SITE PLANS FOR:

DANIEL & JULIE BACKUS

2380 ANDREWS ROAD
TOWN OF CANANDAIGUA
COUNTY OF ONTARIO
STATE OF NEW YORK
AUGUST 1, 2022

INDEX-COVER EX100 - EXISTING CONDITIONS C100 - SITE & UTILITY PLAN C200 - DETAILS C300 - DETAILS









NOT FOR CONSTRUCTION



42 BEEMAN STREET
CANANDAIGUA, NY 14424
(585)905-0360
WWW.MARKSENGINEERING.COM


PROPERTY OWNER: DANIEL & JULIE BACKUS


PREPARED FOR: OWNER

REVISIONS:

11.2.22 PER MRB COMMENTS JJ

DANIEL & JULIE BACKUS
2380 ANDREWS ROAD
TOWN OF CANANDAIGUA
COUNTY OF ONTARIO
NEW YORK
JOB #22-125
7/23/2022

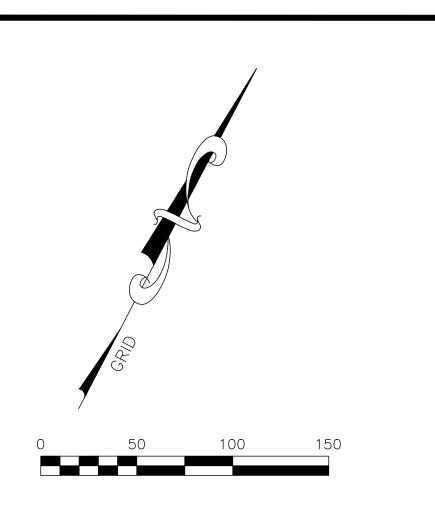

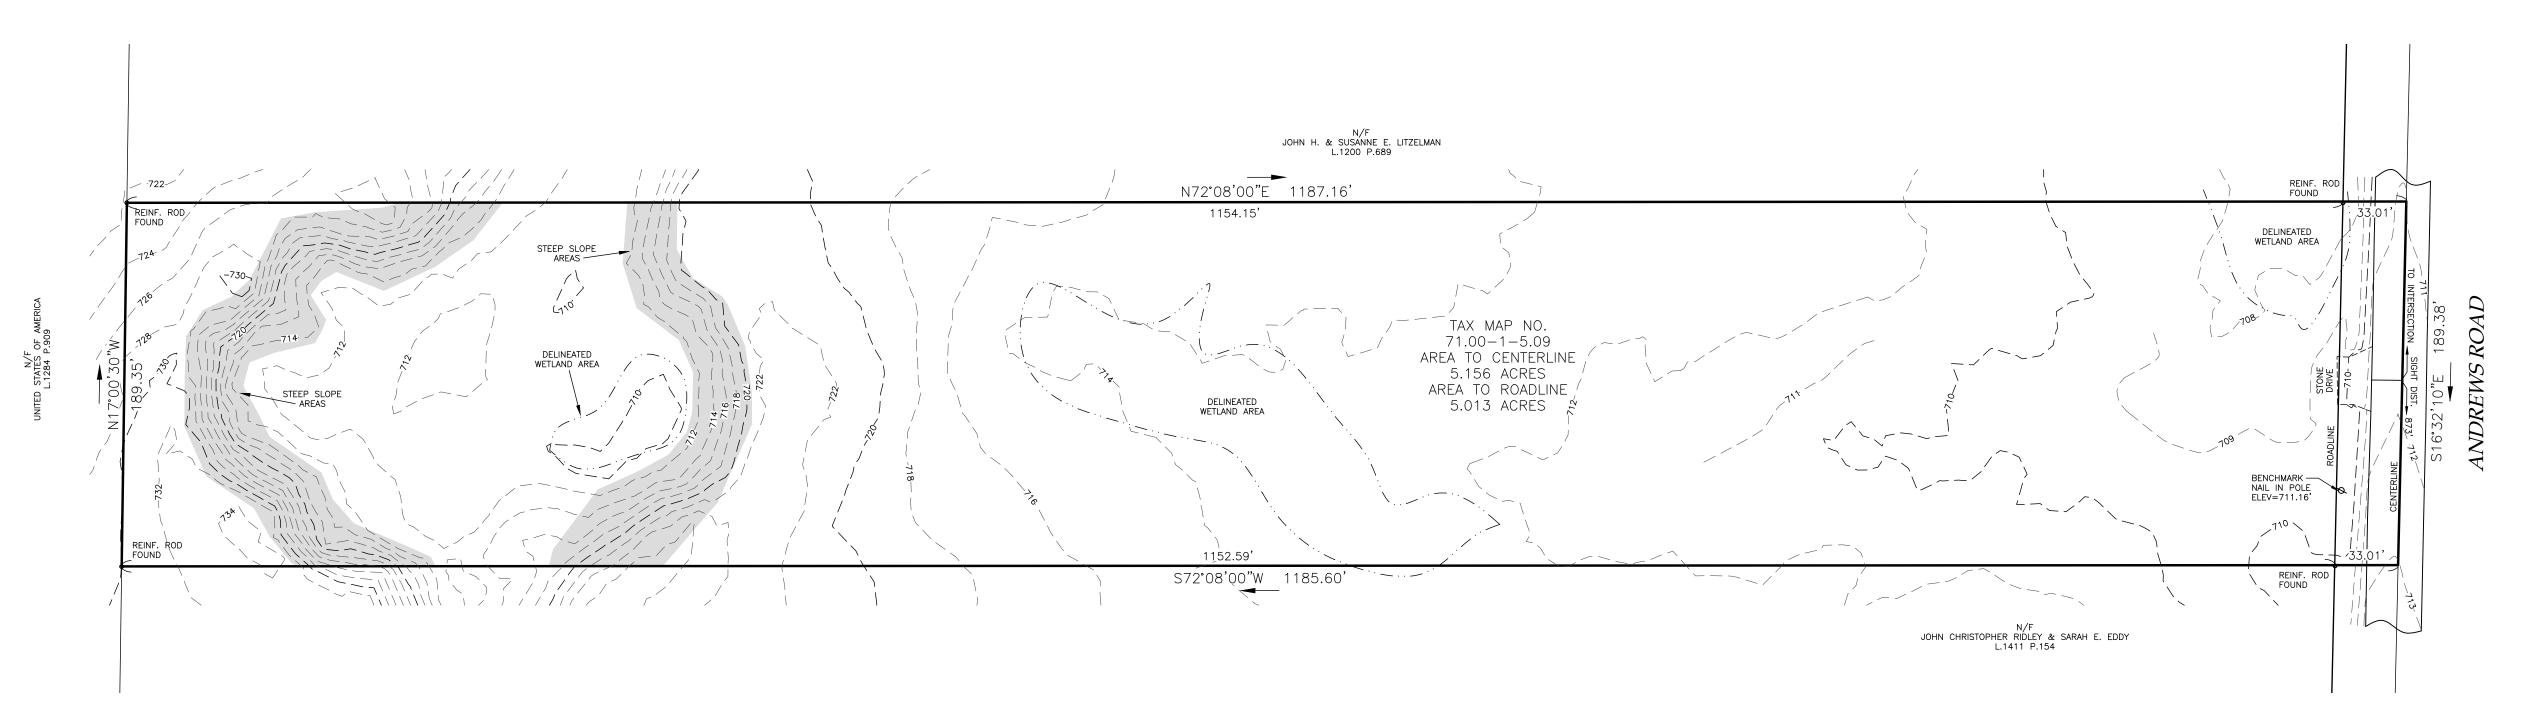



LEGEND

Monument
Benchmark
✓ Utility pole
Hydrant
Light pole
Road Sign

▼ Water Valve

SETBACKS PRINCIPAL STRUCTURE: FRONT — 60 FEET REAR — 40 FEET SIDE — 25 FEET

MAP REFERENCE

EXCAVATION.

1. MAP NOS. 27575, 32205
2. ELEVATION DATUM: NAVD 88 GEOID 18NGS
3. HORIZONTAL DATUM: NAD83 NEW YORK CENTRAL
4. LIBER 1493, PAGE 158 OF DEEDS
5. THIS PLAN IS SUBJECT TO ANY EASEMENTS OR ENCUMBRANCES THAT AN UPDATED SEARCH OF TITLE MAY REVEAL.
6. ALL UTLITIES SHOWN ARE BASED ON VISIBLE SURFACE LOCATION ONLY. NO UNDERGROUND UTILITIES SHOWN. DIG SAFE NY SHALL BE CONTACTED BY THE SITE CONTRACTOR PRIOR TO ANY

I CERTIFY THAT THIS PLAN WAS PREPARED JULY 8, 2022 FROM NOTES OF AN INSTRUMENT SURVEY COMPLETED JUNE 23, 2022 AND FROM MATERIALS REFERENCED HEREON.

DAVID M. PARRINELLO NYSPLS 049724

MarksEngineering

SHOWING LAND IN: 2380 ANDREWS ROAD TOWN OF CANANDAIGUA

DRAWING TITLE:
EXISTING CONDITIONS

DRAWN BY: KRB


DESIGNED BY:
CHECKED BY: DMP


SCALE: AS NOTED

JOB NO.: 22-125

DATE: 7/8/2022

TAX MAP#: 71.00-1-5.09

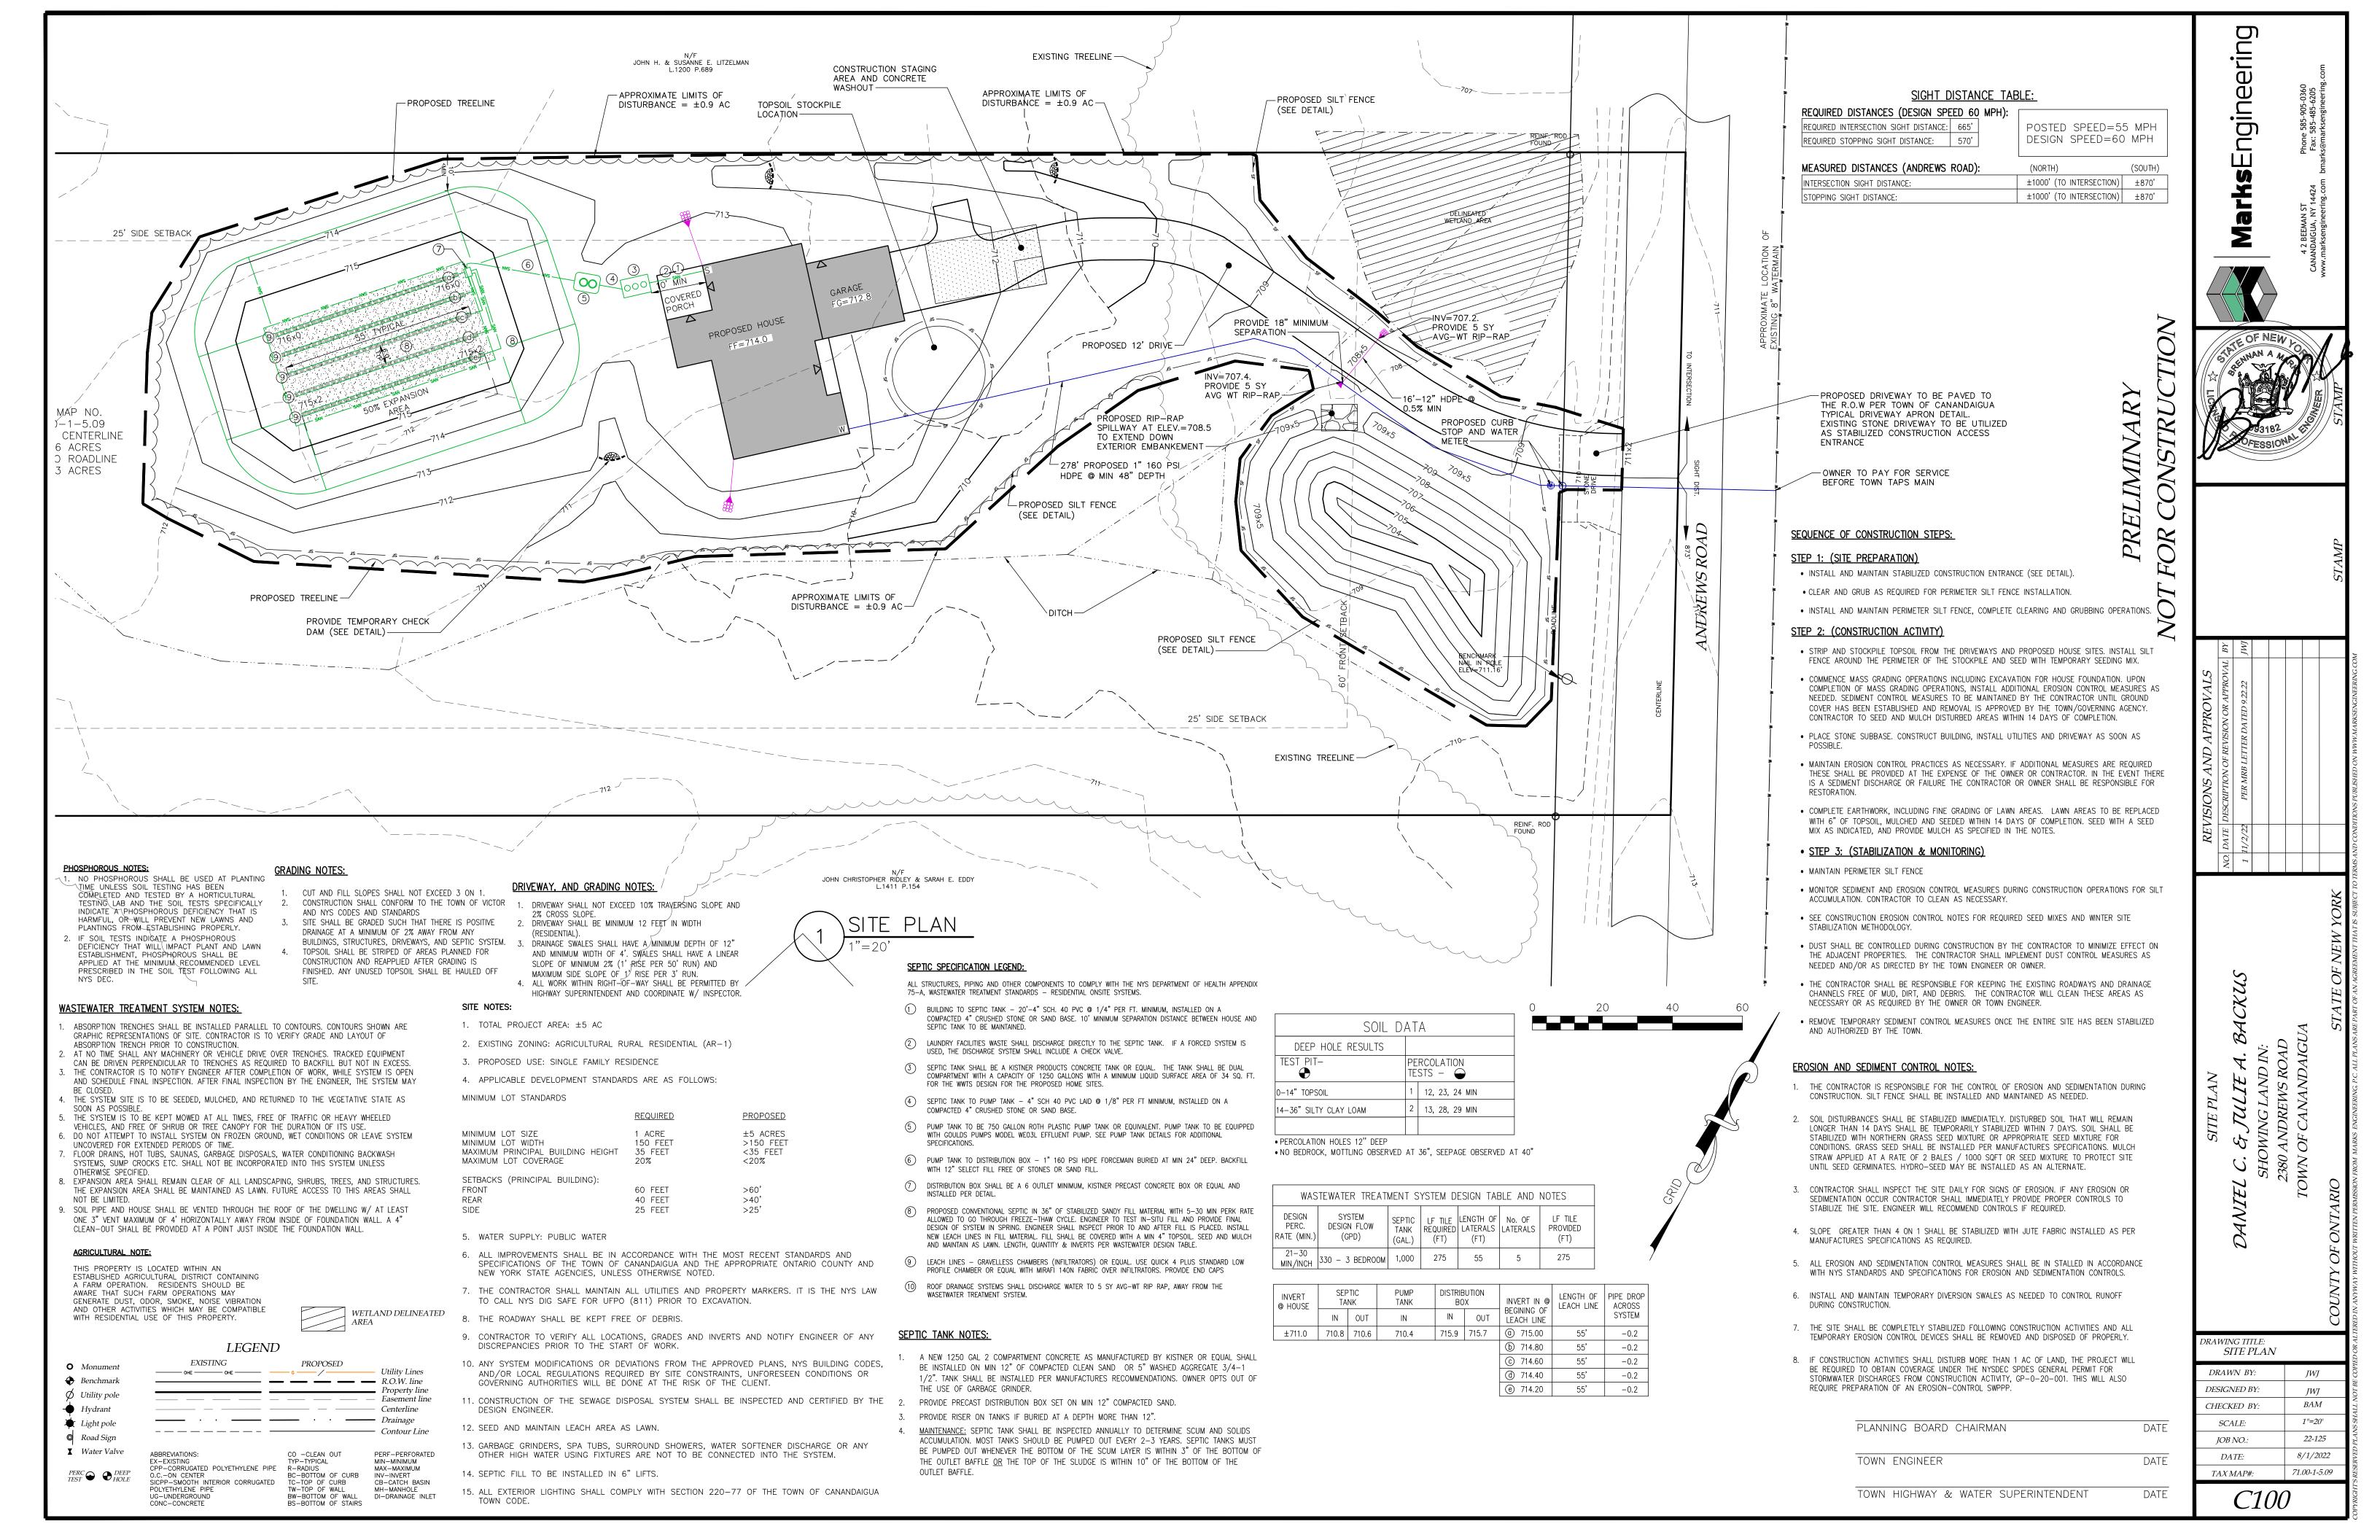

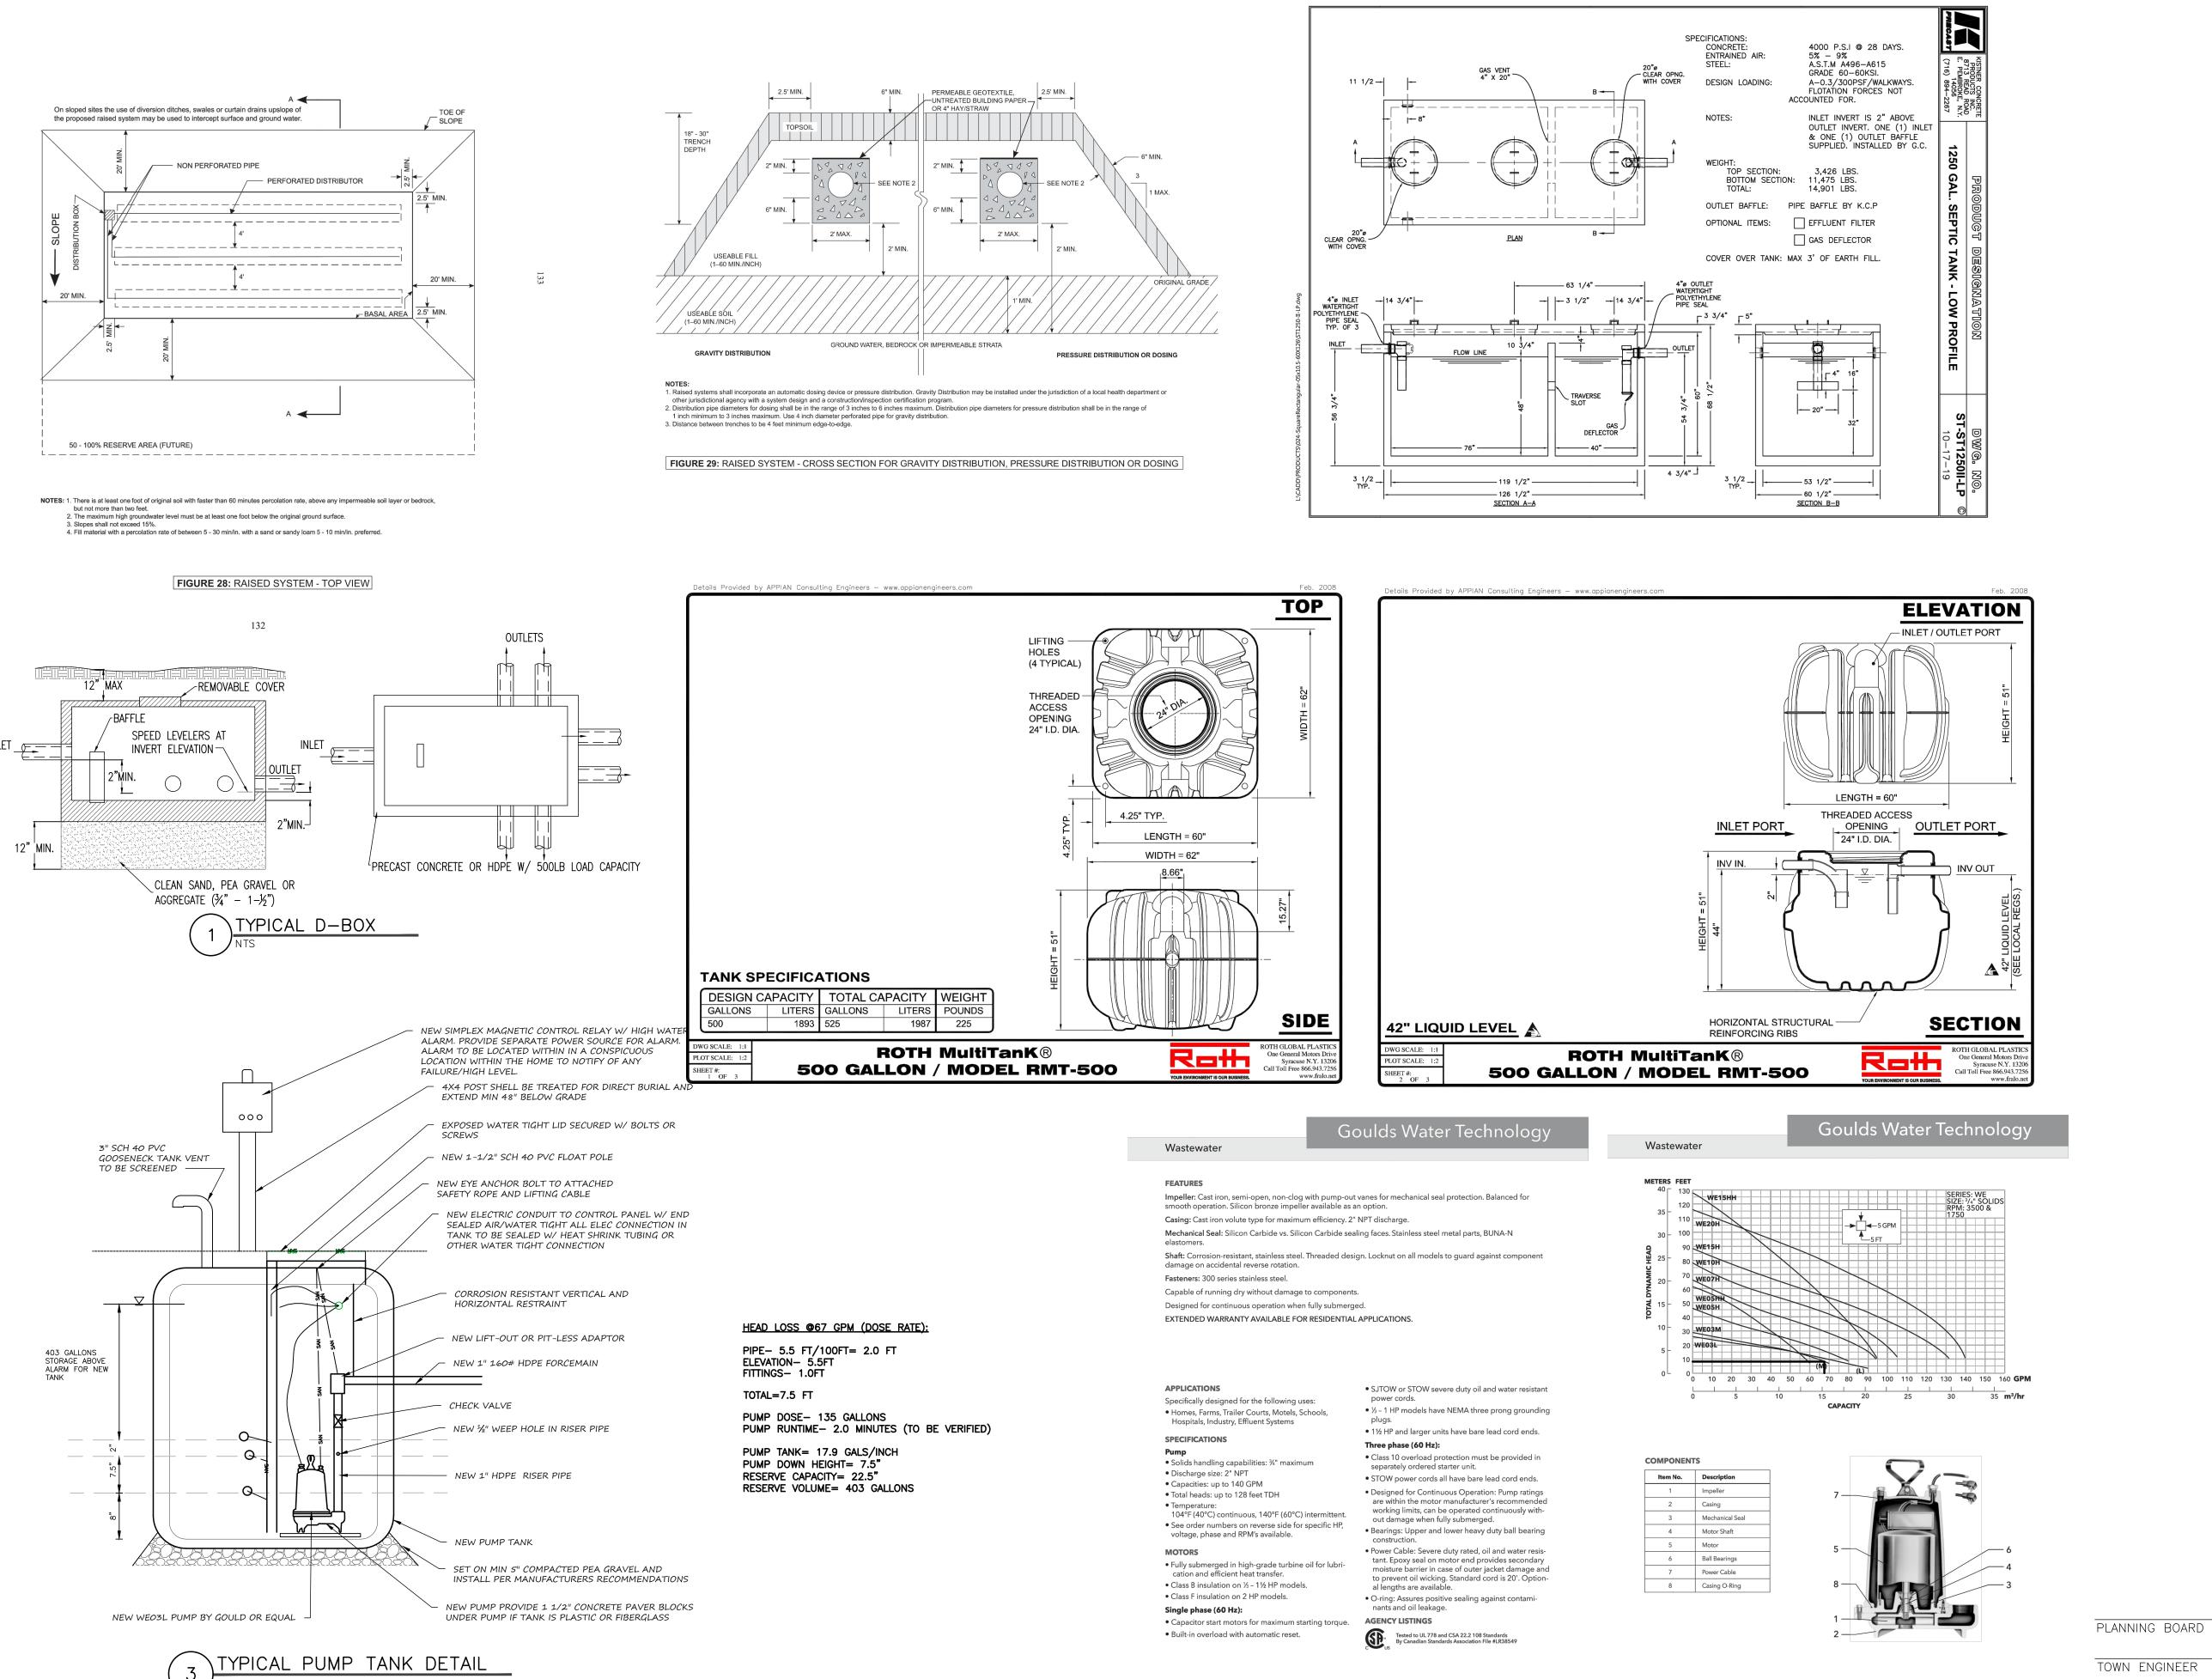

Engineering

DETAIL SHEET

JWJ

JWJ

BAM

1"=50'

22-125

8/1/2022

71.00-1-5.09

DRAWN BY:

DESIGNED BY:

CHECKED BY:

JOB NO.:


DATE:

TAX MAP#:

PLANNING BOARD CHAIRMAN DATE

DATE TOWN HIGHWAY & WATER SUPERINTENDENT DATE

Figure 2.1 Stabilized Construction Access

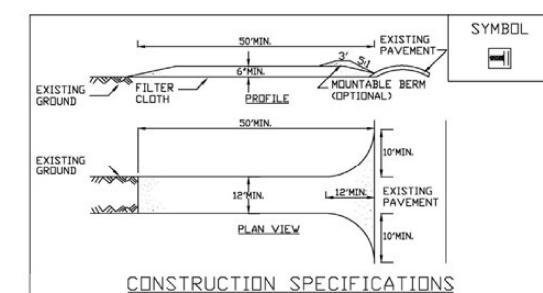

- 1. STONE SIZE USE 1-4 INCH STONE, OR RECLAIMED OR RECYCLED CONCRETE EQUIVALENT.
- 2. LENGTH NOT LESS THAN 50 FEET (EXCEPT ON A SINGLE RESIDENCE LOT WHERE A 30 FOOT MINIMUM LENGTH WOULD APPLY).
- 3. THICKNESS NOT LESS THAN SIX (6) INCHES.
- 4. WIDTH TWELVE (12) FOOT MINIMUM, BUT NOT LESS THAN THE FULL WIDTH AT POINTS WHERE INGRESS OR EGRESS OCCURS. TWENTY-FOUR (24) FOOT IF SINGLE ENTRANCE TO SITE.
- 5. GEDTEXTILE WILL BE PLACED OVER THE ENTIRE AREA PRIOR TO PLACING OF STONE.
- 6. SURFACE WATER ALL SURFACE WATER FLOWING OR DIVERTED TOWARD CON-STRUCTION ACCESS SHALL BE PIPED BENEATH THE ENTRANCE. IF PIPING IS IMPRACTICAL, A MOUNTABLE BERM WITH 5:1 SLOPES WILL BE PERMITTED.
- 7. MAINTENANCE THE ENTRANCE SHALL BE MAINTAINED IN A CONDITION WHICH WILL PREVENT TRACKING OR FLOWING OF SEDIMENT ONTO PUBLIC RIGHTS-OF-WAY, ALL SEDIMENT SPILLED, DROPPED, WASHED OR TRACKED ONTO PUBLIC RIGHTS-OF-WAY MUST BE REMOVED IMMEDIATELY.
- 8. WHEN WASHING IS REQUIRED, IT SHALL BE DONE ON A AREA STABILIZED WITH STONE AND WHICH DRAINS INTO AN APPROVED SEDIMENT TRAPPING DEVICE.
- 9. PERIODIC INSPECTION AND NEEDED MAINTENANCE SHALL BE PROVIDED AFTER EACH RAIN.


ADAPTED FROM DETAILS PROVIDED BY: USDA - NRCS, NEW YORK STATE DEPARTMENT OF TRANSPORTATION, NEW YORK STATE DEPARTMENT OF ENVIRONMENTAL CONSERVATION, NEW YORK STATE SOIL & WATER CONSERVATION COMMITTEE

STABILIZED CONSTRUCTION ACCESS

New York State Standards and Specifications Page 2
For Erosion and Sediment Control


November 2016

Figure 3.1 Stone Check Dam Detail

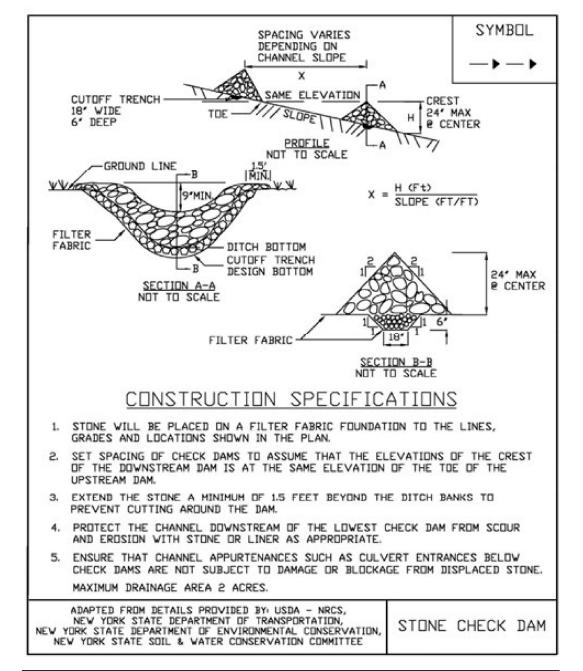

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For Erosion and Sediment Control

Figure 5.30 Reinforced Silt Fence

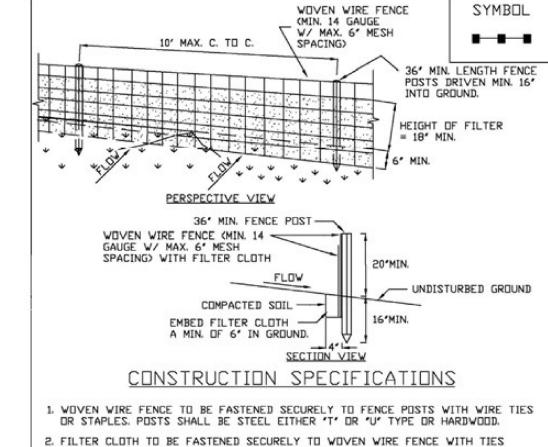


- FILTER CLOTH TO BE FASTENED SECURELY TO WOVEN WIRE FENCE WITH TIES SPACED EVERY 24' AT TOP AND MID SECTION. FENCE SHALL BE WOVEN WIRE, 6' MAXIMUM MESH OPENING.
- 3. WHEN TWO SECTIONS OF FILTER CLOTH ADJOIN EACH OTHER THEY SHALL BE OVER-LAPPED BY SIX INCHES AND FOLDED. FILTER CLOTH SHALL BE EITHER FILTER X, MIRAFI 100X, STABILINKA T140N, OR APPROVED EQUIVALENT.
- 4. PREFABRICATED UNITS SHALL MEET THE MINIMUM REQUIREMENTS SHOWN.
- 5. MAINTENANCE SHALL BE PERFORMED AS NEEDED AND MATERIAL REMOVED WHEN "BULGES" DEVELOP IN THE SILT FENCE.


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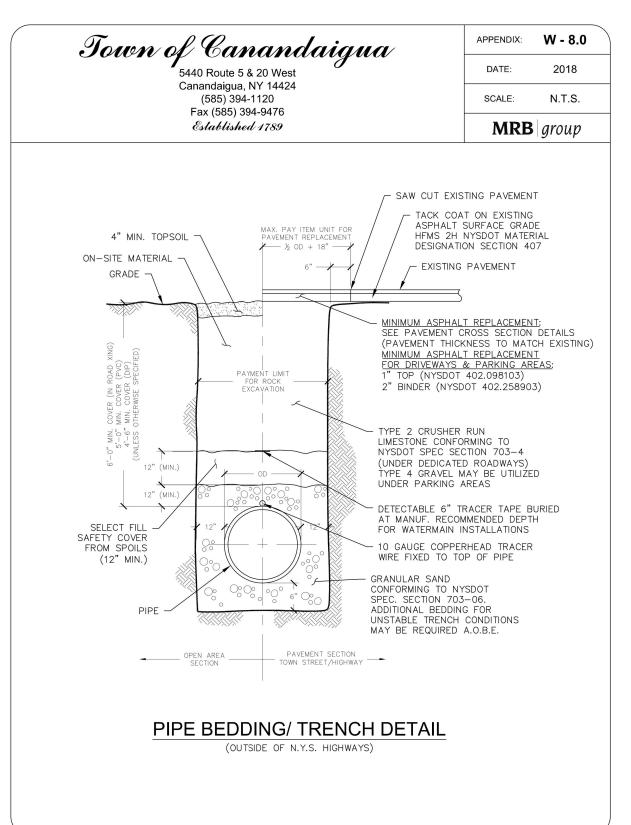
November 2016


CONSERVATION, COMMITTEE SILT FENCE

New York State Standards and Specifica-For Erosion and Sediment Control



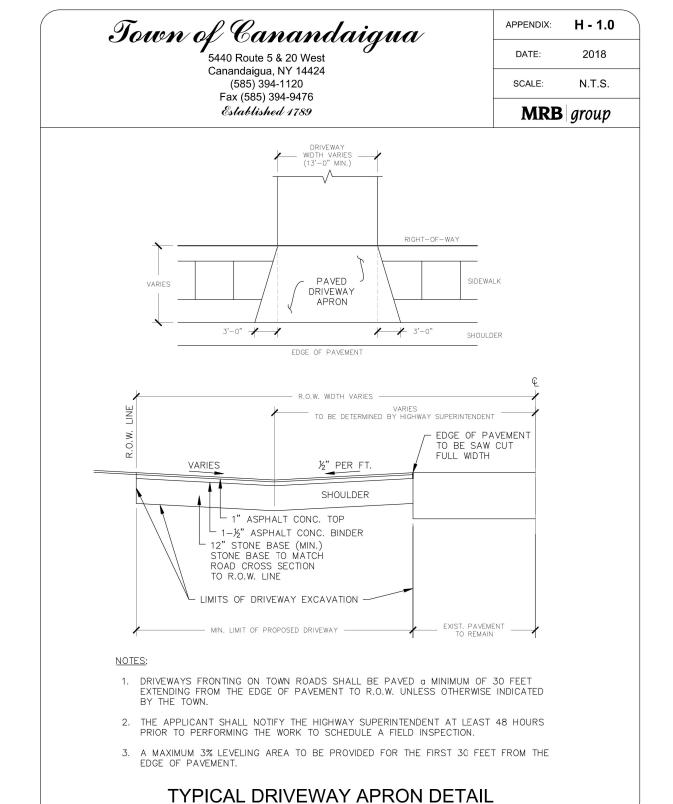

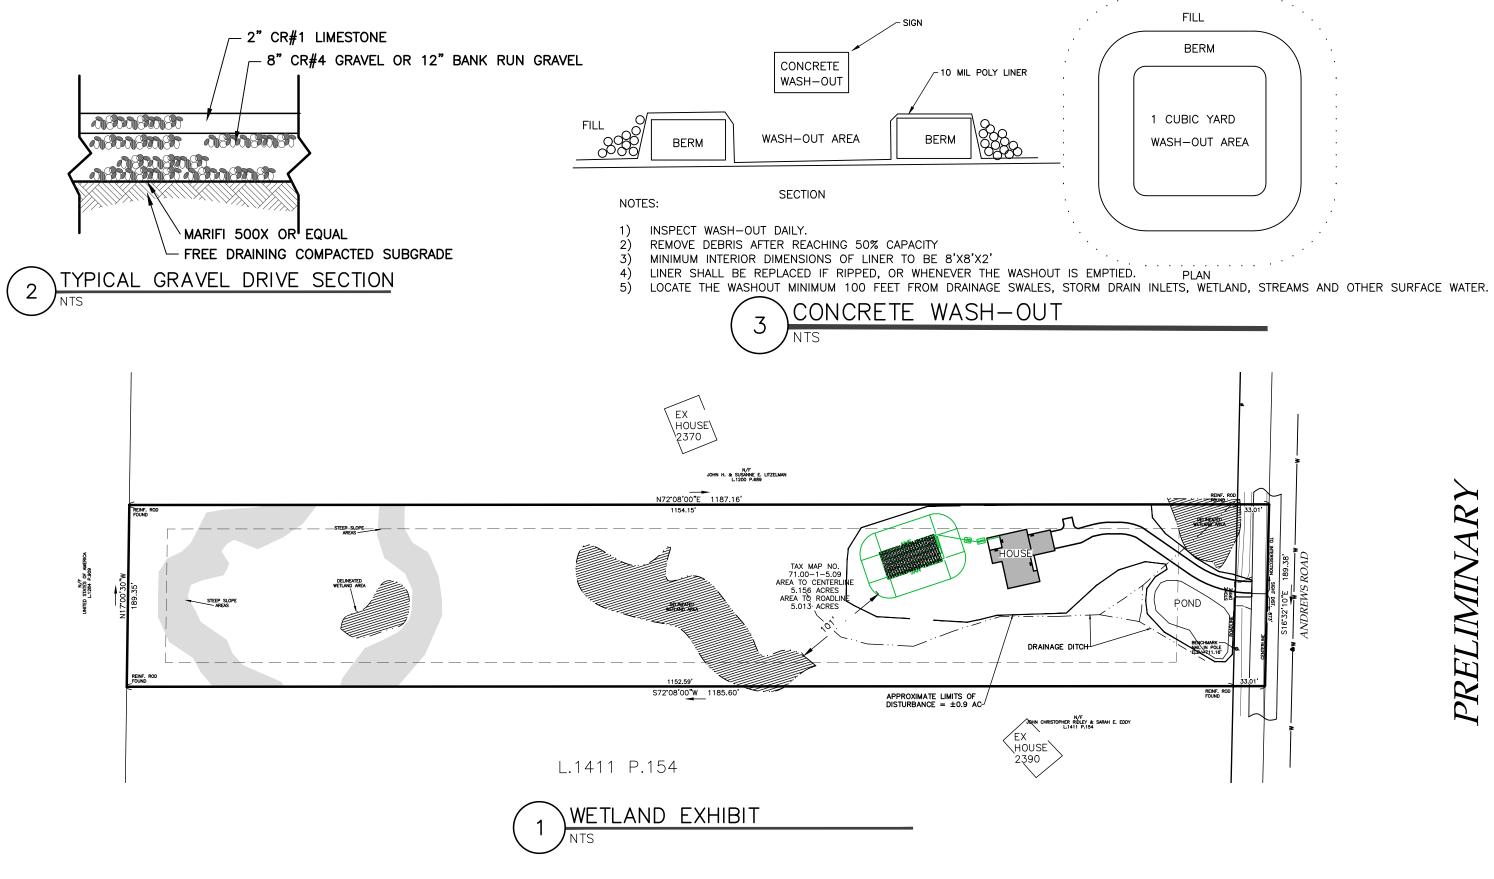

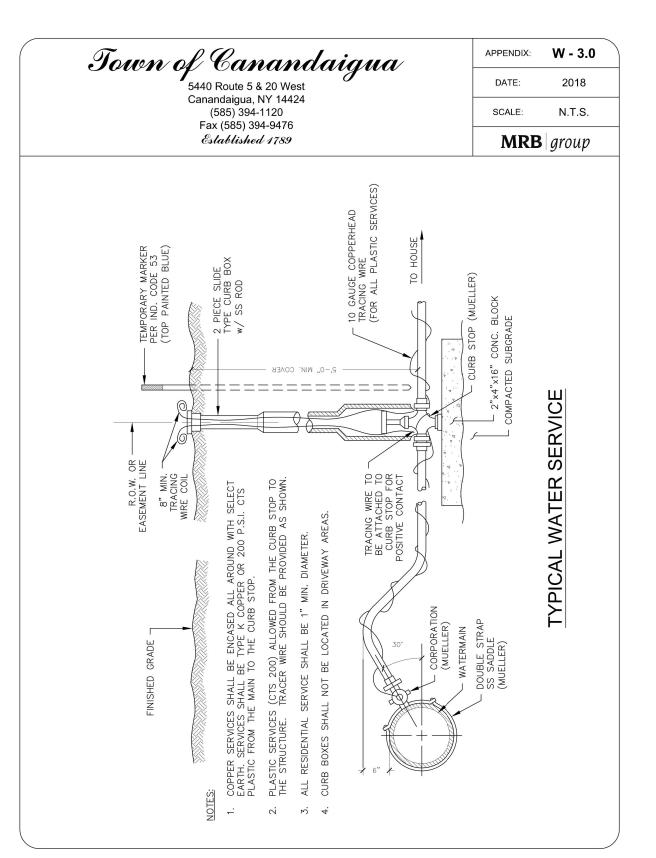

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PLANNING BOARD CHAIRMAN	DAT
TOWN ENGINEER	DATE
TOWN HIGHWAY & WATER SUPERINTENDENT	DATE

VOT FOR CONSTRUCTION

Engineering

KS

$SITE\ PLAN$	KEVISIONS AIND AFFROVA
	NO. DATE DESCRIPTION OF REVISION OR APF
INIEL C. & JULIE A. BACKUS	1 1/2/22 PER MRB LETTER DATED 9.22.
SHOWING LAND IN:	
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TOWN OF CANANDAIGUA	

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 DESIGNED BY:
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 CHECKED BY:
 BAM

 SCALE:
 1"=50'

 JOB NO.:
 22-125

 DATE:
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 TAX MAP#:
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DRAWING TITLE:

DETAIL SHEET