
SHEET INDEX:

C-0 COVER SHEET C-1 SITE PLAN

ONE STAGE(PRELIMINARY/FINAL) SITE PLAN SET FOR SINGLE FAMILY HOME CONSTRUCTION CARSON RESIDENCE 5610 BUFFALO STREET EXTENSION TOWN OF CANANDAIGUA ONTARIO COUNTY -- STATE OF NEW YORK

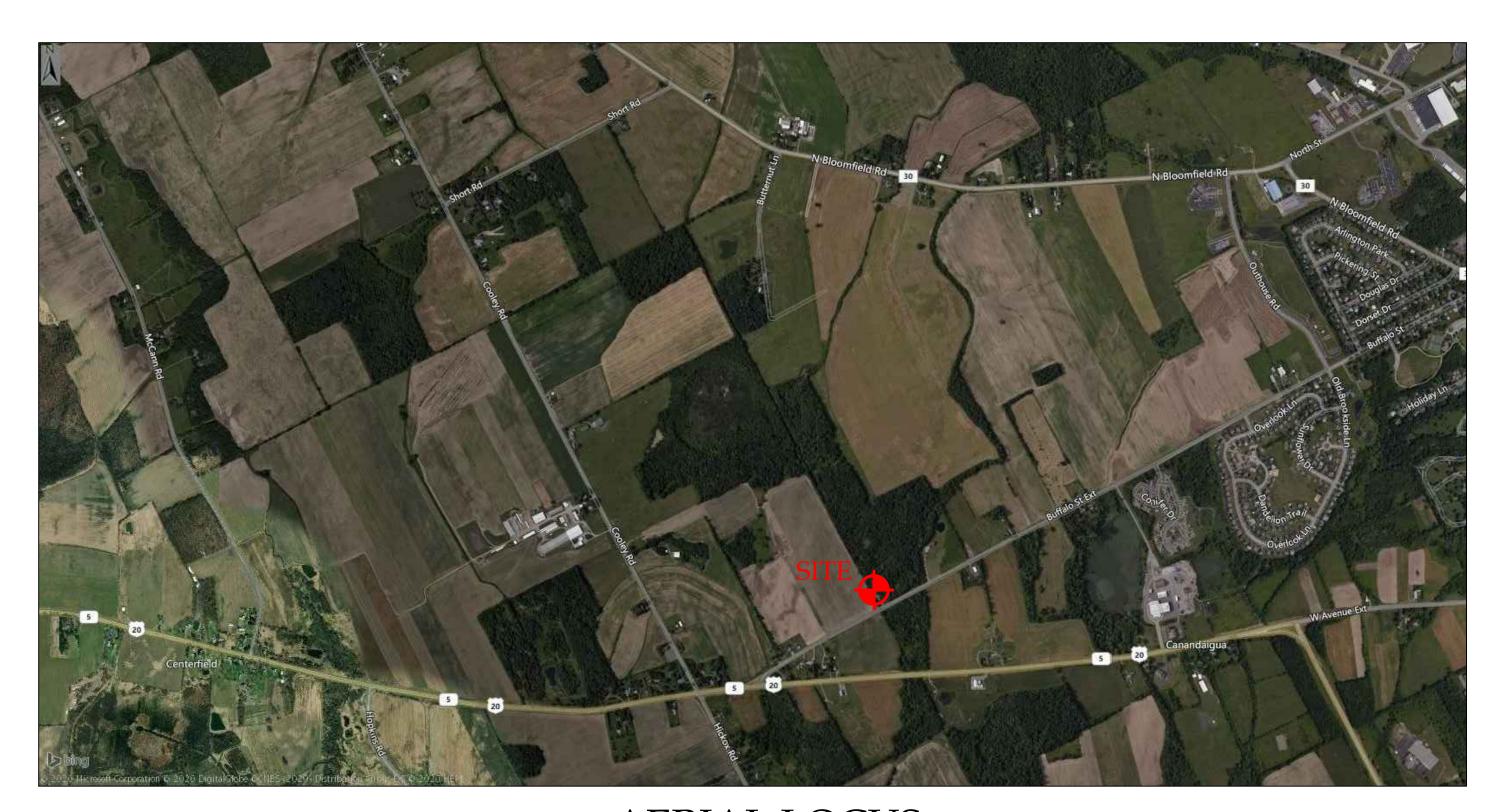

AERIAL LOCUS NOT TO SCALE

A P.K. nail found



GENERAL NOTES

1. PROPERTY LINE INFORMATION SHOWN ON THIS PLAN IS BASED ON AVAILABLE RECORD INFORMATION AND A FIELD INSTRUMENT SURVEY.

2. UTILITIES SHOWN ON THIS PLAN ARE APPROXIMATE. ACTUAL LOCATION SHALL BE FIELD VERIFIED PRIOR TO CONSTRUCTION. THE CONTRACTOR SHALL PROTECT AND MAINTAIN ALL EXISTING UTILITY SERVICES THROUGHOUT CONSTRUCTION. CONTACT U.F.P.O. AT 1-800-962-7962 AT LEAST 72 HOURS PRIOR TO CONSTRUCTION.

3. NO CHANGES ARE TO BE MADE TO THIS DESIGN WITHOUT PRIOR APPROVAL.

4. THE CONTRACTOR SHALL LOCATE, MARK, SAFEGUARD AND PRESERVE ALL SURVEY CONTROL MONUMENTS AND RIGHT—OF—WAY MONUMENTS IN THE AREAS OF CONSTRUCTION.

5. PROPOSED LIGHTING TO BE COORDINATED WITH THE ARCHITECT AND OWNER. LIGHTING SHALL BE DARK SKY COMPLIANT (PER CHAPTER 220, SECTION 77).

6. ELEVATIONS REFERENCE NAVD88 DATUM

7. PORTION OF LANDS OF LOT 2 FALL WITHIN THE TOWN OF CANANDAIGUA NRI DISTRICT (FORESTED AREAS)

8. FLOOD ZONES X PER COMMUNITY PANEL NO. 360598 0015 C LAST DATED MARCH 3, 1997.

Drawing Title:

ZONING CHART TOWN OF CANANDAIGUA ZONING DISTRICT: AGRICULTURAL RURAL RESIDENTIAL DISTRICT (AR-2)

(AR-2)					
	REQUIRED	EXISTING	PROVIDED		
MIN LOT AREA (AREA TO ROW)	2 ACRES	30 ACRES	NO CHANGE		
MIN LOT WIDTH	200'	383.88'	NO CHANGE		
MIN FRONT YARD SETBACK	60'	N/A	793.4'		
MIN SIDE YARD SETBACK	25'	N/A	148.2'		
MIN REAR YARD SETBACK	40'	N/A	445.5'		
MAX BUILDING HEIGHT	35 FT	N/A	35 FT MAX		
MAX BUILDING COVERAGE	20%	N/A	0.5%		
SITE DISTURBANCE		30,000 SQ FT			

ONE STAGE SITE PLAN APPROVAL

PLANNING BOARD CHAIRPERSON

DATE

File# 18099

NOTE:
NO BUILDING PERMIT MAY BE ISSUED UNTIL FINAL SITE PLAN APPROVAL
HAS BEEN GRANTED AND THE FINAL SITE PLAN SIGNED BY THE
PLANNING BOARD CHAIRPERSON.

FOR PERMITTING ONLY

"Unauthorized alteration or addition to a map bearing a Licensed Professional Engineer's or Professional Land Surveyor's seal in any way is a Violation of Section 7209 "Copyright 2020" Venezia & Associates. All rights reserved unauthorized duplication is a violation of all applicable laws"



Iron pin or pipe found

Iron pin set

Concrete Monument

Benchmark


O- Utility pole

E/T

R.O.W. line

Property lines

Revisions			
NO.	Date	Description	Ву

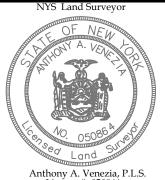

CARSON RESIDENCE
5610 Buffalo Street Extension

5610 Buffalo Street Extension

Town of Canandaigua

County of Ontario State of New York


SITE PLAN

Scale 1" = 20'
T.m. # 83.00-1-38.200
Date: 3/23/2020
Sheet:

Canandaigua New York, 14424

Anthony A. Venezia, P.L.S.
License # 050864

www.veneziasurvey.com — Fax. No. (585) 396-0131 — E-mail rocco@veneziasurvey.com

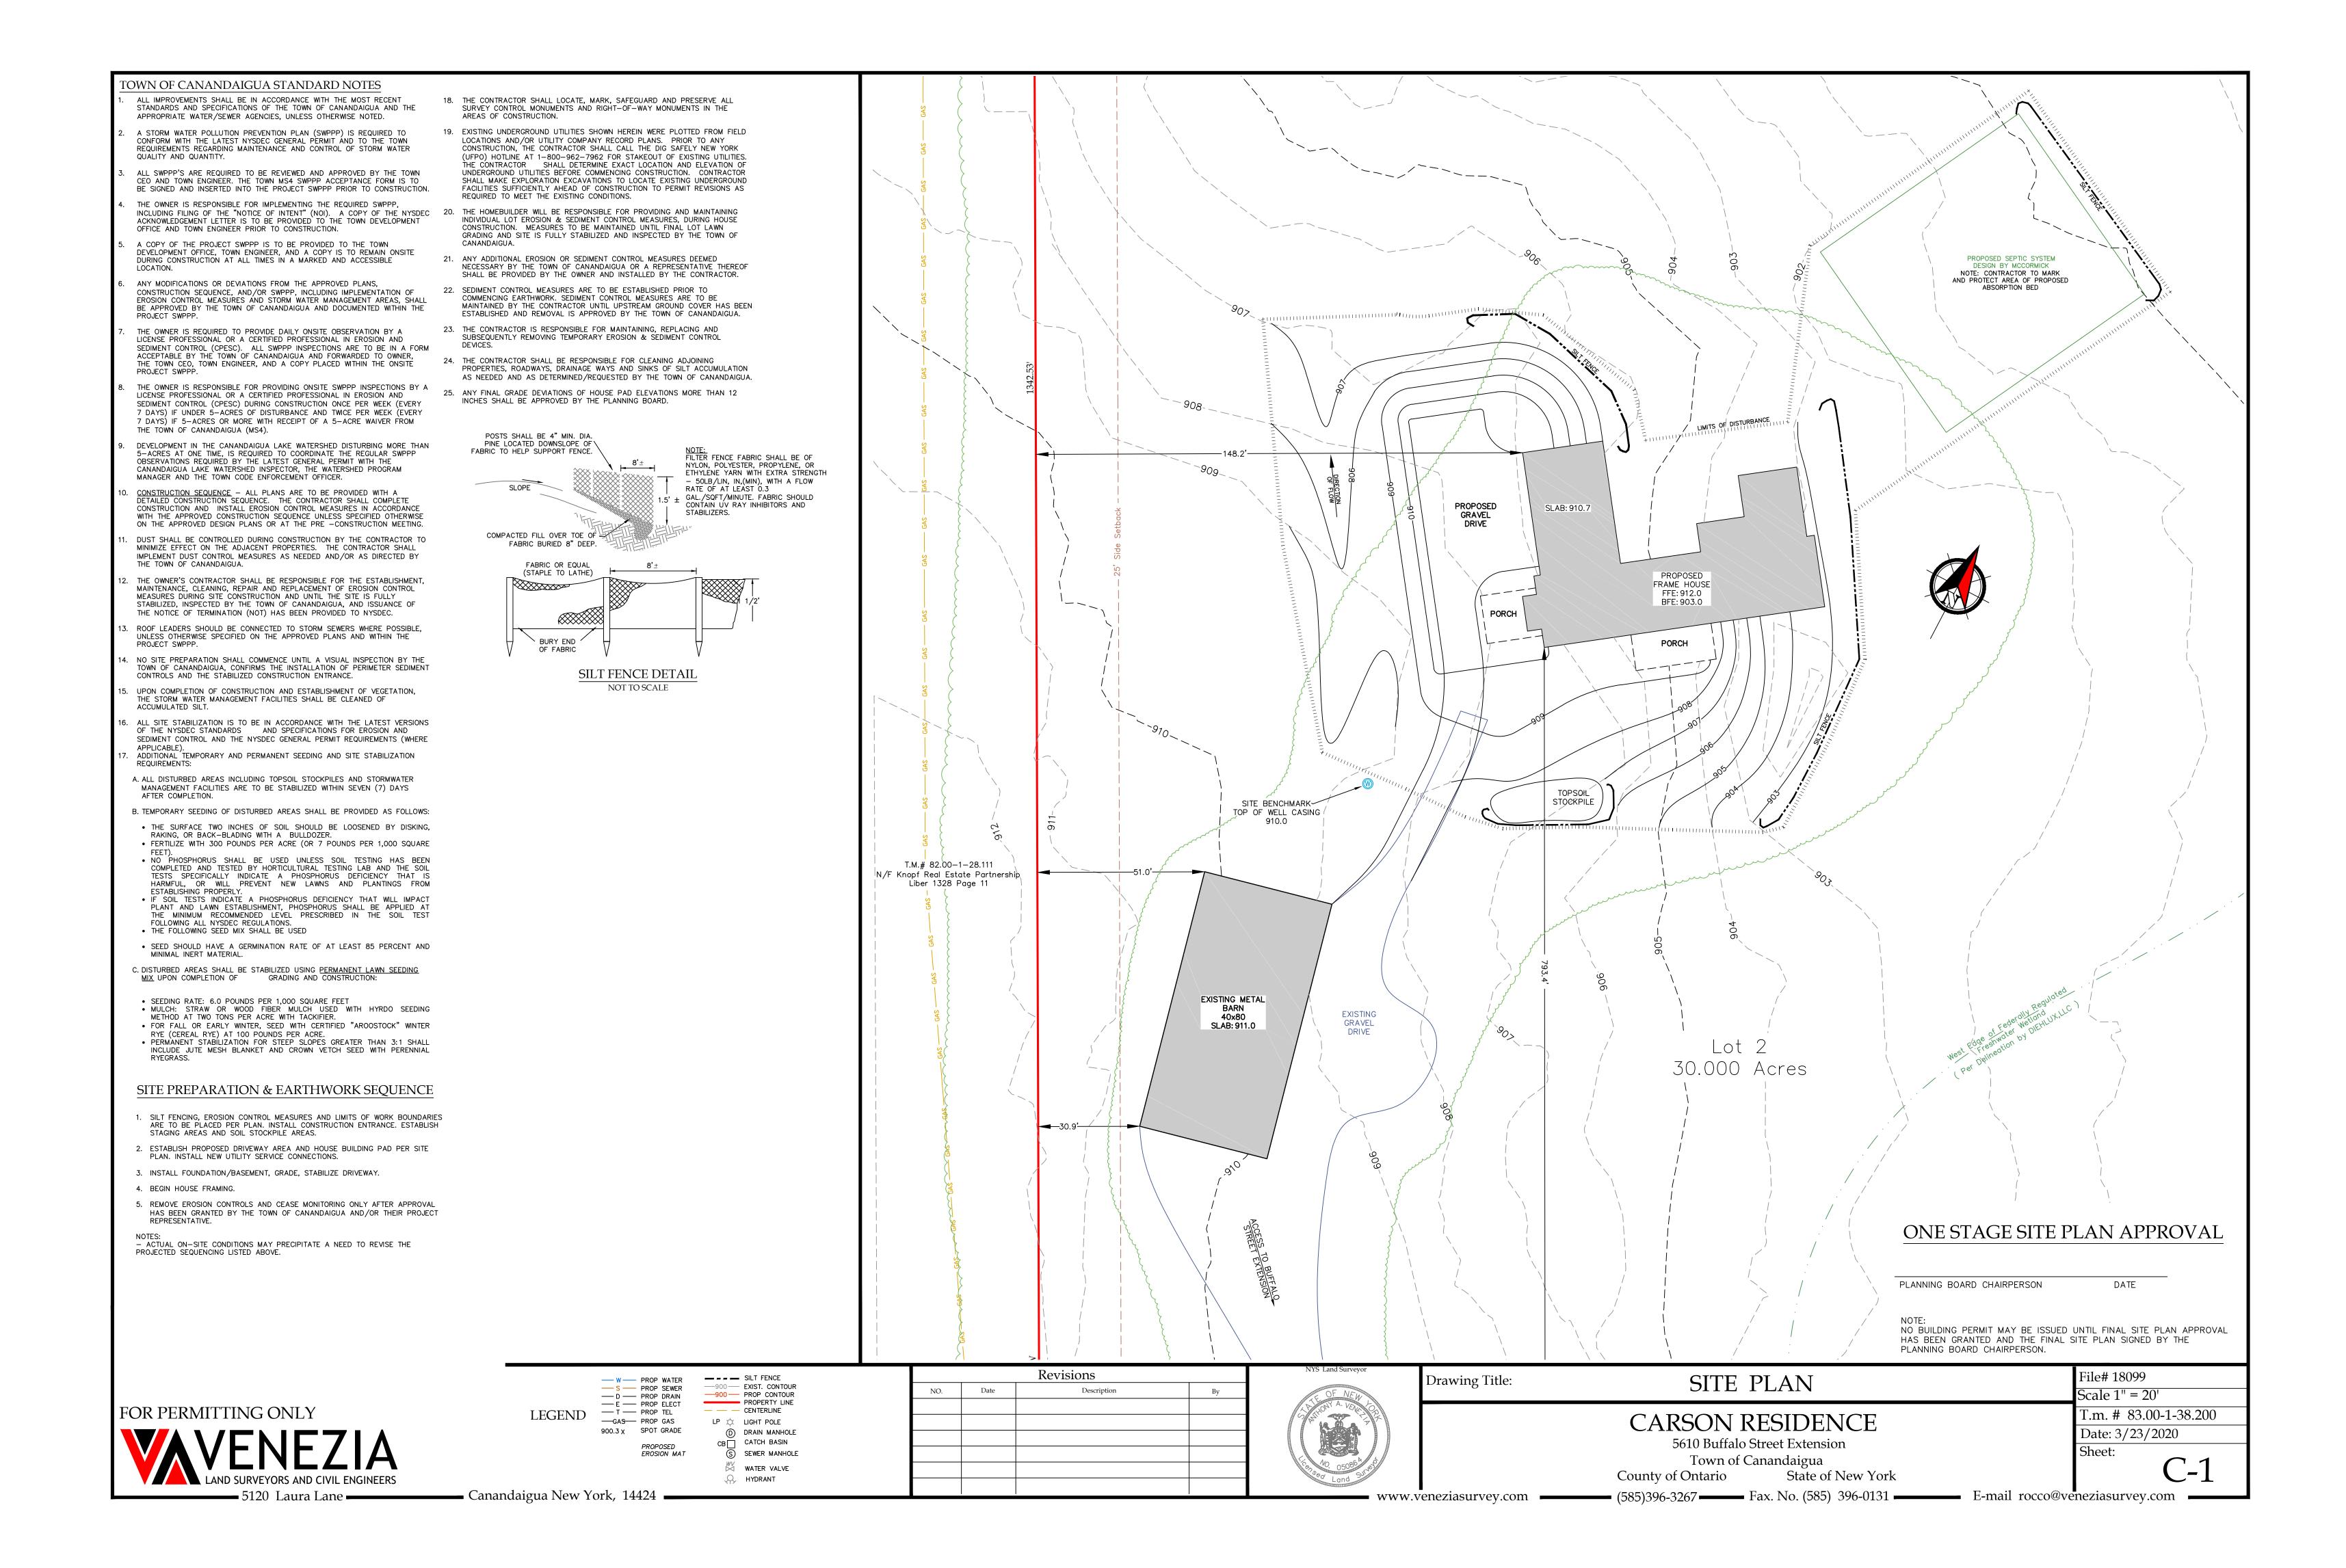

ON-SITE WASTEWATER TREATMENT (SEPTIC) SYSTEM Shallow Trench Absorption System Four Bedroom Single Family Home

Prepared For:

Jeff Carson

Site Location:

Part of 5600 Buffalo Street Ext.


(T) Canandaigua, Ontario County, New York Part of Tax Map ID No. 83.00—1—25.112

Prepared By:

AcCormick Ingineering P.C.

294 Skuse Road Geneva, NY 14456 Tel: 585-721-7219


E-Mail: JTMccormickPE@aol.com

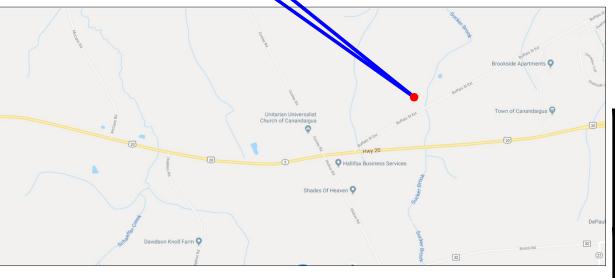

PROJECT SITE



CALL DIG SAFELY NEW YORK 48 HOURS BEFORE DIGGING OR DRIVING POSTS @ 811

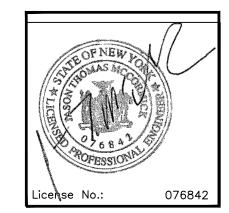

DRAWING NO.	DRAWING TITLE
C-1.0 C-1.1	SEPTIC SYSTEM BASIS OF DESIGN SEPTIC SYSTEM BASIS OF DESIGN
C-2.0 C-2.1	OVERALL SITE PLAN ENLARGED SITE PLAN
C-3.0	SEPTIC SYSTEM DETAILS 1 OF 3
C-4.0	SEPTIC SYSTEM DETAILS 2 OF 3
C-5.0	SEPTIC SYSTEM DETAILS 3 OF 3
C-6.0	SYSTEM PROFILE
	PN 18-219 July 23, 2018 REVISED 05oct18 REV 2 01APR20

THE FOLLOWING PRESENTS THE BASIS OF DESIGN FOR THE ON SITE WASTEWATER TREATMENT SYSTEM.

AREA TO BE SERVED: RESIDENTIAL — FOUR BEDROOM SINGLE FAMILY HOME

DESIGN FLOW: 520 GPD (4 BEDROOMS X 130 GPD/BEDROOM) NO GARBAGE DISPOSAL/NO GARDEN

DESIGN FLOW: 520 GPD (4 BEDROOMS X 130 GPD/BEDROOM) NO GARBAGE DISPOSAL/NO GARDEN TUB SITE CHARACTERISTICS: DEPTH TO GROUNDWATER/IMPERMEABLE LAYER — 4', SITE SLOPE LESS THAN 10% POTABLE WATER FROM A PRIVATE GROUNDWATER WELL

<u>ON-SITE TESTS</u>

PERCOLATION TESTS AND DEEP HOLE TEST COMPLETED BY JASON MCCORMICK, PE, MCCORMICK ENGINEERING PC. TESTS COMPLETED ON JULY 18, 2018

PERC TEST

<u>HOLE</u>	DEPTH OF H	<u>IOLE</u>	PERCOLATION RATE				
HOLE (MARK)	(INCH)		(MIN/INCH)				
			RUN	1 RUN 2	RUN 3	RUN 4	
PT-1	24		22	26	28	29	
PT-1 PT-2 PT-3	24		25	28	28	29	
PT-3	24		19	25	27	26	
	PERC RATE OF	21 - 30	MIN/INCH	(APPLICATION	RATE -	0.60 GAL/DAY/SF)	

DEEP HOLE (DUE TO LIITED SITE ACCESS. AN AUGER WAS USED FOR DEEP HOLE TEST) (MARK DH1)

DEPTH SOIL CONDITION

0"-8" TOPSOIL

8"-34" LOAM WITH SOME STONES AND ROOTS 34"-64" LOAM WITH NO ROOTS, FEW STONES

DEPTH TO IMPERMEABLE LAYER - GREATER THAN 5'-0"

DEPTH TO GROUNDWATER OR MOTTLING - 4'-0" GROUNDWATER WAS OBSERVED

A SECOND DEEP HOLE TESTED WAS EXCAVATED WITH A MINI EXCAVATOR ON SEPTEMBER 6, 2018 (MARK DH2)

DEPTH SOIL CONDITION

0"-11" TOPSOIL

11"-48" LOAM WITH SOME STONES AND ROOTS
48"-63" LOAM WITH NO ROOTS, WET, FEW STONES
DEPTH TO IMPERMEABLE LAYER - GREATER THAN 5'-0"

DEPTH TO GROUNDWATER OR MOTTLING — 4'-1" MOTTLING WAS OBSERVED

HOUSE WAS RELOCATED SO ADDITIONAL ON-SITE TESTING WAS COMPLETED

PERCOLATION TESTS AND DEEP HOLE TEST COMPLETED BY JASON MCCORMICK, PE, MCCORMICK ENGINEERING PC. TESTS COMPLETED ON APRIL 2, 2020

PERC TEST

<u>HOLE</u> (MARK)	DEPTH OF HOLE (INCH)	<u>PERCOLATION_RATE</u> (MIN/INCH)			
	,	RUN 1	RUN 2	RÚN 3	RUN 4
PT-A	24	24	27	29	29
PT-B	24	24	26	27	28
PT-C	24	26	27	29	29

DESIGN PERC RATE OF 21-30 MIN/INCH (APPLICATION RATE - 0.60 GAL/DAY/SF)

DEEP HOLE (MARK DHA)

<u>DEPTH</u> <u>SOIL CONDITION</u>

0"-9" TOPSOIL

9"-38" LOAM WITH SOME STONES AND ROOTS
38"-66" LOAM WITH NO ROOTS, FEW STONES
DEPTH TO IMPERMEABLE LAYER - GREATER THAN 5'-0"

DEPTH TO GROUNDWATER OR MOTTLING - 4'-2" GROUNDWATER WAS OBSERVED

A SHALLOW TRENCH SYSTEM (12" OF FILL + 6" TOPSOIL) IS RECOMMENDED.

DURING CONSTRUCTION, CONTRACTOR SHALL CONFIRM SOILS ARE CONSISTENT WITH THE PERC AND DEEP HOLE TESTS. MCCORMICK ENGINEERING PC SHALL BE NOTIFIED IMMEDIATELY OF ANY DIFFERENCES.

SEPTIC TANK

- A 1,250 GALLON DUAL CHAMBER, PRE—CAST CONCRETE SEPTIC TANK SHALL BE INSTALLED SUCH THAT IT WILL RECEIVE THE DISCHARGE FROM THE NEW HOME.
- 2. CONTRACTOR SHALL CONFIRM DIMENSIONS OF SEPTIC TANK PRIOR TO EXCAVATION.
- 3. SEPTIC TANKS SHOULD BE PUMPED OUT EVERY TWO TO THREE YEARS.
- 4. SEPTIC TANK ADDITIVES (BIOLOGICAL OR CHEMICAL) SHOULD NOT BE USED.

EFFLUENT FILTER (RECOMMENDED)

A ZABEL FILTER (MODEL A1800-4X18) SHALL BE INSTALLED ON THE EFFLUENT PIPE OF THE SEPTIC TANK

ABSORPTION SYSTEM - SHALLOW TRENCH

THE ABSORPTION SYSTEM WAS DESIGNED BASED ON THE NYSDOH RESIDENTIAL ONSITE WASTEWATER TREATMENT SYSTEMS DESIGN HANDBOOK, 2012.
TRENCH LENGTH

APPLICATION RATE: 0.60 GPD PER SQ FT

(TABLE 6 - APPLICATION RATES FOR NONSTANDARD FLOWS)

REQUIRED AREA = 520 GPD / 0.60 GPD PER SQ FT = 867 SQ FT

REQUIRED LENGTH OF 2' WIDE TRENCH: 434 FEET

PROPOSED CONFIGURATION: (8) 2' WIDE BY 60' LONG TRENCHES (TOTAL LENGTH = 480 FT)

TAPFR

A TAPER SHALL BE INSTALLED AROUND THE RAISED AREA. THE TAPER SHALL HAVE A MAXIMUM SLOPE OF 1V:3H

FILL MATERIAL

USABLE FILL SHALL HAVE A PERC RATE BETWEEN 21-30 MINUTES PER INCH AND SHALL BE SANDY LOAM SOIL. A PERC TEST SHALL BE CONDUCTED AT THE BURROW SITE TO CONFIRM PERC RATE PRIOR TO PLACEMENT. A SECOND PERC TEST SHALL BE CONDUCTED ON THE SOIL AFTER IT HAS BEEN PLACED AND STABILIZED AT THE SITE. STABILIZE RAISED BED FILL MATERIAL BY MEANS OF MECHANICAL COMPACTION IN 6" LIFTS OR THROUGH A PERIOD OF 6 MONTHS INCLUDING A FREEZE-THAW CYCLE. MECHANICAL COMPACTION SHALL BE ACHIEVED VIA

Jeff Carson

Site Location:


Part of 5600 Buffalo St. Ext.

(T) Canandaigua, Ontario County, New York Part of Tax Map ID No. 83.00—1—25.112

Prepared By:

McCormick Engineering P.C 294 Skuse Road Geneva, NY 14456

Tel: 585-721-7219 E-Mail: JTMccormickPE@aol.com

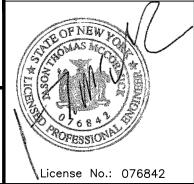

SEPTIC SYSTEM BASIS OF DESIGN

Date: 04/01/20 Dr

Drawing No.:

C - 1.0

SEPARATION REQUIREMENTS

MINIMUM SEPARATION DISTANCES FROM THE ABSORPTION FIELD.

- 100 FEET FROM ALL GROUNDWATER WELLS LOCATED UPHILL OF THE SYSTEM
- 2. 200 FEET FROM ALL GROUNDWATER WELLS LOCATED DOWNHILL OF THE SYSTEM
- 20 FEET FROM ALL HOUSES\BUILDINGS
- 10 FEET FROM ALL PROPERTY LINES
- 20 FEET FROM DRAINAGE DITCHES
- 100 FEET FROM ANY SURFACE WATER (PONDS, STREAMS, ETC.)
- 7. ANY DRAINAGE TILE FOUND WITHIN 30' OF THE ON-SITE WASTEWATER TREATMENT SYSTEM SHALL BE REROUTED.

MINIMUM SEPARATION DISTANCES FROM THE SEPTIC TANK.

- 1. 50 FEET FROM ALL GROUNDWATER WELLS
- 2. 10 FEET FROM ALL HOUSES\BUILDINGS
- 3. 10 FEET FROM ALL PROPERTY LINES
- 10 FEET FROM DRAINAGE DITCHES
- 5. 50 FEET FROM ANY SURFACE WATER (PONDS, STREAMS, ETC.)

ALL SEPARATION REQUIREMENTS SHALL BE CONFIRMED BY THE CONTRACTOR PRIOR TO CONSTRUCTION. IF SEPARATION REQUIREMENTS CAN NOT BE MET, CONTRACTOR SHALL NOTIFY MCCORMICK ENGINEERING PC AT (585) 721-7219 PRIOR TO CONSTRUCTION.

NOTES:

- 1. REFER TO PIPE SCHEDULE ON THIS DRAWING FOR DETAILS ON SIZE, TYPE AND SLOPE OF PROPOSED PIPING.
- 2. CONTRACTOR SHALL CONFIRM ALL REQUIRED SETBACKS ARE MET PRIOR TO START OF CONSTRUCTION. ANY CONFLICTS SHALL BE REPORTED TO MCCORMICK ENGINEERING PC FOR RESOLUTION.
- 3. BASED ON FIELD INVESTIGATIONS. THE ABSORPTION FIELD MUST BE LOCATED IN THE EXACT SPOT SHOWN ON THE SITE PLAN.
- 4. NO HEAVY EQUIPMENT USE IN THE DESIGNATED ABSORPTION SYSTEM AREA IS ALLOWED TO PREVENT SOIL PERMEABILITY REDUCTION DUE TO COMPACTION AND POSSIBLE TRENCH CAVE-IN AND PIPE BREAKAGE.
- 5. DO NOT INSTALL GARBAGE GRINDERS ON WASTE LINES.
- 6. NON-WASTEWATER FLOWS (SUMPS, ROOF DRAINS, ETC) SHALL NOT BE ADDED TO THE SYSTEM.
- 7. SHALLOW TRENCH LEACH FIELD AREA INCLUDING TAPERS SHALL BE SEEDED AND MAINTAINED AS LAWN

INSPECTIONS

ALL INSTALLATIONS MUST BE INSPECTED AND APPROVED BY MCCORMICK ENGINEERING PC PRIOR TO USE. A MINIMUM OF 48 HOUR NOTICE IS REQUIRED TO SCHEDULE INSPECTIONS.

INSPECTIONS

ALL INSTALLATIONS MUST BE INSPECTED AND APPROVED BY MCCORMICK ENGINEERING PC PRIOR TO USE. A MINIMUM OF 72 HOUR NOTICE IS REQUIRED TO SCHEDULE INSPECTIONS.

Jeff Carson

Site Location:


Part of 5600 Buffalo St. Ext.

(T) Canandaigua, Ontario County, New York Part of Tax Map ID No. 83.00—1—25.112

Prepared By:

McCormick Engineering P.C 294 Skuse Road Geneva, NY 14456

Tel: 585-721-7219 E-Mail: JTMccormickPE@aol.com

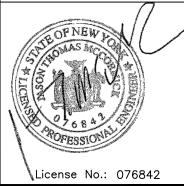



SEPTIC SYSTEM BASIS OF DESIGN


Date: 04/01/20


Drawing No.:

C - 1.1

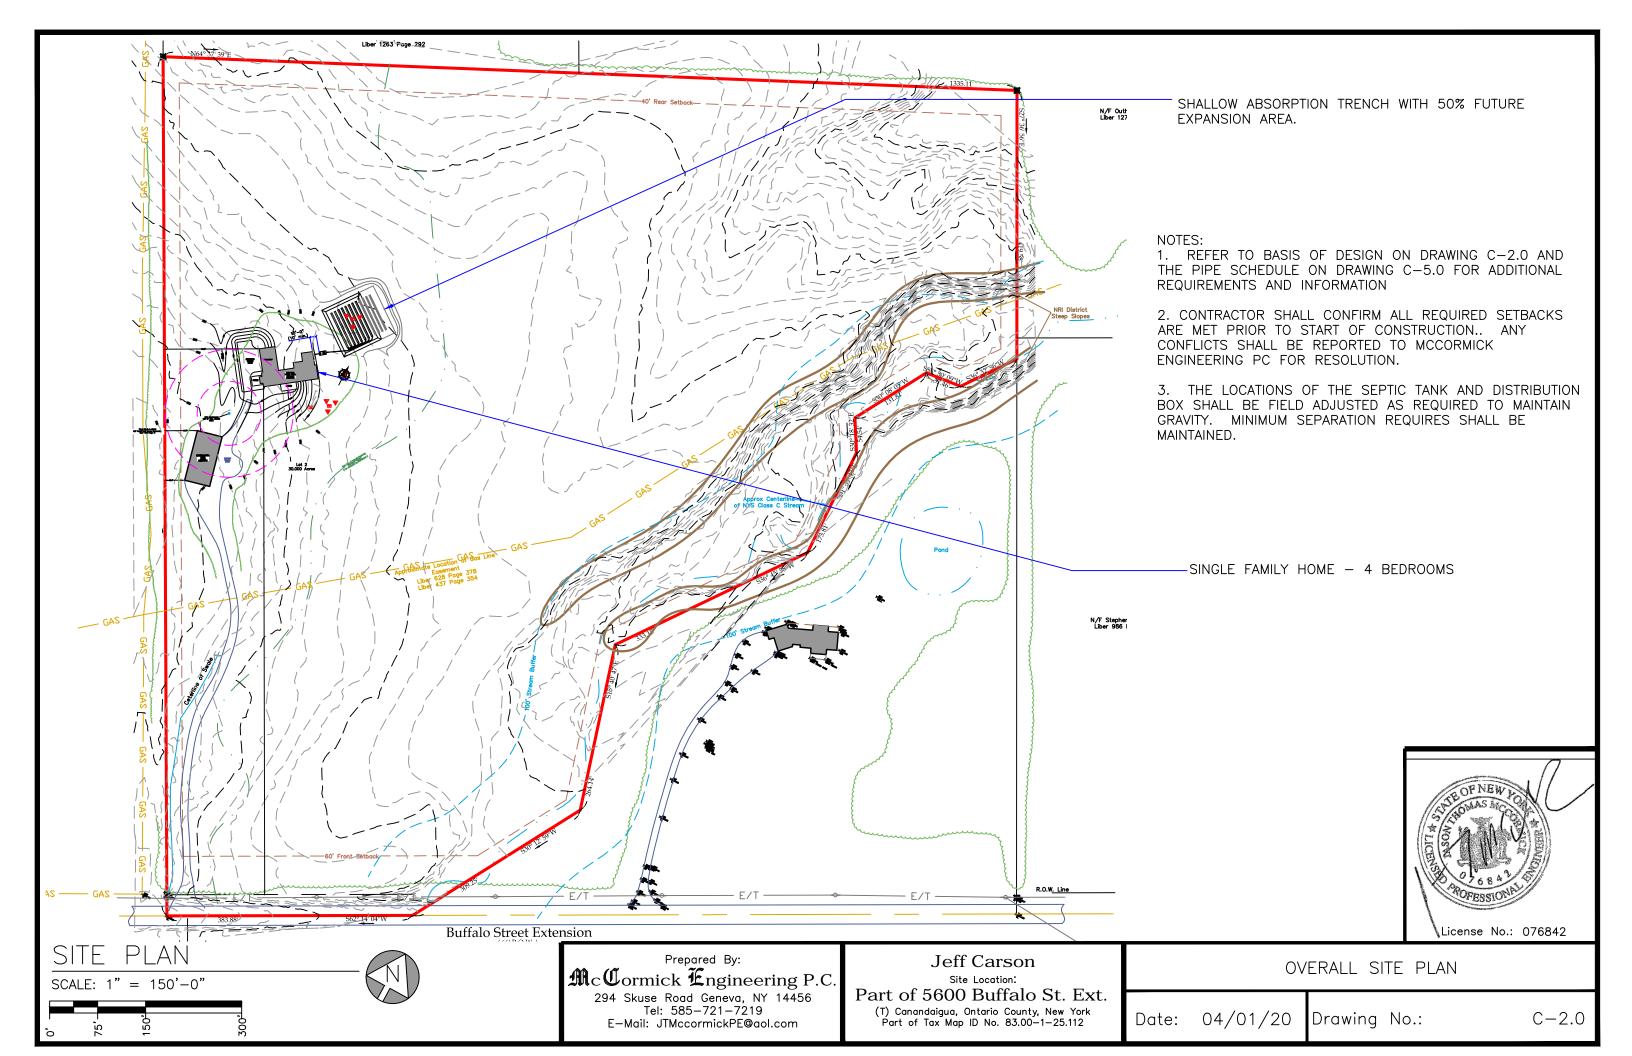

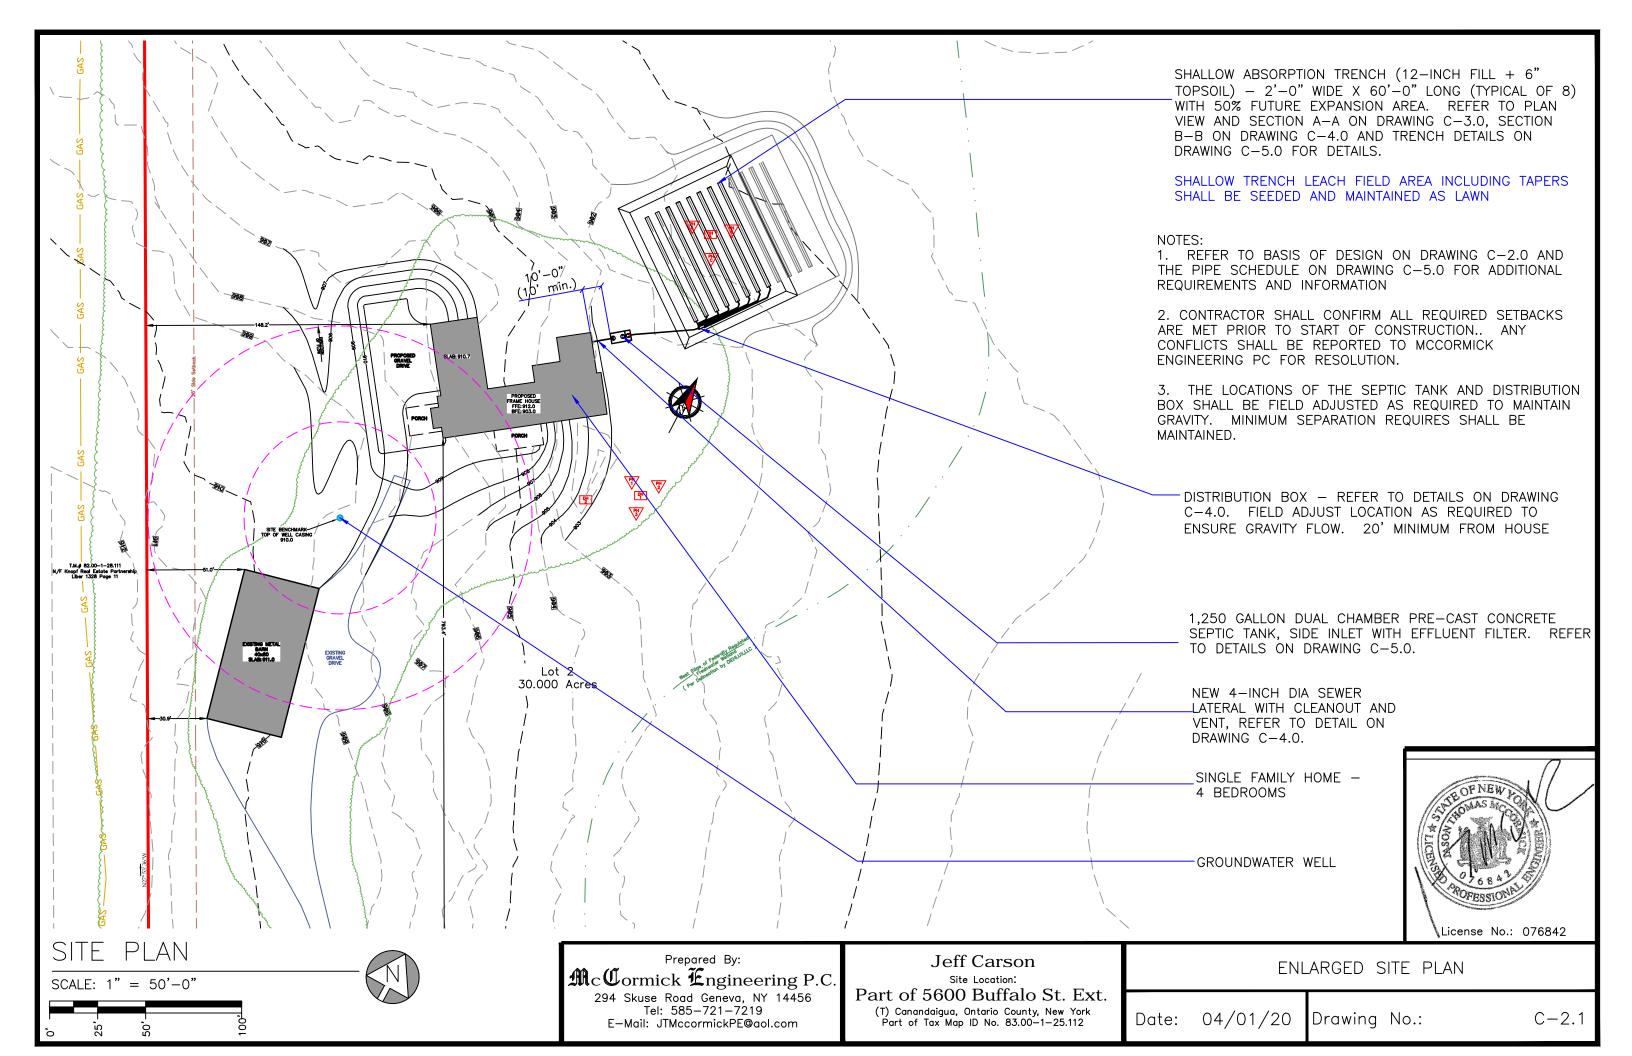

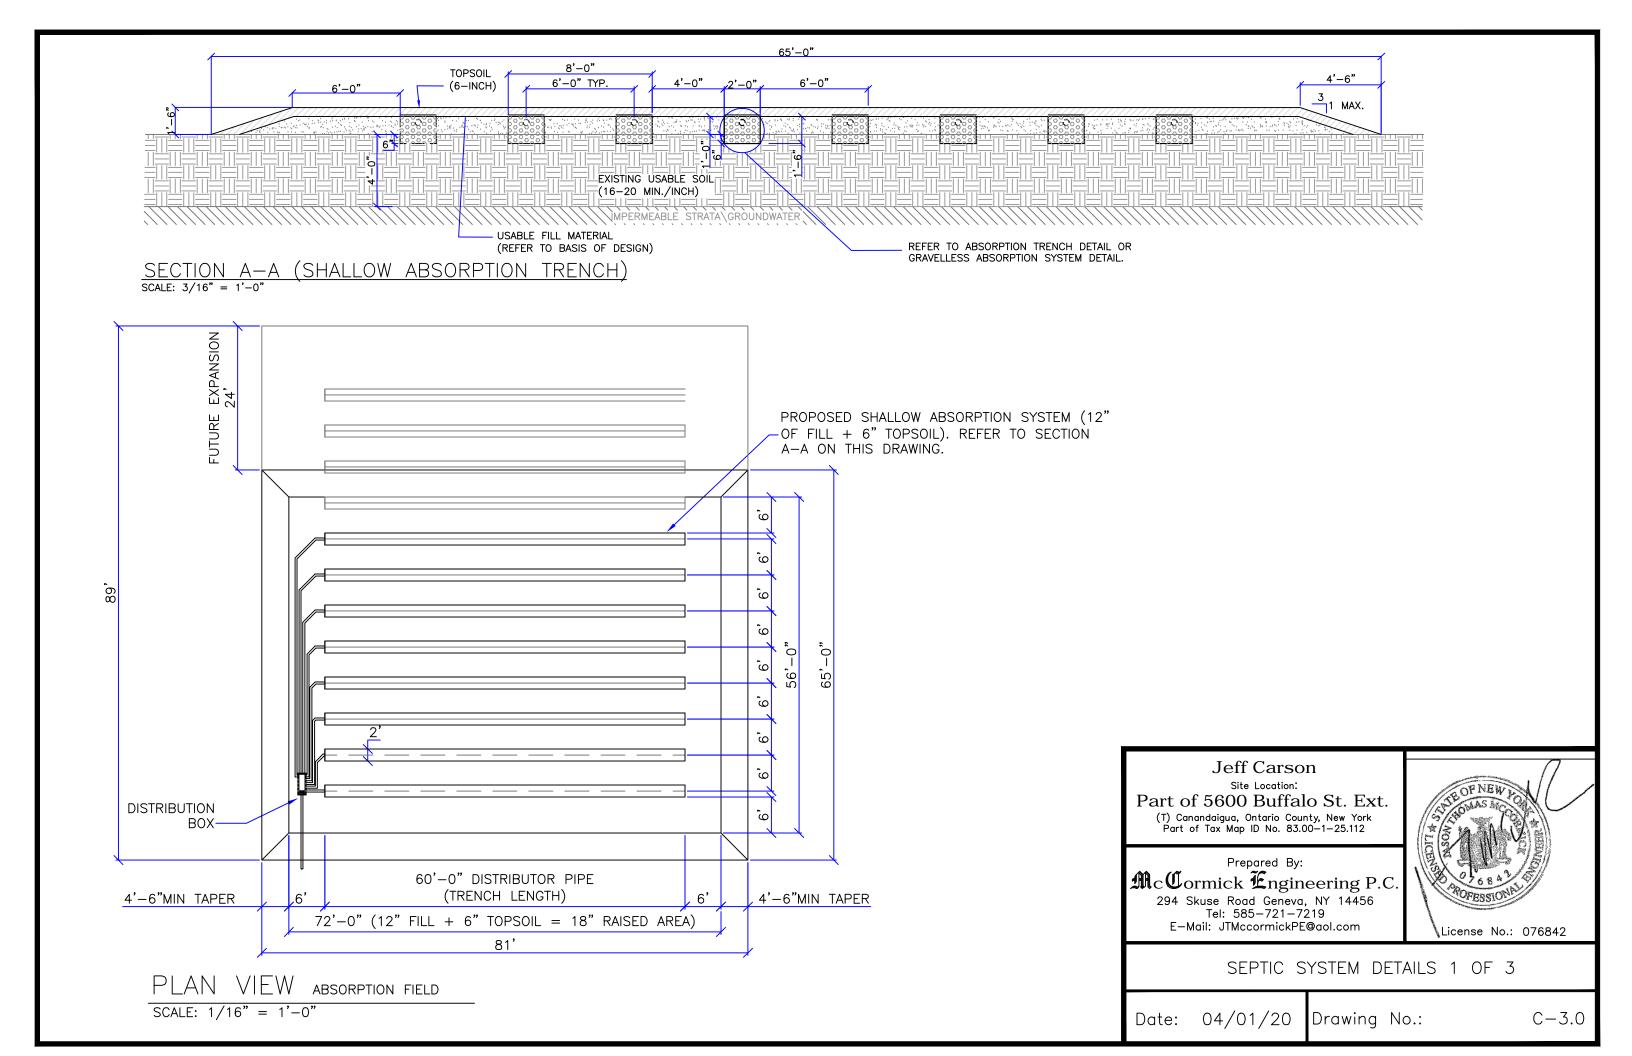

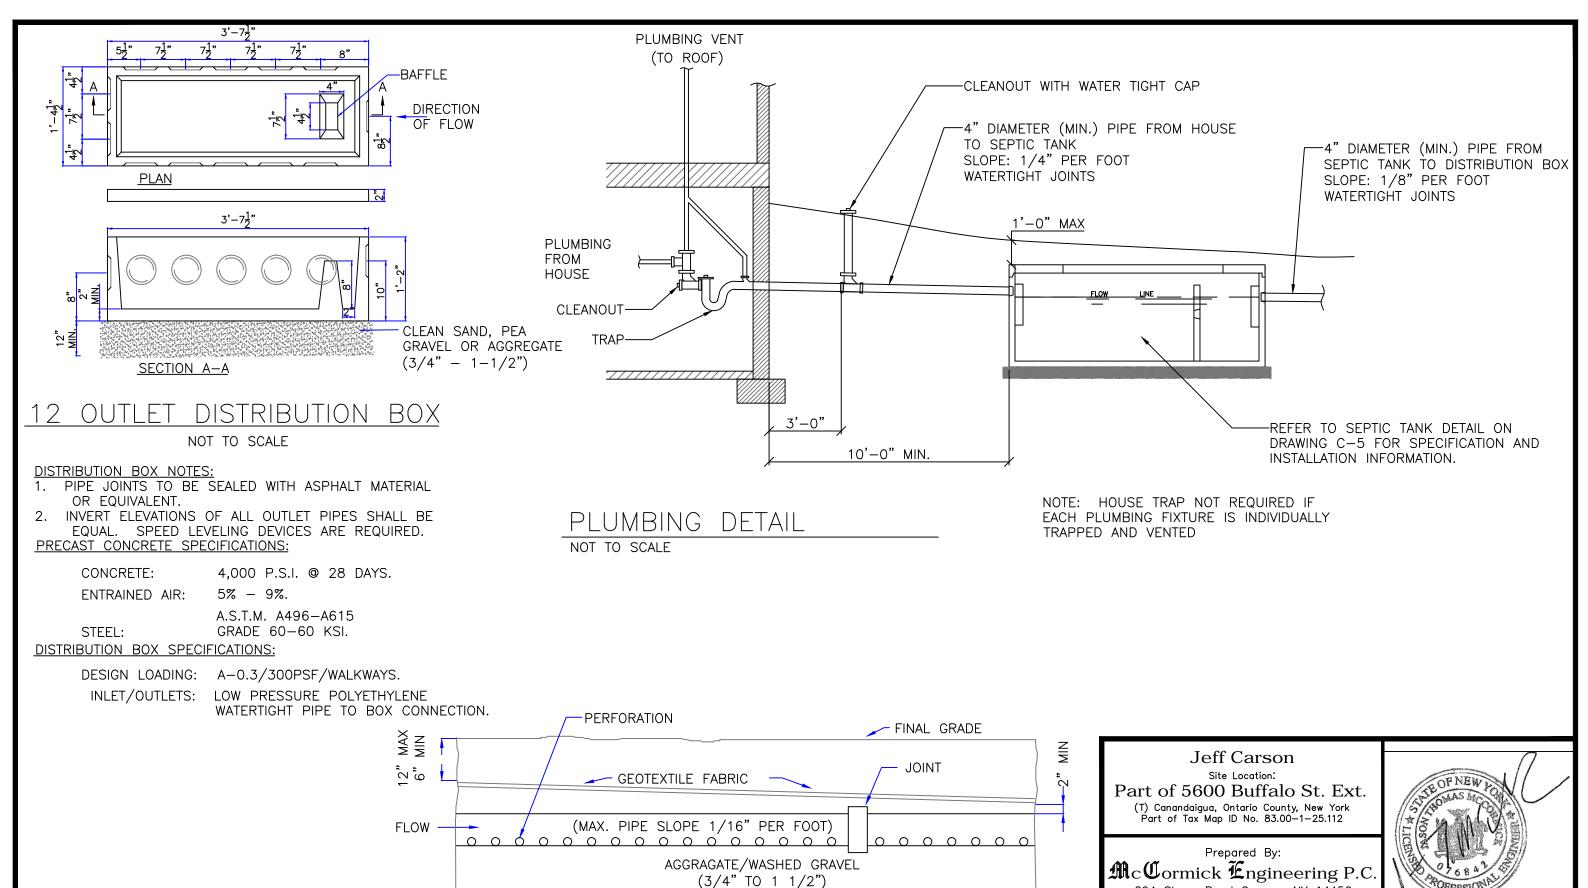


1) SPACING OF ABSORPTION TRENCH - 6' O.C.

2) ENDS OF ALL DISTRIBUTOR PIPES MUST BE CAPPED.

ABSORPTION TRENCH PROFILE -SECTION B-B SCALE: N.T.S.

294 Skuse Road Geneva, NY 14456

Tel: 585-721-7219 E-Mail: JTMccormickPE@aol.com

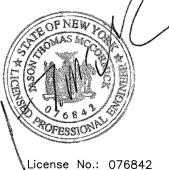


SEPTIC SYSTEM DETAILS 2 OF 3


Date: 04/01/20


Drawing No.:

C - 4.0

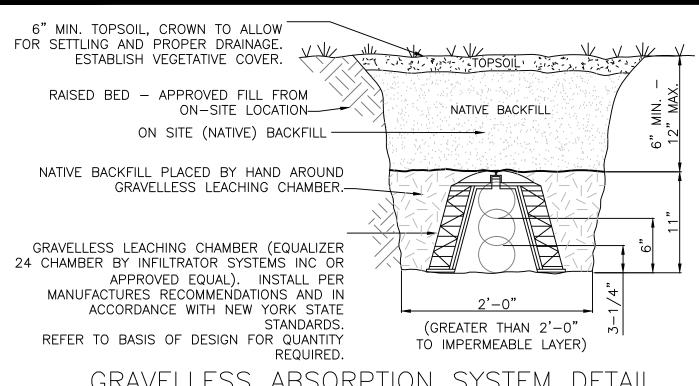

GRAVELLESS ABSORPTION SYSTEM DETAIL

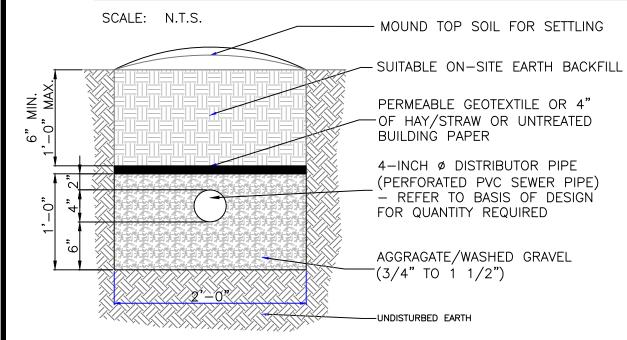

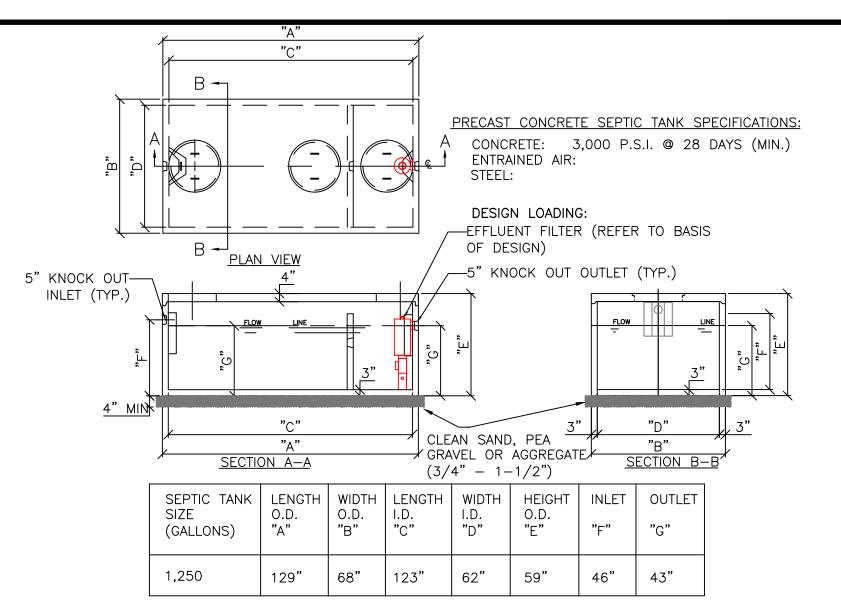

NOTES:

- CONTRACTOR SHALL VERIFY DIMENSIONS PRIOR TO CONSTRUCTION.
- INSTALL A ZABEL FILTER ON OUTLET
- REFER TO BASIS OF DESIGN NOTES ON DWG C-2 FOR ADDITIONAL INFORMATION.
- PLACE A MIN. OF 4-INCH OF CLEAN SAND, PEA GRAVEL OR AGGREGATE (3/4" 1-1/2") UNDER SEPTIC TANK.

SEPTIC TANK DETAIL

ABSORPTION TRENCH DETAIL

SCALE: 1" = 1'-0"

PIPE SCHEDULE					
LOCATION	SIZE	TYPE	SLOPE		
HOUSE TO SEPTIC TANK	4"	PVC SEWER PIPE (SCH. 40) - NON PERFORATED	1/4" PER FOOT (MIN)		
SEPTIC TANK TO DISTRIBUTION BOX	4"	PVC SEWER PIPE (SCH. 40) - NON PERFORATED	1/8" PER FOOT (MIN)		
DISTRIBUTION BOX TO DISTRIBUTOR PIPE	4"	PVC SEWER PIPE - NON PERFORATED	1/32" (MIN) - 1/8" (MAX) PER FOOT		
ABSORPTION TRENCH DISTRIBUTOR PIPE	4"	PVC SEWER PIPE - PERFORATED	1/16" PER FOOT (MAX)		
	OR	OR	OR		
GRAVELLESS LEACHING CHAMBER	EQ -24	INFILTRATOR EQUALIZER 24	LEVEL - 1/16" PER FOOT (MAX)		

REFER TO BASIS OF DESIGN FOR REQUIRED LENGTH OF ABSORPTION TRENCH.

Jeff Carson Site Location:


Part of 5600 Buffalo St. Ext.

(T) Canandaigua, Ontario County, New York Part of Tax Map ID No. 83.00-1-25.112

Prepared By:

McCormick Engineering P.C 294 Skuse Road Geneva, NY 14456

Tel: 585-721-7219 E-Mail: JTMccormickPE@aol.com

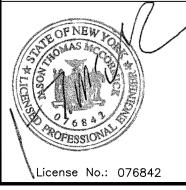


SEPTIC SYSTEM DETAILS 3 OF 3

Date: 04/01/20


Drawing No.:


C - 5.0

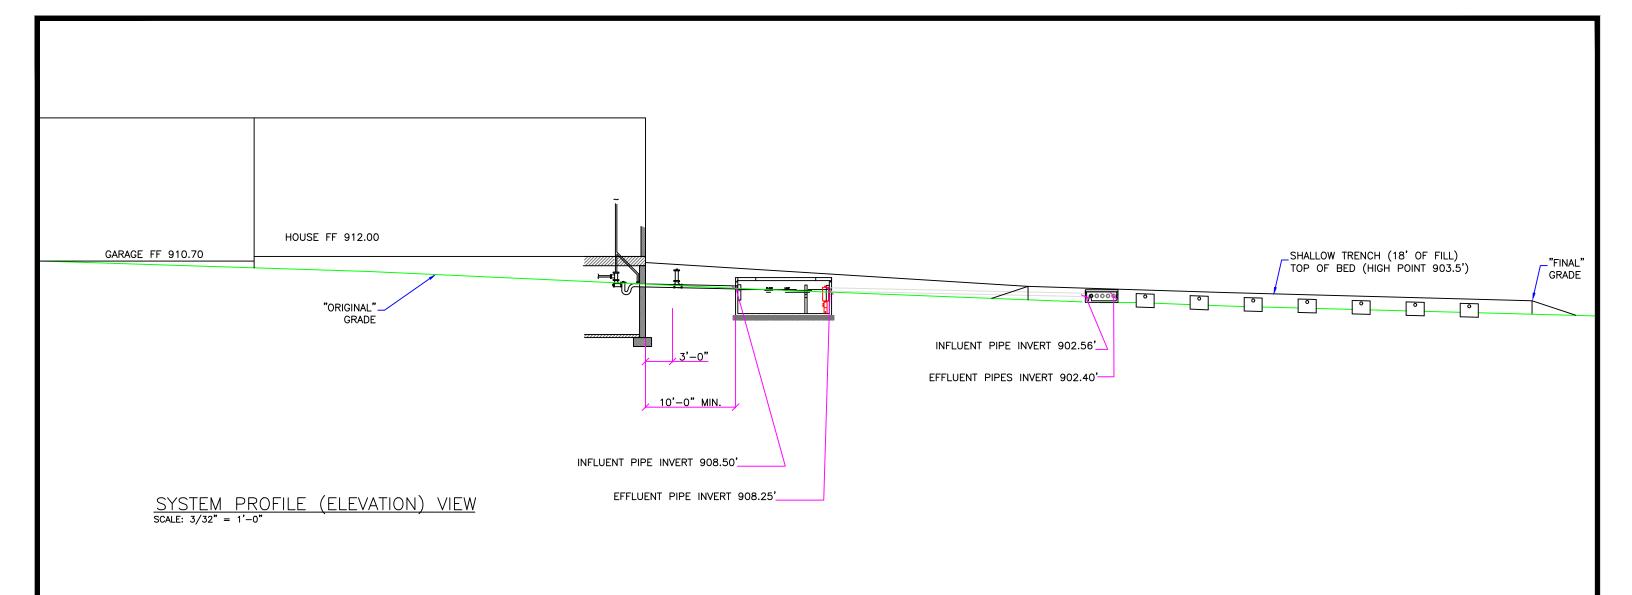

NOTE:

- 1. REFER TO PIPE SCHEDULE ON DRAWING C-5.0 FOR PIPE SCHEDULE (SIZE AND SLOPE)
- 2. SHALLOW TRENCH LEACH FIELD AREA INCLUDING TAPERS SHALL BE SEEDED AND MAINTAINED AS LAWN

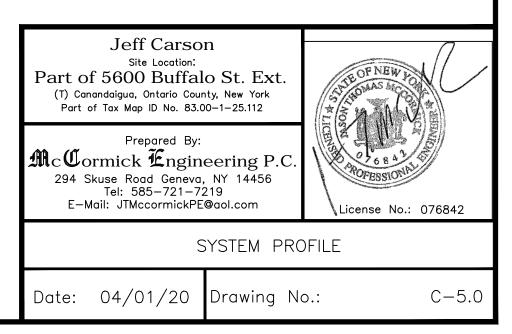

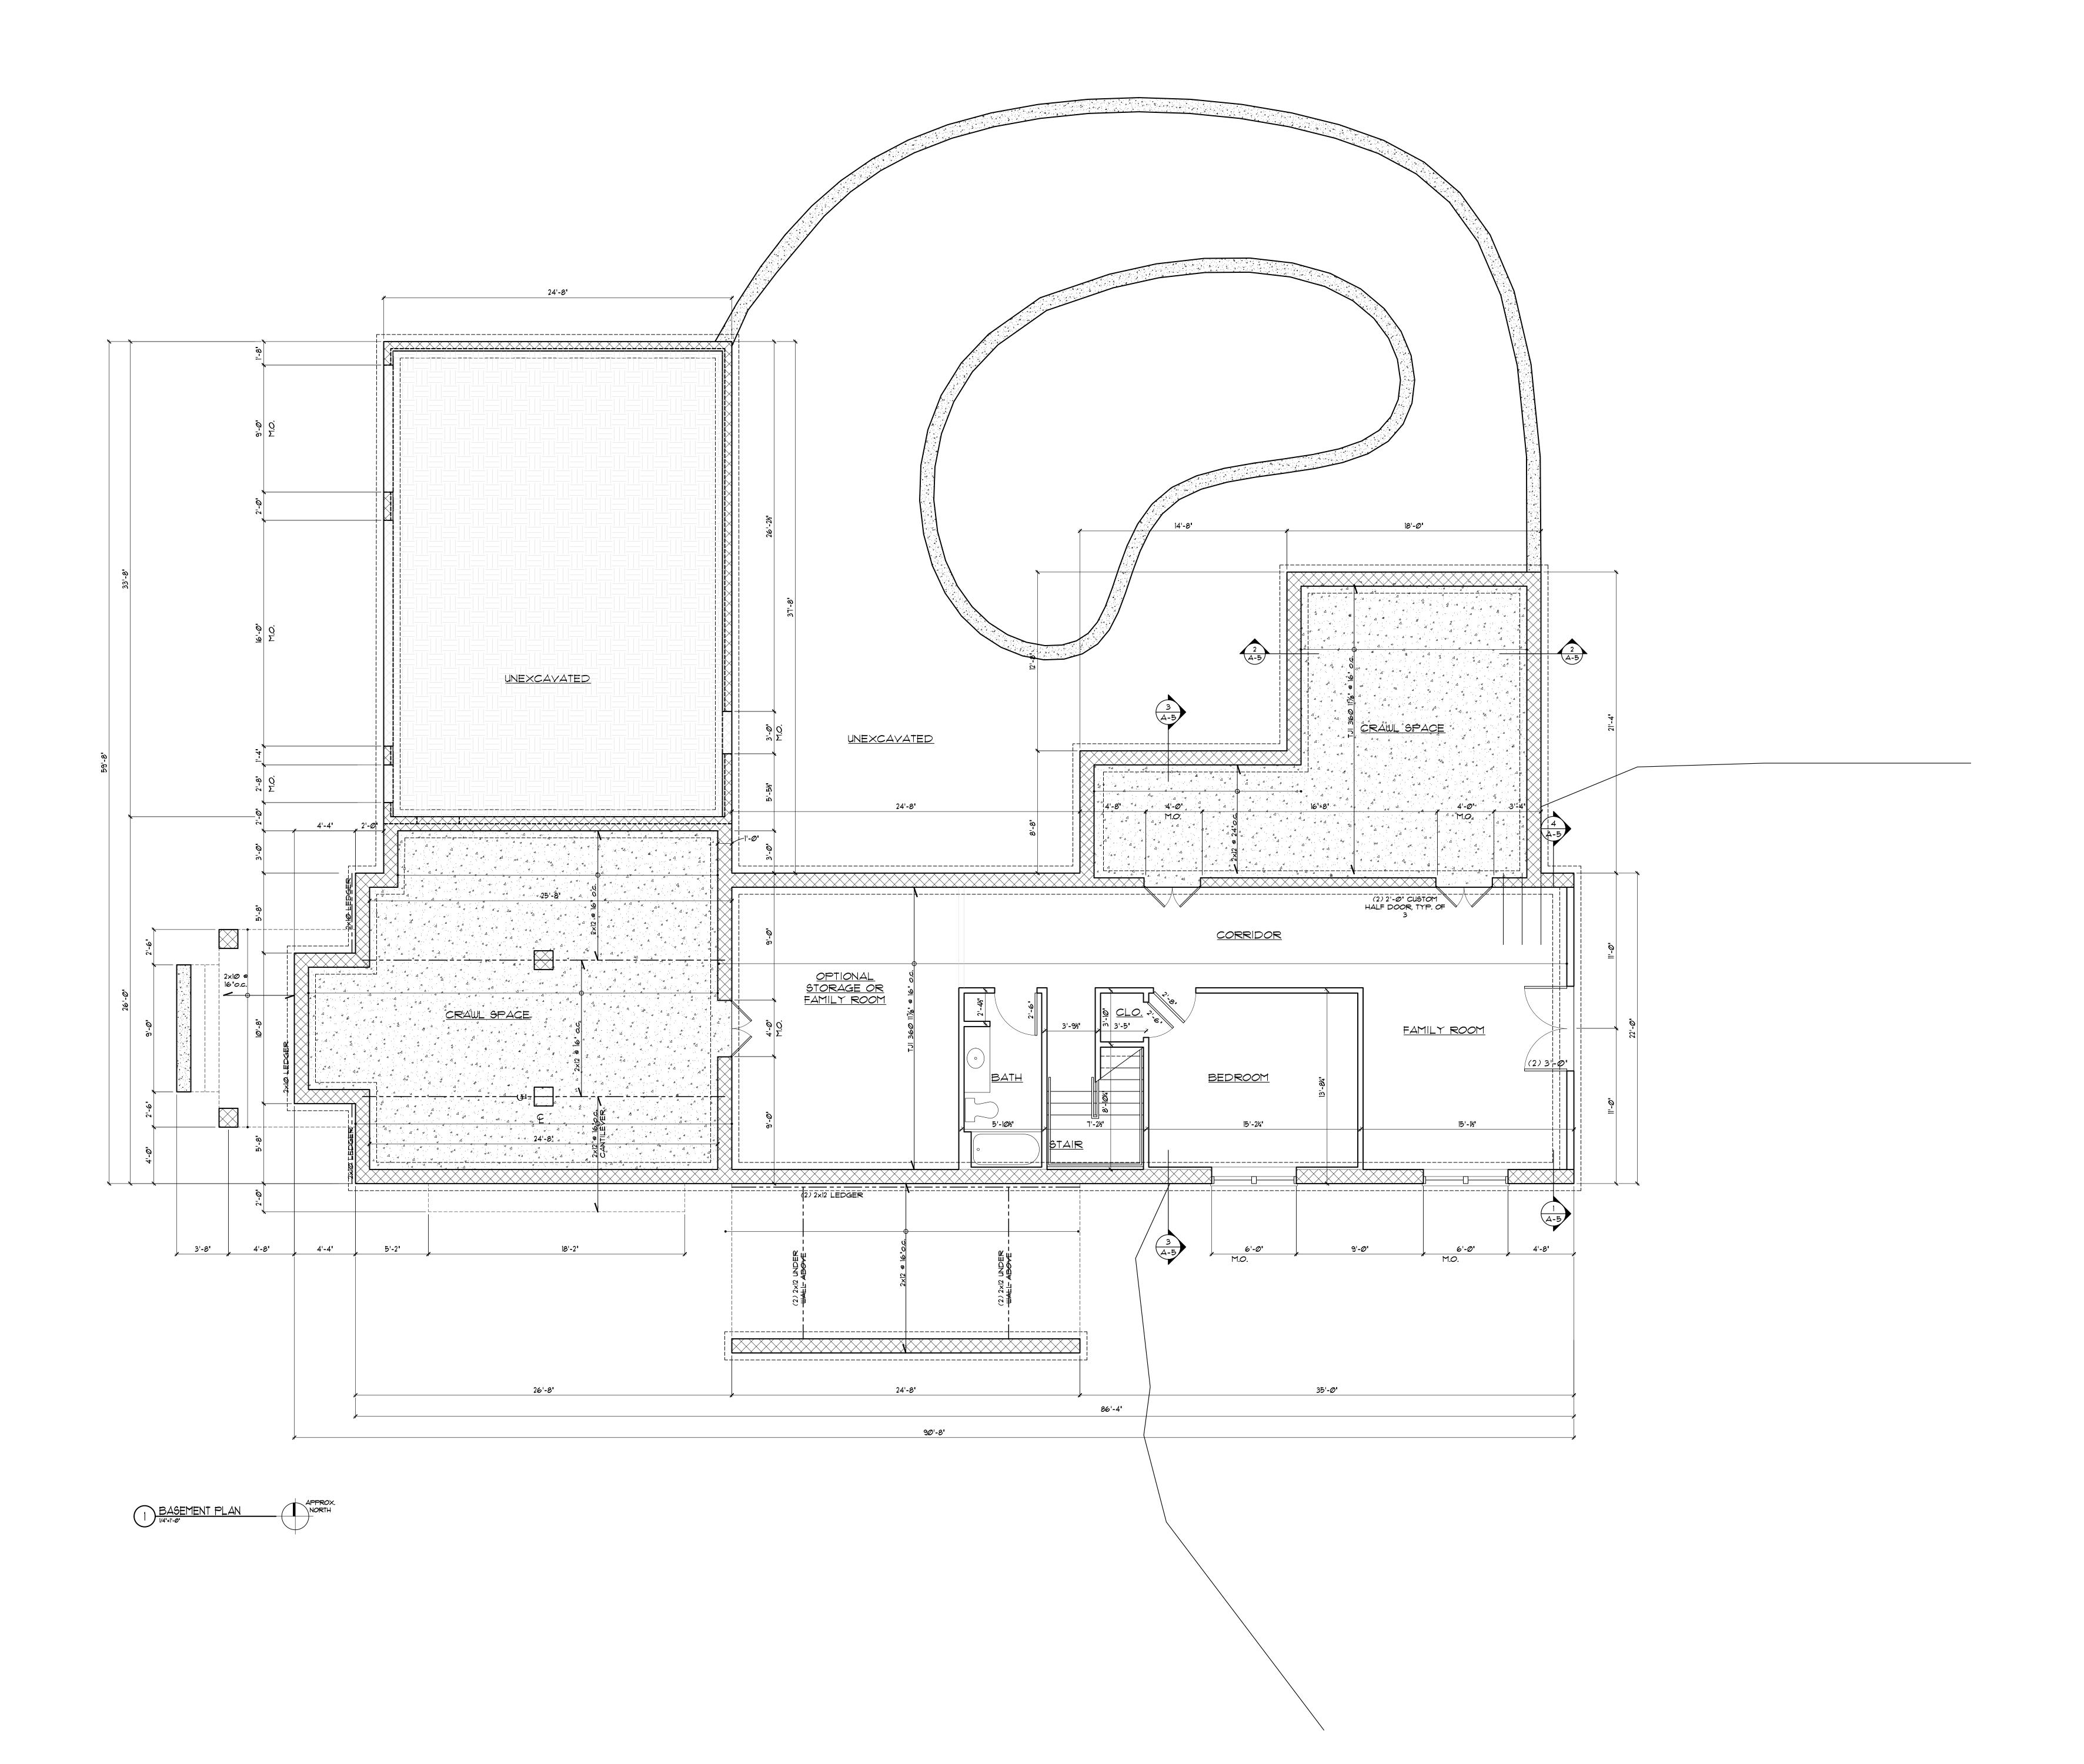

MATTHEW E. RISCHPATER ARCHITECT

PROJECT TITLE:

CARSON RESIDENCE

DRAWING TITLE:

BASEMENT PLAN AND FOUNDATION DETAILS

UNAUTH-ORIZED ALTERATIONS OR ADDITIONS TO THIS DRAWING APE IN WOLATION OF THE NEW YORK STATE EDUCATION LAW ARTICLE 147, SCOTION 726, NO REPORTITED

UNLESS AUTHORIZED BY TREASCHIRCT OF RECORD.

SCALE: AS NOTED

DATE: 01.30.20

MATTHEW E. RISCHPATER ARCHITECT

CARSON RESIDENCE

SCALE: AS NOTED DATE: 01.30.20

DRAWING TITLE:
FIRST FLOOR PLAN

