2.1 PROPERTY OWNER -

1.3 PARCEL AREA -23,130 SQ. FT (.531 AC) 2. OWNER INFORMATION:

2.2 MAILING ADDRESS -78 TREVOR COURT ROAD ROCHESTER, NY 14610 3. ZONING REGULATIONS: 3.1 ZONING DISTRICT - RLD (RESIDENTIAL LAKE)
3.2 ZONING REQUIREMENTS:

	SETPACK/ZONING D	COLUDENTO		
	SETBACK/ZONING R	EQUIREMENTS		
ITEM		REQUIRED	EXISTING	PROPOSED
	MIN FRONT SETBACK (FT)	60	81±	66±
PRINCIPAL	MIN REAR (LAKE) SETBACK (FT)	60	40.6	41*
BUILDING	MIN SIDE SETBACK (FT)	12	26±	12
	MAX BUILDING HEIGHT (FT)	25	23	27*
MAX BLDG LOT COVERAGE PERCENTAGE (%)		15	14	17.2*
MAX LOT CO	VERAGE PERCENTAGE (%)	25	34	29.9*

EDWARD & PATRICIA BREWER

3.3 VARIANCES BEING REQUESTED

•	47	VARIANCES BEING REQUESTED.							
	ITE	M:	REQUIRED		EXISTING PR		PROPOSED	(RELIEF)	
	A.	MAX BUILDING HEIGHT -		25'		23'	27'	(2')	
	B.	MIN REAR (LAKE) SETBACK -		60'		40.6'	41'	(19')	
	C.	MAX BUILDING LOT COVERAGE -		15%		14%	17.2%	(2.2%)	
	D.	MAX LOT COVERAGE -		25%		34%	29.9%	(4.9%)	

4. REFERENCES:

- 4.1 BOUNDARY SURVEY BOUNDARY INFORMATION WAS TAKEN FROM PLAN OF THE LAND OF EDWARD N. & PATRICIA R. BREWER 4727 COUNTY ROAD 16 TOWN OF CANANDAIGUA. ONTARIO COUNTY. NEW YORK PREPARED BY DAVID M. PARRINELLO DATED 09/24/2010 AND IS SHOWN FOR GRAPHICAL REPRESENTATION ONLY.
- 4.2 ARCHITECTURAL DRAWINGS THE ARCHITECTURAL PLANS WERE PROVIDED ON 02/18/2016, BY ARCHITECTURAL INNOVATIONS, P.C., DISCREPANCIES WITH BUILDING(S), CONTROL POINTS, AND/ OR TIE DIMENSIONS SHALL BE REPORTED TO THE DESIGN ENGINEER (PRIOR TO THE INSTALLATION OF IMPROVEMENTS) FOR COORDINATION AND CLARIFICATION.
- * EXISTING 100 YR FLOODPLAIN ELEVATION WAS PLOTTED BASED ON THE FEMA 100 YEAR FLOODPLAIN ELEVATION FOR CANANDAIGUA LAKE (692.00'), THE MAJORITY OF THE PROJECT SITE IS LOCATED WITHIN "ZONE A: NO BASE FLOOD ELEVATIONS DETERMINED," WITH A SMALL PORTION NEAR THE ROAD BEING LOCATED IN "ZONE X: AREA OUTSIDE OF THE 500 YEAR FLOOD PLAIN." REFER TO FEMA FLOOD INSURANCE RATE MAP, COMMUNITY-PANEL NUMBER 360598 0025 C, MAP DATED MARCH 3, 1997.

LEGEND:

EXISTING	PROPOSED	DESCRIPTION
SIGN	<u> </u>	SIGN
*	← □	LIGHT POLE
	===	POWER POLE
		GAS MAIN & VALVE
————E—————————————————————————————————		ELECTRIC CONDUIT & STRUCTURE
		TELEPHONE CONDUIT & STRUCTURE
	1+00 2+00	CENTERLINE AND STATIONING
		RIGHT-OF-WAY OR PROPERTY LINE
		CURB
x	x	FENCE (DESCRIPTION)
8"SA- 	8" PVC SDR-35 SAN @ 1.0%	SANITARY SEWER WITH MANHOLE
8"ST□	O12"PE ST ● 1.0%	STORM SEWER, MANHOLE & FIELD/DROP INLET
•	√	WATER MAIN WITH HYDRANT & GATE VALVE
		CENTERLINE OF SWALE
_525-	525	CONTOUR
		DRAINAGE FLOW ARROW
+ SHOT 525.00	525.0	SPOT ELEVATION
· · · · · · · · · · · · · · · · · · ·		TREE LINE
	\bigcirc	TREE PROTECTION
		100 YR FLOODPLAIN BOUNDARY*
		SEPTIC PERCOLATION TEST LOCATION

NOTES

- 1. MAPPING THE EXISTING UNDERGROUND UTILITIES WERE PLOTTED BASED ON RECORD MAPPING SUPPLIED BY OTHERS. THE ENGINEER MAKES NO WARRANTY AS TO THE LOCATION, SIZE, TYPE, ELEVATION, AND/OR NUMBER OF EXISTING UTILITIES. THE CONTRACTOR SHALL BE RESPONSIBLE FOR DETERMINING THE HORIZONTAL AND VERTICAL LOCATION OF UTILITIES IN THE VICINITY OF THE NEW INFRASTRUCTURE.
- 2. STAKEOUT THE CONTRACTOR SHALL NOTIFY DIG SAFELY NEW YORK (1-800-962-7962) FOR A UTILITY STAKEOUT 48 HOURS IN ADVANCE OF COMMENCING WORK. STAKEOUT OF PRIVATE UTILITIES SHALL BE COORDINATED WITH THE OWNER.
- 3. DATUM THE VERTICAL DATUM WAS SET USING CANANDAIGUA LAKE WATER ELEVATION PROVIDED BY CANANDAIGUA WATER TREATMENT PLANT ON 07/30/2015 AND AS RECORDED BY MARATHON ENGINEERING ON 07/30/2015 AND IS REFERENCED TO THE NATIONAL GEODETIC VERTICAL DATUM OF 1929.
- 4. PROPERTY PROTECTION THE CONTRACTOR IS RESPONSIBLE FOR DAMAGE TO EXISTING PAVEMENT, CURBS, WALKS, LAWNS, TREES, ETC. CAUSED BY THEIR CONSTRUCTION OPERATIONS. ALL DAMAGE SHALL BE REPAIRED OR REPLACED BY THE CONTRACTOR TO THE OWNER'S SATISFACTION AT NO ADDITIONAL EXPENSE.
- 5. ACCESS THE CONTRACTOR SHALL PROVIDE SATISFACTORY VEHICULAR ACCESS TO ALL ADJOINING PROPERTIES, PRIVATE ROADWAYS, PARKING FACILITIES, AND PUBLIC STREETS DURING CONSTRUCTION.
- 6. SITE SAFETY PRIOR TO AND THROUGHOUT CONSTRUCTION, THE CONTRACTOR SHALL POST SIGNAGE IN CONFORMANCE WITH THE REQUIREMENTS OF THE LOCAL MUNICIPALITY AND OCCUPATIONAL HEALTH AND SAFETY ACT (OHSA). JOB SAFETY AND MAINTENANCE AND PROTECTION OF TRAFFIC IS THE RESPONSIBILITY OF THE CONTRACTOR.
- 7. EXCAVATIONS ALL EXCAVATIONS SHALL BE BACKFILLED/BARRICADED TO THE SATISFACTION OF THE OWNER'S REPRESENTATIVE AT THE CONCLUSION OF EACH WORKING DAY. 8. MAINTENANCE - PUBLIC STREETS, PRIVATE DRIVES AND PARKING FACILITIES SHALL BE KEPT FREE OF FOREIGN

OWNER'S ON-SITE REPRESENTATIVE.

9. CONSTRUCTION STORAGE - STORAGE OF EQUIPMENT AND MATERIALS SHALL BE WITHIN A SPECIFIED AND SECURED AREA AS DETERMINED IN CONTRACT DOCUMENTS OR AS SPECIFIED BY THE OWNER'S ON-SITE REPRESENTATIVE.

MATERIALS. ALL AREAS SHALL BE SWEPT CLEAN AT THE END OF EACH WORKING DAY AND/OR AS DIRECTED BY THE


- 10. PERMIT(S) PRIOR TO CONSTRUCTION, THE CONTRACTOR SHALL OBTAIN THE NECESSARY PERMITS FROM THE APPLICABLE MUNICIPALITY OR AGENCY. THE CONTRACTOR IS RESPONSIBLE FOR ALL BONDS AND INSURANCES AND THE OWNER IS RESPONSIBLE FOR PERMIT FEES UNLESS OTHERWISE STATED IN THE OWNER/ CONTRACTOR AGREEMENT
- 11. ROOF LEADERS ALL ROOF LEADERS AND SPLASH BLOCK OUTFALLS SHALL BE DIRECTED AND ROUTED AROUND LEACH FIELD AREAS.
- 12. TREES THE VEGETATION WITHIN THE LIMITS OF DISTURBANCE SHALL BE SELECTIVELY REMOVED AS REQUIRED FOR CONSTRUCTION. VEGETATION TO REMAIN SHALL BE PROTECTED TO THE DRIP EDGE OF THE TREE. COORDINATE REMOVAL OF VEGETATION WITH OWNER AND CONTRACTOR.
- 13. LIMITS OF DISTURBANCE THE LIMITS OF DISTURBANCE FOR THE PROJECT SHALL BE CONSIDERED TO BE THE PROPERTY LINES OF THE PROJECT PARCEL.


DEMOLITION LEGEND


- DEMOLISH EXISTING HOME. BACKFILL EXCAVATION WITH SELECT FILL AS AS REQUIRED TO BRING TO REQUIRED GRADE FOR CONSTRUCTION OF NEW RESIDENCE. COORDINATE WITH ARCHITECTURAL DRAWINGS FOR FOUNDATION DESIGN. REMOVE ALL EXISTING DECKS AND PORCHES. ALL CONNECTING WALKWAYS AND SIDEWALKS TO BE REMOVED. DISPOSE OF DEMOLISHED MATERIAL OFF SITE IN SAFE, LEGAL MANNER.
- 2 DEMOLISH EXISTING STRUCTURE
- ABANDON/REMOVE EXISTING SEPTIC SYSTEM: PUMP OUT SEPTIC TANK, THEN REMOVE SEPTIC COVER. FOR TANK LOCATED UNDER PROPOSED HOME, REMOVE ENTIRELY. FOR TANK LOCATED WITHIN LAWN AREA, INSERT HOLES INTO TANK BOTTOM, AND FILL TO GRADE WITH SAND. REMOVE DISTRIBUTION BOXES AND PLUG ALL LINES WITH CONCRETE. REMOVE ALL LEACH LINES UNDER PROPOSED HOME-- ALL OTHER LEACH LINES MAY BE ABANDONED IN PLACE.
- REMOVE EXISTING DRIVEWAY AS REQUIRED FOR COINSTRUCTION OF NEW DRIVEWAY.

CONSTRUCTION SEQUENCE

- 1. OBTAIN ALL NECESSARY APPROVALS AND PERMITS
- 2. FLAG WORK LIMITS AND EXISTING SEPTIC LEACH FIELD
- 3. LOCATE ALL UNDERGROUND UTILITIES (CONTACT DIG SAFE NY) 4. INSTALL PERIMETER SEDIMENT CONTROLS, I.E. EROSION FENCING AND CHECK DAMS
- 5. PROTECT VEGETATION TO REMAIN
- COMPLETE DRIVEWAY STABILIZATION
- 7. DEMOLISH EXISTING HOUSE, SHED AND GARAGE
- 8. COMPLETE CLEARING AND GRUBBING OPERATION
- 9. PLACE EROSION CONTROL MEASURES AT TOPSOIL STOCKPILES AND STRIP TOPSOIL
- 10. PERFORM ROUGH GRADING
- 11. CONSTRUCT NEW HOUSE AND SEPTIC SYSTEM
- 12. MAINTAIN EROSION CONTROL MEASURES AND PLACE ADDITIONAL MEASURES AS EARTHWORK,
- UNDERGROUND UTILITIES AND STRUCTURES ARE CONSTRUCTED
- 13. FINALIZE ROUGH GRADING AND FINE GRADING 14. RESTORE DISTURBED AREAS WITH TOPSOIL, SEED AND MUCH
- 15. REMOVE EROSION CONTROL MEASURES AS AREAS ARE REESTABLISHED WITH GROUND COVER

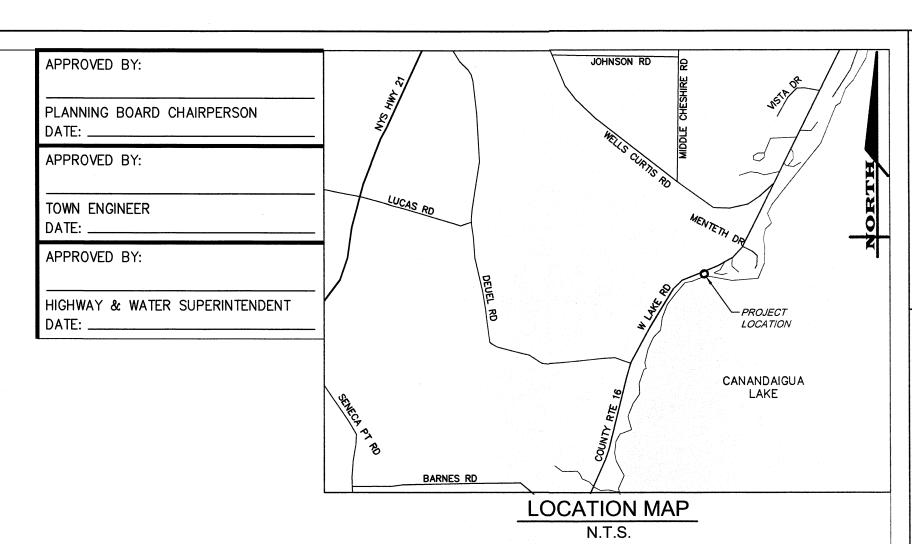

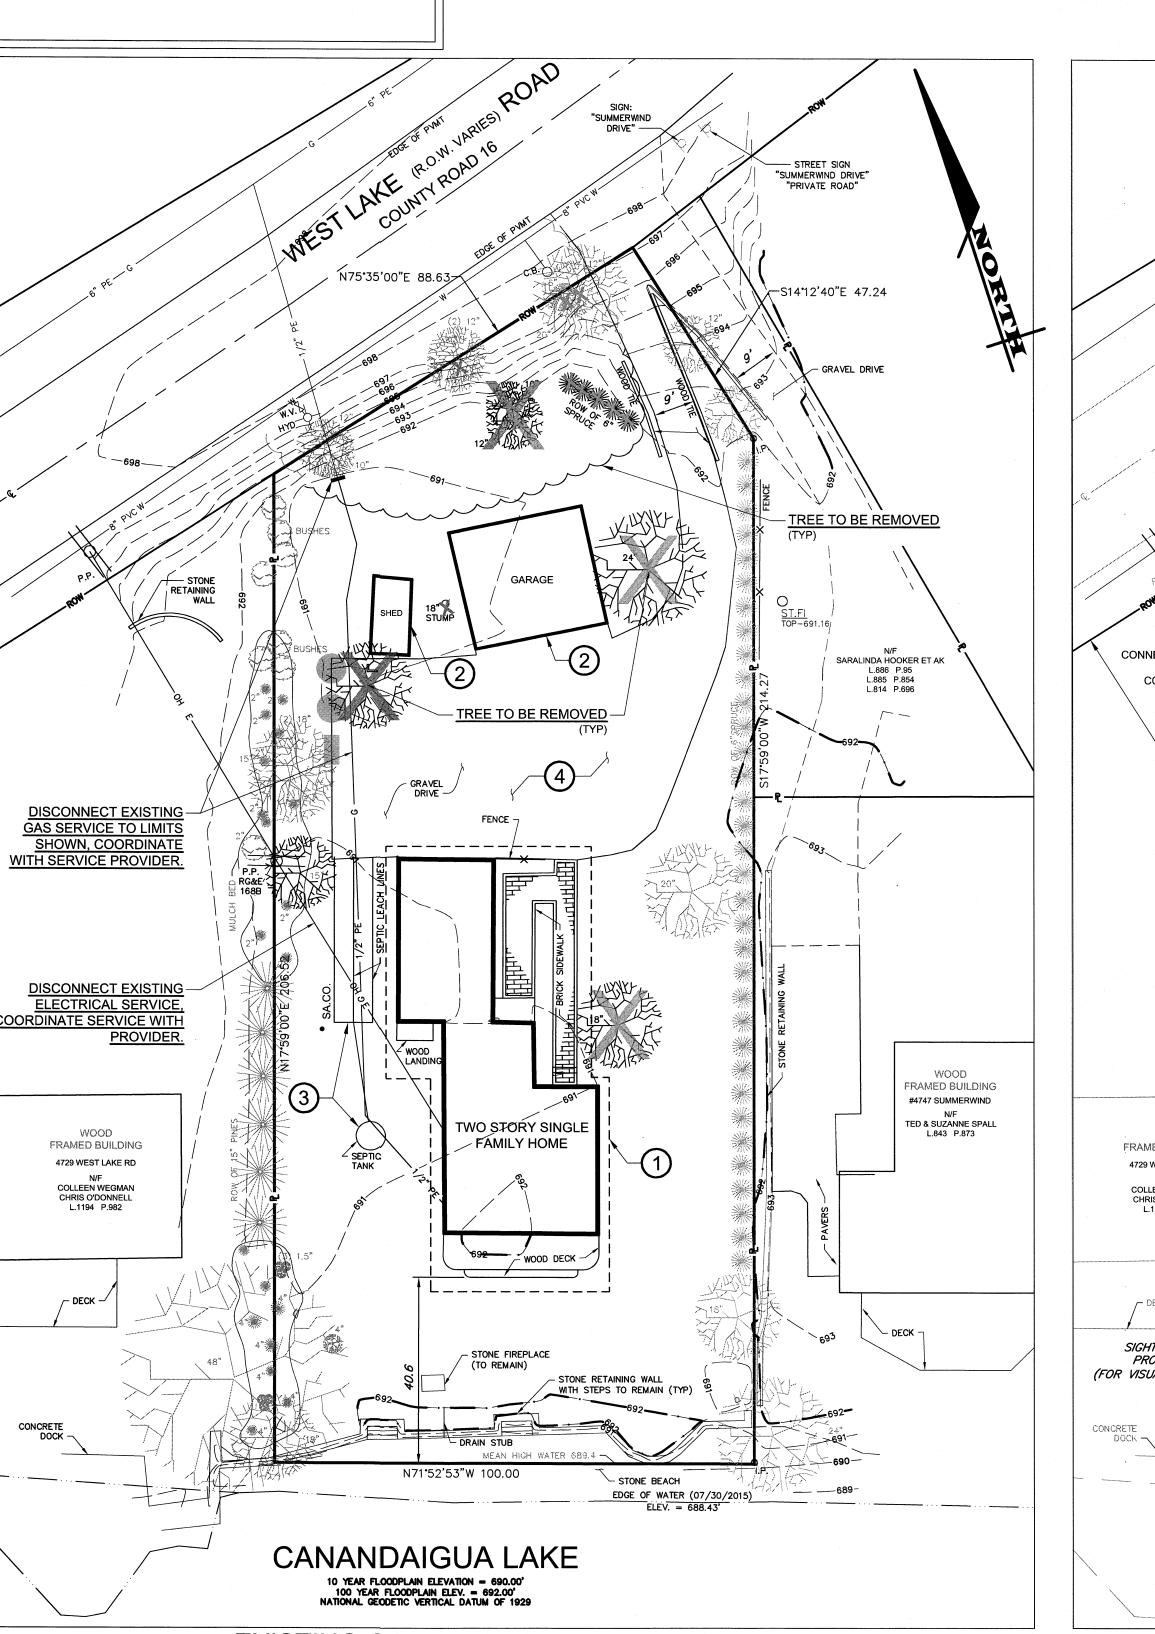

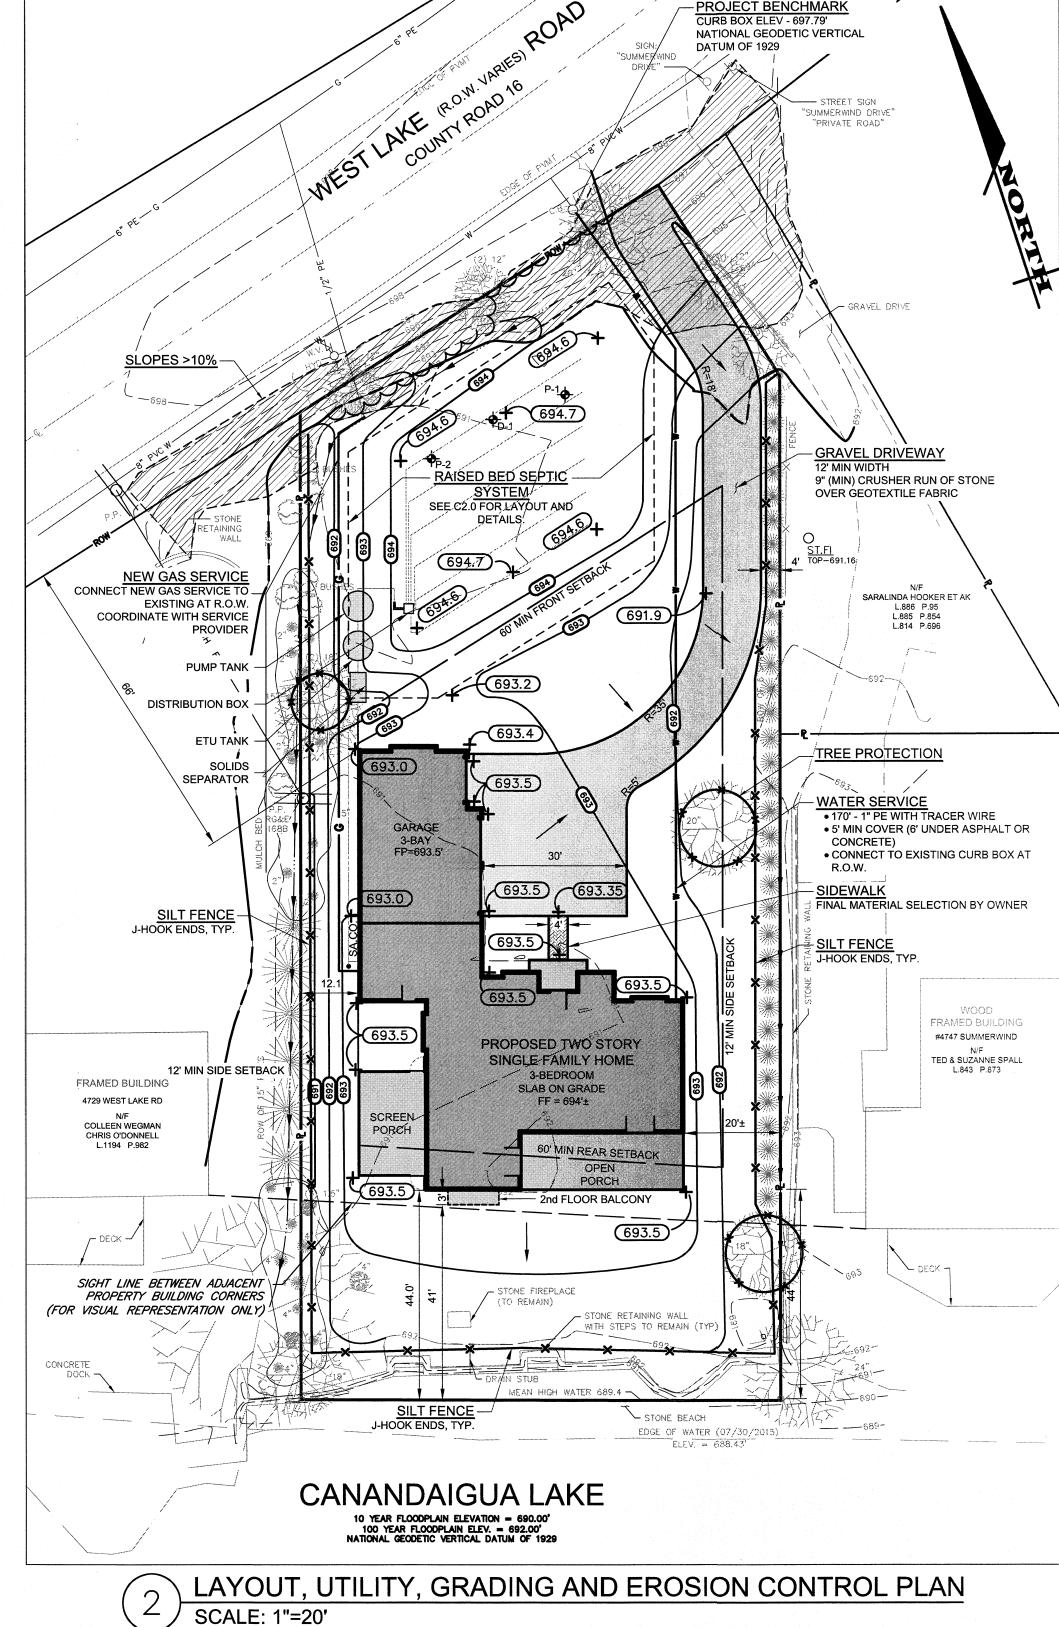

ENGINEERING 39 CASCADE DRIVE ROCHESTER, NY 14614

PHONE 585-458-7770 www.marathoneng.com

JOB NO: 0674-15 SCALE: AS SHOWN DRAWN: PBG RPB DESIGNED: 12/09/2015 REVISIONS DATE BY REVISION 12/15/15 DAM DRC COMMENTS 02/22/16 | PBG | 2016 LAYOUT

DATE:

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DRAWING TITLE: LAYOUT, UTILITY, **GRADING & EROSION**


CONTROL PLANS

ROBER P. BRINGLEY

1 of 2 SHEET No: 0674-15 DRAWING No: JOB No:


EXISTING CONDITIONS & DEMOLITION PLAN

SCALE: 1"=20'

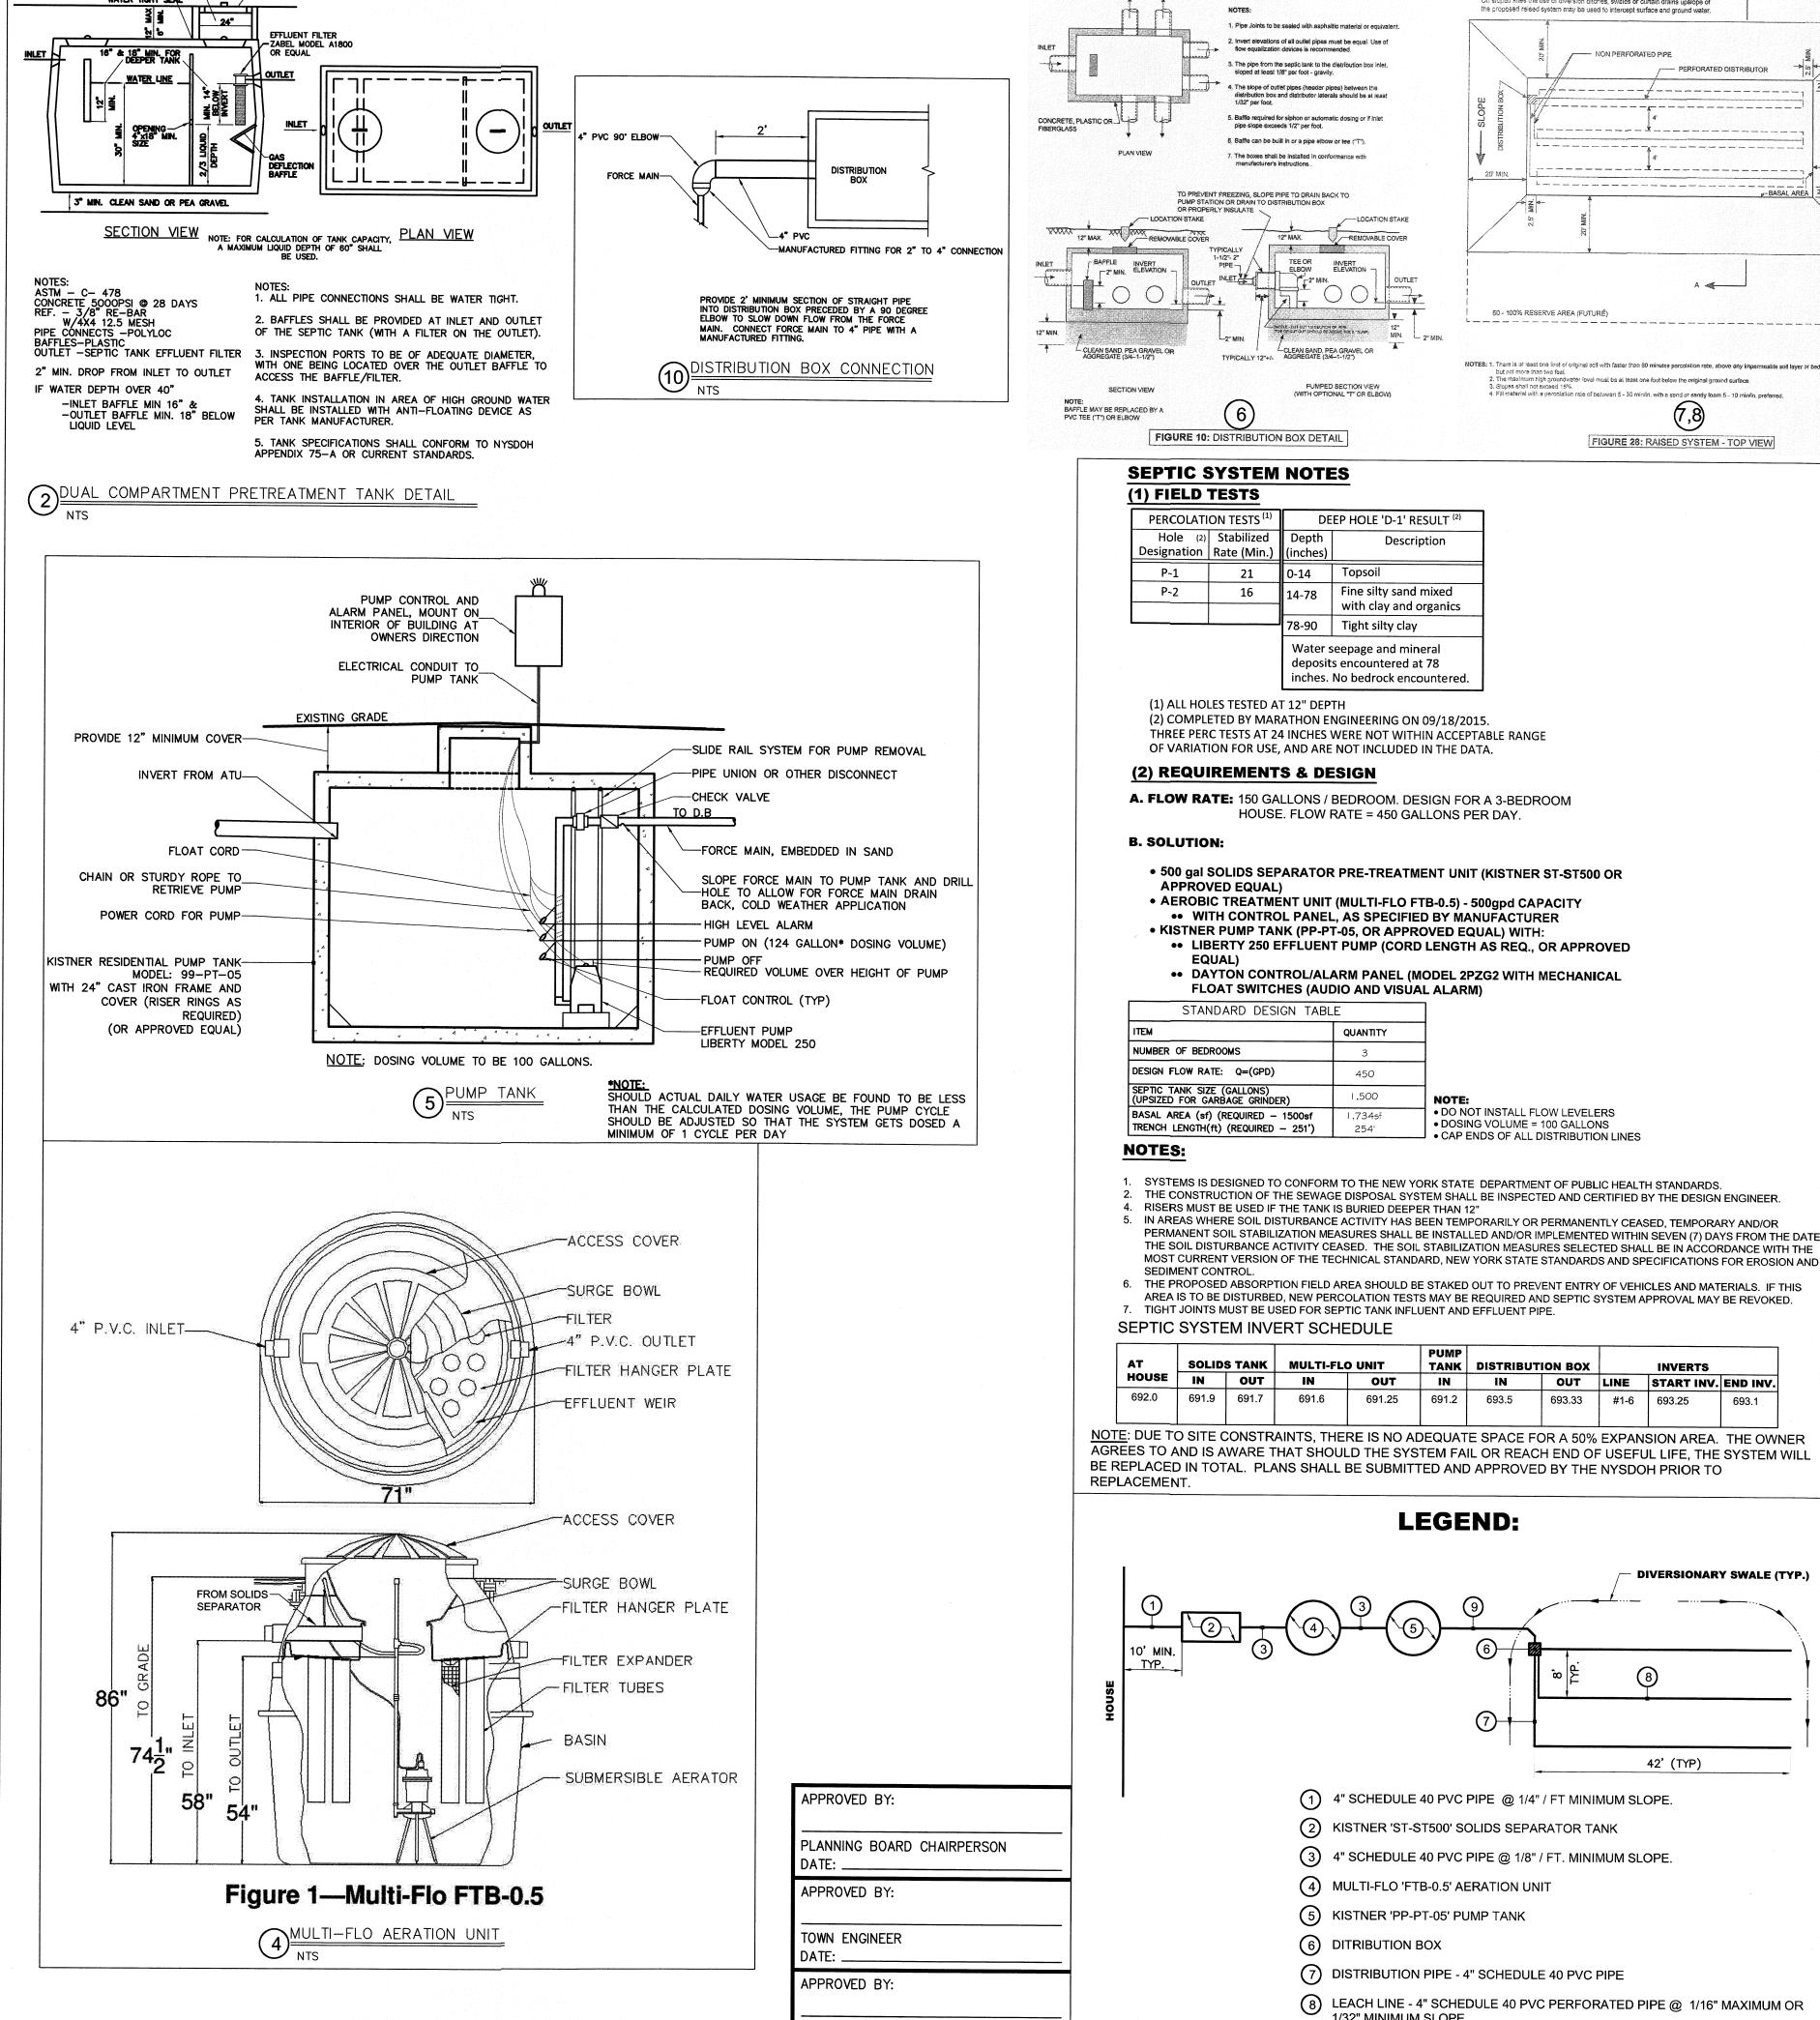

PROVIDE RISER IF TANK IS DEEPER THAN 12"

24" CLEAR OPENING

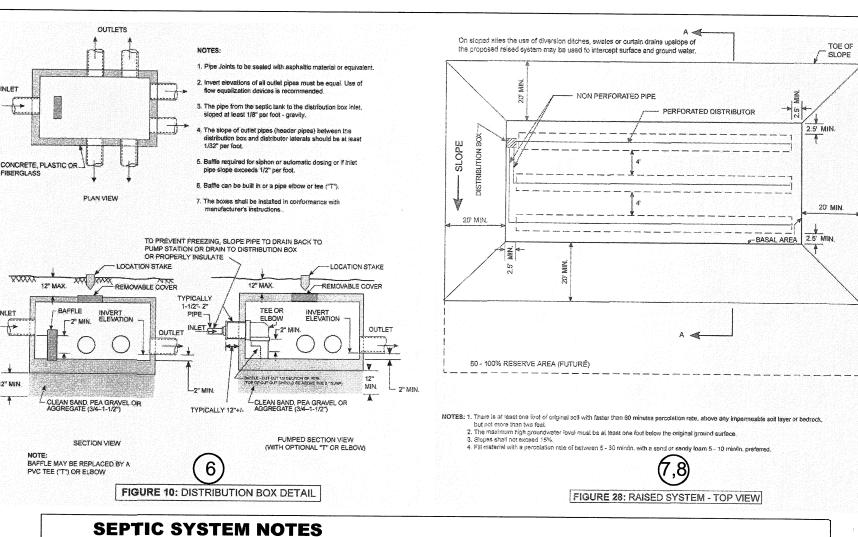

DEEP HOLE 'D-1' RESULT (2)

Fine silty sand mixed

with clay and organics

P-1 P-2

16

APPROVED EQUAL)

STANDARD DESIGN TABLE

SOLIDS TANK | MULTI-FLO UNIT

691.6

14-78

78-90 Tight silty clay

Water seepage and mineral deposits encountered at 78

inches. No bedrock encountered.

HOUSE. FLOW RATE = 450 GALLONS PER DAY.

•• WITH CONTROL PANEL, AS SPECIFIED BY MANUFACTURER

QUANTITY

1.500

FLOAT SWITCHES (AUDIO AND VISUAL ALARM)

•• LIBERTY 250 EFFLUENT PUMP (CORD LENGTH AS REQ., OR APPROVED

•• DAYTON CONTROL/ALARM PANEL (MODEL 2PZG2 WITH MECHANICAL

• DO NOT INSTALL FLOW LEVELERS

TANK DISTRIBUTION BOX

LEGEND:

4" SCHEDULE 40 PVC PIPE @ 1/4" / FT MINIMUM SLOPE.

3 4" SCHEDULE 40 PVC PIPE @ 1/8" / FT. MINIMUM SLOPE.

8 LEACH LINE - 4" SCHEDULE 40 PVC PERFORATED PIPE @ 1/16" MAXIMUM OR 1/32" MINIMUM SLOPE.

(2) KISTNER 'ST-ST500' SOLIDS SEPARATOR TANK

7 DISTRIBUTION PIPE - 4" SCHEDULE 40 PVC PIPE

4 MULTI-FLO 'FTB-0.5' AERATION UNIT

5 KISTNER 'PP-PT-05' PUMP TANK

6 DITRIBUTION BOX

9 1-1/2" FORCE MAIN

HIGHWAY & WATER SUPERINTENDENT


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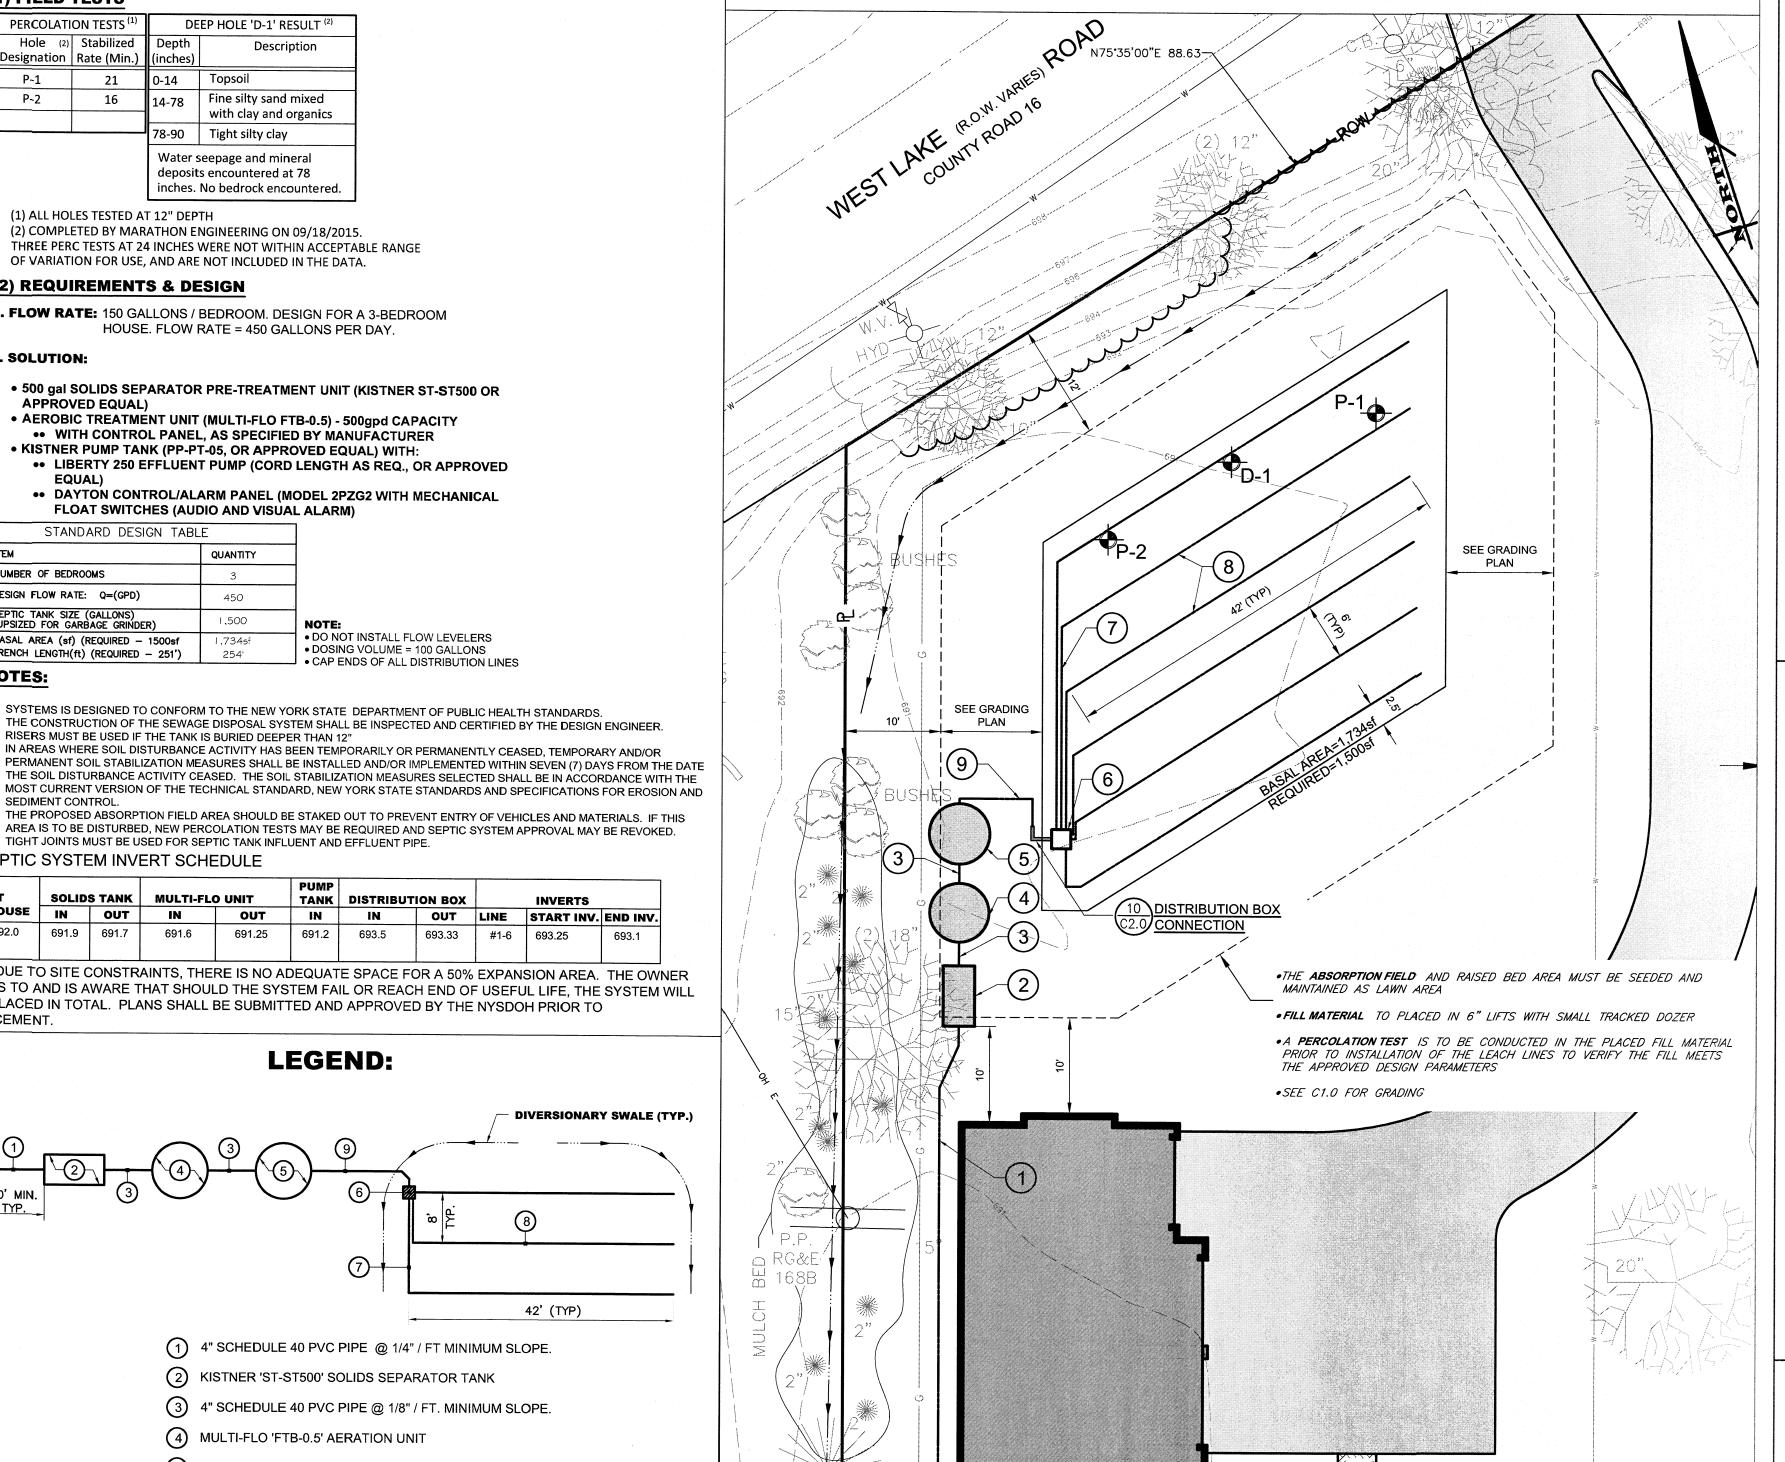
691.25 | 691.2 | 693.5 | 693.33 | #1-6 | 693.25

OUT IN IN OUT LINE START INV. END INV.

42' (TYP)

DOSING VOLUME = 100 GALLONS
 CAP ENDS OF ALL DISTRIBUTION LINES



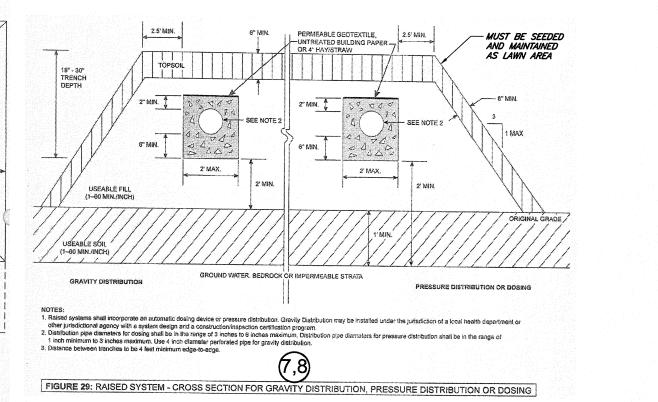

SEPTIC SYSTEM PLAN

SCALE: 1"=10'

FF= 694.0'



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M

JOB NO: 0674-15 AS SHOWN DRAWN:

DESIGNED: RPB 12/09/2015

REVISIONS DATE BY REVISION 12/15/15 DAM DRC COMMENTS 02/22/16 | PBG | 2016 LAYOUT

DATE:

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DRAWING TITLE: SEPTIC PLAN AND CONSTRUCTION DETAILS

2 of 2 SHEET No: 0674-15 JOB No: DRAWING No: