
## SITE ENGINEERING DRAWINGS FOR

# CENTERPOINTE APARTMENTS PHASE 3

# TOWN OF CANANDAIGUA ONTARIO COUNTY, NEW YORK MAY 2016

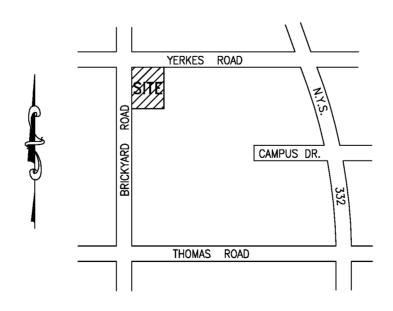

LOCATION MAP

PLANNING BOARD CHAIRMAN	DATE
TOWN ENGINEER	DATE
CANANDAIGUA FARMINGTON WATER DISTRICT	DATE
CANANDAIGUA HIGHWAY SUPERINTENDENT	DATE

<u>EXISTING</u>	
uuuuu	TREE/BRUSH LINES
620X3	SPOT ELEVATION
	R.O.W./STREETLINE
	PROPERTY LINE
468	CONTOUR LINE
	HOUSE/BUILDING
þ	POWER POLE
w	WATER LINE
X	HYDRANT
×	WATER VALVE
0	CATCH BASIN
•	STORM SEWER MANHOLE
<del></del>	CENTERLINE OF ROAD
<u>PROPOSED</u>	
466	CONTOUR LINE
•	CATCH BASIN
	SANITARY MANHOLE
•	STORM MANHOLE
000000000000000000000000000000000000000	STAKED STRAW BALE OR FABRIC FENCE
	PROPERTY LINE
**	HYDRANT
w	WATER VALVE
*	CURB BOX

**LEGEND** 

McMahon LaRue Associates, P. C.

**Engineers & Surveyors** 

822 Holt Road Webster, NY 14580 (585) 436-1080 www.McMahon-LaRue.com DRAWING INDEX

EROSION CONTROL PLAN

UTILITY REMOVAL PLAN

UTILITY PLAN

GRADING PLAN

LIGHTING PLAN

DETAILS

11. DETAILS

12. DETAILS


DETAILS


9.


LANDSCAPE PLAN


COVER SHEET

2. SITE PLAN

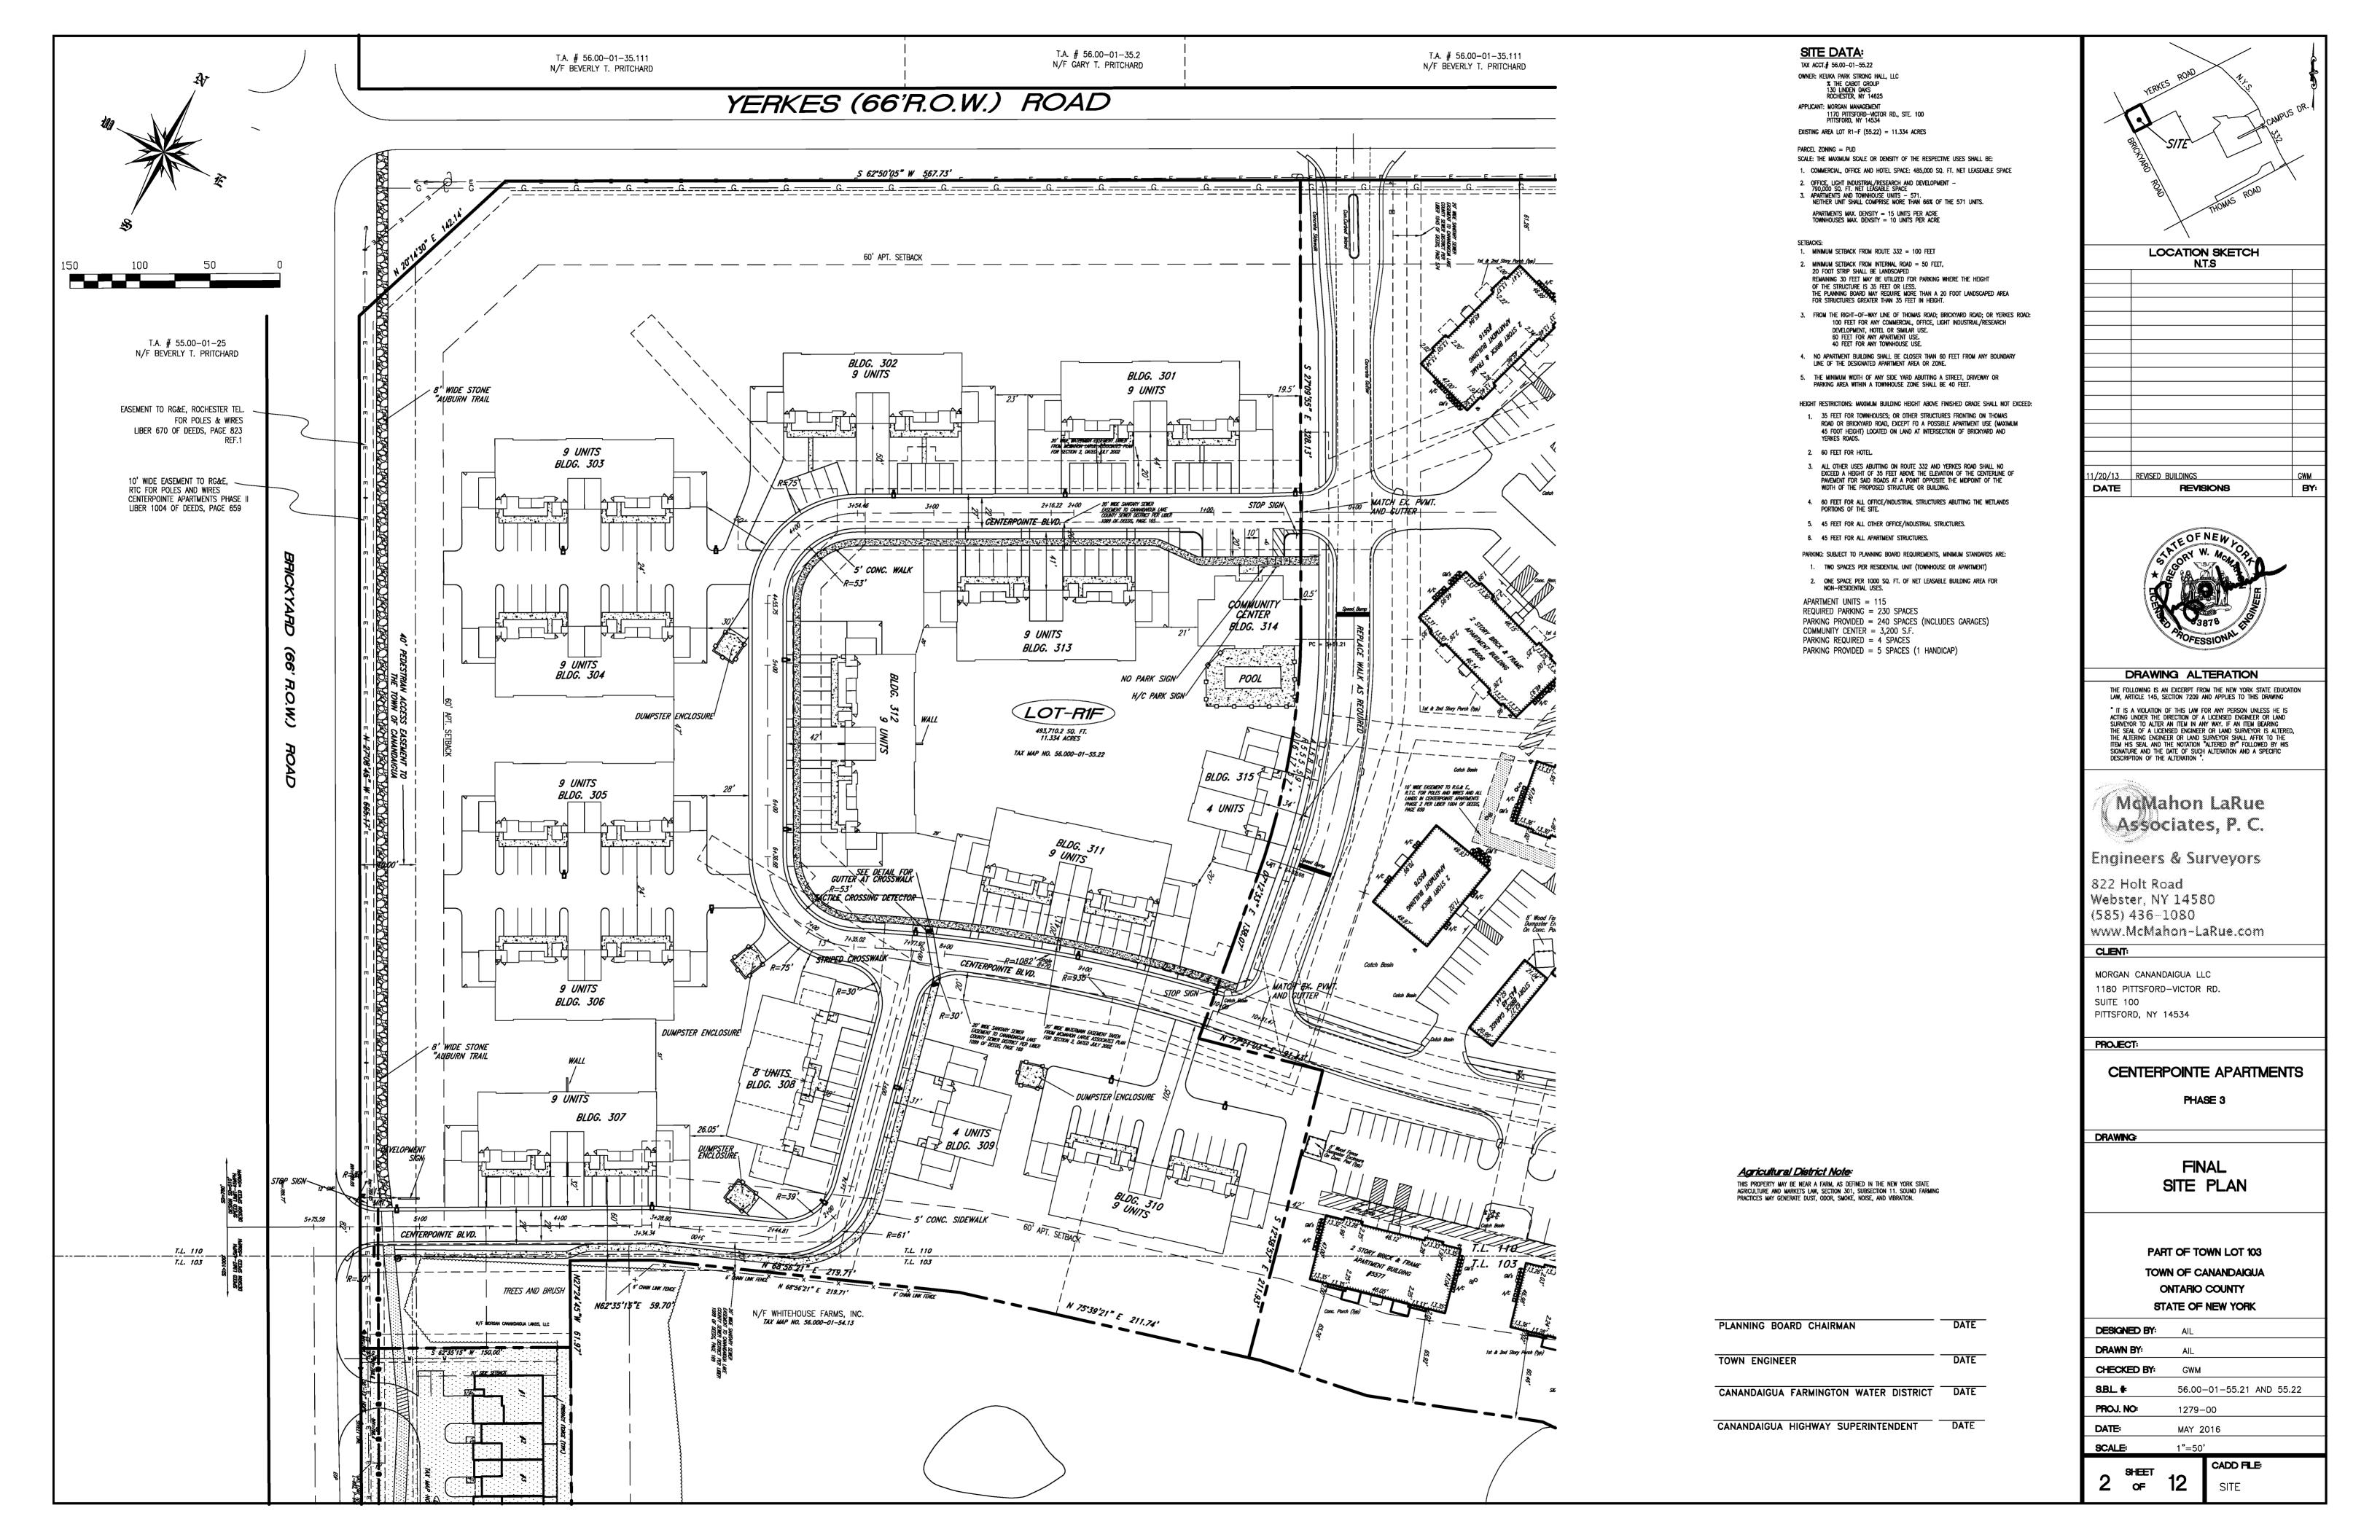

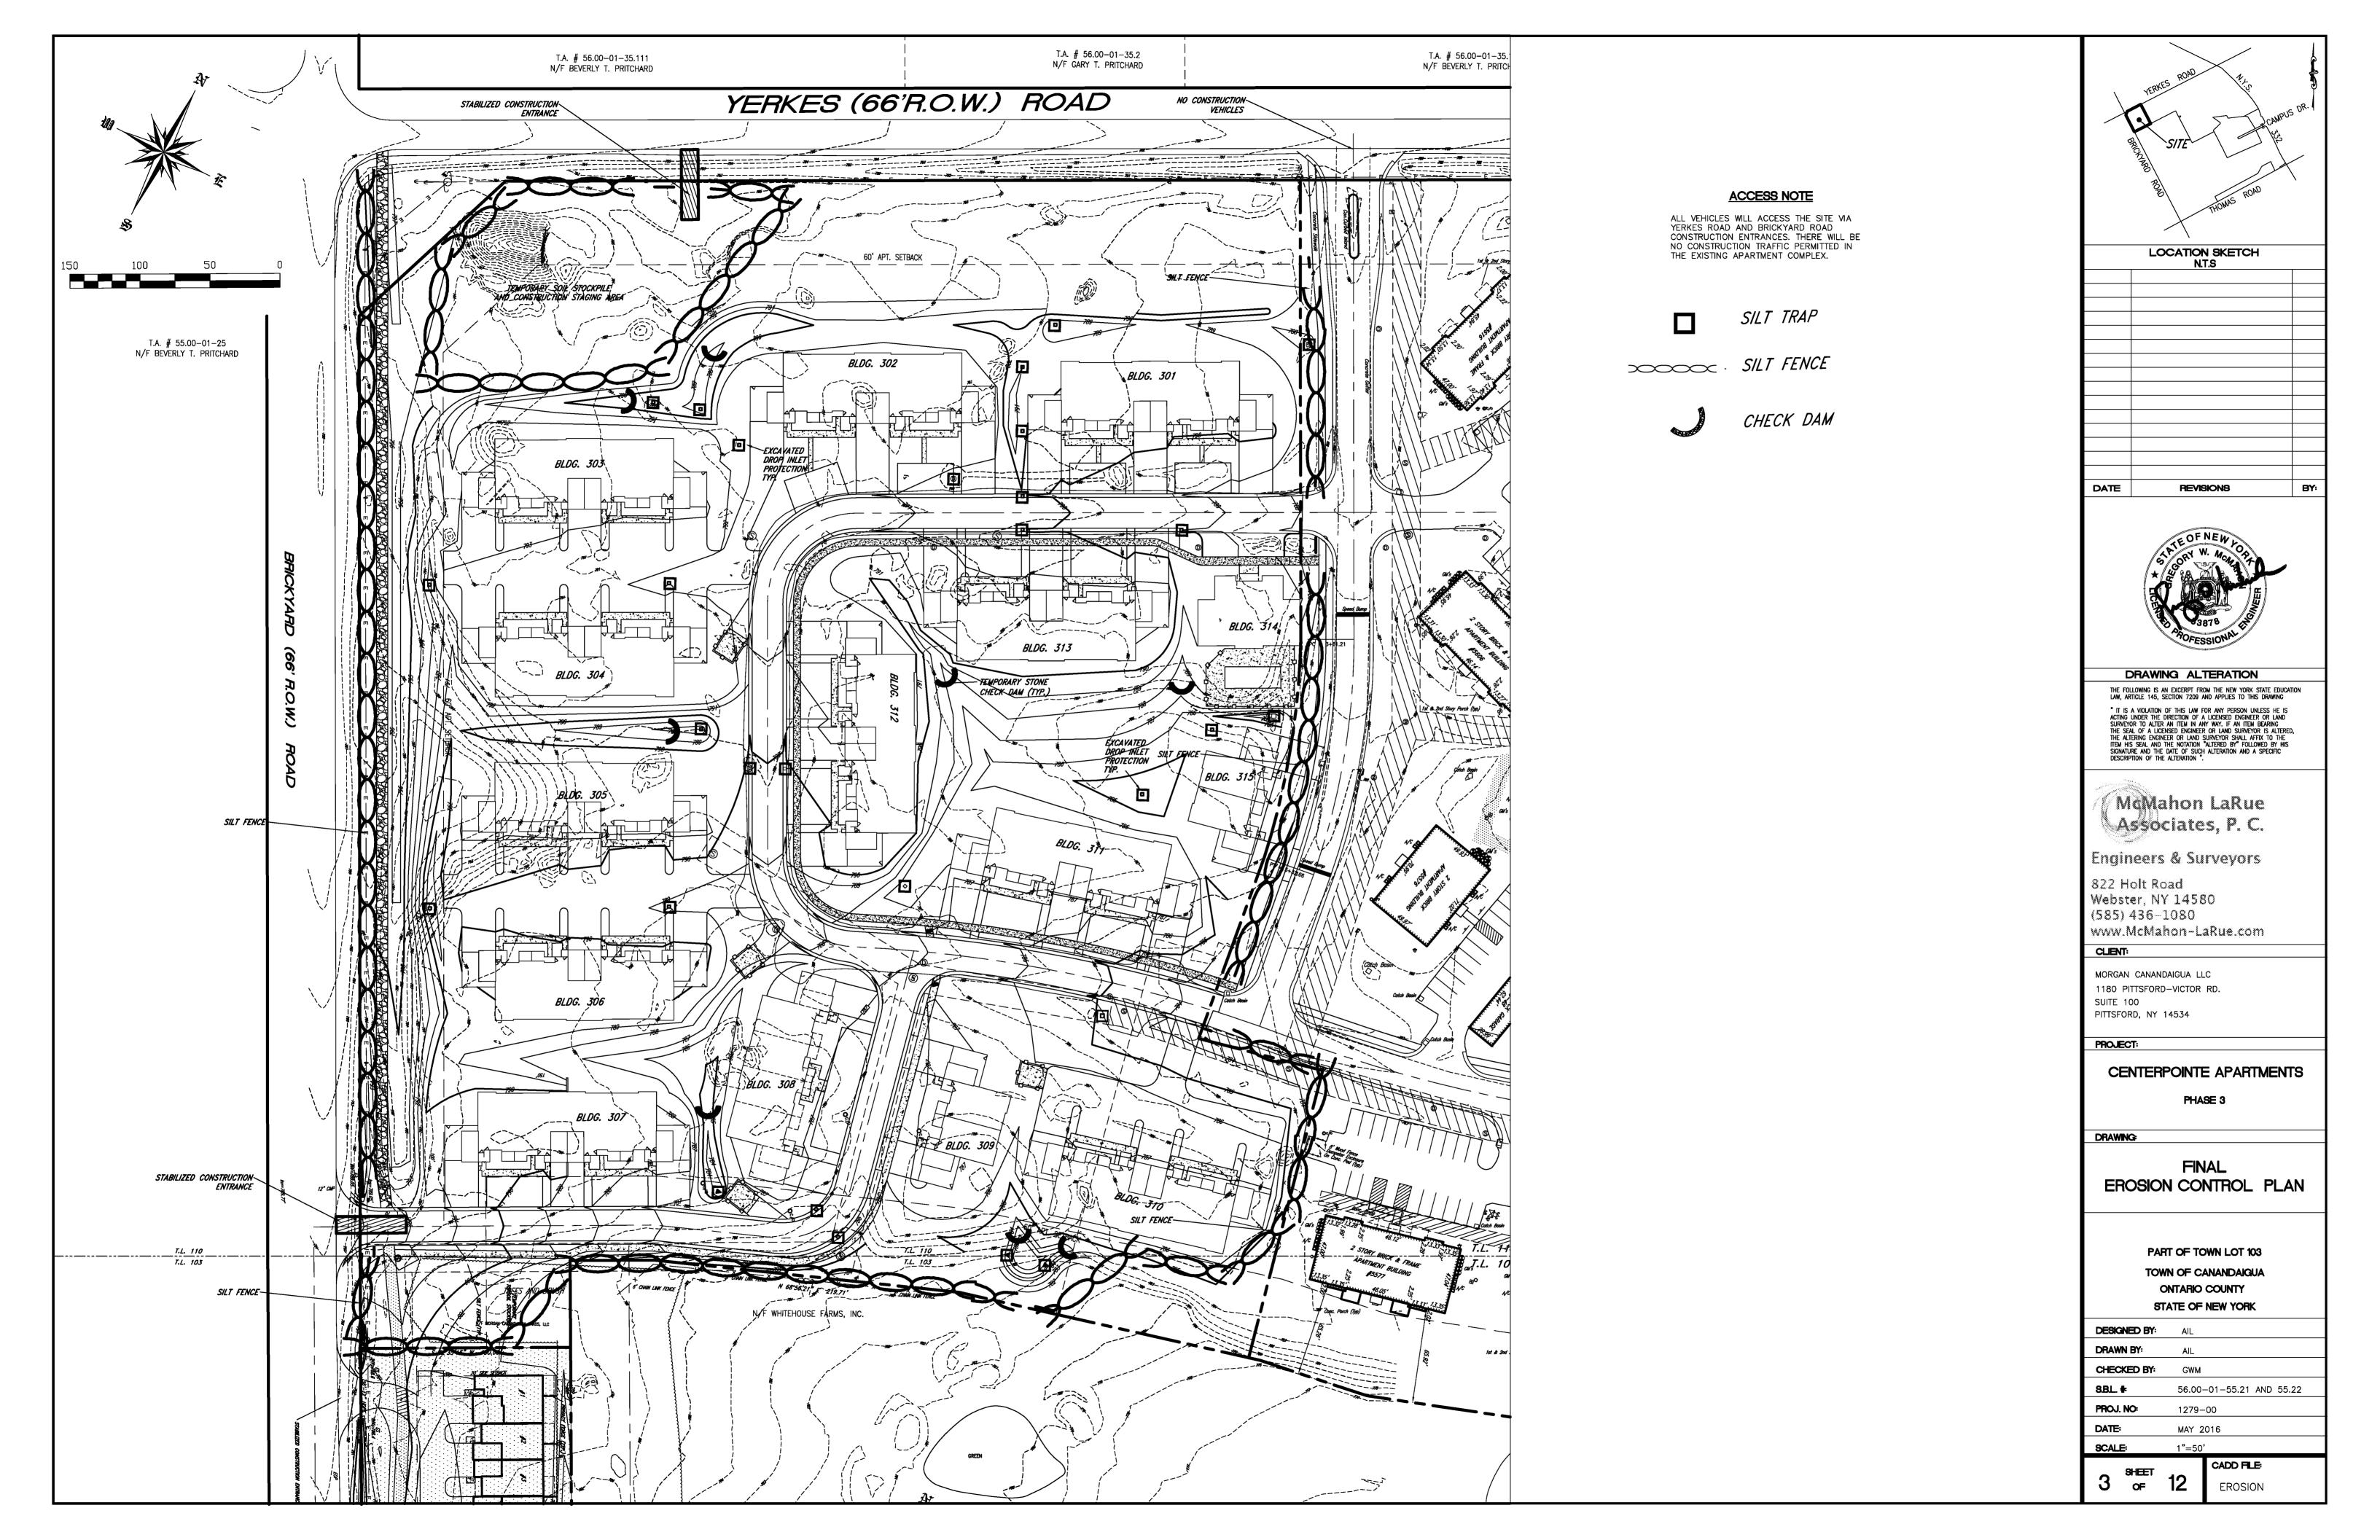

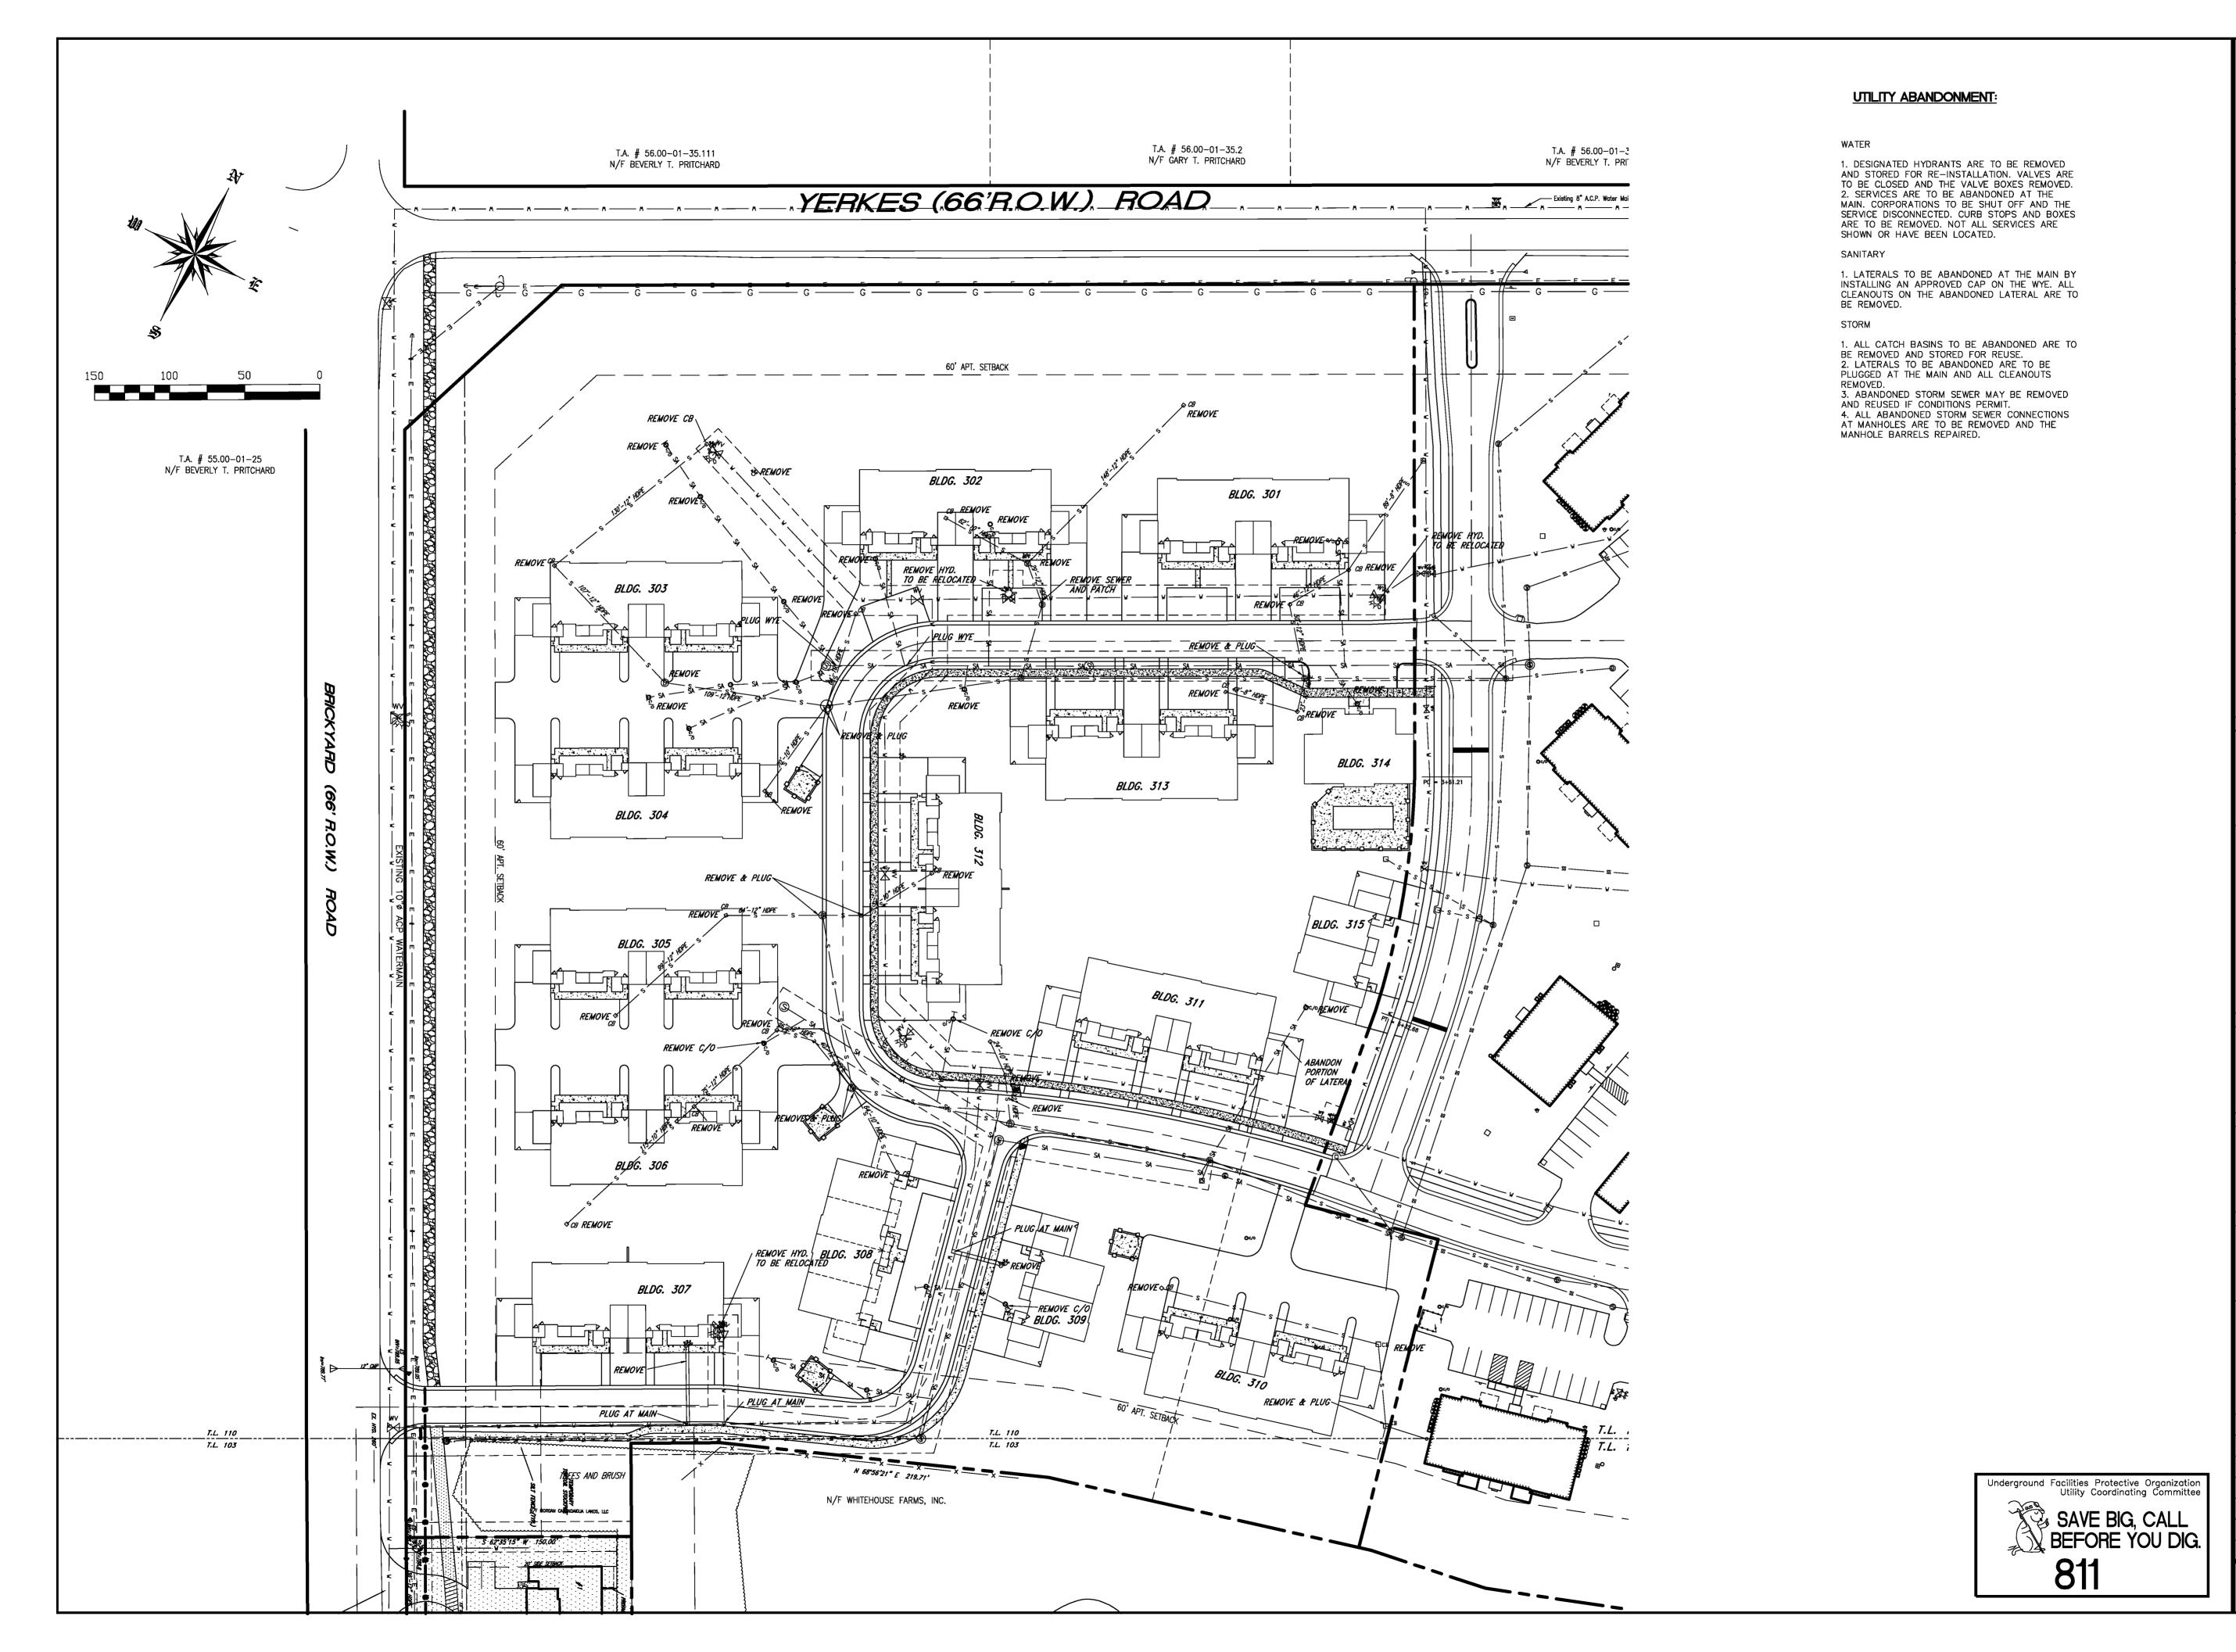

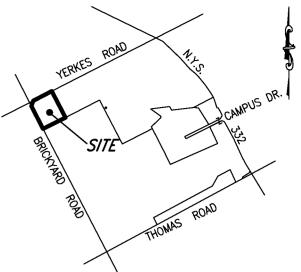

LOCATION SKETCH N.T.S

DATE REVISIONS



DRAWING ALTERATION

THE FOLLOWING IS AN EXCERPT FROM THE NEW YORK STATE EDUCATION LAW, ARTICLE 145, SECTION 7209 AND APPLIES TO THIS DRAWING

"IT IS A VIOLATION OF THIS LAW FOR ANY PERSON UNLESS HE IS ACTING UNDER THE DIRECTION OF A LICENSED ENGINEER OR LAND SURVEYOR TO ALTER AN ITEM IN ANY WAY. IF AN ITEM BEARING THE SEAL OF A LICENSED ENGINEER OR LAND SURVEYOR IS ALTERED, THE ALTERING ENGINEER OR LAND SURVEYOR SHALL AFFIX TO THE ITEM HIS SEAL AND THE NOTATION "ALTERED BY" FOLLOWED BY HIS SIGNATURE AND THE DATE OF SUCH ALTERATION AND A SPECIFIC DESCRIPTION OF THE ALTERATION".



#### Engineers & Surveyors

822 Holt Road Webster, NY 14580 (585) 436–1080 www.McMahon-LaRue.com

#### CLIENT:

MORGAN CANANDAIGUA LLC 1180 PITTSFORD-VICTOR RD. SUITE 100 PITTSFORD, NY 14534

PROJECT:

CENTERPOINTE APARTMENTS

PHASE 3

DRAWING:

FINAL UTILITY DEMO PLAN


PART OF TOWN LOT 103


TOWN OF CANANDAIGUA


ONTARIO COUNTY


STATE OF NEW YORK

DESIGNED BY:	AIL			
DRAWN BY:	AIL			
CHECKED BY:	GWM			
8.B.L. #	56.00-01-55.21 AND 55.22			
PROJ. NO:	1279-00			
DATE:	MAY 2016			
SCALE:	1"=50'			
SHEET	CADD FILE:			
4 of 12 DEMO				

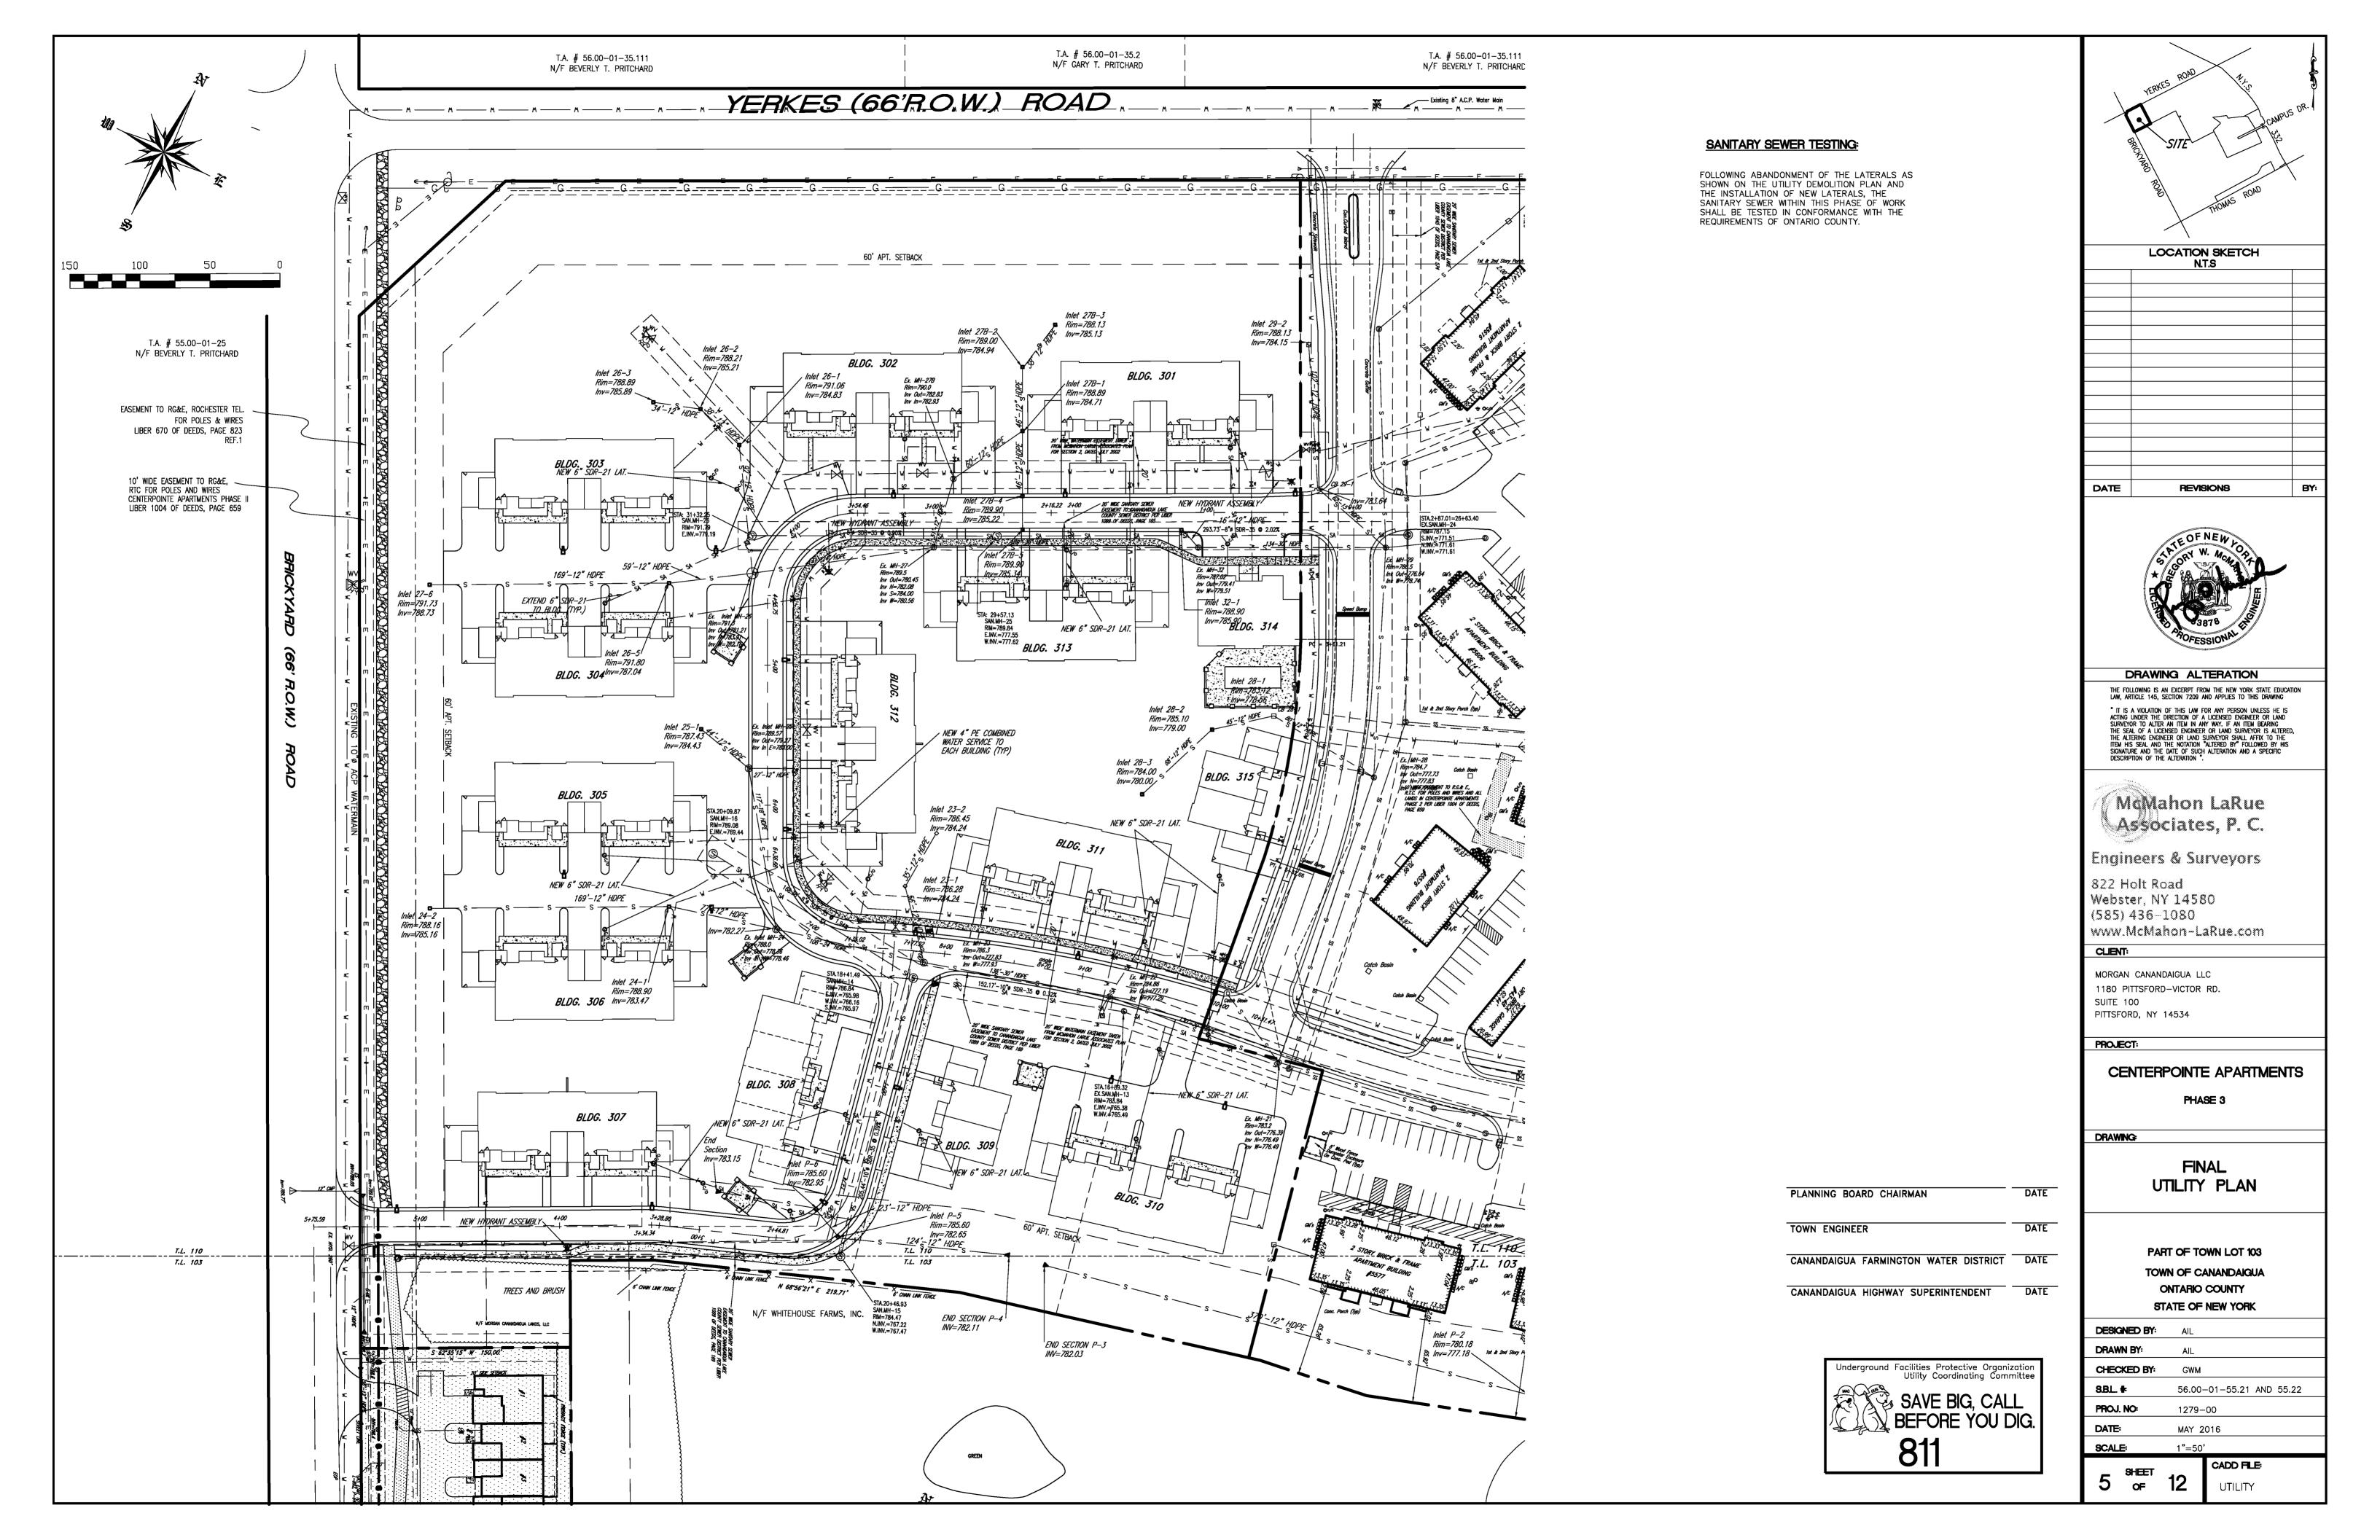

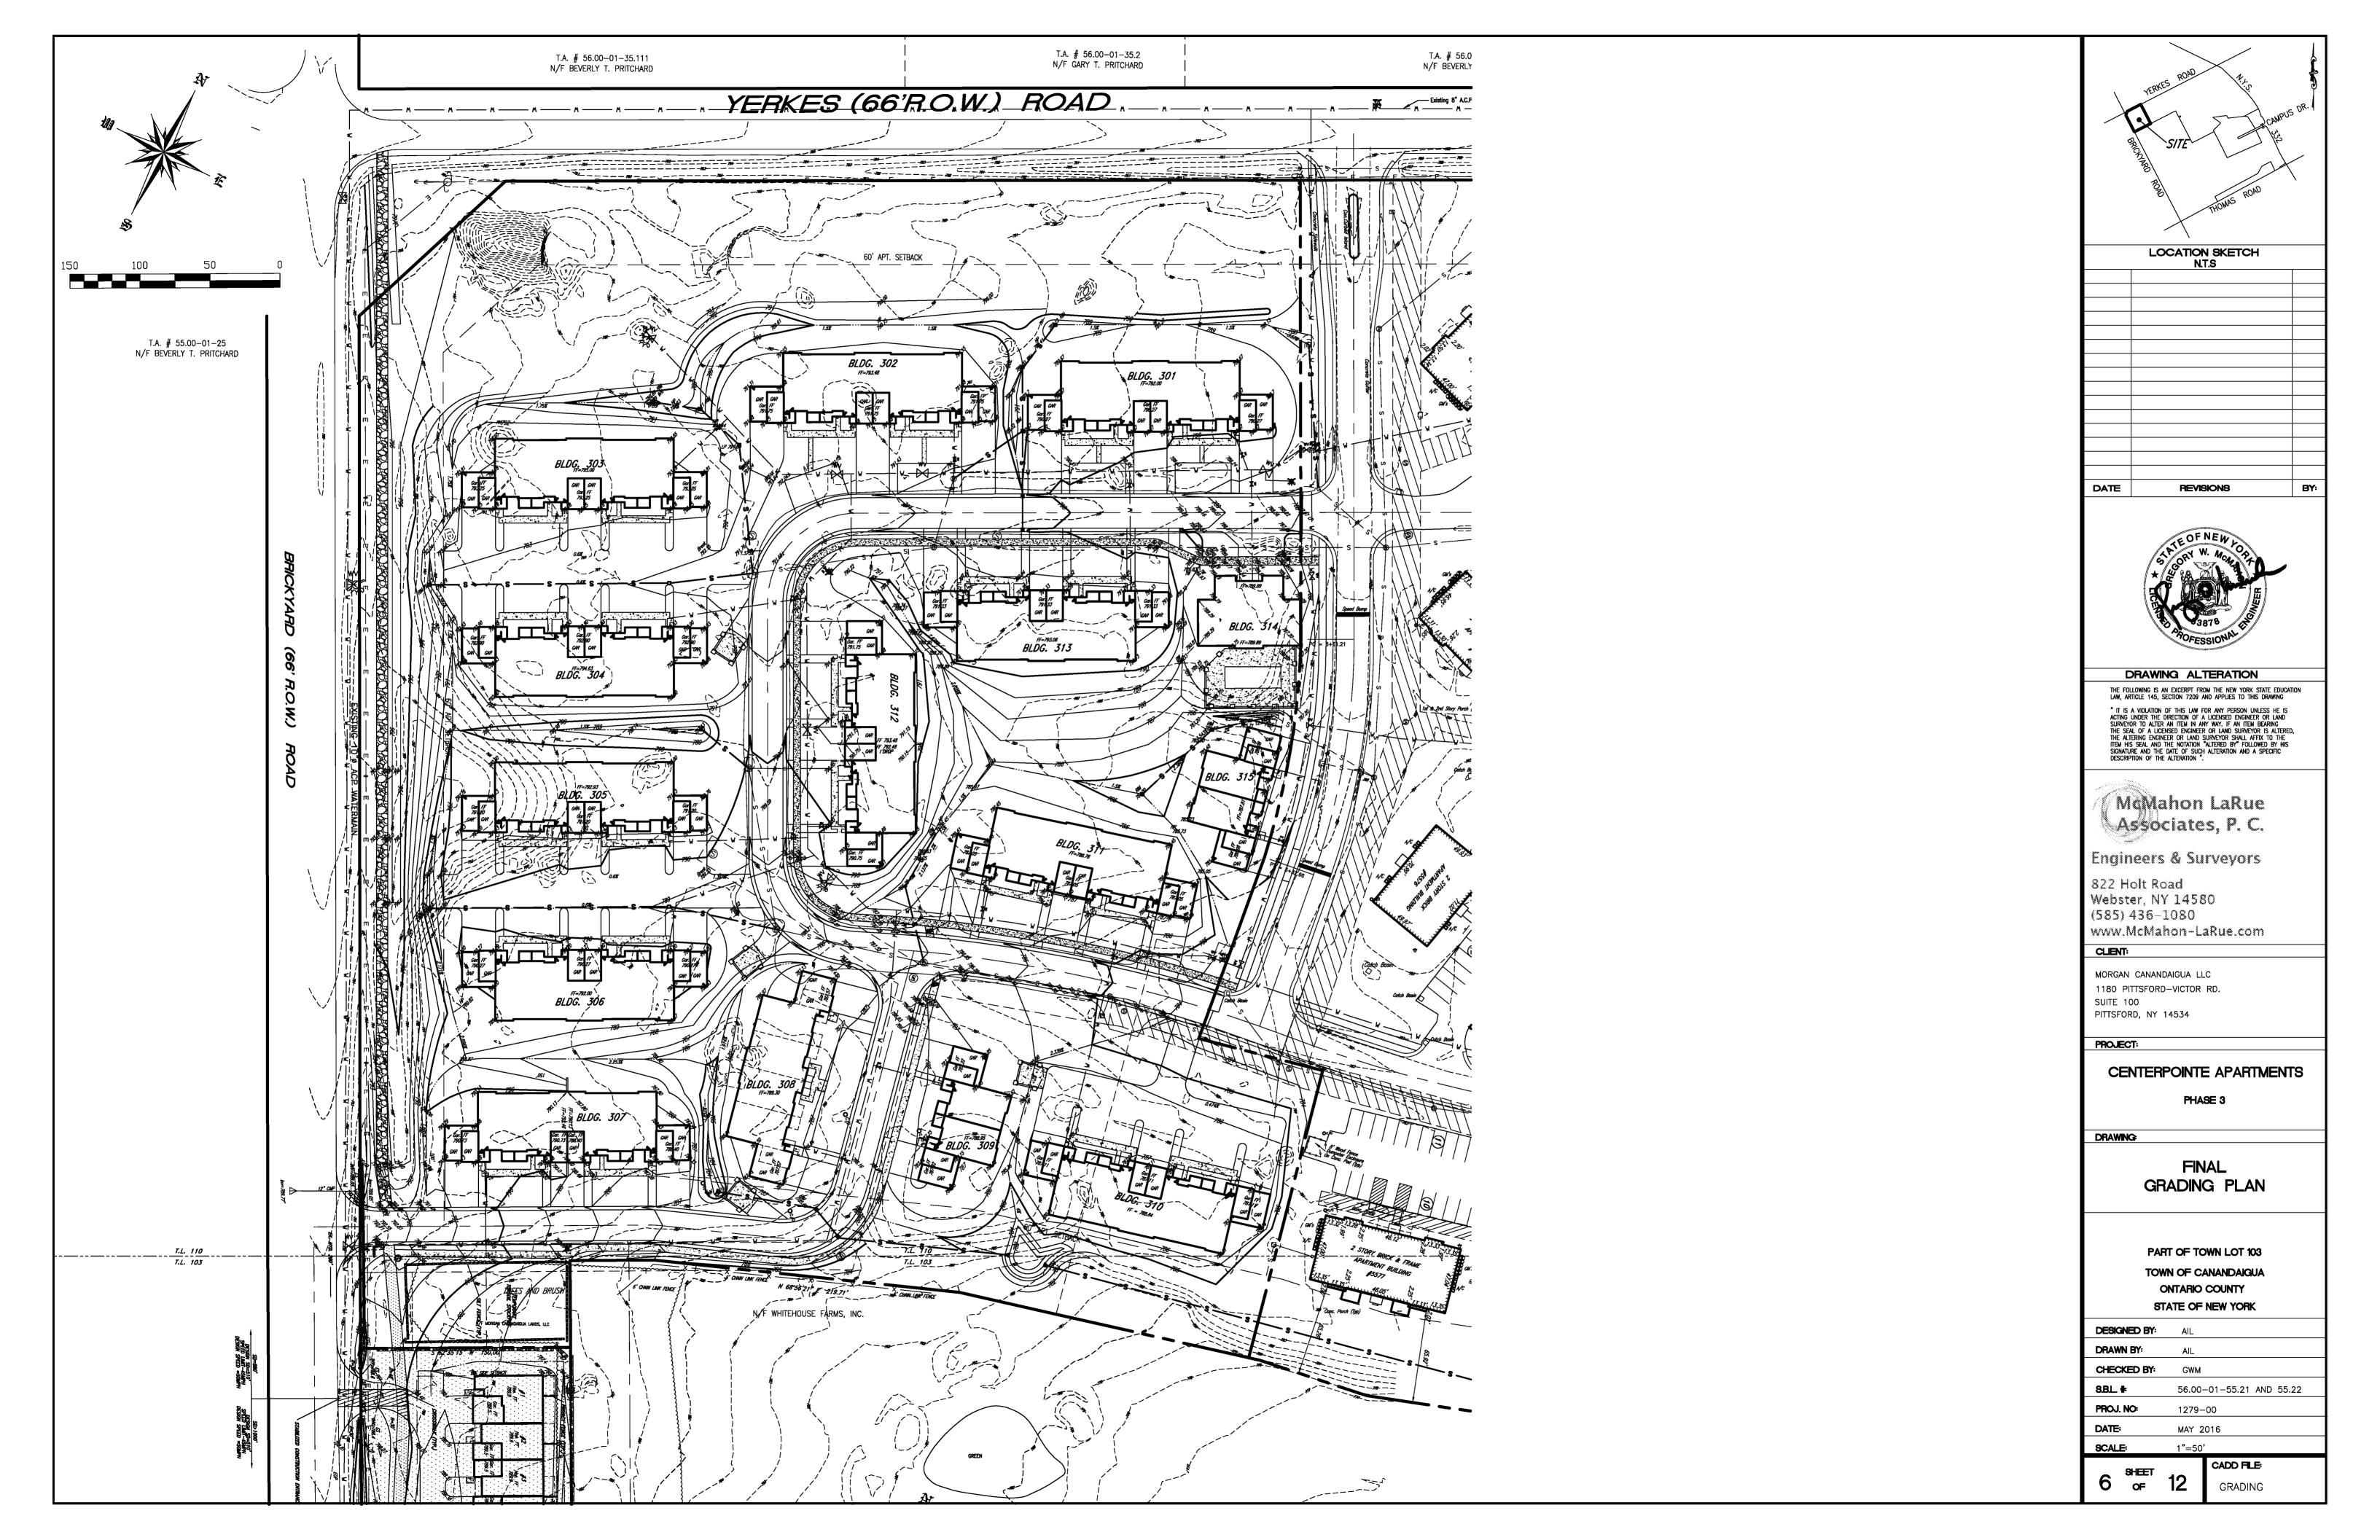

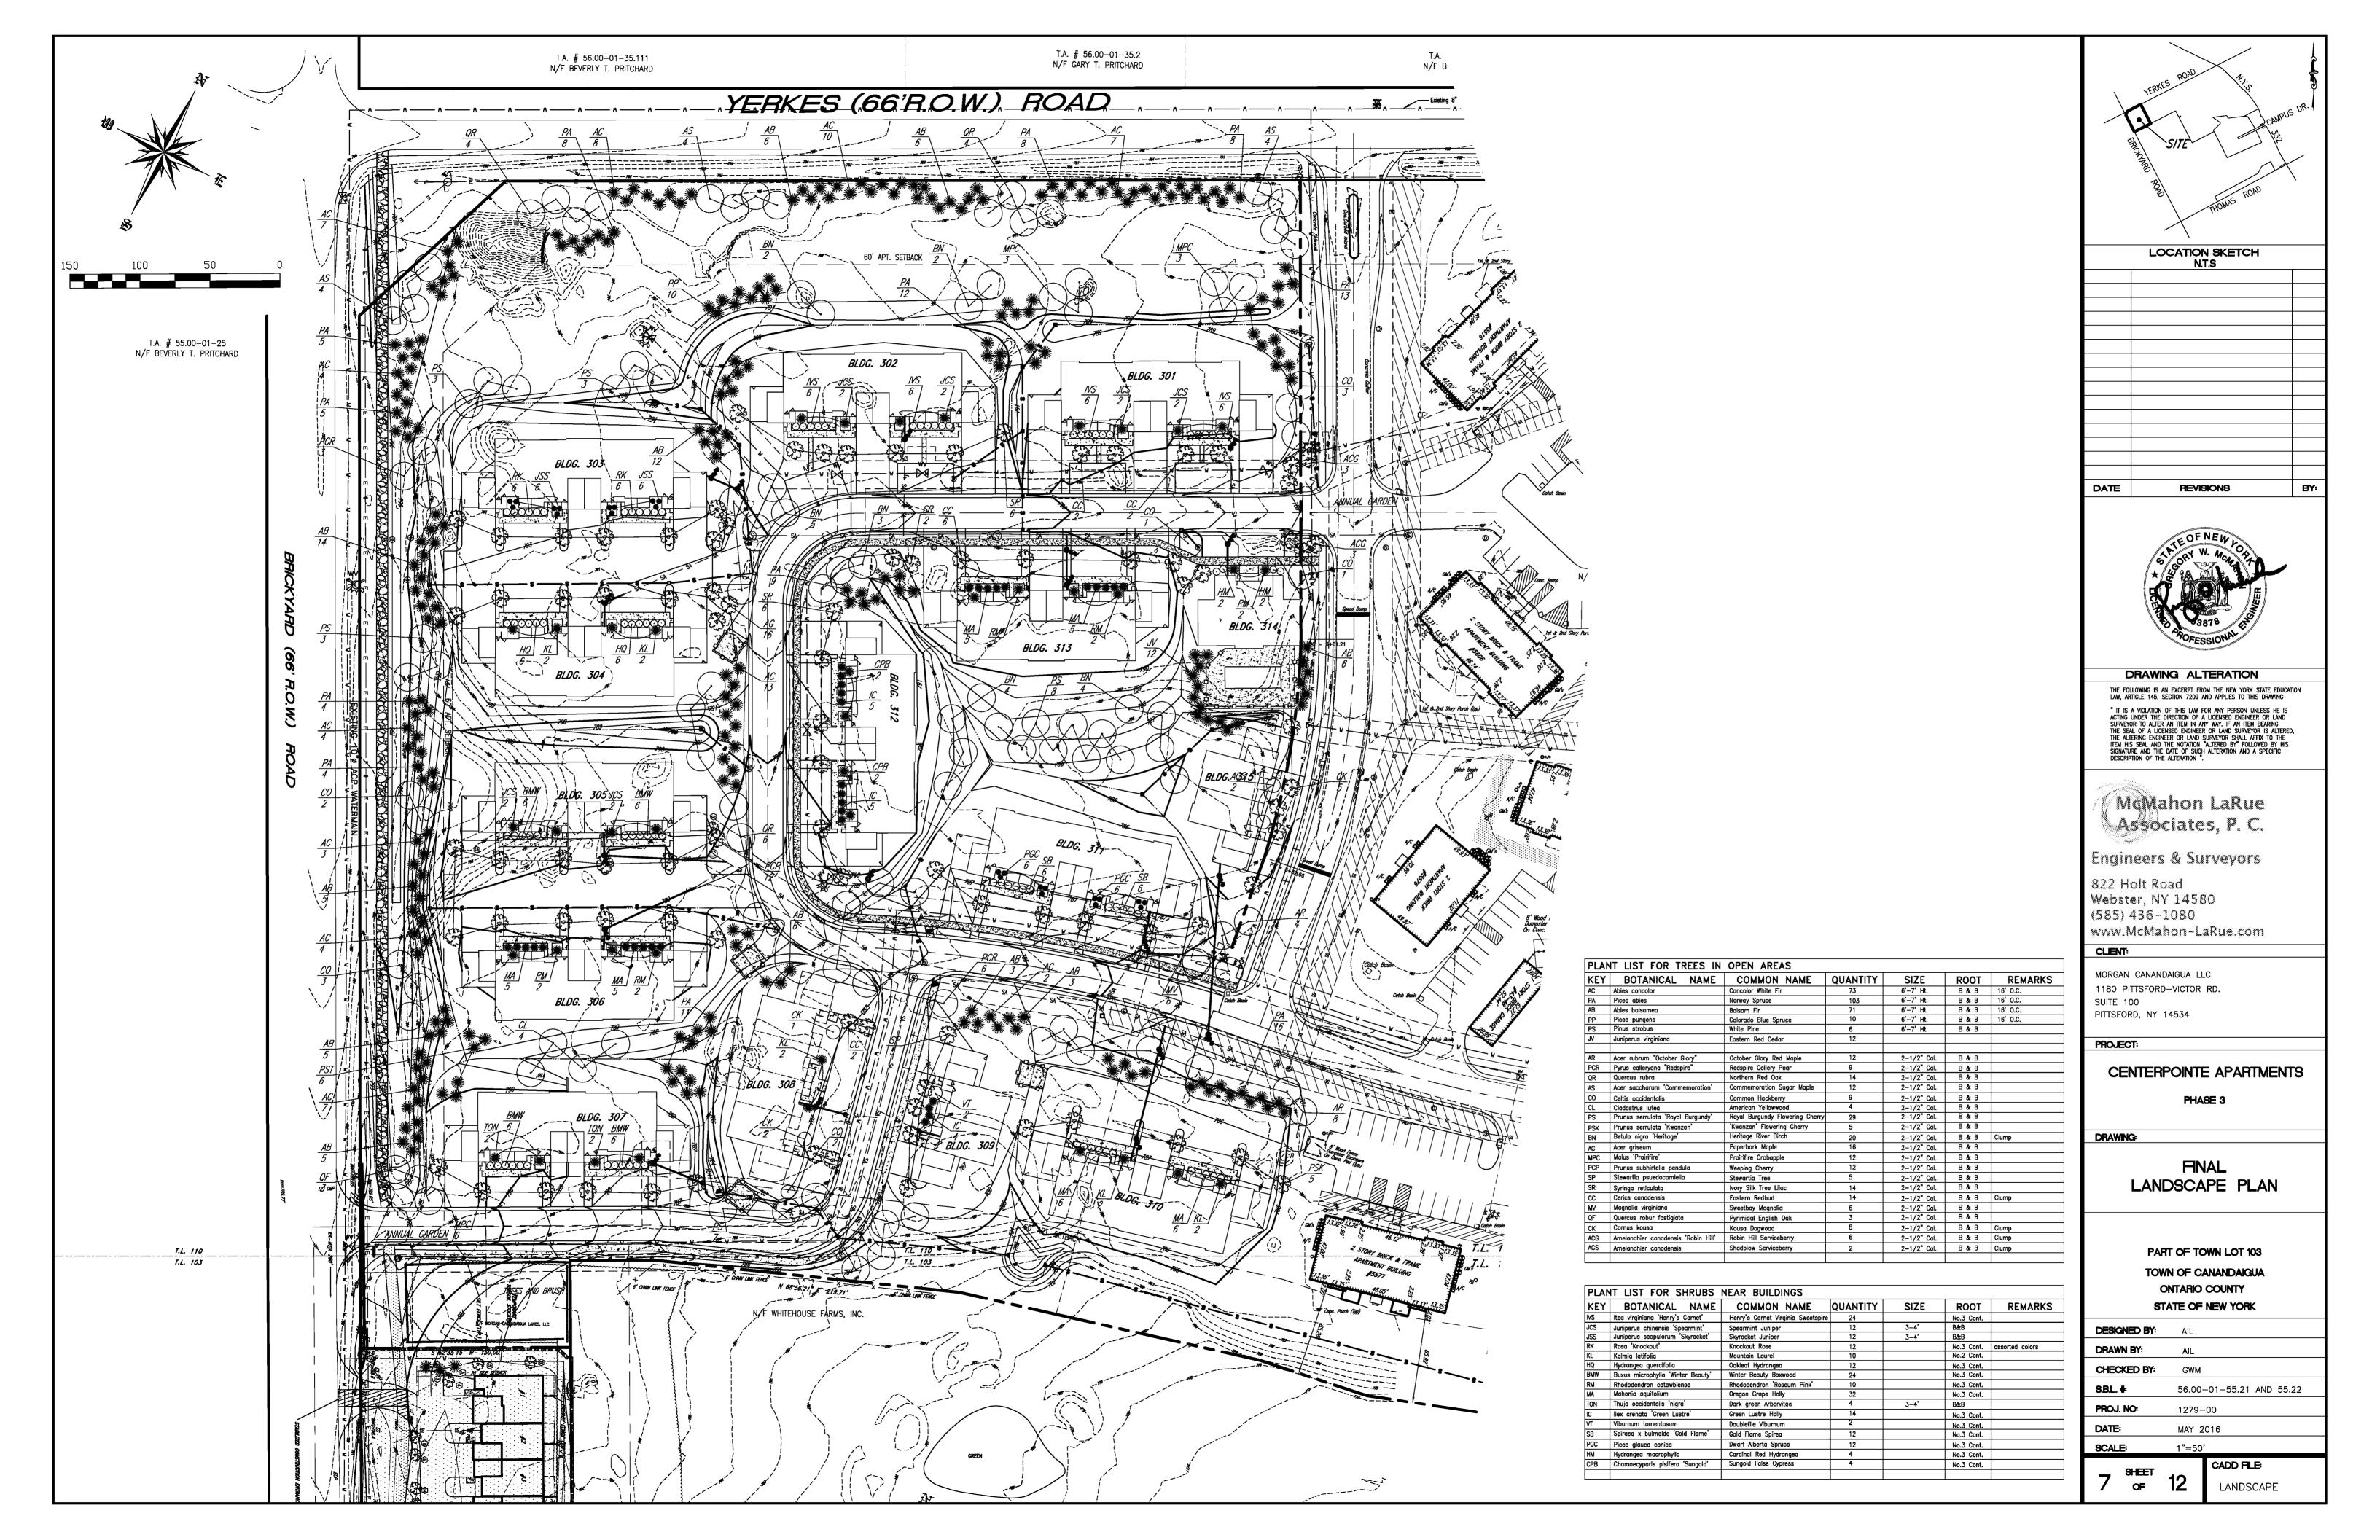

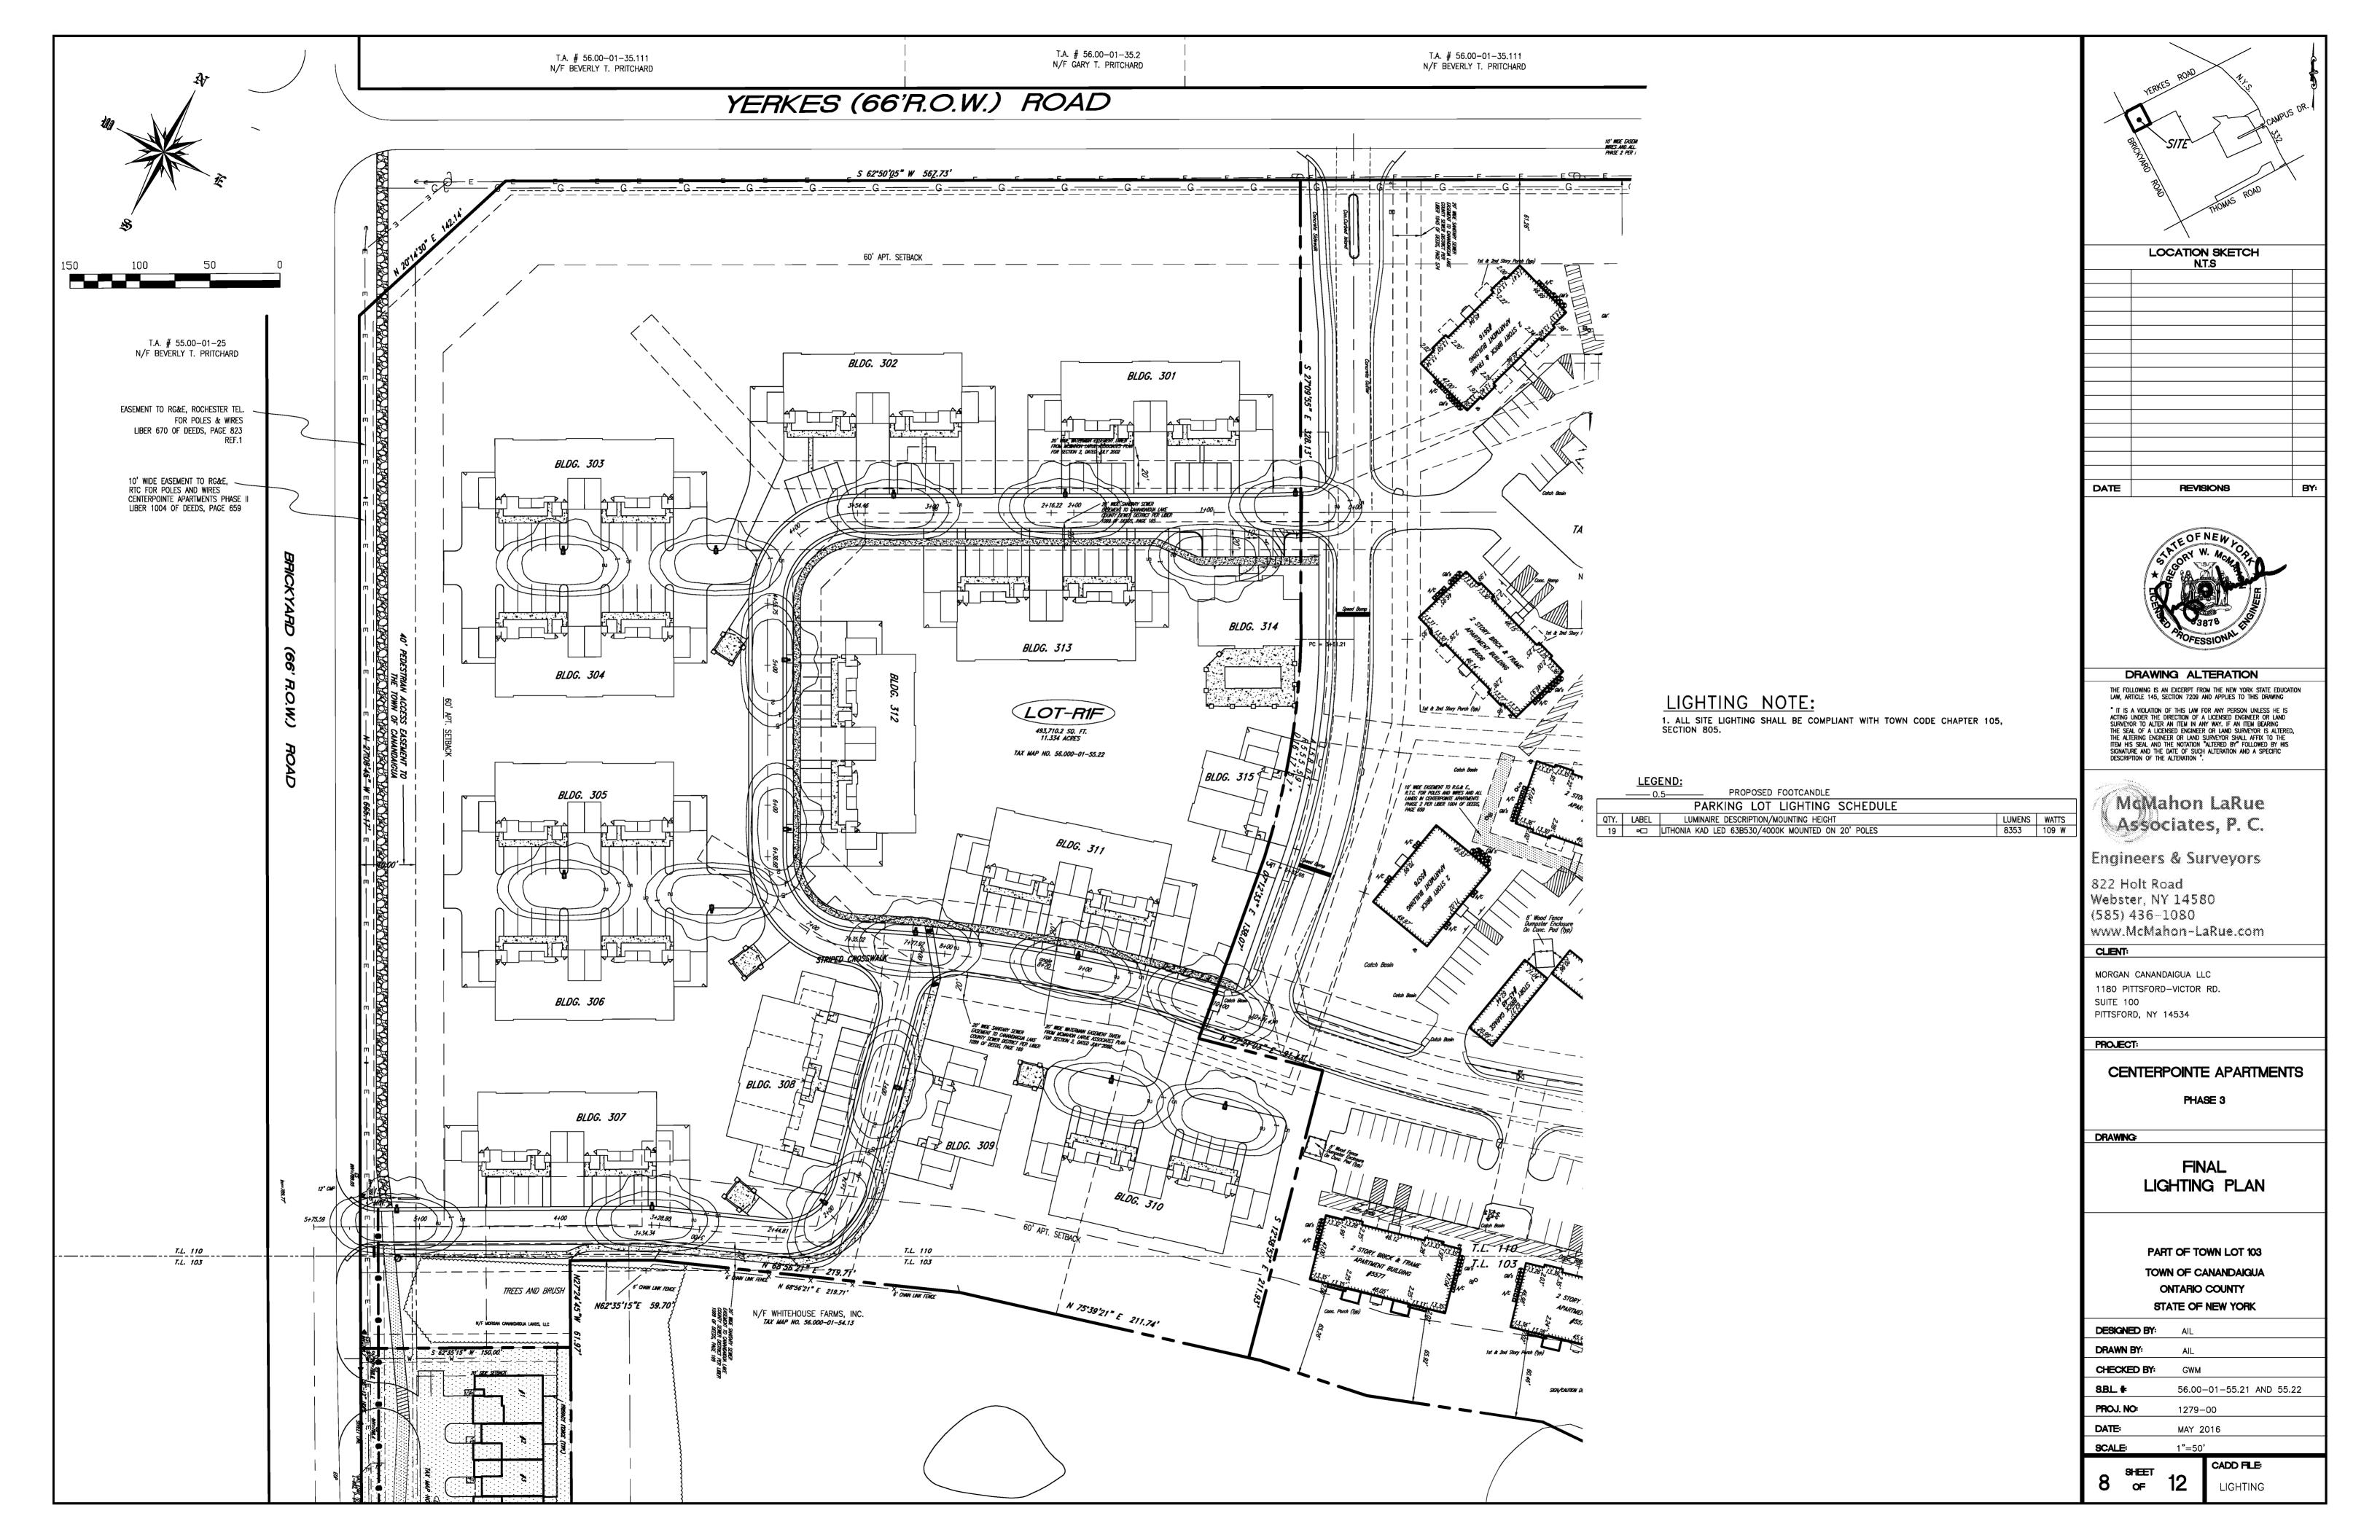

#### **GENERAL NOTES:**

- 1. ALL UTILITIES WITH THE EXCEPTION OF SANITARY SEWERS SHALL BE CONSTRUCTED IN ACCORDANCE WITH THE TOWN OF CANANDAIGUA'S LATEST SPECIFICATIONS.
- TOPOGRAPHIC INFORMATION IS BASED UPON AN AERIAL SURVEY COMPLETED IN JANUARY, 2013. THE CONTRACTOR SHALL CONFIRM ALL EXISTING CONDITIONS AND DIMENSIONS IN THE FIELD PRIOR TO THE COMMENCEMENT OF WORK AND NOTIFY THE DEVELOPER OF ANY DISCREPANCIES IMMEDIATELY.
- 3. THE CONTRACTOR SHALL CLEAN DEBRIS FROM ALL EXISTING STORM STRUCTURES WITHIN THE WORK LIMIT LINES. THE CONTRACTOR SHALL MAINTAIN TEMPORARY AND/OR PERMANENT STORM WATER DRAINAGE IN ALL AREAS FOR THE DURATION OF THE CONTRACT.
- 4. THE CONTRACTOR SHALL PROTECT ALL EXISTING SITE AMENITIES NOT DESIGNATED FOR REMOVAL. THE CONTRACTOR SHALL REPAIR OR REPLACE ITEMS DAMAGED AS A RESULT OF HIS CONSTRUCTION ACTIVITIES, AS DETERMINED BY THE DEVELOPER AND AT NO ADDITIONAL COST TO THE OWNER.
- 5. THE CONTRACTOR SHALL PROTECT AND SUPPORT ALL EXISTING UTILITIES FOR THE DURATION OF THE CONTRACT. THE CONTRACTOR SHALL REPLACE ANY UTILITY WHICH BECOMES DAMAGED AS A RESULT OF HIS/HER CONSTRUCTION ACTIVITIES.
- 6. THE CONTRACTOR SHALL MAINTAIN SAFE VEHICULAR AND PEDESTRIAN ACCESS TO THE SITE FOR THE DURATION OF THE CONSTRUCTION.
- 7. THE CONTRACTOR SHALL HAVE IN PLACE ALL BARRICADES, SIGNAGE, AND LIGHTS PERTAINING TO MAINTENANCE AND PROTECTION OF TRAFFIC BEFORE ANY EXCAVATION ACTIVITY TAKES PLACE.
- 8. ALL EXCESS EXCAVATION MATERIALS DETERMINED BY THE DEVELOPER TO BE REUSABLE BY THE CONTRACTOR FOR THIS CONTRACT, MAY BE STORED ON-SITE IN A LOCATION DETERMINED BY THE OWNER. CONTRACTOR SHALL STRIP AND STOCKPILE TOPSOIL WHERE POSSIBLE.
- 9. CONTRACTOR STAGING AREAS ARE TO BE COORDINATED WITH THE DEVELOPER PRIOR TO START OF CONSTRUCTION. ALL DISTURBED AREAS SHALL BE RESTORED. ALL STAGING AREAS ARE TO BE WITHIN WORK
- 10. THE LOCATION OF UNDERGROUND UTILITIES SHOWN HEREON ARE INFERRED FROM SURFACE EVIDENCE, AND RECORD AND UTILITY PLANS. ACTUAL LOCATION AND DESCRIPTION MAY DIFFER. THE CONTRACTOR SHALL NOTIFY ALL UTILITIES FOR STAKEOUT. TRUE LOCATIONS SHALL BE VERIFIED IN THE FIELD BY THE CONTRACTOR PRIOR TO ANY EXCAVATION OPERATIONS.

#### CONSTRUCTION SEQUENCE:

- 1. Install staging area. Install stabilized construction entrance.
- Flag the work limits, mark areas to be protected.
- 3. Install all perimeter erosion control devices.
- Modify existing utilities per the design plans.
- 5. Seed and mulch disturbed areas as required.
- 6. Clear and grub remainder of the site as required.
- 7. Install additional erosion control measures: earth dikes, silt fence etc.
- 8. Rough grade the site, stockpile topsoil, and construct swales. Limit disturbance to a maximum of 5
- acres at any one time. Install additional erosion control measures as shown on the plan.
- 9. Leave the surface slightly roughened and vegetate and mulch immediately.
- 10. Construct the roadway, buildings, and foundations.
- 11. Complete final grading. Install permanent seeding and plantings.
- 12. When all construction activity is complete and the site is stabilized to the satisfaction of the governing municipality and in compliance with NYSDEC regulations, remove all temporary erosion control devices; and fill and seed the temporary sediment basins.

There shall be no more than 5 acres of disturbed soil at any time without prior written approval from NYSDEC. This plan may be modified as necessary to maintain compliance with SPDES regulations.

#### GRADING NOTES:

- 1. CONTRACTOR SHALL ADJUST THE RIMS OF ALL MANHOLES, CATCH BASINS VALVE BOXES, AND ALL OTHER UTILITY SITE STRUCTURES TO MEET FINISHED GRADE IN AREAS REQUIRING REPAYING OR REGRADING AS PART OF THIS WORK INCLUDING THOSE THAT MAY NOT BE SHOWN ON THESE DRAWINGS.
- 2. THE LINE AND GRADE OF NEW PAVEMENT SHALL MEET EXISTING PAVEMENT FLUSH WHERE DESIGNATED TO MEET ON THE
- 3. ALL FILL AREAS ARE TO BE COMPACTED WITH A SHEEP'S FOOT ROLLER. 4. SANITARY SEWER TRENCH IN AREAS OF ROADWAY FILL, SHALL BE COMPACTED WITH A VIBRATORY ROLLER ATTACHED TO THE

#### <u>EROSION CONTROL MAINTENANCE / INSPECTION PROCEDURES</u>

- CONTRACTOR SHALL INSPECT EROSION AND SEDIMENTATION CONTROL MEASURES AT LEAST ONCE PER WEEK, AND CLEAN WITHIN
- ONE WORKING DAY OF ANY RAINFALL EVENT OF 1/2" RAINFALL OR GREATER OR FOLLOWING SIGNIFICANT SNOW MELT. MAINTAIN ALL MEASURES IN GOOD WORKING ORDER; IF A REPAIR IS NECESSARY, INITIATE IT WITHIN 24 HOURS OF REPORT.
- 3. REMOVE BUILT UP SEDIMENT FROM SILT FENCE WHEN IT HAS REACHED ONE-THIRD THE HEIGHT OF THE FENCE.
- 4. INSPECT SILT FENCE FOR DEPTH OF SEDIMENT AND TEARS, TO SEE IF THE FABRIC IS SECURELY ATTACHED TO THE FENCE
- POST, AND TO SEE THAT THE FENCE POSTS ARE FIRMLY IN THE GROUND. 5. INSPECT SEDIMENT BASINS FOR DEPTH OF SEDIMENT. REMOVE BUILT-UP SEDIMENT WHENEVER THE CAPACITY OF THE BASIN
- HAS BEEN REDUCED BY FIFTY PERCENT OF THE DESIGN CAPACITY 6. INSPECT TEMPORARY AND PERMANENT SEEDING AND PLANTING FOR BARE SPOTS, WASHOUTS, AND HEALTHY GROWTH.
- 7. THE OPERATOR SHALL HAVE A QUALIFIED PROFESSIONAL CONDUCT AN ASSESSMENT OF THE SITE PRIOR TO THE COMMENCEMENT OF CONSTRUCTION AND CERTIFY IN AN INSPECTION REPORT THAT THE APPROPRIATE FROSION AND SEDIMENT CONTROLS DESCRIBED IN THE SWPPP AND REQUIRED BY PART III.D OF THE SPDES GENERAL PERMIT FOR STORMWATER DISCHARGES HAVE BEEN ADEQUATELY INSTALLED. FOLLOWING THE COMMENCEMENT OF CONSTRUCTION, SITE INSPECTIONS SHALL BE CONDUCTED BY THE QUALIFIED PROFESSIONAL AT LEAST EVERY 7 CALENDAR DAYS
- 8. A MAINTENANCE INSPECTION REPORT WILL BE MADE AFTER EACH INSPECTION. A RECORD OF ALL INSPECTION REPORTS SHALL BE KEPT IN AN ONSITE LOG BOOK. THIS LOG BOOK SHALL BE MADE AVAILABLE TO THE PERMITTING AUTHORITY UPON

#### CONSTRUCTION SITE WASTE MANAGEMENT: DESIGNATE A WASTE COLLECTION AREA ONSITE THAT DOES NOT RECEIVE A SUBSTANTIAL AMOUNT OF RUNOFF FROM UPLAND AREAS AND DOES NOT DRAIN DIRECTLY TO A WATERBODY.

- CONSTRUCT A TEMPORARY LAND DIKE AROUND THE WASTE COLLECTION AREA TO PREVENT SITE WASTES FROM CONTRIBUTING TO STORMWATER CONTAMINATION.
- 3. ENSURE THAT CONTAINERS HAVE LIDS AND ARE KEPT IN A COVERED AREA WHEN POSSIBLE.
- 4. SCHEDULE WASTE COLLECTION APPROPRIATELY.
- 5. CLEAN UP SPILLS IMMEDIATELY USING AN ABSORBENT MATERIAL SUCH AS SAWDUST OR KITTY LITTER.
- POST GUIDELINES FOR PROPER HANDLING, STORAGE, AND DISPOSAL OF CONSTRUCTION SITE WASTES. PROVIDE PROPER TRAINING TO ALL WORKERS ON THE SITE.

#### **STORM SEWER NOTES:**

- 1. CONTRACTOR SHALL INSTALL ALL STORM SEWERS AS SHOWN ON THE DRAWINGS INCLUDING WORK AT THE DISCHARGE POINT TO THE EXISTING
- 2. GENERAL CONTRACTOR SHALL MAINTAIN TEMPORARY OR PERMANENT STORM WATER DRAINAGE FOR THE DURATION OF THE CONTRACT. THE GENERAL CONTRACTOR SHALL BE RESPONSIBLE FOR THE REMOVAL OF THE EXISTING STORM SEWER MAINS, STRUCTURES, AND APPURTENANCES AS NEEDED TO COMPLETE THE WORK.

#### **EROSION CONTROL NOTES:**

- 1. ALL EROSION CONTROL MEASURES SHALL BE IN ACCORDANCE WITH N.Y.S. GUIDELINES FOR URBAN EROSION AND SEDIMENT CONTROL, AND LOCAL GOVERNING SOIL AND WATER CONSERVATION AGENCY RECOMMENDATIONS AND STANDARDS. SILT FENCE WILL BE INSTALLED WITH A TRENCHER.
- 2. ONLY AREAS NEEDED FOR CONSTRUCTION AS SHOWN ON THESE PLANS SHALL BE DISTURBED. NO OTHER TREES, SHRUBS, OR GRASSES ARE TO BE REMOVED FOR CONSTRUCTION. REMAINING VEGETATION SHALL BE PROTECTED TO PRESERVE THEIR AESTHETIC AND EROSION CONTROL VALUES.
- 3. THE CONTROL OF EROSION AND SEDIMENTATION SHALL BE A CONTINUOUS PROCESS UNDERTAKEN AS NECESSARY PRIOR TO. DURING AND AFTER SITE PREPARATION AND CONSTRUCTION BY THE CONTRACTOR. THE CONTRACTOR SHALL BE RESPONSIBLE FOR REMOVAL OF EROSION CONTROL AND SEDIMENTATION CONTROLS AFTER GROUND COVER IS ESTABLISHED.
- 4. THE CONTRACTOR SHALL REMOVE EROSION CONTROL MEASURES WHEN AN AREA IS PERMANENTLY STABILIZED, CONSTRUCTION IS COMPLETE, FINAL VEGETATIVE COVER HAS BEEN ESTABLISHED, AND IS APPROVED BY THE TOWN OF CANANDAIGUA.
- 5. LOOSE PILE MATERIAL THAT IS EXCAVATED FOR BUILDING CONSTRUCTION PURPOSES SHALL BE KEPT LOOSE PILED UNTIL IT IS USED FOR FOUNDATION BACKFILL OR FINAL GRADING AND PERMANENT VEGETATION.
- 6. RUNOFF FROM STOCKPILED MATERIALS SHALL BE CONTAINED BY EROSION CONTROL MEASURES. STOCKPILED MATERIALS NOT MOVED WITHIN 30 DAYS SHALL BE SHAPED INTO A UNIFORM PILE AND SEEDED WITH A RAPID GERMINATING GRASS SEED MIX.
- CONTRACTOR SHALL ROUGH GRADE THE SITE. ALL FILL MATERIAL SHALL BE COMPACTED SUFFICIENTLY TO PREVENT PROBLEMS OF EROSION, AND WHERE THE MATERIAL IS TO SUPPORT STRUCTURES, IT SHALL BE COMPACTED TO A MINIMUM OF 95% OF MODIFIED PROCTOR TEST DENSITY WITH PROPER MOISTURE CONTENT.
- 8. ALL CATCH BASIN INLETS SHALL BE ENCLOSED WITH SILT FENCE UNTIL THE SITE IS FULLY STABILIZED.
- 9. CONTRACTOR SHALL TEMPORARY SEED AND MULCH ALL DIVERSION DITCHES AND ANY OTHER DISTURBED AREAS NOT SCHEDULED FOR IMMEDIATE ADDITIONAL WORK. REMAINING DISTURBED AREAS SHALL BE SEEDED WITH GROUND COVER AND MULCHED AS SOON AFTER THEIR DISTURBANCE AS CONSTRUCTION PRACTICES AND WEATHER WILL ALLOW. CONTRACTOR SHALL STABILIZE DISTURBED AREAS AND STOCKPILES WITHIN 7 DAYS OF LAST CONSTRUCTION ACTIVITY IN THAT AREA.
- 10. DRAINAGE SYSTEMS AND EROSION AND SEDIMENT CONTROL DEVICES SHALL BE MAINTAINED AS FREQUENTLY AS NECESSARY AND REPLACED IF NECESSARY UNTIL SUCH TIME AS A SUBSTANTIAL STAND OF VEGETATION HAS DEVELOPED AND POTENTIAL FOR EROSION NO LONGER EXISTS.
- 11. THE CONTRACTOR SHALL MAINTAIN SITE CONDITIONS WHICH SHALL PREVENT TRACKING OR FLOWING OF SEDIMENT ONTO PUBLIC RIGHT-OF-WAYS. THE CONTRACTOR SHALL KEEP CLEAN AND FREE SIDEWALKS, STREETS, AND PAVEMENTS FROM DIRT, MUD. STONE, DEBRIS, AND OTHER HAULED MATERIALS AS A RESULT OF HIS/HER WORK.
- 12. A STABILIZED CONSTRUCTION ENTRANCE LOCATED SHALL BE IN PLACE PRIOR TO WORK COMMENCING ON THE SITE. THE CONTRACTOR SHALL CONTROL DUST FROM SITE ACTIVITY TO THE SATISFACTION OF THE PROJECT DEVELOPER, OWNER, AND THE TOWN OF CANANDAIGUA.
- 13. SITE EROSION CONTROL MEASURES INCLUDE BUT ARE NOT LIMITED TO MEASURES SHOWN ON THE PLANS. CONTRACTOR SHALL IMPLEMENT OTHER MEASURES ORDERED BY THE DEVELOPER OR A TOWN REPRESENTATIVE NECESSARY TO CONTROL
- 14. CONTRACTOR SHALL INSPECT EROSION AND SEDIMENTATION CONTROL MEASURES ONCE PER WEEK, AND CLEAN WITHIN ONE WORKING DAY OF ANY RAINFALL EVENT OF 1/2" RAINFALL OR GREATER OR FOLLOWING SIGNIFICANT SNOW MELT.
- 15. REMOVE ACCUMULATED SEDIMENTS FROM POND DEEP POOL AND TRAPS WHEN SEDIMENTS OCCUPY 50% OF THE VOLUME
- 16. CHECK AND REPAIR STAKED STRAW BALE AREAS, AS NECESSARY.
- 17. SWEEP ADJOINING ROADWAYS, IF ANY TRACKING OF SOILS ONTO OFF-SITE PAVING OCCURS.
- 18. INSPECT AND CLEAN ALL TEMPORARY EROSION CONTROL STRUCTURES AFTER EACH RAIN STORM EVENT.
- 19. ALL SLOPES 1-ON-3 OR GREATER WILL BE STABILIZED WITH JUTE MESH AND RESTORED WITH CROWN VETCH.
- 20. THE ENTIRE PROJECT WILL BE RESTORED WITH 6" OF TOPSOIL.
- 21. EROSION CONTROL MEASURES SUCH AS STRAW BALES ARE TO BE PLACED 5' INTO THE PROJECT FROM ORANGE

CONSTRUCTION FENCE, AND SHALL REMAIN IN EFFECT UNTIL DEEMED UNNECESSARY BY TOWN OF CANANDAIGUA.

- 22. ALL DISTURBED AREAS NOT TO BE WORKED WITHIN 7 DAYS SHALL BE SEEDED/MULCHED IMMEDIATELY.
- 23. All disturbed areas shall be immediately seeded and mulched in accordance with the following criteria: Temporary Seeding: IF: Spring or summer or early fall, then seed the area with ryegrass (annual or perennial) at 30 lbs. per acre
  - IF: Late fall or early winter, then seed Certified 'Aroostook' winter rye (cereal rye) at 100 lbs. per acre (2.5 lbs./1000

#### <u>Permanent Seeding:</u>


<u>Species</u>	Variety	lbs./acre	lbs/1000 sq. ft.
Common White Clover	Common	8	0.20
Tall Fescue	KY-31/Rebel	20	0.45
Ryegrass (perennial)	Pennfine/Linn	5	0.10
Ryegrass (perennial)		5	0.10

(Approximately 0.7 lb./1000 sq. ft. or use 1 lb./1000 sq. ft.)


#### Waterway / Pond Seeding

materway	/ Fullu See	unig	<u>•</u>						
Species	Rate	per	Acre	(lbs) Rate	per	1,000	sq.	ft.	(lbs)
Kentucky	bluegrass			25	•	C	.60		•
Creeping 6	Red Fescue			20		C	.50		
Perennial	ryegrass		_	10		_0	<u>).20</u>		


- 24. REFER TO THE STORMWATER POLLUTION PREVENTION PLAN FOR SPECIFIC DETAILS REGARDING EROSION CONTROL AND
- 25. A COPY OF THE "NOI" AND A BRIEF DESCRIPTION OF THE PROJECT SHALL BE MAINTAINED AT THE CONSTRUCTION SITE AND MADE AVAILABLE FOR PUBLIC VIEWING UPON REQUEST.
- 26. THE PERMIT COVERAGE IS NON-TRANSFERABLE. IN THE EVENT OF A TRANSFER OF RESPONSIBILITY FOR STORMWATER RUNOFF, THE FORMER PERMITTEE MUST SUBMIT A "NOT" AND NOTIFY THE NEW DISCHARGER OF THE NEED TO SIGN THE SWPPP AND SUBMIT A NEW "NOI".

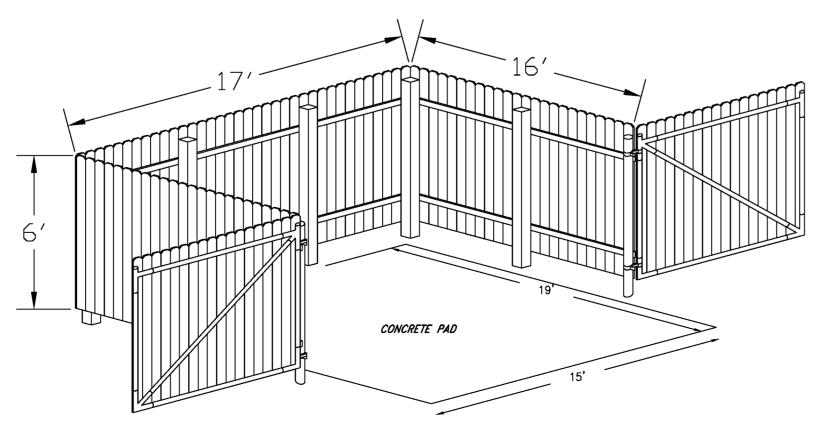


**DUMPSTER ENCLOSURE:** 

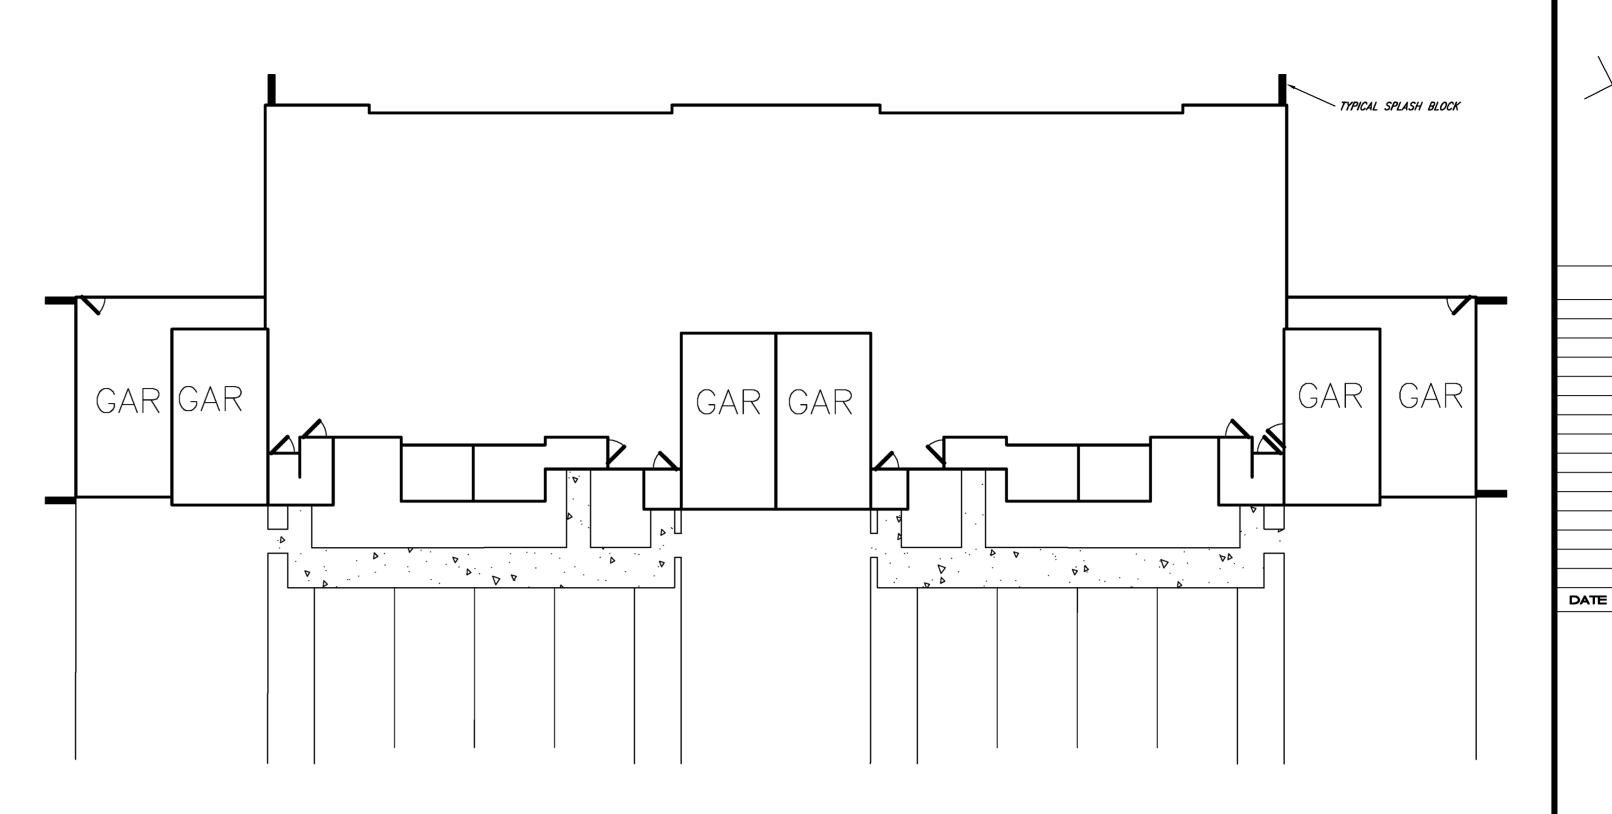


#### TYPICAL SPLASH BLOCK LOCATIONS:

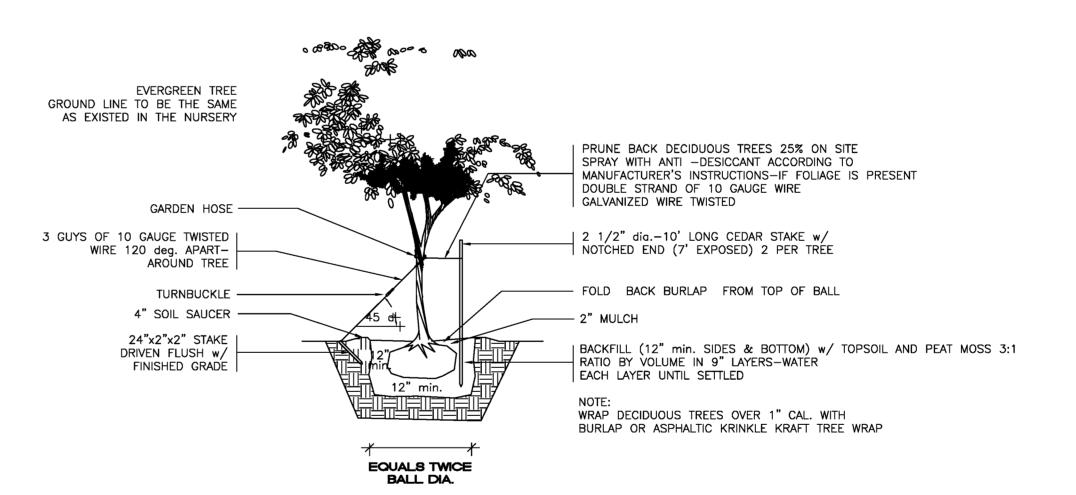

#### TREE PLANTING DETAIL NO SCALE

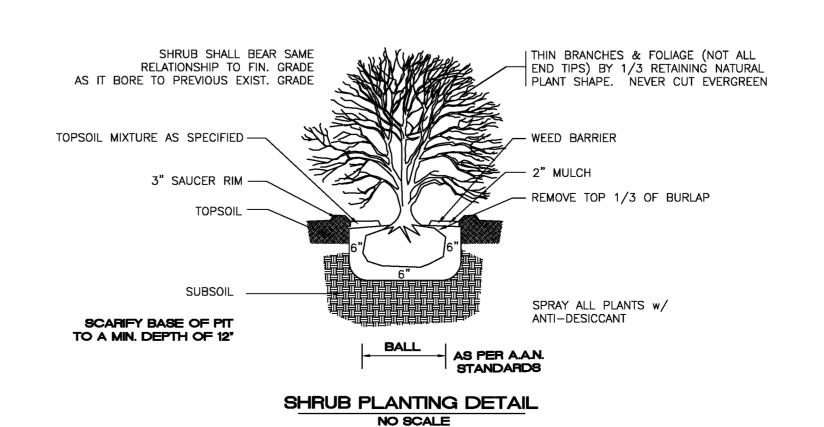

#### LOCATION SKETCH N.T.S

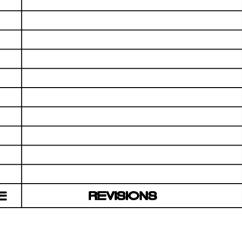



#### DRAWING ALTERATION THE FOLLOWING IS AN EXCERPT FROM THE NEW YORK STATE EDUCATION LAW, ARTICLE 145, SECTION 7209 AND APPLIES TO THIS DRAWING

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#### Engineers & Surveyors

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#### CLIENT:

MORGAN CANANDAIGUA LLC 1180 PITTSFORD-VICTOR RD. SUITE 100 PITTSFORD, NY 14534

#### PROJECT:


CENTERPOINTE APARTMENTS PHASE 3

**DRAWING** 

#### FINAL NOTES AND DETAILS


PART OF TOWN LOT 103 TOWN OF CANANDAIGUA ONTARIO COUNTY STATE OF NEW YORK

DESIGNED BY:	GWM	
DRAWN BY:	GWM	
CHECKED BY:	AIL	
8.B.L. #	56.00-01-55.21 AND 55.22	
PROJ. NO:	1279-00	
DATE:	MAY 2016	
SCALE:	AS NOTED	
SHEET	CADD FILE:	
9 0=	12 DETAIL	

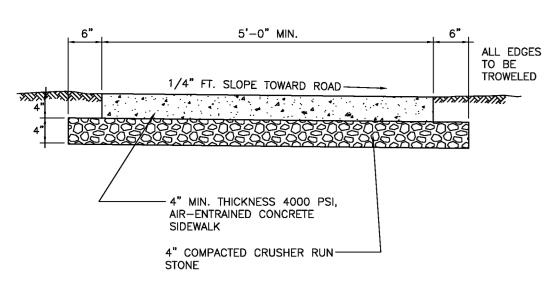

- 1. CONSTRUCTION JOINTS TO BE INSTALLED EVERY 25 FEET.
- 2. DUMMY JOINTS MINIMUM 1" DEEP TO BE MADE EVERY 5 FEET.
- 3. ALL EXPOSED CONCRETE SURFACE SHALL BE BROOM FINISHED.
- 4. ALL EXPOSED CONCRETE TO RECEIVE TWO COATS OF A COMBINATION CURING COMPOUND-SEALER SUCH AS "ACCUSEAL" OR "POLYCLEAR" OR APPROVED EQUAL
- 5. CONCRETE SIDEWALKS THROUGH DRIVEWAYS SHALL BE INCREASED TO A 5" THICKNESS
- WITH 10 GUAGE WIRE MESH FOR REINFORCEMENT.

### TYPICAL CONCRETE SIDEWALK DETAIL

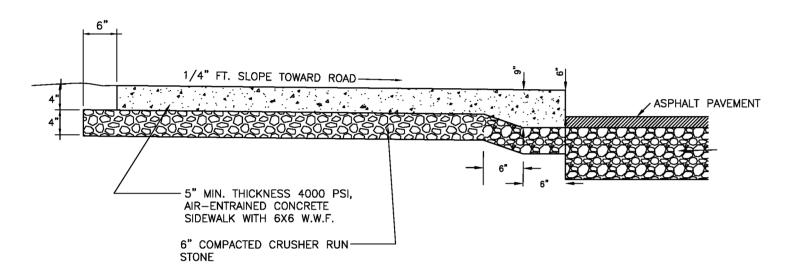

LIGHTING "

POLE: SQS411 OR APPROVED EQUAL

HORIZONTAL LAMP WITH SAG LENS

POLE MOUNTED AT 20'-0"

6" ARM MOUNT

DIE-CAST ALUMINUM


DARK BRONZE FINISH


FIXTURE:

LED

LITHONIA KAD LED - LED AREA LUMINAIRE KAD LED 63B530/400K SR2


#### CONCRETE SIDEWALK AND INTEGRAL CURB

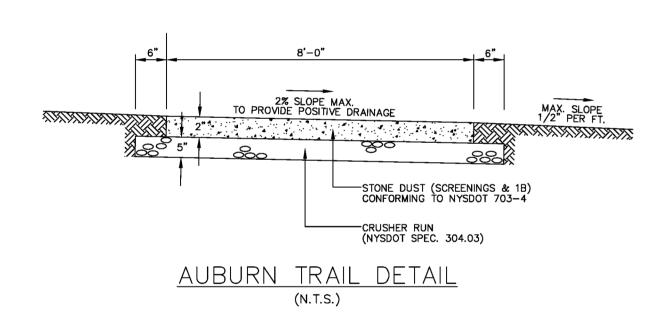

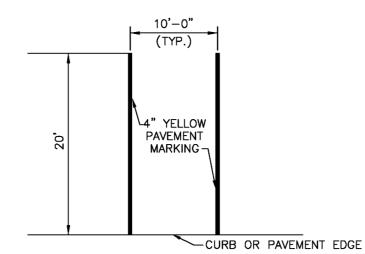



### TYPICAL PARKING STALL



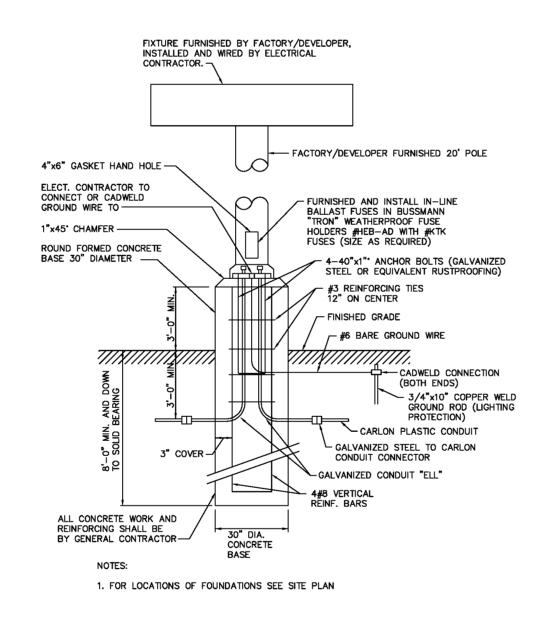

TYPICAL LIGHTING POLE FOUNDATION

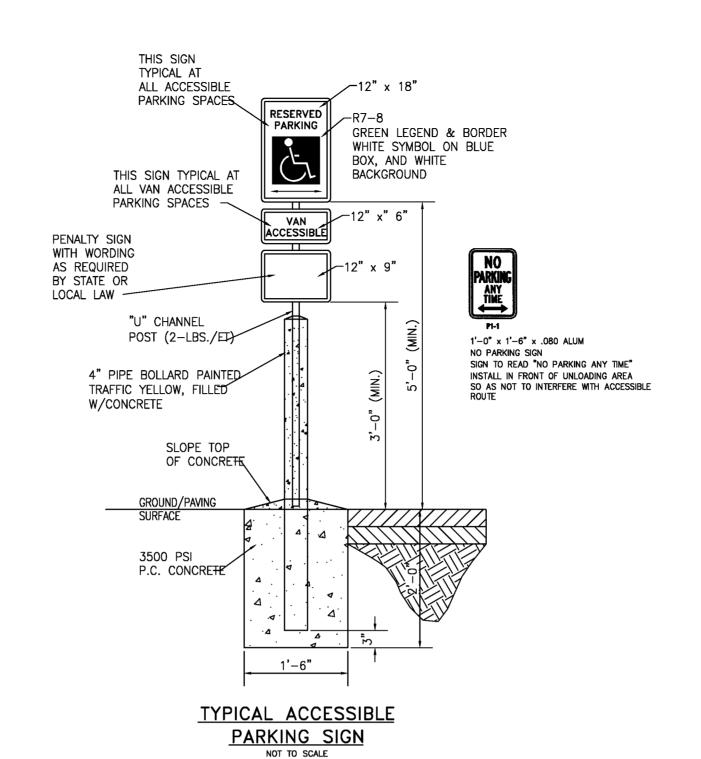

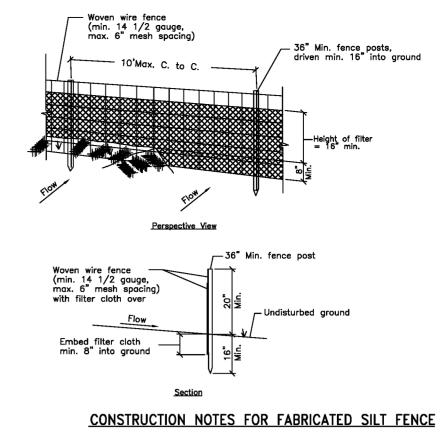

1. Woven wire fence to be fastened securely to fence posts with wire ties or staples. Woven wire, 14 1/2 ga. 6" max. mesh opening 2. Filter cloth to be fastened securely to woven wire fence with ties spaced every 24" at top and mid section. Filter X, Mirafi 100x, Stabilinka T140N or approved equal 3. When two sections of filter cloth adjoin each other they shall be over— lapped by six inches and folded.

Prefabricated unit: Geofab, Envirofence,

or approved equal

Maintenance shall be performed as needed and material removed when "bulges" develop in the silt fence.

#### EROSION CONTROL NOTES AND SEQUENCE OF IMPLEMENTATION

- 1. Cut the primary and secondary ground cover that currently
- 2. Install stabilized construction entrance.

immediate additional work.


- 3. Place staked straw bales or silt fences as shown on the
- 4. Rough grading the site including grubbing and stripping of
- 5. Seed and mulch all disturbed areas not scheduled for
- 6. Remaining disturbed areas will be seeded with ground cover and mulched as soon after their disturbance as construction practices and weather will allow.
- 7. The control of erosion and sediment shall be a continuous process undertaken as necessary during construction and when necessary after the completion of this project. erosion and sediment controls shall be maintained and replaced as necessary until such time as a substantial stand of vegetation has developed and the potential for erosion no longer exists.
- 8. The developer shall be responsible to insure that all erosion control measures are installed, maintained, and removed when no longer needed.

#### SILT FENCE DETAIL Not To Scale

EXCAVATED AREA = 100 SQUARE FEET EXCAVATED DEPTH = 1 FOOT -BELOW TOP OF INLET SIDE SLOPE = 2:1 (MAXIMUM)

#### SECTION VIEW

### EXCAVATED DROP INLET PROTECTION

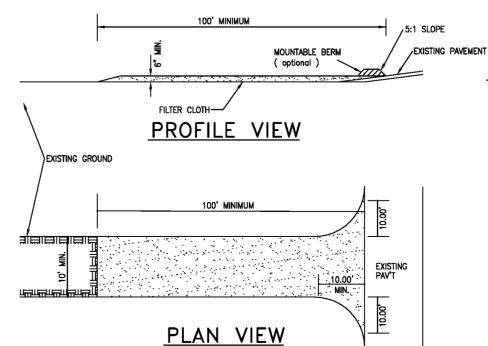

## CONSTRUCTION SPECIFICATIONS

- 1. STONE SIZE USE 2" STONE, OR RECLAIMED OR RECYCLED CONCRETE EQUIVALENT 2. LENGTH - AS REQUIRED, BUT NOT LESS THAN 50 FEET ( except on a single residence lot where a 30 foot minimum length would apply ). 3. THICKNESS - NOT LESS THAN SIX ( 6 ) INCHES.
- 4. WIDTH TEN ( 10 ) FOOT MINIMUM, BUT NOT LESS THAN THE FULL WIDTH AT POINTS WHERE INGRESS OR EGRESS OCCURS.
- FILTER CLOTH WILL BE PLACED OVER THE ENTIRE AREA PRIOR TO PLACING OF STONE. FILTER CLOTH WILL NOT BE REQUIRED ON A SINGLE FAMILY RESIDENCE LOT.
- SURFACE WATER ALL SURFACE WATER FLOWING OR DIVERTED TOWARD CONSTRUCTION ENTRANCES SHALL BE PIPED ACROSS THE ENTRANCE. IF PIPING IS IMPRACTICAL, A MOUNTABLE BERM WITH 5:1 SLOPES WILL BE PERMITTED. MAINTENANCE - THE ENTRANCE SHALL BE MAINTAINED IN A CONDITION WHICH
- WILL PREVENT TRACKING OR FLOWING OF SEDIMENT ONTO PUBLIC RIGHT-OF-WAYS.

  THIS MAY REQUIRE PERIODIC TOP DRESSING WITH ADDITIONAL STONE AS CONDITIONS

  DEMAND AND REPAIR AND/OR CLEANOUT OF ANY MEASURES USED TO TRAP


  SEDIMENT. ALL SEDIMENT SPILLED, DROPPED, WASHED OR TRACKED ONTO

  PUBLIC RIGHT-OF-WAYS MUST BE REMOVED IMMEDIATELY. WASHING — WHEELS SHALL BE CLEANED TO REMOVE SEDIMENT PRIOR TO ENTRANCE ONTO PUBLIC RIGHT—OF—WAYS. WHEN WASHING IS REQUIRED, IT SHALL BE

DONE ON AN AREA STABILIZED WITH STONE AND WHICH DRAINS INTO AN APPROVED

9. PERIODIC INSPECTION AND NEEDED MAINTENANCE SHALL BE PROVIDED

CONSTRUCTION ENTRANCE

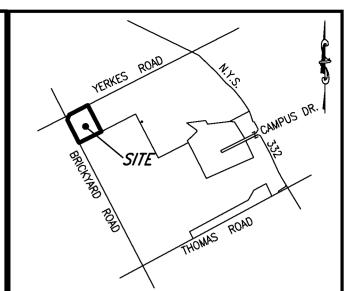

#### LOCATION SKETCH N.T.S

**REVISIONS** BY: DATE



#### DRAWING ALTERATION

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#### **Engineers & Surveyors**

822 Holt Road Webster, NY 14580 (585) 436-1080 www.McMahon-LaRue.com

#### CLIENT:

MORGAN CANANDAIGUA LLC 1180 PITTSFORD-VICTOR RD. SUITE 100 PITTSFORD, NY 14534

PROJECT:

#### CENTERPOINTE APARTMENTS

PHASE 3

**DRAWING** 


#### FINAL NOTES AND DETAILS

PART OF TOWN LOT 103 TOWN OF CANANDAIGUA ONTARIO COUNTY STATE OF NEW YORK


**DESIGNED BY:** GWM DRAWN BY: GWM CHECKED BY: 8.B.L. # 56.00-01-55.21 AND 55.22 PROJ. NO: 1279-00 DATE: MAY 2016 SCALE: AS NOTED CADD FILE:

10 of

DETAIL

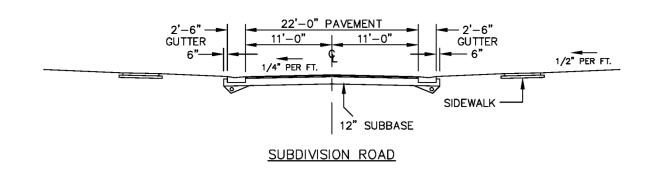

#### TYPICAL ROAD CROSS SECTIONS (N.T.S.)

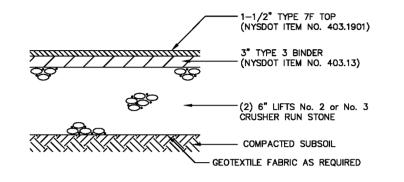


SUBDIVISION ROAD

NOTE: ALL DEPTHS ARE COMPACTED THICKNESSES AND


PAVEMENT THICKNESSES MAY VARY AS REQUIRED BY ENGINEER


PAVEMENT CROSS SECTION (TYP.) (N.T.S.)

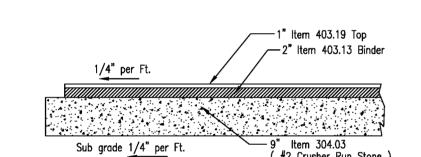


## DRIVEWAY ASPHALT PAVEMENT


NOT TO SCALE

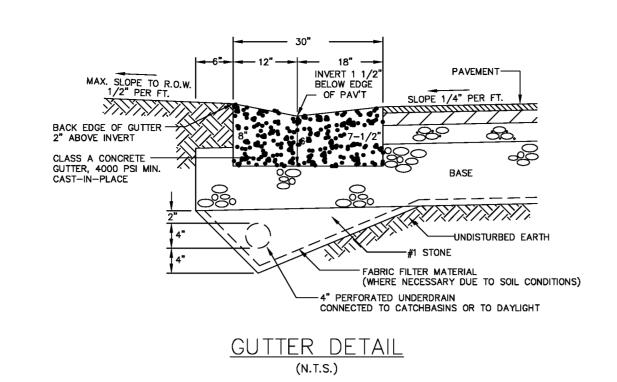


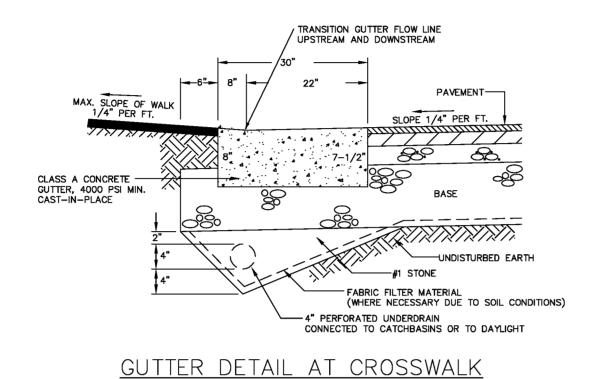


(N.T.S.)

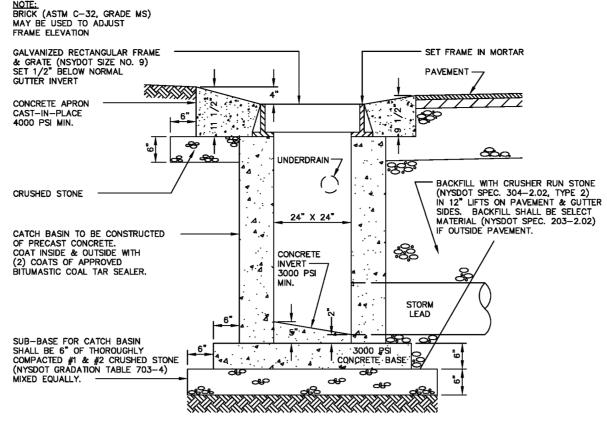


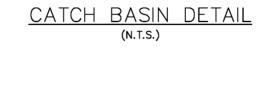

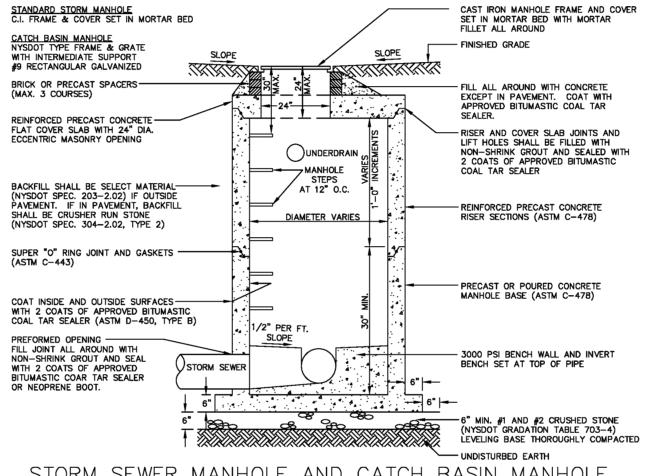

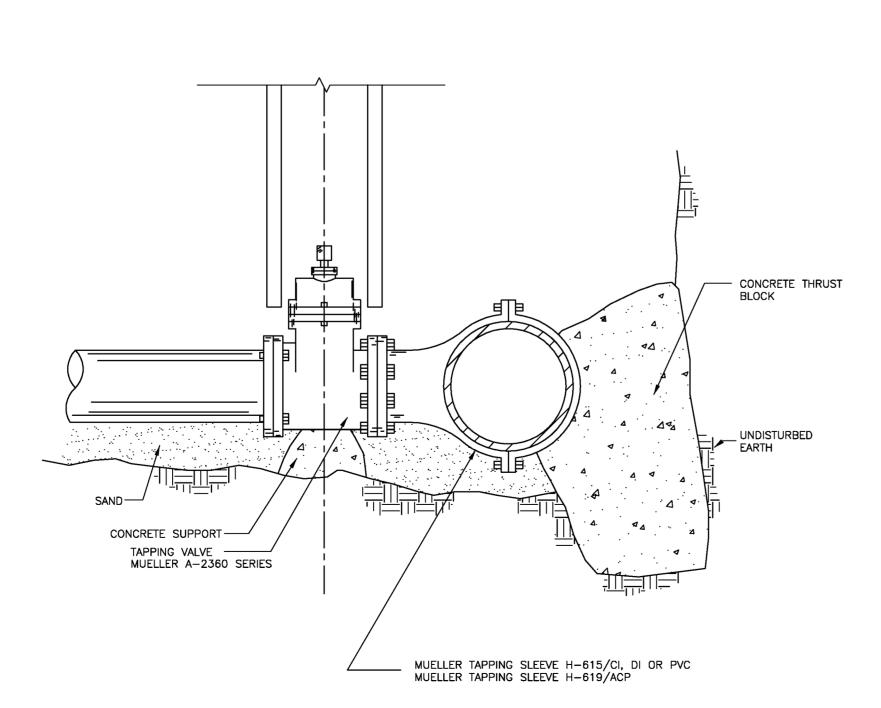

TAPPING SLEEVE AND VALVE

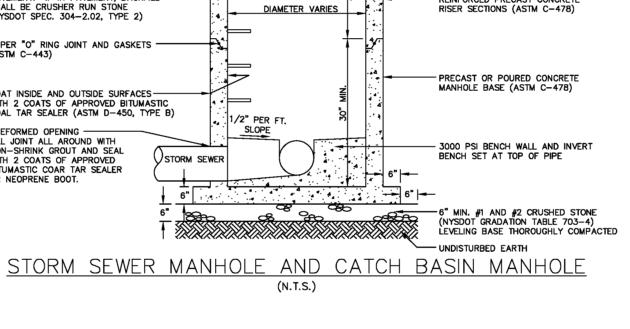

HORIZONTAL THRUST BLOCK FOR TEES AND PLUGS

HORIZONTAL THRUST BLOCK FOR BENDS
NOT TO SCALE

1.25 2.0 1.75 3.00

2.0 3.0 2.5 4.0

Note:
1. All dimensions are in feet.
2. Bearing areas are based on allowable bearing pressure of 3000 psi.
3. Height of the thrust block shoild be equal to or less than 1/2 the depth from the ground surface to the base of the block.
4. Minimum concrete strength shall be 3000 psi.

BEND

PIPE SIZE (inches)

WORKING PRESS.

ELEVATION

ELEVATION


1.50 1.75 2.00 2.00

BEND

2.5 2.25 1.75 1.75 3.0 3.0 2.33 2.0


1.0 1.50

22-1/2° BEND

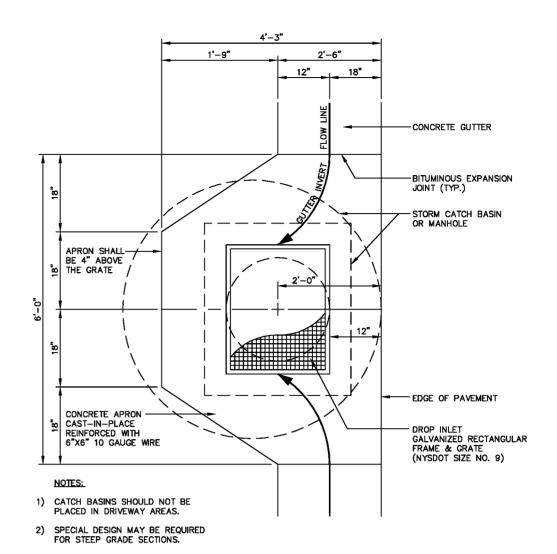

TOWN OF CANANDAIGUA

#### GUTTER & CATCH BASIN APRON DETAIL (N.T.S.)

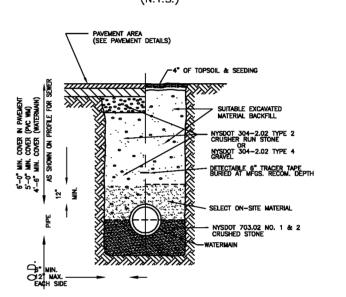

#### TYPICAL WATERMAIN TRENCH

#### **WATERMAIN NOTES:**

Pressure and leakage test on all water mains shall be carried out in accordance with the Town of Farmington's latest standards and applicable AWWA standards.

2. The water main shall be disinfected equal to AWWA standard specifications C-601-68 with the exception of Item 7.3.

Materials

a. Water mains shall be ductile iron pipe - Class 52 cement lined in accordance with AWWA C-104 and shall have rubber gasket push-on joints in accordance with AWWA C-111. b. Services shall be 1-1/2" seamless copper tubing, Type K, ASTM B-88. Curb boxes shall be Mueller H- 10414 with 82866 rod, 5 foot box length and corporation stops Mueller B-15000.


c. Each water service shall be provided with a check valve and pressure regulator on the downstream side

d. Hydrants shall be manufactured by Mueller or Kennedy in accordance with AWWA C-502. Hydrants shall be manufactured for 5 foot bury with break—away flange construction and 6 inch mechanical joint inlet. They shall open left and be painted yellow with red caps and bonnets as approved by the Superintendent of Water. Hydrants shall be 3—way with two 2—1/2" hose nozzles and one 4—1/4" pumper connection and have National Standard threads. Main valve openings shall be 5—1/4" and packing shall consist of the tee, guard valve, hydrant and adapter.

e. Gate valves shall conform to AWWA C-500, hinge mounted, double disc, resilient seat with non-rising stem and "0" ring packing. They shall be of the 350 psi test class with a minimum working pressure of 200 psi or a resilient seat valve conforming to AWWA C-509 with fully encapsulated wedge or rubber seat ring. Epoxy coated on the valve interior. Valves shall open left and be one of the following types: Mueller or Kennedy.

4. Water mains and all water service lines to have a minimum of five (5) feet of cover from finished grade; six (6) feet at road crossing and beneath parking facilities. 5. Where water and sewer mains cross the trench, the trench will be stoned from the bottom of the trench of lower pipe to the spring line of the upper pipe using a mix of 1A and 1 or 1 and 2 stone compacted in six (6) inch lifts.

6. If ground water is encountered within seven (7) feet of the surface, the fire hydrants weep holes shall be plugged and the effected fire hydrants shall be noted on the plans.

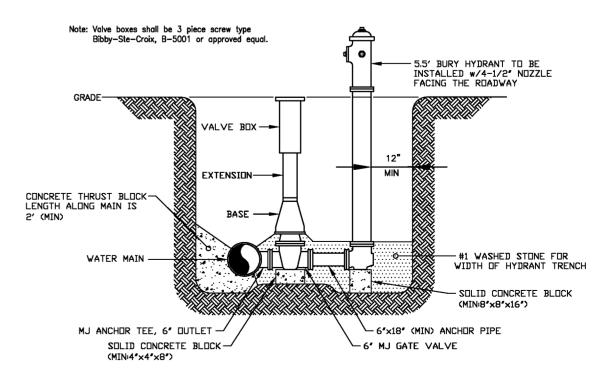

PERPENDICULAR HYDRANT ASSEMBLY NOT TO SCALE





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PROJECT:

## CENTERPOINTE APARTMENTS

PHASE 3

**DRAWING** 

### FINAL NOTES AND DETAILS

PART OF TOWN LOT 103 TOWN OF CANANDAIGUA ONTARIO COUNTY STATE OF NEW YORK

DESIGNED BY:	GWM				
DRAWN BY:	GWM				
CHECKED BY: AIL					
8.B.L. #	56.00-01-55.21 AND 55.22				
<b>PROJ. NO:</b> 1279-00					
DATE: MAY 2016					
SCALE:	AS NOTED				
SHEET		CADD FILE:			
11 OF 12   DETAIL					

#### CANANDAIGUA LAKE COUNTY SEWER DISTRICT

#### **STANDARD SANITARY SEWER PLAN NOTES:**

- 1. Sewer permits and permits for work within Ontario County Highway rights of way must be purchased in advance at the Ontario County Public Works office located at 2962 County Road 48 in the Town of Honewell, Call 585-396-4000 for information.
- 2. Sanitary sewer construction and/or improvements shall be in accordance with the most recent standards and specifications of the Canandaigua Lake County Sewer District, N.Y.S. Department of Environmental Conservation, N.Y.S. Department of Health, the latest edition of Recommended
- Standards for Wastewater Facilities and any other agencies having jurisdiction. Sanitary sewer main gravity pipe shall be 8" dia. or larger PVC Class SDR-35 or SDR-21 with elastomeric joints. Laterals shall be 4" dia. SDR-21 with elastomeric joints. Actual field conditions may require additional pipe or backfill reinforcement. The sanitary sewer will be designed by the developer's engineer. Field changes must be approved by the sewer district.
- The sanitary sewer is designed to provide gravity service to all adjacent building basements. Exceptions have been approved by the sewer district and are clearly noted on the utility plan. Basement floor elevations will be shown on the sanitary sewer profile for each lot that will not be served by gravity laterals.
- The contractor shall locate, mark and preserve any right of way monuments or survey control in the area of construction
- 6. Utility locations shown are approximate only. The contractor shall determine exact location of utilities, excavating to expose the utility, if necessary in the area of construction, before commencing construction. Contact U.F.P.O. at 1-800-962-7962 at least 72 hours prior to construction.
- The sanitary sewer shall be located a minimum horizontal distance of 10' from any existing or proposed water main (as measured from the outside of the sewer to the outside of the water main). In cases where the sanitary sewer crosses a water main, the minimum vertical separation shall be 18" (measured out-to-out). The crossing shall be arranged so that the sewer joints will be equidistant and as far as possible from the water main joints.
- 8. A letter of credit, or engineer approved equivalent, for an amount equal to the estimated cost of construction, inspection, record drawings, dedication documents and related expenses for the sanitary sewer plus an additional 10% for contingencies must be submitted to the Commissioner of Public Works before a permit is issued or sewer construction may commence.
- 9. The contractor shall provide the District with shop drawings and material specifications that have been pre-approved by the design engineer before a permit will be issued.
- 10. The developer is responsible for the preparation of all required easement maps and descriptions and submission to the District for approval. Permits will not be issued prior to the easement documents being signed by the Commissioner and recorded in the County Clerk's office. 11. The contractor is responsible for compliance with OSHA requirements in all aspects of
- construction. 12. When sanitary sewer construction activities begin, the contractor shall plug the main at the connecting manhole. Plugs shall not be removed until the completed sewer line is tested and approved for use.
- 13. The contractor shall be responsible for maintaining sanitary flows at all times by methods acceptable to the developer's engineer and the District.
- 14. The sewer line shall be laid using a pipe laser. Grade shall be checked every 100 feet using a surveyor's level to insure the correct grade is being maintained.

- 15. Floor drains in the basement or garage are to be connected to the sanitary sewer. Floor drains do not include foundation or footer drains installed to intercept uncontaminated ground water. All discharges to the sanitary sewer must comply with effluent limits of the Ontario County sewer use law. Foundation and footer drains shall be constructed in a manner that will prohibit ground water from draining into the sanitary sewer pipe cradle.
- 16. Openings in existing manholes shall be made with a core saw. A rubber, water-tight pipe-tomanhole boot adapter or other District approved connector conforming to ASTM C-923, shall be used to make the connection to the existing manhole.
- 17. Connections requiring openings in asbestos cement pipe will be designed, inspected and certified by the design engineer or representative thereof.
- 18. All pipes entering and exiting manholes shall have a flexible water-tight joint no less than 1 foot
- and no greater than 3 feet from the outside wall of the manhole 19. Manholes deeper than 14 feet, less than 5 feet in depth, or having three or more pipe connections
- shall have a minimum inside diameter of 5 feet.
- 20. Any excavation not backfilled by the end of the workday shall be fenced, barricaded and lighted for safety and protection of the public. 21. The contractor shall be responsible for the removal of existing sanitary mains, structures and
- appurtenances, if any, needed to complete the work. 22. Existing laterals to be disconnected must be permanently plugged or capped at the easement or right of way line under the direction of the Canandaigua Lake County Sewer District Supervisor. The contractor is required to obtain a permit prior to performing the work. The location of the
- plug or cap shall be recorded for as-built drawing purposes. 23. Lateral clean outs will be provided at the right of way line or sanitary sewer easement line
- whichever is furthest from the sewer main, and every 90 linear feet thereafter. 24. The contractor shall take and record field measurements to all wyes, clean outs and lateral plugs as well as lengths of risers and depths at lateral plugs. The information will be given to the
- developer's engineer for use in preparing record drawings. 25. Following project completion and 30 days after the backfill has been in place the following tests shall be performed on gravity sanitary sewer main: a. Infiltration/ex-filtration tests on sewer main and manholes. Air pressure testing for
- sewer mains and vacuum testing for manholes is recommended. Tests on manholes may be performed only after manhole benches and inverts are complete.
- b. A deflection test using a rigid ball or mandrel having a diameter of 95% of the inside diameter of the pipe. Mechanical pulling devices will not be used. c. The sewer line will be televised and lamped after all other tests are complete. A good quality copy of the DVD or video-tape and related records will be submitted for
- evaluation to Canandaigua Lake County Sewer District. Prior to televising the sewer line shall be flushed and cleared of dirt, stones and debris. If permission is granted to remove the plug at the connecting manhole prior to flushing operation, provide downstream screens or other devices to prevent debris from entering the County's sewer system. Sections of pipe repaired or re-flushed will be re-televised until acceptable. 26. Upon project completion and District approval, the developer's engineer will submit record
- drawings on mylar and in electronic format, tied to NAD83 Horizontal and NAVD 88 Vertical datum. The drawings will show actual field measured locations, lengths, elevations and types of pipe and appurtenances, including wyes and laterals, as well as profiles, easements and any other related information requested by the District. Mylar drawings will be stamped/sealed and signed by a professional engineer or surveyor, and shall be at standard engineering scale (1" = 50' min.), and on standard sized drawings no smaller than 11" x 17" and no larger than 24" x 36". Project monumentation and permanent benchmarks shall be shown with coordinate and/or elevation

CONDITION

WATER LINE

ABOVE

SEWER LINE

WATER LINE

ABOVE


SEWER LINE


SEWER LINE

ABOVE

WATER LINE

- 27. The developer is responsible for providing easement maps and descriptions and sewer dedication documents. Maps will be recorded with dedication documents in the Ontario County Clerk's office, and therefore need to be submitted on legal size (8 ½" x 14") paper
- 28. Prior to releasing the retainage from the original letter of credit, a maintenance bond for a minimum of 10% of the total sanitary sewer-related cost of the project in favor of the Canandaigua Lake County Sewer District will be submitted to the Commissioner. The bond will expire no sooper that one year from the date of dedication of the sewer, or the release date of the retainage from the letter of credit, whichever occurs last.

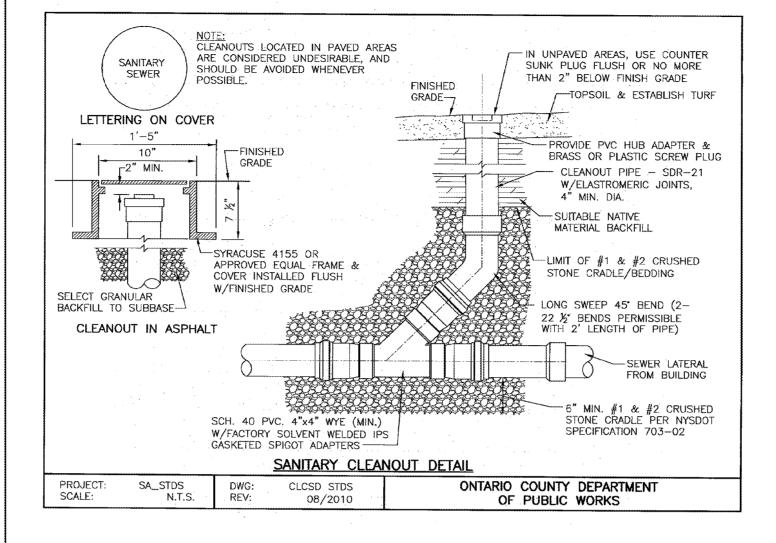

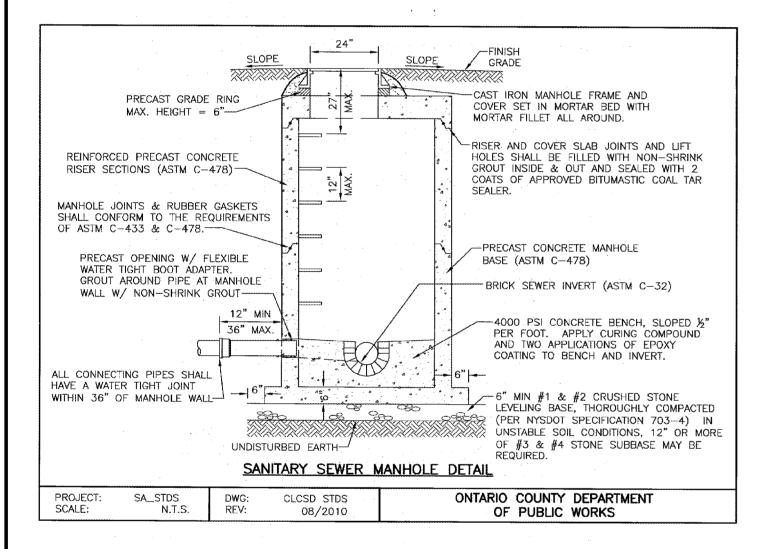


#### 1. MANHOLES LESS THAN 5 FEET DEEP, GREATER THAN 14 FEET DEEP. OR HAVING THREE OR MORE PIPE CONNECTIONS SHALL HAVE A MINIMUM INSIDE DIAMETER OF 5 FEET. 2. REINFORCED PRECAST CONCRETE FLAT COVER SLABS WITH 24" DIA. ECCENTRIC MASONRY OPENING SHALL BE USED FOR ALL MANHOLES. 3. ALL BENCHES, INVERTS AND INTERIOR WALLS OF THE MANHOLE BASE TO 12" ABOVE THE HIGHEST PIPE SHALL HAVE TWO APPLICATIONS OF EPOXY COATING (SIKAGARD 62, DURALKOTE 500 OR OTHER APPROVED EQUAL). THE REMAINING INTERIOR WALLS AND ENTIRE EXTERIOR SURFACE SHALL BE COATED WITH TWO APPLICATIONS OF APPROVED BITUMASTIC COAL TAR SEALER (ASTM D-450, TYPE B). 4. MANHOLE STEPS SHALL BE STEEL REINFORCED POLYPROPYLENE, CAST IN PLACE BY MANUFACTURER. 5. MANHOLE FRAME AND COVER SHALL BE SYRACUSE CASTING #1032, NEENAH R-1726 OR OTHER DISTRICT APPROVED

	EQUAL. COVER TO BE GASKETED WITH "SANITARY SEWER" CAST IN LID WITH 2" LETTERING (MAX. SIZE).
6.	FOR MANHOLES NOT LOCATED IN PAVEMENT, BACKFILL WITH SUITABLE NATIVE MATERIAL PER NYSDOT SPECIFICATION

MANHOLE NOTES:

5.	FOR MANHOLES NOT LOCATED IN PAVEMENT, BACKFILL WITH	
	SUITABLE NATIVE MATERIAL PER NYSDOT SPECIFICATION	
	203-2.01. FOR MANHOLES IN PAVEMENT, BACKFILL WITH	
	CRUSHER RUN STONE, TYPE 2 PER NYSDOT SPECIFICATION	
	304-2.02.	

		· ·	<u> </u>	. •	- '	
PROJECT: SCALE:	SA_STDS N.T.S.	DWG: REV:	CLCSD STDS 08/2010	01	COUNTY PUBLIC	DEPARTMENT WORKS
	. •					

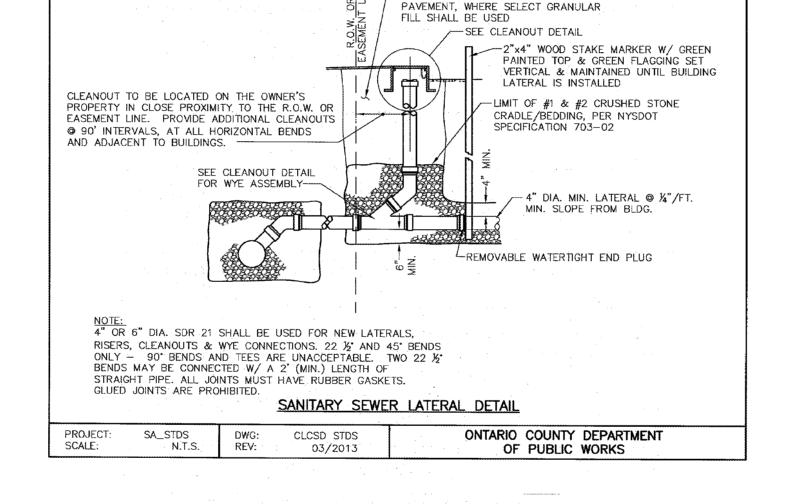

-- FILL VOID BETWEEN CORED

-REMAINING BACKFILL TO BE SUITABLE EXCAVATED MATERIAL EXCEPT IN

OF CONSTRUCTION FOR INSPECTION OF CONNECTION.

MAKING NEW HOLES IN EXISTING MANHOLES.

NOT BE LESS THAN 6" FROM A RISER JOINT.

CONSTRUCTED LOWER THAN THE CROWN OF THE

DAMAGE TO THE MANHOLE.

EXISTING MAIN SEWER INVERT.

UPSTREAM SEWER.

10 IMPACT DEVICES WIL BE ALLOWED TO BE USED FOR

BRACED AND PROTECTED TO PREVENT ANY SHIFTING OR

FXISTING MAIN SEWER. THE INVERT OF THE NEW SEWER SHALL BE CONSTRUCTED AT LEAST 3" ABOVE THE

SHALL NOT EXCEED 100 DEGREES FROM THE EXISTING

MANHOLE WITH TWO (2) COATS OF SIKAGARD NO. 62 FOR INTERIOR OF BASE AND TWO (2) COATS OF SUPER


SERVICE BLACK FOR ALL OTHER SURFACES.


**NEW SEWER CONNECTION** 

TO EXISTING MANHOLE


ONTARIO COUNTY DEPARTMENT

OF PUBLIC WORKS

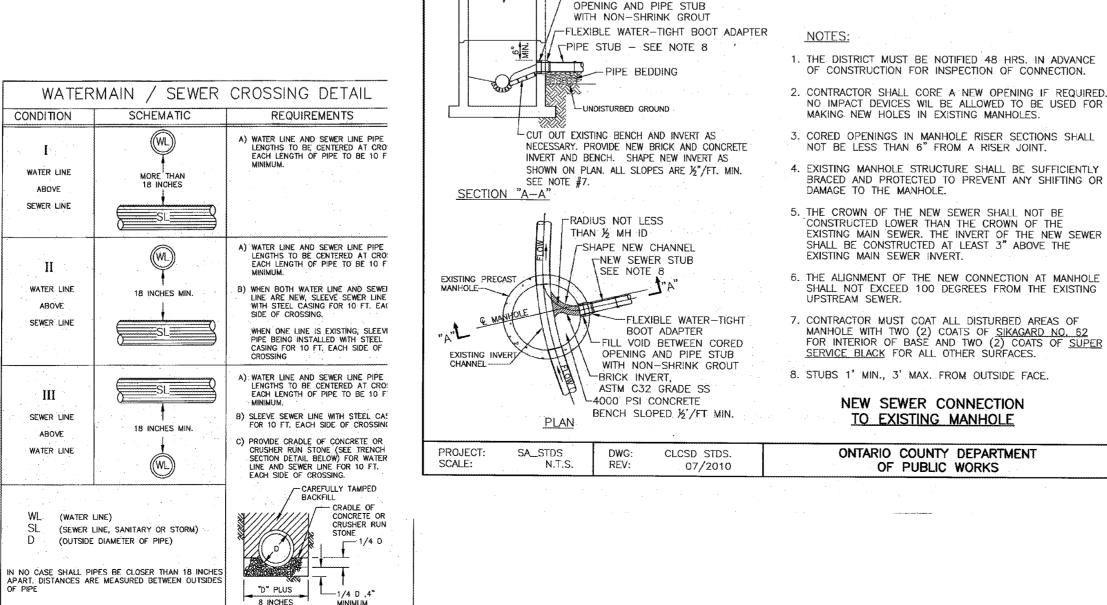

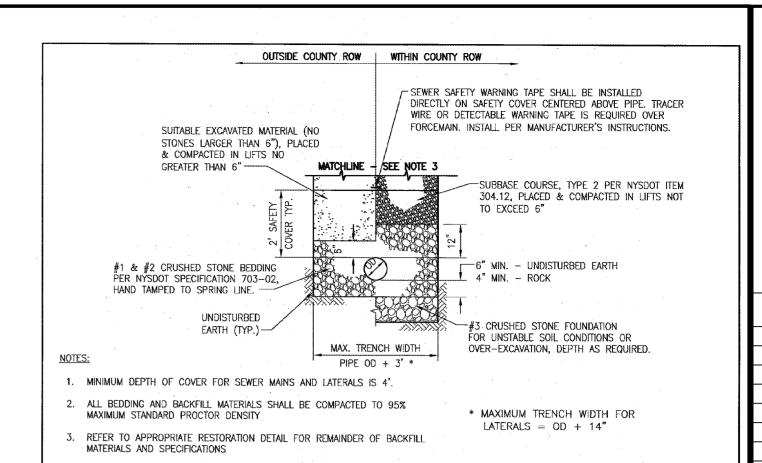

SANITARY SEWER MAIN AND LATERAL TRENCH, BEDDING & ENCASEMENT DETAIL

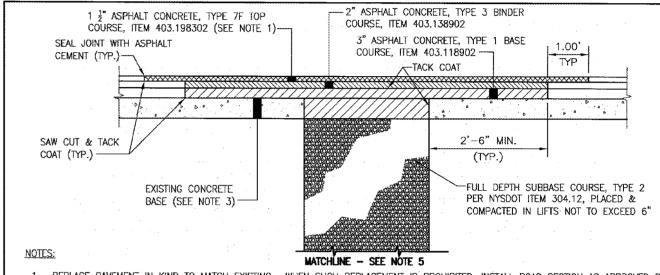

- 1. REPLACE PAVEMENT IN KIND TO MATCH EXISTING. WHEN SUCH REPLACEMENT IS PROHIBITED, INSTALL ROAD SECTION AS APPROVED BY ENGINEER. THE MINIMUM APPROVED SECTION SHALL BE 18" SUBBASE COURSE, TYPE 2 (ITEM 304.12, 3" ASPHALT CONCRETE TYPE 1 BASE COURSE (ITEM 403.118902), 2" ASPHALT CONCRETE TYPE 3 BINDER COURSE (ITEM 403.138902), AND 1 1 7 ASPHALT CONCRETE TYPE 7F TOP COURSE (ITEM 403.198902)
- 2. BACKFILL SHALL BE COMPACTED TO 95% MAXIMUM STANDARD PROCTOR DENSITY IN 6" MAXIMUM LIFTS.


03/2013

- 3. IF CONCRETE BASE IS EXISTING, REPLACE WITH A MINIMUM OF 6" OF ASPHALT CONCRETE TYPE 1 BASE COURSE ITEM 403.118902).
- 4. DAMAGED PAVEMENT MARKINGS OR SIGNAL LOOPS SHALL BE REPLACED IN KIND.
- 5. REFER TO SANITARY SEWER MAIN AND LATERAL TRENCH, BEDDING & ENCASEMENT DETAIL FOR TRENCH WIDTH, REMAINING BACKFILL MATERIALS AND SPECIFICATIONS

#### TRENCH AND PAVEMENT RESTORATION DETAIL FOR ROAD CUTS & PAVEMENT AREAS

ONTARIO COUNTY DEPARTMENT

OF PUBLIC WORKS

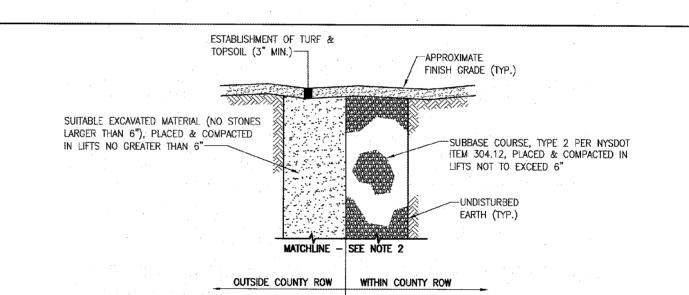

SA\_STDS


N.T.S.

REV:

- 1. ALL BACKFILL MATERIALS SHALL BE COMPACTED TO 95% MAXIMUM STANDARD
- 2. REFER TO SANITARY SEWER MAIN AND LATERAL TRENCH, BEDDING & ENCASEMENT DETAIL FOR TRENCH WIDTH, REMAINING BACKFILL MATERIALS AND SPECIFICATIONS

TRENCH RESTORATION DETAIL FOR NON-PAVEMENT AREAS

SA\_STDS CLCSD STDS ONTARIO COUNTY DEPARTMENT SCALE: N.T.S. OF PUBLIC WORKS

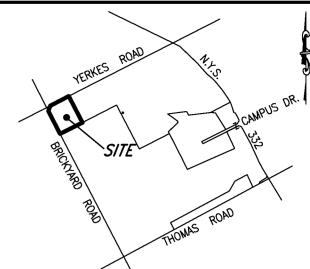

LOCATION SKETCH N.T.S

BY DATE **REVISIONS** 



DRAWING ALTERATION

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**Enaineers & Surveyors** 

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CLIENT:

MORGAN CANANDAIGUA LLC 1180 PITTSFORD-VICTOR RD. SUITE 100 PITTSFORD, NY 14534

PROJECT:

CENTERPOINTE APARTMENTS

PHASE 3

**DRAWING** 

FINAL NOTES AND DETAILS

> PART OF TOWN LOT 103 TOWN OF CANANDAIGUA ONTARIO COUNTY

STATE OF NEW YORK

**DESIGNED BY:** GWM DRAWN BY: GWM CHECKED BY: 56.00-01-55.21 AND 55.22 8.B.L. # PROJ. NO: 1279-00 DATE: MAY 2016 AS NOTED CADD FILE:

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DETAIL