
# PRELIMINARY/FINAL SITE PLANS for BURKE-SHEPARD RESIDENCE

5007 & 5009 COUNTY ROAD 16

SITUATE IN:

TOWN OF CANANDAIGUA - ONTARIO COUNTY - STATE OF NEW YORK

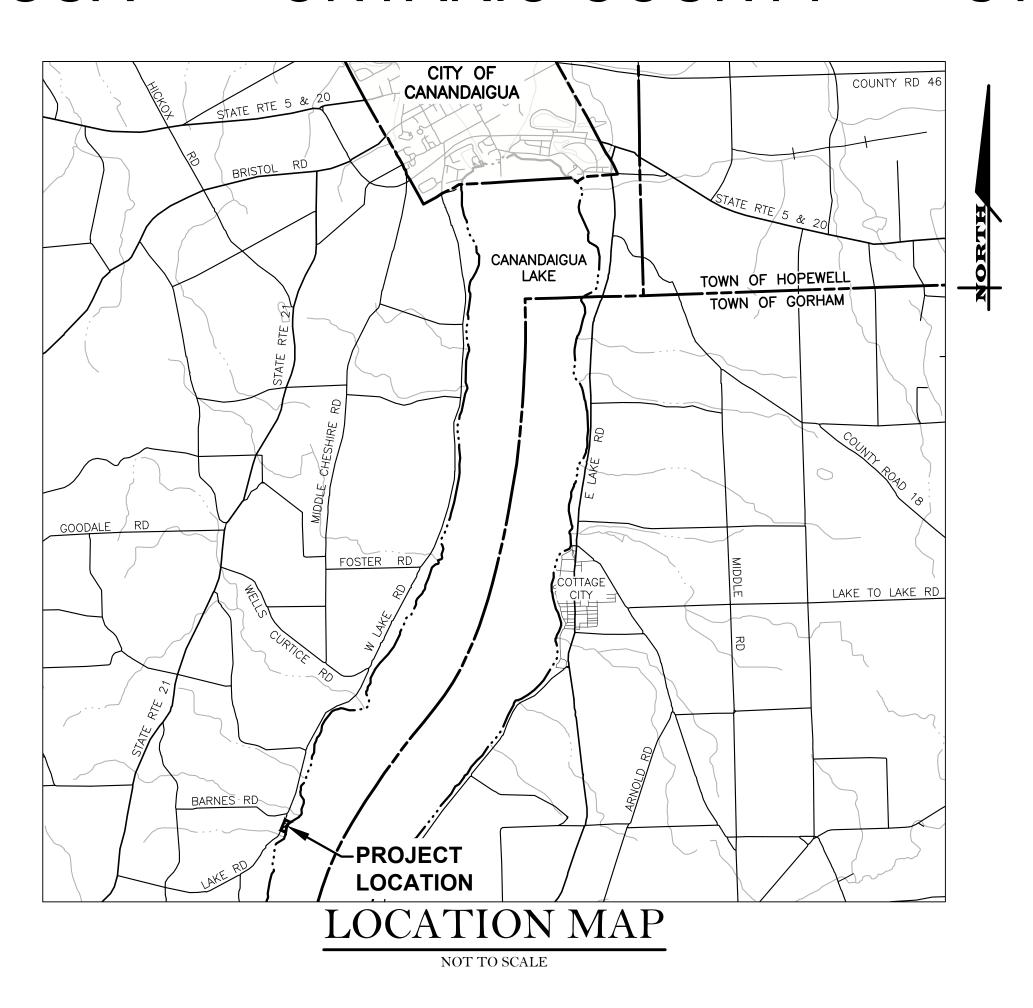



3 9 CASCADE DRIVE
ROCHESTER, NY 14614
5 8 5 - 4 5 8 - 7 7 7 0

ITHACA LOCATION

840 HANSHAW RD, STE 12
ITHACA, NY 14850
6 0 7 - 2 4 1 - 2 9 1 7

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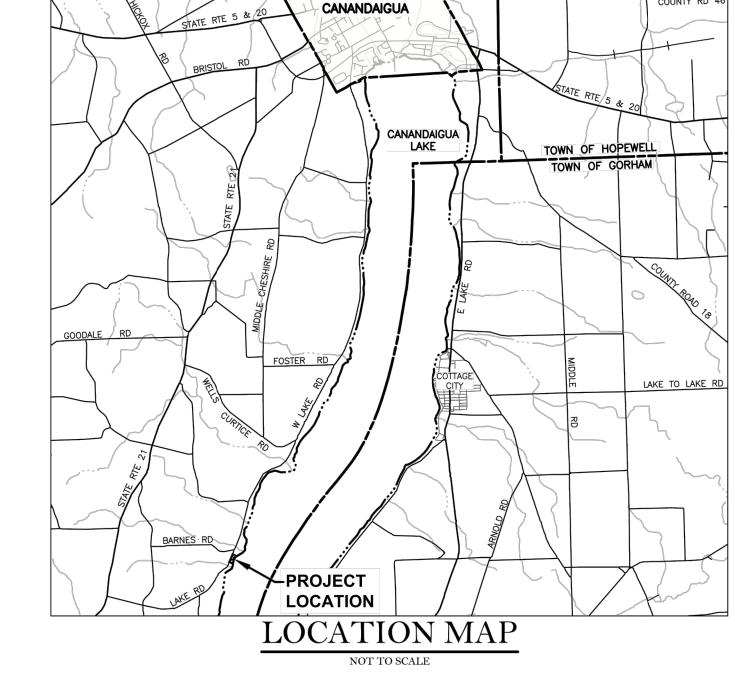
	LIST OF DRAWINGS					
No.	DWG. No.	DESCRIPTION				
1	COVER	COVER				
2	V1.0	EXISTING CONDITIONS & DEMOLITION PLAN				
3	C2.0	SUBDIVISION & LAYOUT PLAN				
4	C3.0	GRADING & UTILITY PLAN				
5	C3.1	SEPTIC SYSTEM DESIGN PLAN				
6	C4.0	EROSION CONTROL & LANDSCAPING PLAN				

# NOTES


- 1. MAPPING THE EXISTING CONDITIONS SHOWN ON THIS PLAN WERE PREPARED BY VENEZIA LAND SURVEYORS AND CIVIL ENGINEERS. THE ENGINEER MAKES NO WARRANTY AS TO THE LOCATION, SIZE, TYPE, ELEVATION, AND/OR NUMBER OF EXISTING UTILITIES. THE CONTRACTOR SHALL BE RESPONSIBLE FOR DETERMINING THE HORIZONTAL AND VERTICAL LOCATION OF UTILITIES IN THE VICINITY OF THE NEW INFRASTRUCTURE.
- 2. STAKEOUT THE CONTRACTOR SHALL NOTIFY DIG SAFELY NEW YORK (1-800-962-7962) FOR A UTILITY STAKEOUT 48 HOURS IN ADVANCE OF COMMENCING WORK. STAKEOUT OF PRIVATE UTILITIES SHALL BE COORDINATED WITH THE OWNER.
- 3. BOUNDARY BOUNDARY INFORMATION IS SHOWN FOR GRAPHICAL REPRESENTATION ONLY.
- 4. DATUM THE VERTICAL DATUM WAS SET TO NAVD 88.
- 5. COORDINATE SYSTEM THE PROJECT IS NOT TIED TO ANY COORDINATE SYSTEM, AND THE HORIZONTAL DATUM IS THEREFORE ASSUMED.
- 6. FLOODPLAIN THE PROPERTY IS LOCATED IN ZONE 'X' AND IS NOT LOCATED GRAPHICALLY IN THE FLOODPLAIN AS SHOWN ON COMMUNITY PANEL No 3605980025C, DATED 03/03/1997


#### **SPECIAL DEMOLITION NOTES**

- 1. THE CONTRACTOR SHALL VERIFY THAT A LL UTILITIES TO BE REMOVED DO NOT HAVE ANY IN SERVICE LATERALS OR SERVICES CONNECTED TO THEM. ANY LATERALS/ SERVICES THAT ARE STILL IN SERVICE SHALL BE RECONNECTED AND THE OWNER'S ON-SITE REPRESENTATIVE AND DESIGN ENGINEER SHALL BE NOTIFIED IMMEDIATELY.
- 2. IT IS INTENDED TO LIMIT DISTURBANCE AS MUCH AS POSSIBLE. THE CONTRACTOR WILL BE RESPONSIBLE TO COORDINATE DEMOLITION SCHEDULE, PHASING, PEDESTRIAN SAFETY, PARKING AND VEHICULAR CIRCULATION, STOCKPILE LOCATIONS AND SECURITY FENCING WITH OWNERS ON-SITE REPRESENTATIVE. ANY DISTURBANCE OUTSIDE THE WORK LIMIT LINE SHALL BE COORDINATED WITH THE OWNER'S ON-SITE
- 3. ITEMS TO BE SALVAGED SHALL BE STOCKPILED IN A SECURE LOCATION FOR REINSTALLATION. ANY ITEMS DAMAGED DURING REMOVAL SO AS TO BE UN-USEABLE SHALL BE REPLACED IN KIND.



CITY OF

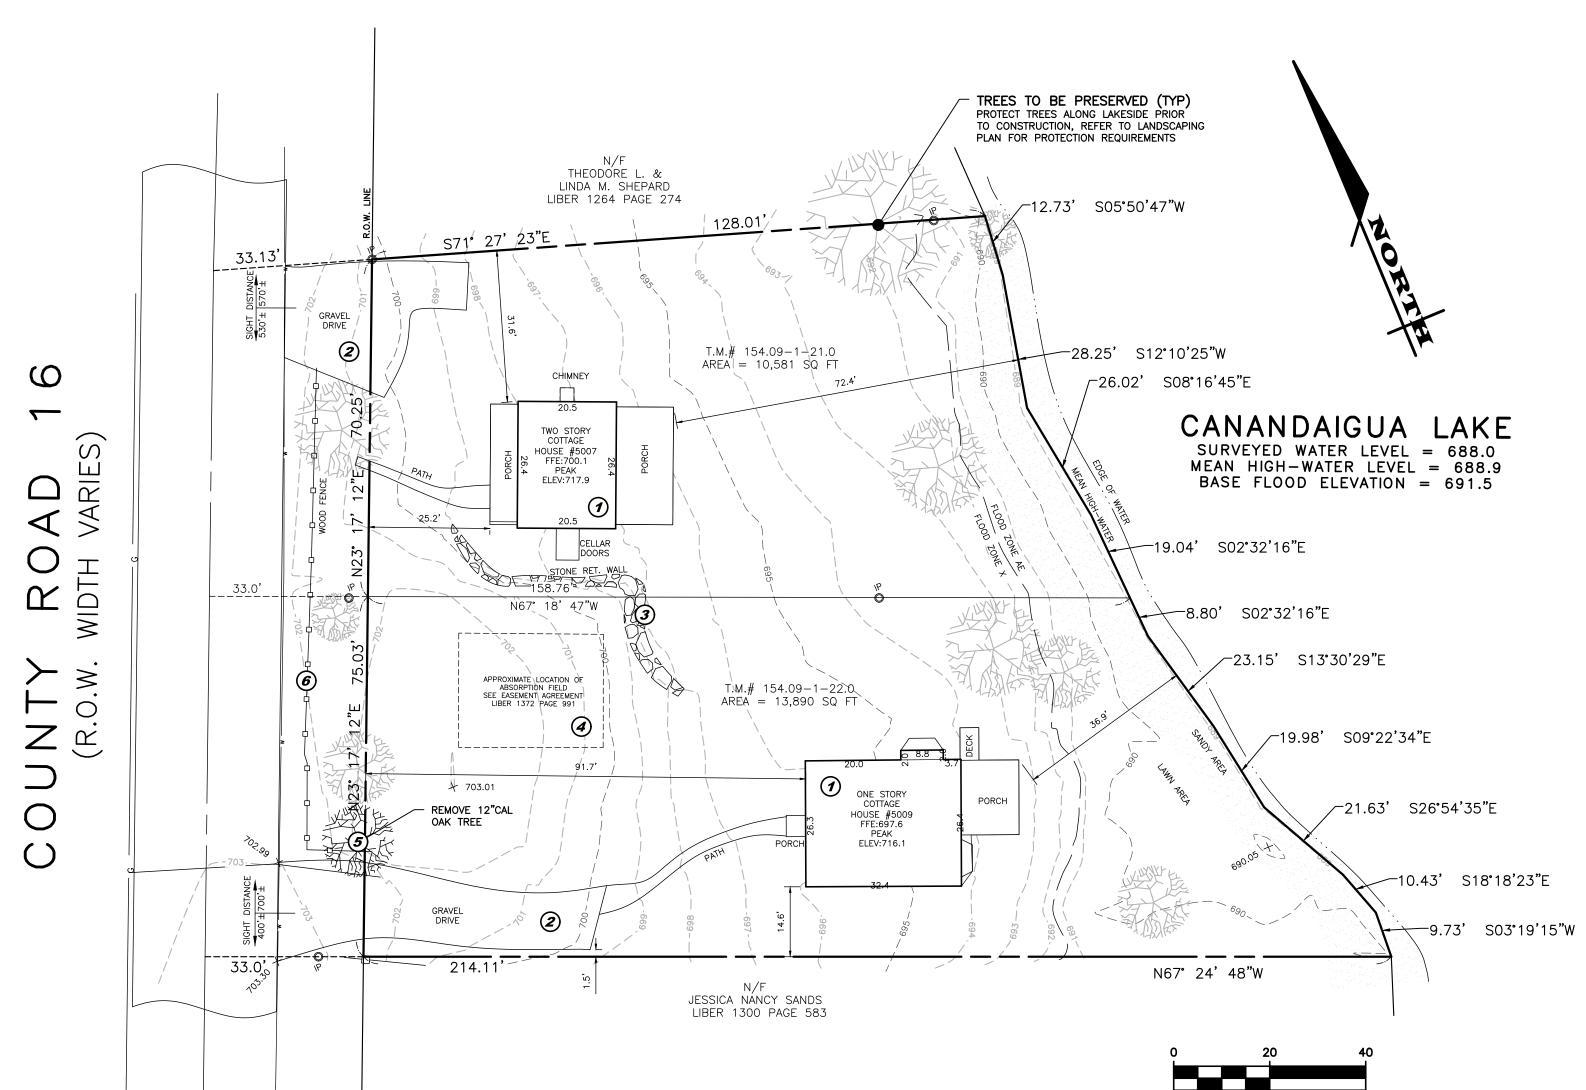

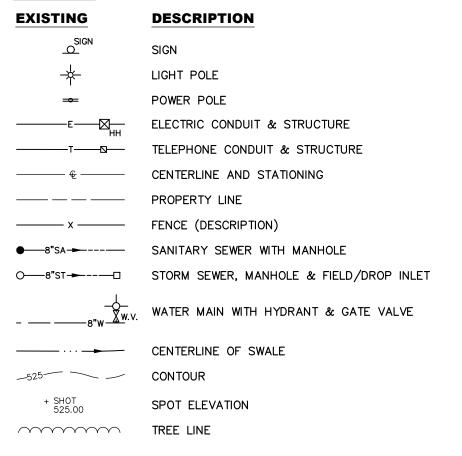

**LEGEND** 

**DEMOLITION SCHEDULE** DEMOLISH HOUSE IN ENTIRETY, INCLUDING BASEMENT. REMOVE AND DISPOSE OF MATERIALS. COORDINATE SERVICE ABANDONMENT WITH UTILITY PROVIDERS.

(2) REMOVE EXISTING GRAVEL PARKING AREA AND HARDSCAPES.

(3) REMOVE STONE GARDEL WALL IN ENTIRETY. (4) DECOMMISSION EXISTING SEPTIC SYSTEM. SEPTIC AND PUMP TANKS SHALL BE REMOVED AND DISPOSED.

(5) REMOVE TREE AND DISPOSE OFFSITE. REVIEW TREES TO BE REMOVED WITH OWNER'S REPRESENTATIVE PRIOR TO REMOVAL. 6 REMOVE FENCE AND DISPOSE

PLANNING BOARD CHAIRPERSON APPROVED BY: TOWN ENGINEER APPROVED BY: TOWN WATER SUPERINTENDANT

APPROVED BY:

ENGINEERING ROCHESTER LOCATION

39 CASCADE DRIVE ROCHESTER, NY 14614 5 8 5 - 4 5 8 - 7 7 7 0 ITHACA LOCATION 840 HANSHAW RD, STE 6 ITHACA, NY 14850 6 0 7 - 2 4 1 - 2 9 1 7

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JOB NO: 1436-22 SCALE: **AS SHOWN** DRAWN: DESIGNED: DATE: 7/1/22 REVISIONS DATE BY REVISION 07/15/22 LJB PRC COMMENTS 07/27/22 LJB TOWN COMMENTS ANY PERSON, UNLESS ACTING UNDER THE DIRECTION OF A LICENSED PROFESSION BNGINEER OR LAND SURVEYOR, TO ALTER IN ANY WAY, AN ITEM BEARING THE SEAL OF PROFESSIONAL ENGINEER OR LAND SURVEYOR, IF AN ITEM BEARING THE SEAL OF PROFESSIONAL ENGINEER OR LAND SURVEYOR IS ALTERED, THE ALTERING FINGINEER OF PROFESSIONAL ENGINEER OR LAND SURVEYOR IS ALTERED, THE ALTERING FINGINEER OF THE PROFESSIONAL ENGINEER OR LAND SURVEYOR IS ALTERED. AND SURVEYOR SHALL AFFIX TO THE ITEM THEIR SEAL AND THE NOTATION "ALTERED FOLLOWED BY THEIR SIGNATURE AND THE DATE OF SUCH ALTERATION, AND A SPEC COPYRIGHT © 2022 MARATHON ENG.

DRAWING TITLE: **EXISTING** CONDITIONS & **DEMOLITION PLAN** 

ROBERT P. BRINGLEY

2 of 6 SHEET No: 1436-22 JOB No: DRAWING No:

# PROJECT STATISTICS

#### 1. GENERAL:

- 1.1 APPLICANT LAUREEN BURKE & THEODORE SHEPARD 5005 COUNTY ROAD 16 CANANDAIGUA, NY 14424
- 1.2 PROPERTY ADDRESS 5007 & 5009 COUNTY ROAD 16 TOWN OF CANANDAIGUA, NEW YORK
- 1.3 TAX ACCOUNT 154.09-1-21.000 & 154.09-1-22.000

#### 2. PARCEL STATISTICS:

- 3.1 AREA 0.562 ACRES (24,471 SF)
- 3.2 EXISTING CONDITIONS: TWO SEPARATE PROPERTIES WITH EXISTING 600 AND 900 SQUARE FOOT COTTAGES ON THE RESPECTIVE LOTS.

**LEGEND:** 

DESCRIPTION

LIGHT POLE

TREE LINE

POWER POLE

ELECTRIC CONDUIT & STRUCTURE

WATER MAIN WITH HYDRANT & GATE VALVE

3.3 PROPOSED CONDITIONS: COMBINE SEPARATE LOTS AND CONSTRUCT AN APPROXIMATELY 3,667 SF SINGLE FAMILY RESIDENCE WITH DRIVEWAY, POOL, AND SEPTIC SYSTEM.

#### ZONING REGULATIONS:

- 2.1 ZONING DISTRICT RESIDENTIAL LAKE DISTRICT (RLD)
- 2.2 CODE REQUIREMENTS -

ITEM MIN. LOT AREA MIN. LOT WIDTH MAX BLDG. COVERAGE MAX LOT COVERAGE BUILDING HEIGHT	REQUIRED	EXISTING	PROPOSED
	20,000 SF	24,471 SF	24,471 SF
	125 FT	70.25 FT	145.28 FT
	15%	8.5%	15.0%
	25%	14.3%	26.9%*
	25 FT	<25FT	25 FT MAX
PRINCIPAL BUILDING SET FRONT SETBACK SIDE SETBACK REAR (LAKE) SETBACK DRIVEWAY SETBACK	BACKS: 60 FT 12 FT 60 FT 10 FT	25.2 FT 14.6 FT 36.9 FT 1.5 FT	40.0 FT* 12.0 FT 37.0 FT* 3.8 FT

(\* = VARIANCE NEEDED)

#### 1) GENERAL NOTES:

- 1. APPLICABILITY THE NOTES AND INFORMATION PROVIDED ON THIS SHEET ARE APPLICABLE TO ALL "C" SERIES DRAWINGS. THE "C" SERIES DRAWINGS COVER SITE RELATED IMPROVEMENTS OUTSIDE THE BUILDING ENVELOPE. THE BUILDING ENVELOPE INCLUDES ALL AREA WITHIN 5' OUTSIDE OF THE BUILDING'S EXTERIOR WALL.
- 2. MAPPING THE EXISTING UNDERGROUND UTILITIES WERE PLOTTED BASED ON RECORD MAPPING SUPPLIED BY OTHERS. THE ENGINEER MAKES NO WARRANTY AS TO THE LOCATION, SIZE, TYPE, ELEVATION, AND/OR NUMBER OF EXISTING UTILITIES. THE CONTRACTOR SHALL BE RESPONSIBLE FOR DETERMINING THE HORIZONTAL AND VERTICAL LOCATION OF UTILITIES IN THE VICINITY OF THE NEW INFRASTRUCTURE.
- 3. STAKEOUT THE CONTRACTOR SHALL NOTIFY DIG SAFELY NEW YORK (1-800-962-7962) FOR A UTILITY STAKEOUT 48 HOURS IN ADVANCE OF COMMENCING WORK. STAKEOUT OF PRIVATE UTILITIES SHALL BE COORDINATED WITH THE OWNER.
- 4. PROPERTY PROTECTION THE CONTRACTOR IS RESPONSIBLE FOR DAMAGE TO EXISTING PAVEMENT, CURBS, WALKS, LAWNS, TREES, ETC. CAUSED BY THEIR CONSTRUCTION OPERATIONS. ALL DAMAGE SHALL BE REPAIRED OR REPLACED BY THE CONTRACTOR TO THE OWNER'S SATISFACTION AT NO ADDITIONAL EXPENSE.
- 5. ACCESS THE CONTRACTOR SHALL PROVIDE SATISFACTORY VEHICULAR ACCESS TO ALL ADJOINING PROPERTIES, PRIVATE ROADWAYS, PARKING FACILITIES, AND PUBLIC STREETS DURING CONSTRUCTION.
- 6. SITE SAFETY PRIOR TO AND THROUGHOUT CONSTRUCTION, THE CONTRACTOR SHALL POST SIGNAGE IN CONFORMANCE WITH THE REQUIREMENTS OF THE LOCAL MUNICIPALITY AND OCCUPATIONAL HEALTH AND SAFETY ACT (OHSA). JOB SAFETY AND MAINTENANCE AND PROTECTION OF TRAFFIC IS THE RESPONSIBILITY OF THE CONTRACTOR.
- 7. EXCAVATIONS ALL EXCAVATIONS SHALL BE BACKFILLED/BARRICADED TO THE SATISFACTION OF THE OWNER'S REPRESENTATIVE AT THE CONCLUSION OF EACH WORKING DAY.
- 8. MAINTENANCE PUBLIC STREETS, PRIVATE DRIVES AND PARKING FACILITIES SHALL BE KEPT FREE OF FOREIGN MATERIALS. ALL AREAS SHALL BE SWEPT CLEAN AT THE END OF EACH WORKING DAY AND/OR AS DIRECTED BY THE OWNER'S ON-SITE REPRESENTATIVE.
- 9. CONSTRUCTION STORAGE STORAGE OF EQUIPMENT AND MATERIALS SHALL BE WITHIN A SPECIFIED AND SECURED AREA AS DETERMINED IN CONTRACT DOCUMENTS OR AS SPECIFIED BY THE OWNER'S ON-SITE REPRESENTATIVE.
- 10. PERMIT(S) PRIOR TO CONSTRUCTION, THE CONTRACTOR SHALL OBTAIN THE NECESSARY PERMITS FROM THE APPLICABLE MUNICIPALITY OR AGENCY. THE CONTRACTOR IS RESPONSIBLE FOR ALL BONDS AND INSURANCES AND THE OWNER IS RESPONSIBLE FOR PERMIT FEES UNLESS OTHERWISE STATED IN THE OWNER/ CONTRACTOR AGREEMENT.
- 11. STAKEOUT THE CONSTRUCTION STAKEOUT SHALL BE PERFORMED BY A LICENSED LAND SURVEYOR USING CONTROL PROVIDED ON THE "LAYOUT PLAN". THE BUILDING FOOTPRINT, DATED 6/20/22, WERE PROVIDED BY HANLON ARCHITECTS. DISCREPANCIES WITH BUILDING(S), CONTROL POINTS, AND/ OR TIE DIMENSIONS SHALL BE REPORTED TO THE DESIGN ENGINEER (PRIOR TO THE INSTALLATION OF IMPROVEMENTS) FOR COORDINATION AND CLARIFICATION.

#### 2) ADDITIONAL NOTES:

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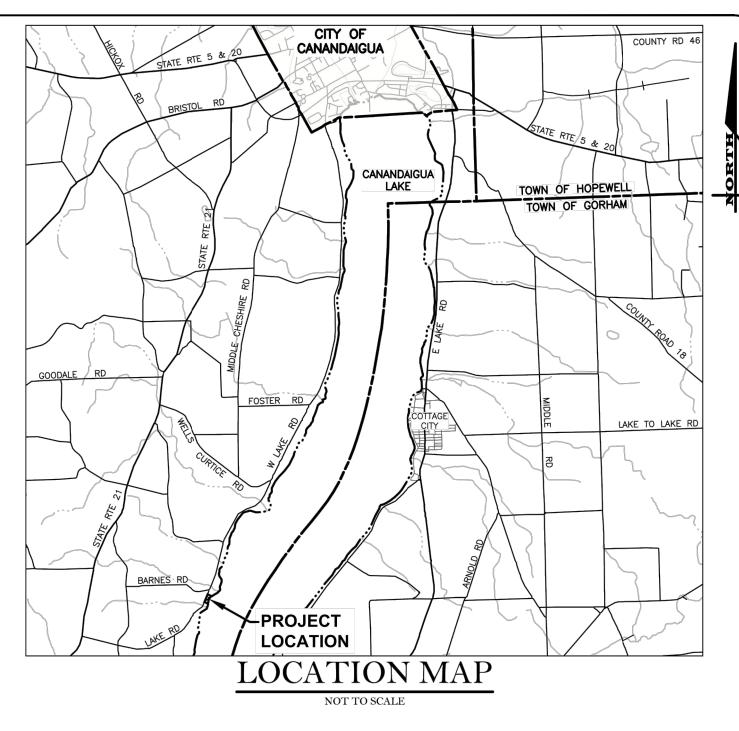
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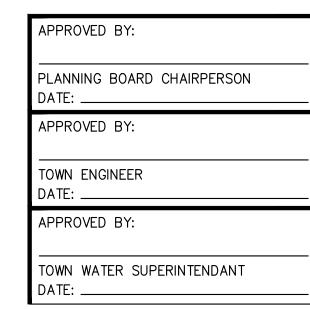
1. **ELECTRICAL SERVICE** - NEW ELECTRICAL SERVICE SHALL BE COORDINATED WITH RG&E.


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- 2. DOWNSPOUTS ALL DOWNSPOUTS FOR NEW HOME & GARAGE SHALL BE DIRECTED TO THE PROPOSED RAIN GARDENS.
- 3. PROPOSED LIGHTING ALL LIGHTING TO BE INSTALLED SHALL BE DARK SKY COMPLIANT AND SHALL MEET THE REQUIREMENTS OF SECTION 220-77 OF THE CANANDAIGUA TOWN CODE.







ENGINEERING

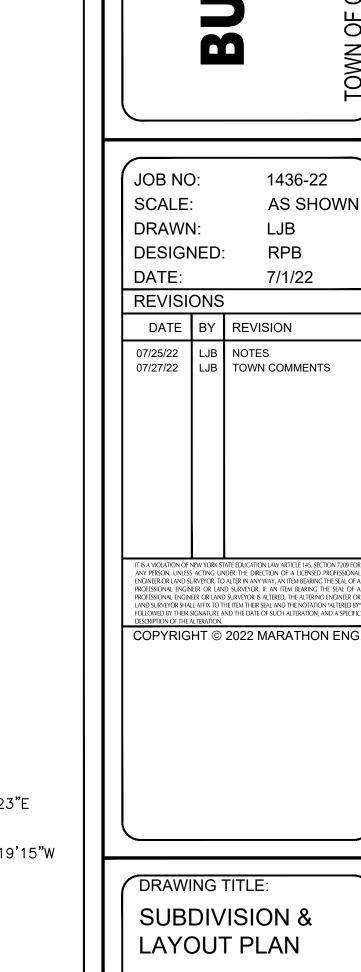ROCHESTER LOCATION

39 CASCADE DRIVE

ROCHESTER, NY 14614


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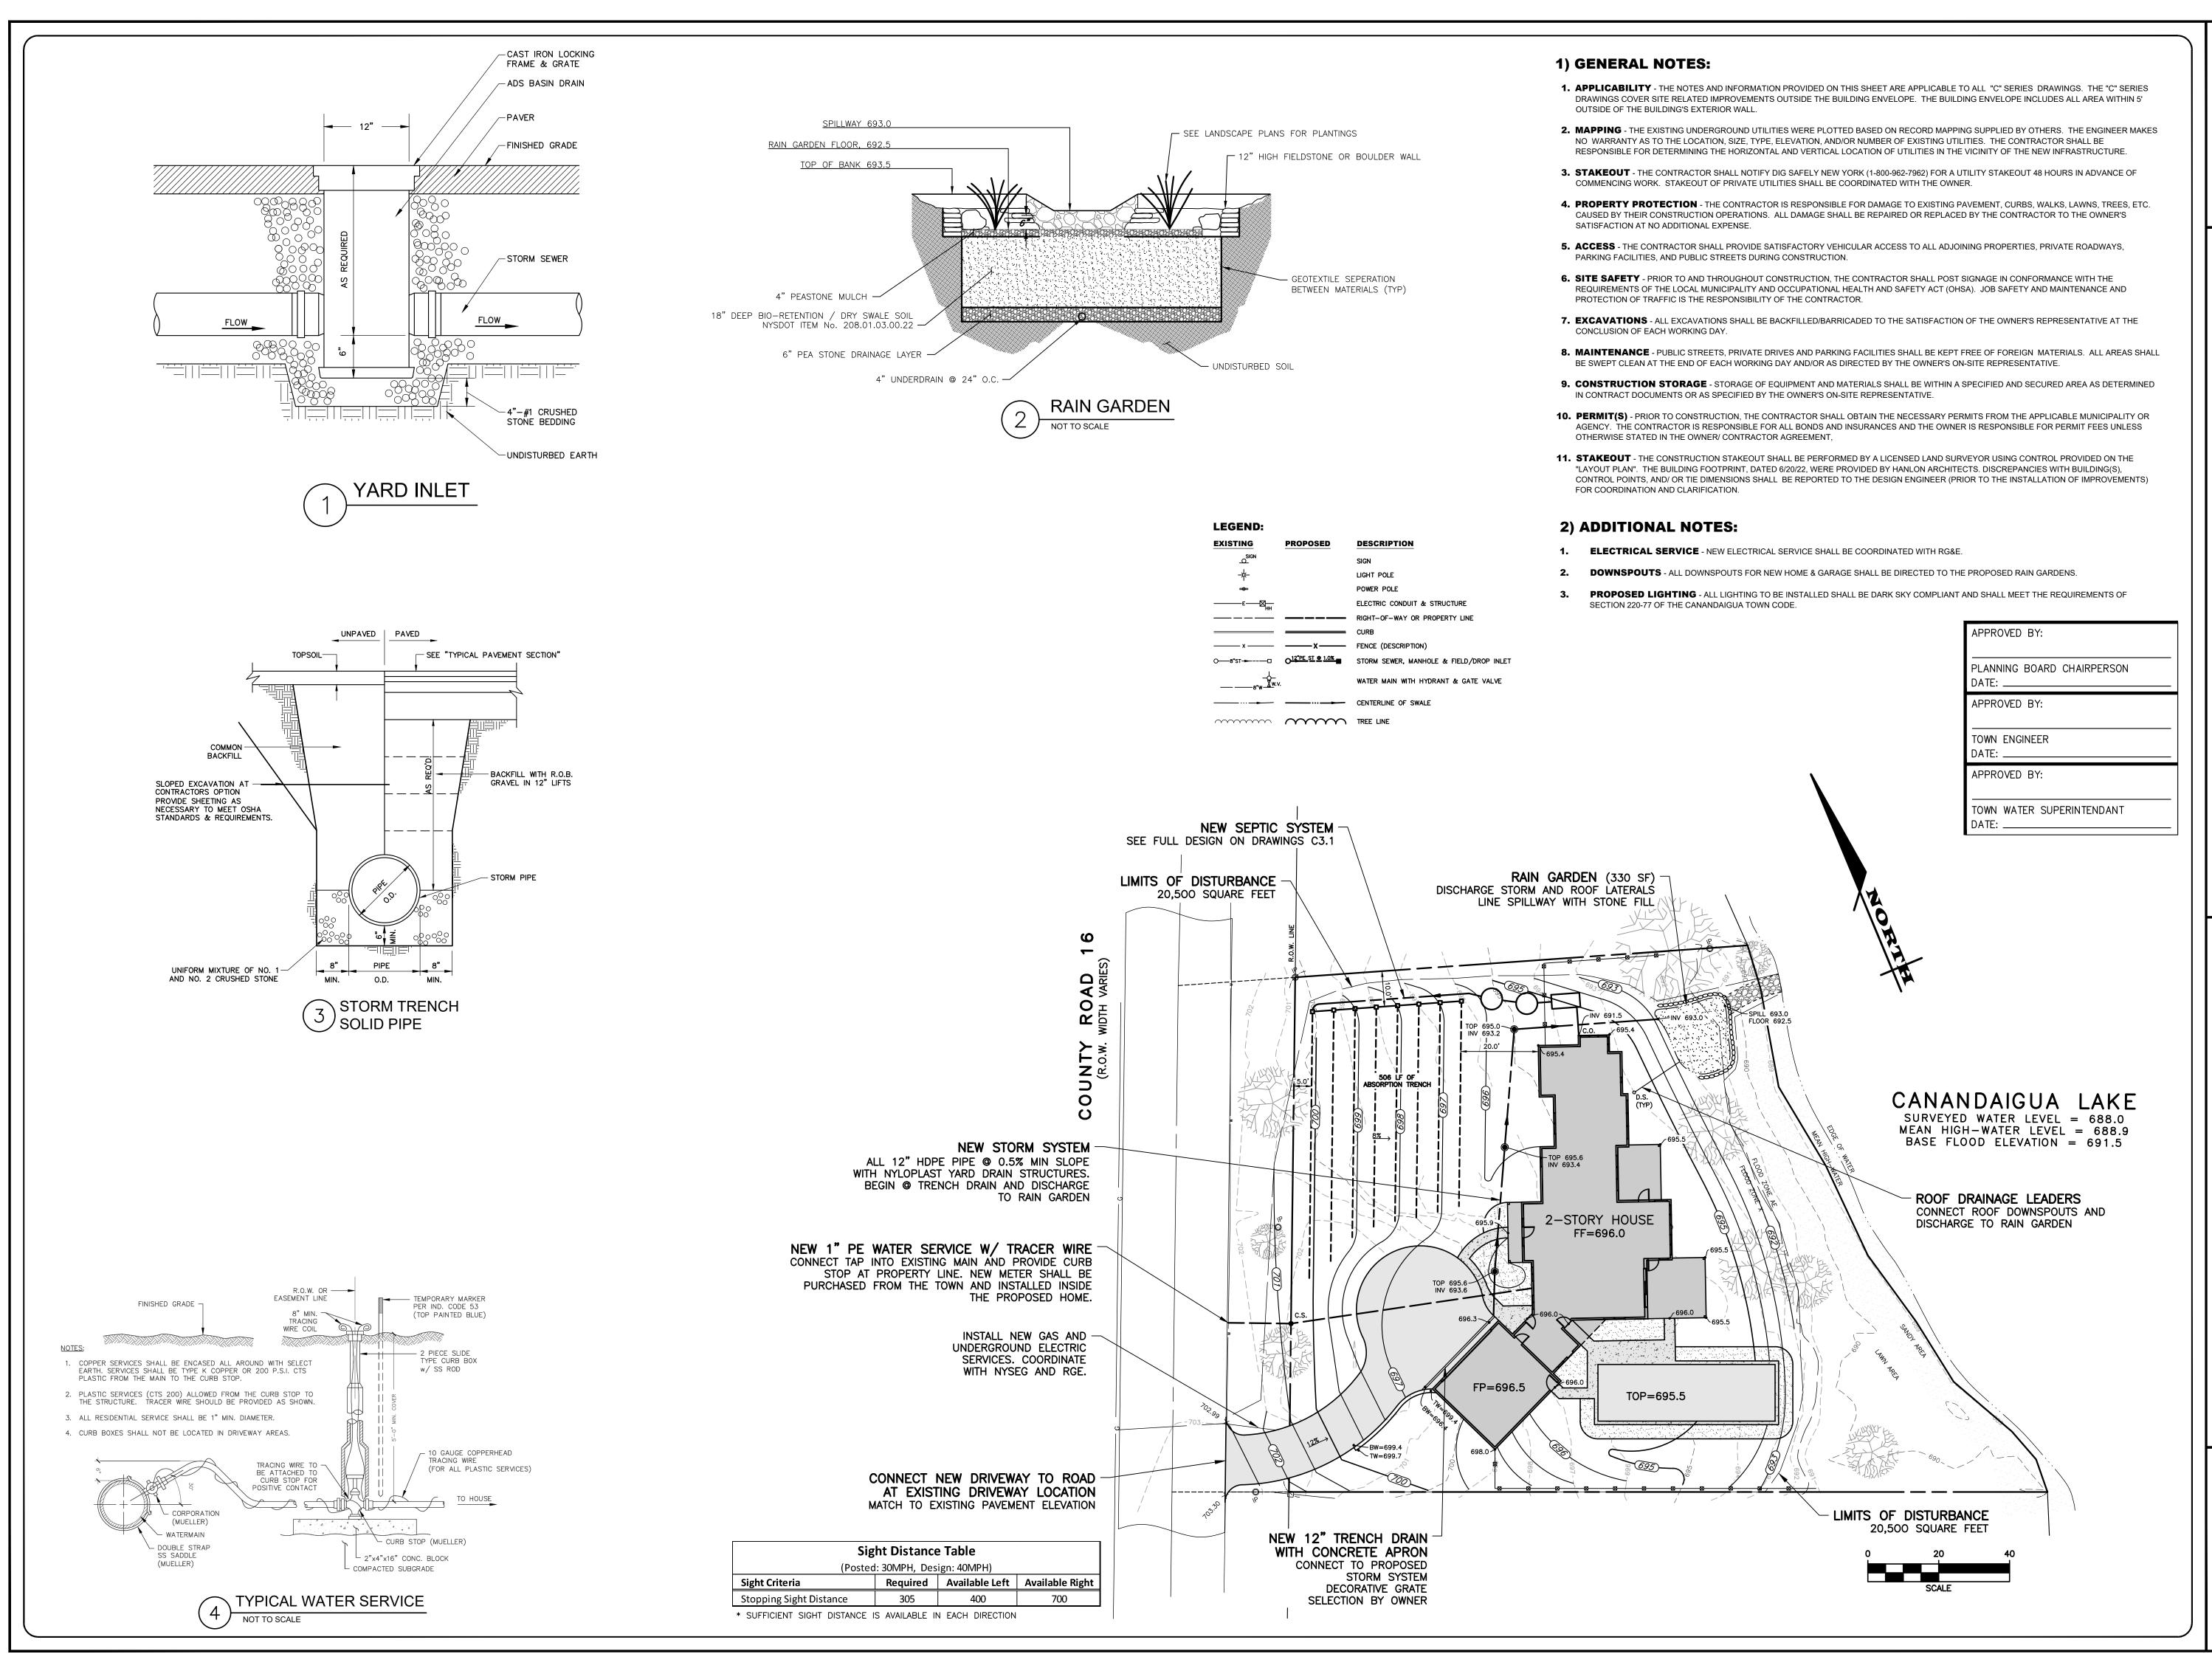


SUBDIVISION & SHEET No:

DRAWING No:

1436-22

JOB No:

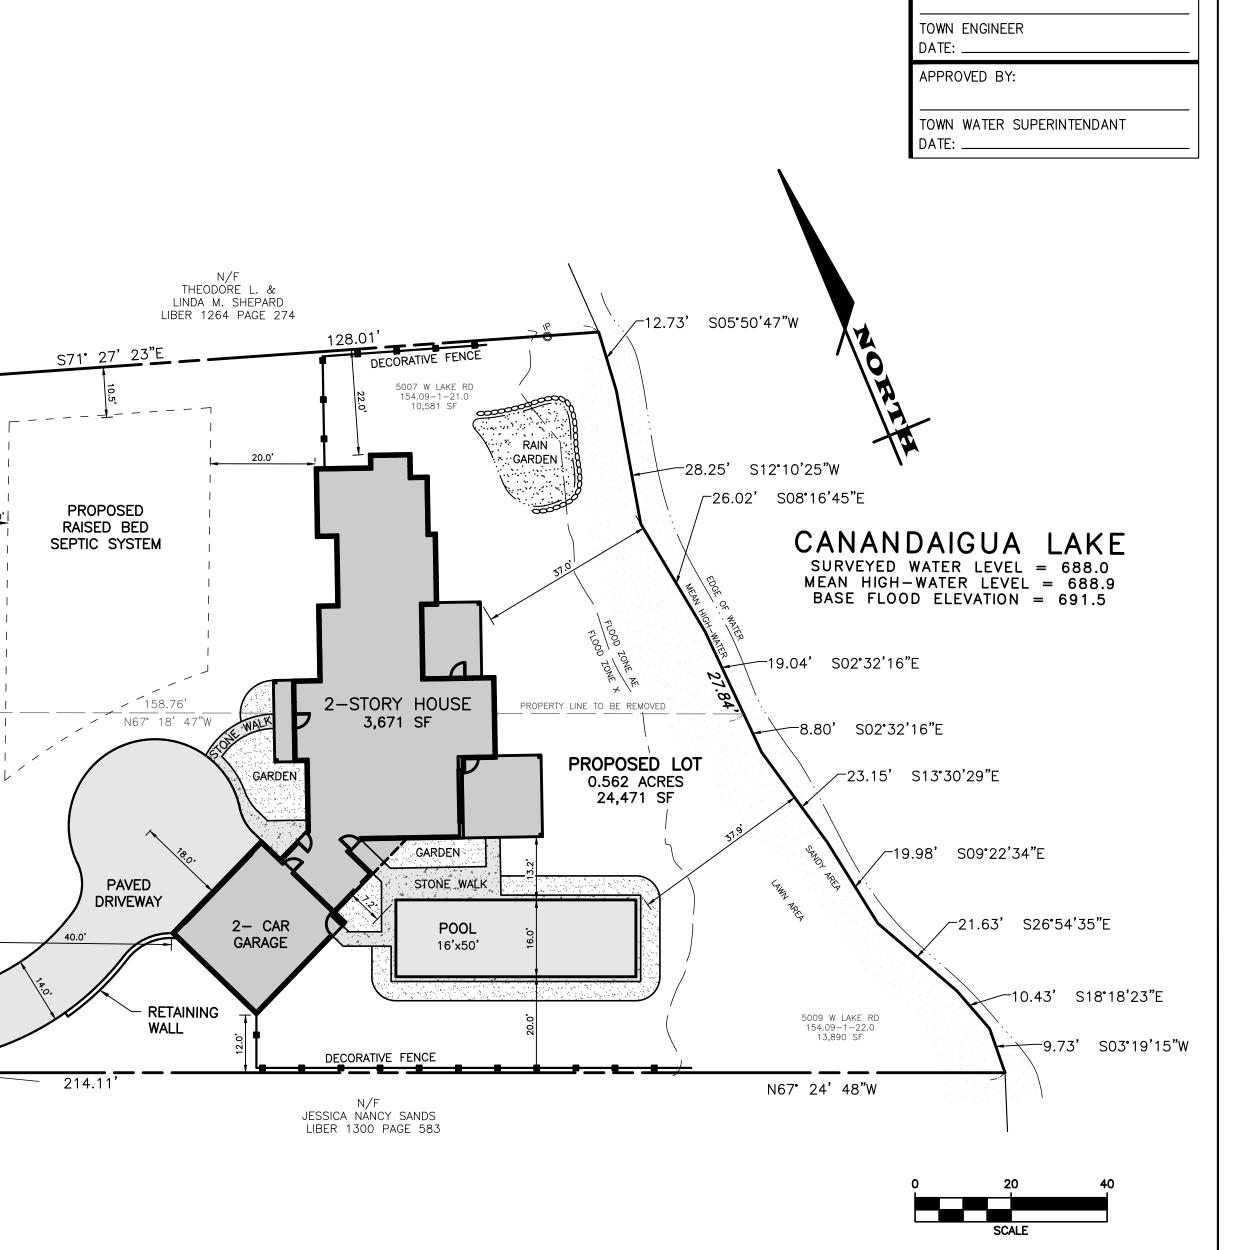

**ENGINEERING** ROCHESTER LOCATION


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DRAWING TITLE **GRADING & UTILITY PLAN** 

SHEET No: 1436-22 JOB No: DRAWING No:



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DRAWING TITLE: SEPTIC SYSTEM **DESIGN PLAN** 

SHEET No: 1436-22 JOB No: DRAWING No:

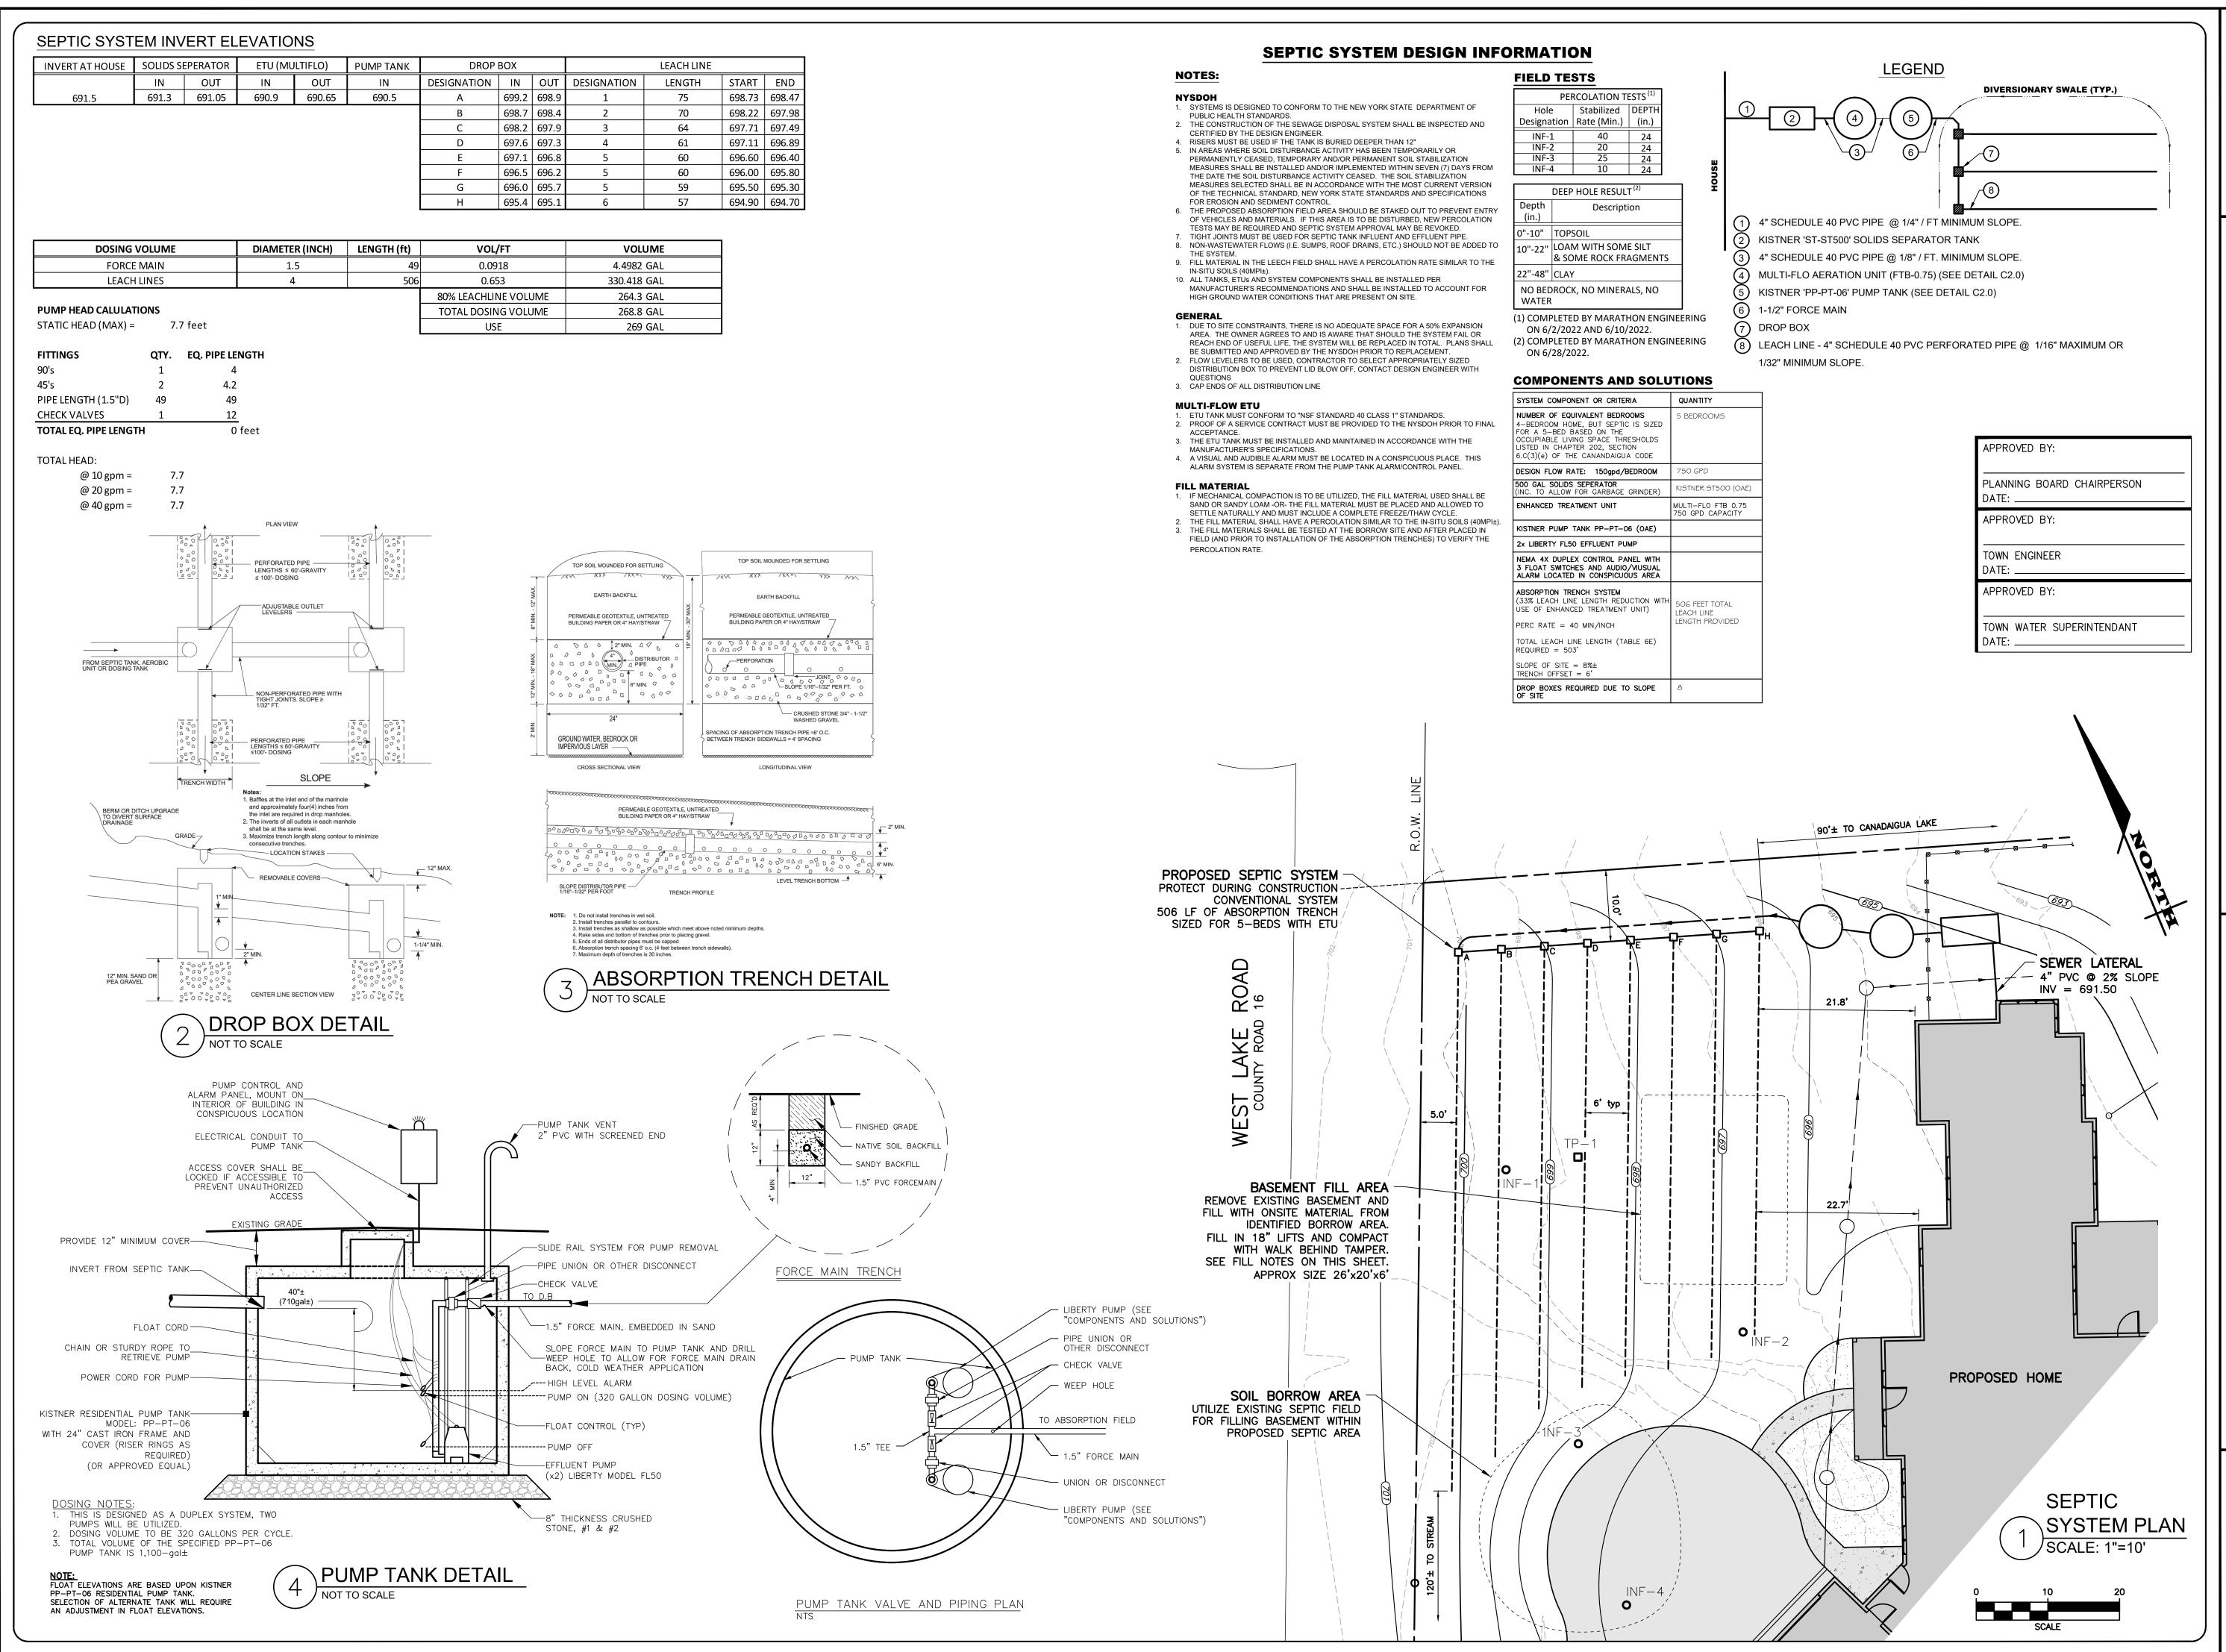
- SHALL BE CLEARED, GRUBBED AND STRIPPED OF ANY VEGETATION AND ROOT MAT. THE POOL AREA SHALL BE CLEARED. THE FILL MATERIAL FOR THE EMBANKMENT SHALL BE FREE OF ROOTS AND OTHER WOODY VEGETATION AS WELL AS OVER-SIZED STONES, ROCKS, ORGANIC MATERIAL OR OTHER OBJECTIONABLE MATERIAL. THE EMBANKMENT SHALL BE COMPACTED BY TRAVERSING WITH EQUIPMENT WHILE IT IS BEING CONSTRUCTED.
- THE STONE USED IN THE OUTLET SHALL BE SMALL RIPRAP 4"-8" ALONG WITH A 1' THICKNESS OF 2" AGGREGATE PLACED ON THE UP-GRADE SIDE ON THE SMALL RIPRAP OR EMBEDDED FILTER CLOTH IN THE RIPRAP SEDIMENT SHALL BE REMOVED AND TRAP RESTORED TO ITS ORIGINAL DIMENSIONS WHEN THE SEDIMENT HAS ACCUMULATED TO 1/2 THE DESIGN DEPTH OF THE TRAP. IT SHALL BE PLACED ON SITE AND STABILIZED.
- THE STRUCTURE SHALL BE INSPECTED AFTER EACH RAIN AND REPAIRS MADE AS NEEDED. CONSTRUCTION OPERATIONS SHALL BE CARRIED OUT IN SUCH A MANNER THAT EROSION AND SEDIMENT ARE CONTROLLED. THE STRUCTURE SHALL BE REMOVED AND THE AREA STABILIZED WHEN THE DRAINAGE AREA HAS BEEN PROPERLY STABILIZED.

#### MAXIMUM DRAINAGE AREA 5 ACRES

ALL CUT AND FILL SLOPES SHALL BE 2:1 OR FLATTER.

TEMPORARY SEDIMENT TRAP SIZING CALCULATION								
DRAINAGE AREA (AC)	TRAP AREA	DEPTH	REQUIRED VOLUME (C.F.)	PROVIDED VOLUME (C.F.)				
0.4	350 SF	4.0 FT. MIN.	1,400	1,400±				

# TEMPORARY SEDIMENTATION TRAP SCALE: N.T.S

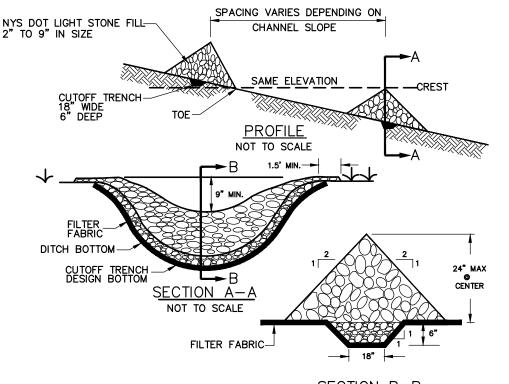

# CONSTRUCTION SPECIFICATIONS


LOCATION SHOWN ON IN THE PLAN

- . STONE WILL BE PLACED ON A FILTER FABRIC FOUNDATION TO THE LINES, GRADES AND
- 2. SET SPACING OF CHECK DAMS TO ASSUME THAT THE ELEVATIONS OF THE CREST OF THE DOWNSTREAM DAM IS AT THE SAME ELEVATION OF THE UPSTREAM DAM.
- 3. EXTEND THE STONE A MINIMUM OF 1.5 FEET BEYOND THE DITCH BANKS TO PREVENT CUTTING
- 4. PROTECT THE CHANNEL DOWNSTREAM OF THE LOWEST CHECK DAM FROM SCOUR AND EROSION WITH STONE OR LINER AS APPROPRIATE.
- 5. ENSURE THAT CHANNEL APPURTENANCES SUCH AS CULVERT ENTRANCES BELOW CHECK DAMS ARE NOT SUBJECT TO DAMAGE OF BLOCKAGE FROM DISPLACED STONES. MAXIMUM DRAINAGE AREA - 2 ACRES



WOVEN WIRE FENCE (MIN. 14 1/2

GAUGE W/ MAX. 6" MESH SPACING)

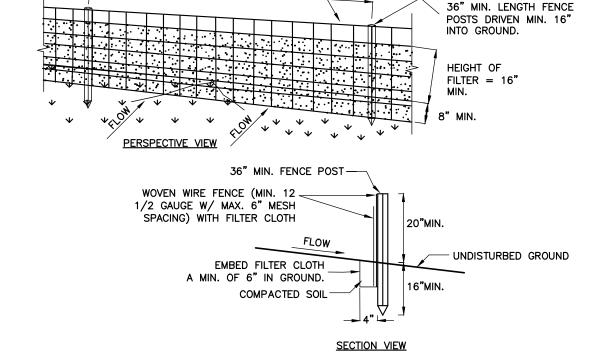


# **CONSTRUCTION SPECIFICATIONS**

DEVELOP IN THE SILT FENCE.

- 1. WOVEN WIRE FENCE TO BE FASTENED SECURELY TO FENCE POSTS WITH WIRE TIES OR STAPLES, POSTS SHALL BE STEEL "T" OF "U" TYPE OF HARDWOOD.
- 2. FILTER CLOTH TO BE FASTENED SECURELY TO WOVEN WIRE FENCE WITH TIES SPACED EVERY 24" AT TOP AND MID SECTION. FENCE SHALL BE WOVEN WIRE, 12 1/2 GAUGE, 6" MAXIMUM MESH
- 3. WHEN TWO SECTIONS OF FILTER CLOTH ADJOIN EACH OTHER THEY SHALL BE OVERLAPPED BY SIX INCHES AND FOLDED. FILTER CLOTH SHALL BE EITHER FILTER X, MIRAFI 100X, STABLINKKA T140N,
- 4. PREFABRICATED UNITS SHALL BE GEOFAB, ENVIROFENCE, OR APPROVED EQUIVALENT. 5. MAINTENANCE SHALL BE PERFORMED AS NEEDED AND MATERIAL REMOVED WHEN "BULGES"
- 6. ENVIRO-FENCE WITH INTEGRAL MESH IS ACCEPTABLE SUBSTITUTE.



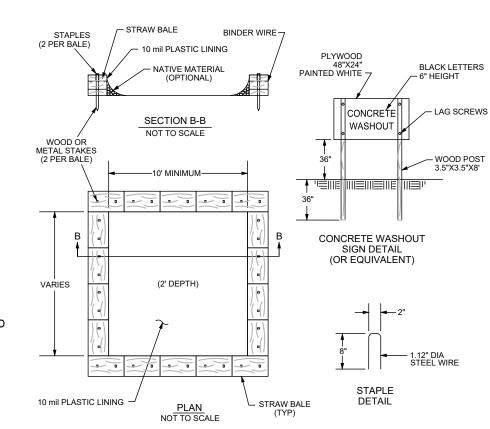

### TYPE "ABOVE GRADE" WITH STRAW BALES

# NOTES 1. ACTUAL LAYOUT TO BE DETERMINED IN THE FIELD. 2. A CONCRETE WASHOUT SIGN SHALL BE INSTALLED WITHIN 30' OF THE TEMPORARY CONCRETE WASHOUT 3. MATERIALS USED TO CONSTRUCT TEMPORARY CONCRETE WASHOUT FACILITIES SHALL BE REMOVED FROM THE SITE OF THE WORK AND DISPOSED OF OR RECYCLED. 4. HOLES, DEPRESSIONS OR OTHER GROUND DISTURBANCE CAUSED BY THE REMOVAL OF THE TEMPORARY CONCRETE WASHOUT FACILITIES SHALL BE BACKFILLED, REPAIRED, AND STABILIZED TO PREVENT EROSION. 5. WASHOUT SHALL BE EMPTIED AT OR BEFORE REACHING 75% CAPACITY, AND THE LINER SHALL BE REPLACED WHENEVER THE WASHOUT IS EMPTIED.

# CONCRETE WASHOUT SCALE: N.T.S

BURIED FABRIC

-GATHER EXCESS

1. FILTER FABRIC SHALL HAVE AN EOS OF 40-85. BURLAP MAY BE USED FOR SHORT TERM APPLICATIONS.

3. STAKE MATERIALS WILL BE STANDARD 2" x 4" WOOD OR EQUIVALENT METAL WITH A MINIMUM

FABRIC SHALL BE EMBEDDED 1 FOOT MINIMUM BELOW GROUND AND BACKFILLED. IT SHALL

6. A 2" x 4" WOOD FRAME SHALL BE COMPLETED AROUND THE CREST OF THE FABRIC FOR OVER

DROP INLET PROTECTION

4. SPACE STAKES EVENLY AROUND INLET 3 FEET APART AND DRIVE A MINIMUM OF 18 INCHES DEEP. SPANS GREATER THAN 3 FEET MAY BE BRIDGED WITH THE USE OF WIRE MESH BEHIND THE FILTER FABRIC FOR SUPPORT.


2. CUT FABRIC FROM A CONTINUOUS ROLL TO ELIMINATE JOINTS. IF JOINTS ARE

NEEDED THEY WILL BE OVERLAPPED TO THE NEXT STAKE.


BE SECURELY FASTENED TO THE STAKES AND FRAME.

SCALE: N.T.S

CONSTRUCTION SPECIFICATIONS

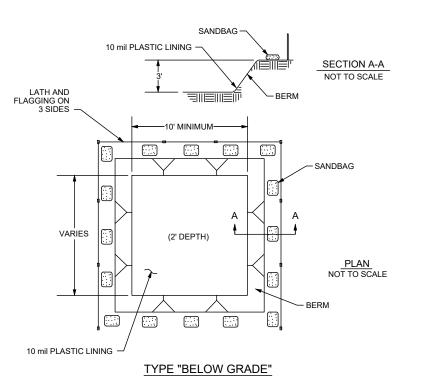

- 10 mil PLASTIC LINING

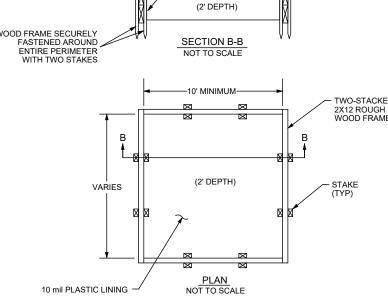

#### **EROSION CONTROL NOTES**


- 1. INSPECTION EROSION CONTROL (EC) MEASURES INSTALLED AND MAINTAINED BY THE SITE WORK CONTRACTOR ARE SUBJECT TO THE REVIEW AND APPROVAL OF THE: MUNICIPALITY, DESIGN ENGINEER, AND OWNER'S REPRESENTATIVE. IMMEDIATE ACTION BY THE CONTRACTOR SHALL BE TAKEN IF ADDITIONAL OR CORRECTIVE MEASURES ARE REQUIRED BY ANY ONE OF THESE CITED REVIEWERS. EROSION CONTROL MEASURES NOT SPECIFICALLY SHOWN ON CONTRACT DRAWINGS (I.E., STRAW BALES, COLLARS, FABRICS, ETC.) SHALL BE INSTALLED AS WARRANTED BY FIELD CONDITIONS, AND AS DIRECTED BY THE AFOREMENTIONED REVIEWERS.
- 2. **PRE-CONSTRUCTION** THE APPROPRIATE EROSION CONTROL MEASURES AS DEFINED BY THE CONSTRUCTION DOCUMENTS SHALL BE INSTALLED PRIOR TO THE START OF ANY CONSTRUCTION ACTIVITIES.
- 3. TOPSOIL UPON COMPLETION OF THE STOCKPILE STRIPPING OPERATION, STOCKPILES SHALL BE STABILIZED IN ACCORDANCE TO NYSDEC REGULATIONS.
- 4. SLOPES UPON COMPLETION OF GRADING. SLOPES WITH A GRADIENT OF ONE FOOT VERTICAL TO THREE FEET HORIZONTAL (1 ON 3) OR GREATER SHALL BE: TOPSOILED, SEEDED, FERTILIZED AND MULCHED OR TREATED AS SPECIFIED ON CONTRACT
- 5. **DUST** THE CONTRACTOR SHALL APPLY WATER AND/OR CALCIUM CHLORIDE, AS CONDITIONS WARRANT, TO CONTROL WIND BORN EROSION. THIS MEASURE APPLIES TO: HAUL ROADS, CUT AND FILL OPERATIONS, SUB-BASE AND ANY OTHER EXPOSED SURFACES.
- 6. OPERATION & MAINTENANCE THROUGHOUT THE PERIOD OF CONSTRUCTION AND PRIOR TO ESTABLISHING FINAL GROUND COVER THE SITE CONTRACTOR IS RESPONSIBLE FOR THE OPERATION AND MAINTENANCE OF THE TEMPORARY EROSION CONTROL MEASURES. FOR EXAMPLE, THE SILTATION FACILITIES SHALL BE RE-EXCAVATED WHEN THE VOLUME (3600 CUBIC FEET/DISTURBED ACRE) IS REDUCED BY ONE-HALF OR MORE OF ITS SPECIFIED CAPACITY AND/OR THE MATERIAL IS WITHIN ONE FOOT OF THE DISCHARGE POINT.
- 7. WORK STOPPAGE ALL DISTURBED AREAS NOT TO BE WORKED WITHIN 14 DAYS MUST BE SEEDED WITHIN 7 DAYS FROM THE LAST CONSTRUCTION ACTIVITY IN THAT
- 8. TEMPORARY STABILIZATION TEMPORARY STABILIZATION SHALL REQUIRE 4 TONS OF STRAW/ ACRE OF DISTURBANCE PLACED WITH TACKIFIER OR ROLLED WITH A TRACKED VEHICLE TO ENSURE NOT DISPLACED.


#### **9. WINTER STABILIZATION** - ALL WINTER STABILIZATION METHODS IDENTIFIED IN THE NYS 'BLUE BOOK' SHALL BE FOLLOWED FOR ANY DISTURBANCE OR NON-STABILIZED AREAS FROM NOVEMBER 15TH - APRIL 1ST.

- **10. SUBSOIL RESTORATION** ALL AREAS TO BE RESTORED AS LAWN SHALL BE RESTORED PER CHAPTER 5 (5.1.6) OF THE NEW YORK STATE STORMWATER DESIGN MANUAL AND THE SOIL RESTORATION TABLE (TABLE 5.3 - SOIL RESTORATION REQUIREMENTS) SHOWN ON THE PLANS. THE PROJECT SOILS ARE HYDROLOGIC SOIL GROUP B AND SHALL BE RESTORED AS SPECIFIED.
- 11. SEQUENCE THE CONTRACTOR SHALL INSTALL EROSION CONTROL MEASURES IN THE FOLLOWING SEQUENCE UNLESS AUTHORIZED OTHERWISE AT PRE-CONSTRUCTION
  - INSTALL PERIMETER SEDIMENT CONTROLS, I.E. EROSION FENCING.
  - INSTALL STABILIZED CONSTRUCTION ENTRANCE.
  - PROTECT VEGETATION TO REMAIN. CLEAR/GRUB AND CONSTRUCT DIVERSIONARY SWALES, AND SEDIMENT BASINS.
  - COMPLETE CLEARING AND GRUBBING OPERATION. • PLACE EROSION CONTROL MEASURES AT TOPSOIL STOCKPILES AND STRIP


  - CONSTRUCT SWALES AND SILTATION DEVICES AS EARTHWORK OPERATIONS PROGRESS.
  - MAINTAIN EROSION CONTROL MEASURES AND PLACE ADDITIONAL MEASURES AS


  - EARTHWORK AND UNDERGROUND UTILITIES ARE CONSTRUCTED. • ROUGH GRADE RAIN GARDEN AREAS AS TEMPORARY SEDIMENT TRAPS.
  - RESTORE AREAS AS DEFINED BY CONTRACT DOCUMENTS. • AFTER SITE IS SUBSTANTIALLY RESTORED, INSTALL RAIN GARDEN AREAS.
  - REMOVE EROSION CONTROL MEASURES AS AREAS ARE REESTABLISHED WITH GROUND COVER.

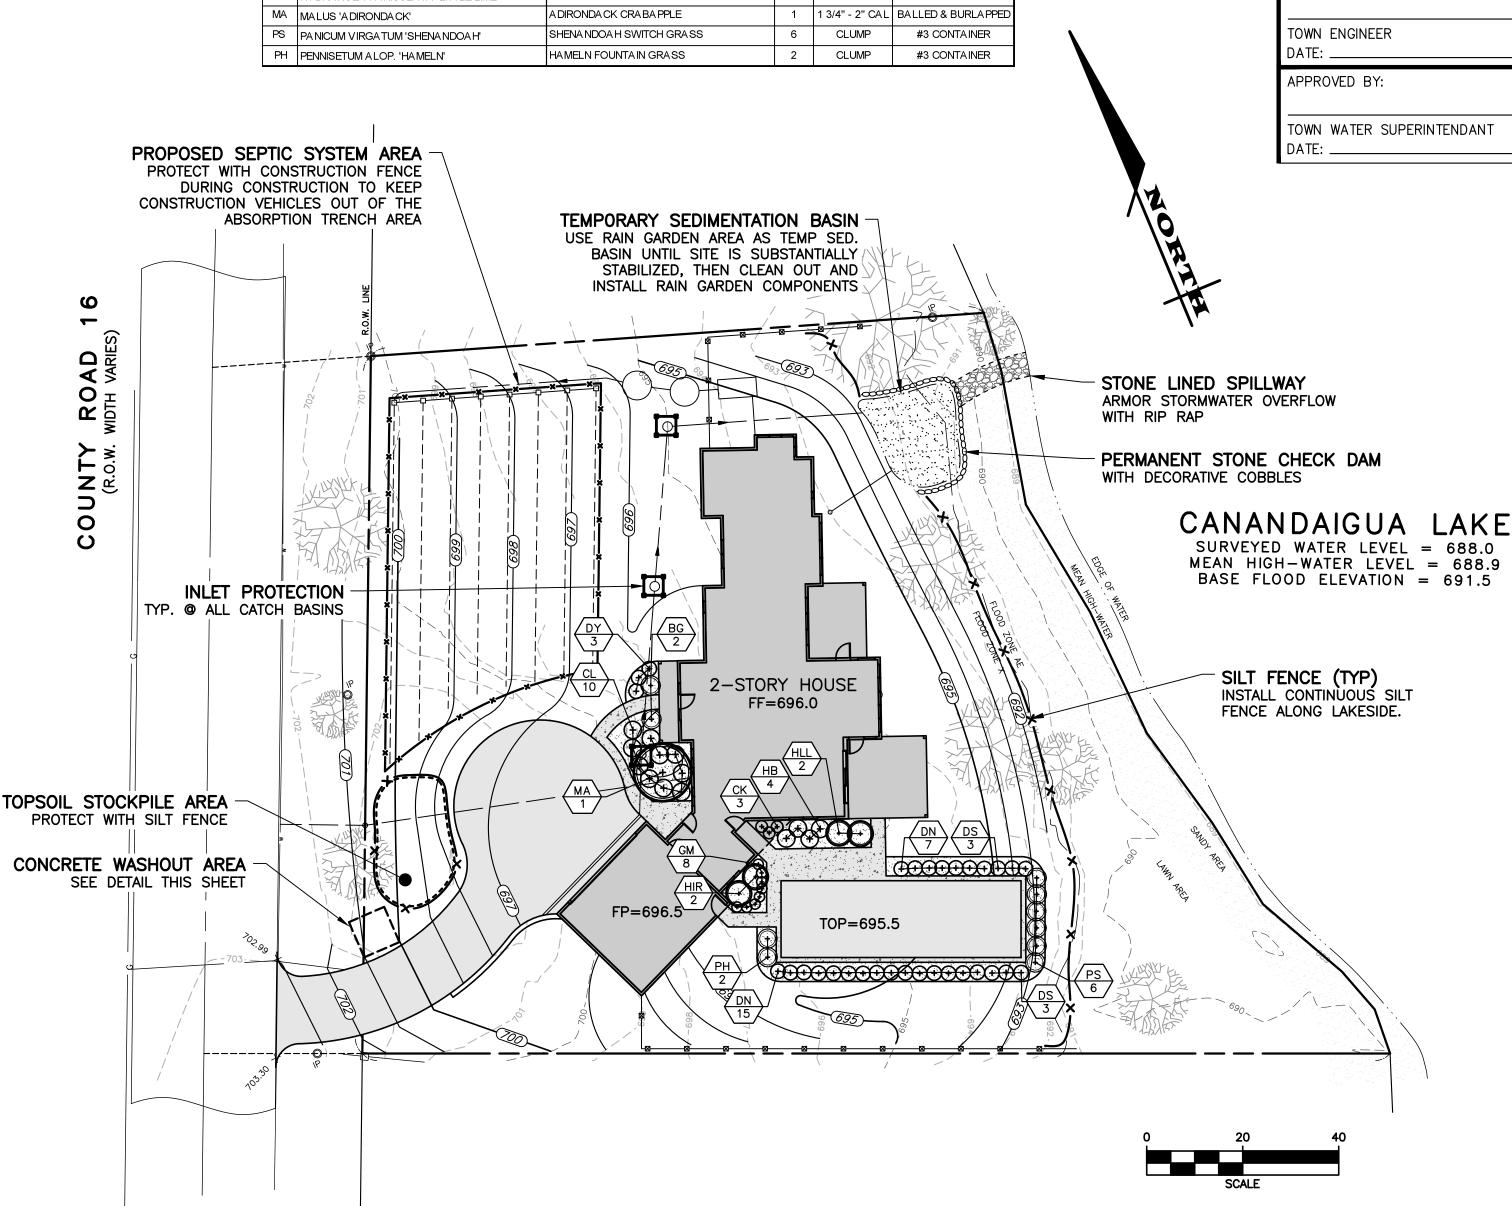

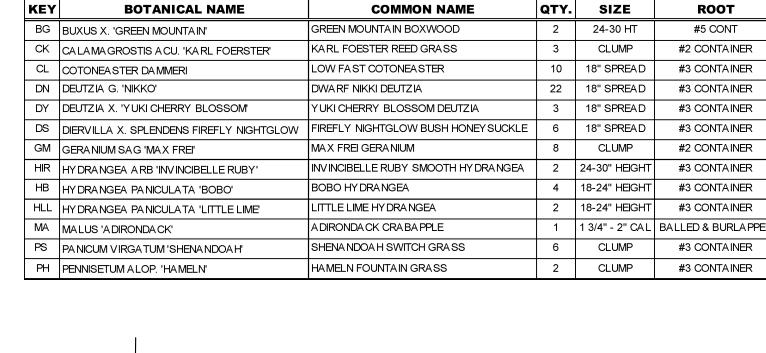

PRELIMINARY LANDSCAPING SCHEDULE

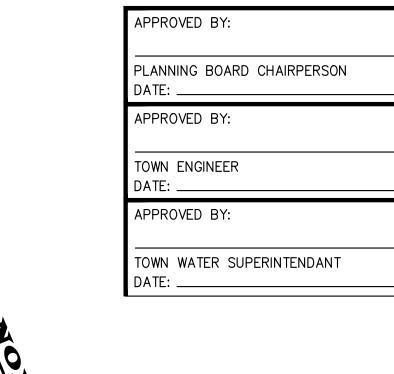

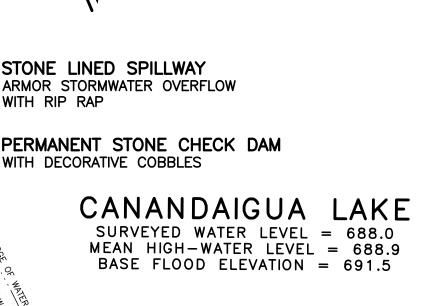

NY PERSON, UNLESS ACTING UNDER THE DIRECTION OF A LICENSED PROFE ESSIONAL ENGINEER OR LAND SURVEYOR, IF AN ITEM BEARING THE SEAL OF LLOWED BY THEIR SIGNATURE AND THE DATE OF SUCH ALTERATION, AND A SPE COPYRIGHT © 2022 MARATHON ENG.

1436-22

7/1/22

**AS SHOWN** 

JOB NO: SCALE:

DRAWN:

DATE:

**DESIGNED:** 

REVISIONS

DATE BY REVISION

DRAWING TITLE: **EROSION CONTROL** & LANDSCAPING PLAN

NO. 066924

ROBERT P. BRINGLEY

SHEET No: 1436-22 JOB No: DRAWING No:



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OAD

WIRE TIES, (TYP.) STORM GRATE-SILT SOCK-CATCH **DRAIN INLET SECTION** DRAIN INLET PLAN PAVED SURFACE INLET PROTECTION SCALE: N.T.S -2"x 4" WOOD