DEVELOPMENT PLANS FOR UTILITY PLANT ADDITION

AKOUSTIS TECHNOLOGIES 5450 CAMPUS DRIVE CANANDAIGUA, COUNTY OF ONTARIO STATE OF NEW YORK



LOCATION MAP

1" = 1000'



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☐ Call Before You Dig **☐** Wait The Required Time

☐ Confirm Utility Response ☐ Respect the Marks

☐ Dig With Care

PLANNING BOARD CANANDAIGUA PLANNING BOARD APPROVED	
CHAIRMAN	DATE
TOWN ENGINEER	DATE

UTILITY PLANT ADDITION

5450 CAMPUS DRIVE CANANDAIGUA, NY 14424

AKOUSTIS TECHNOLOGIES

5450 CAMPUS DRIVE CANANDAIGUA, NY 14424




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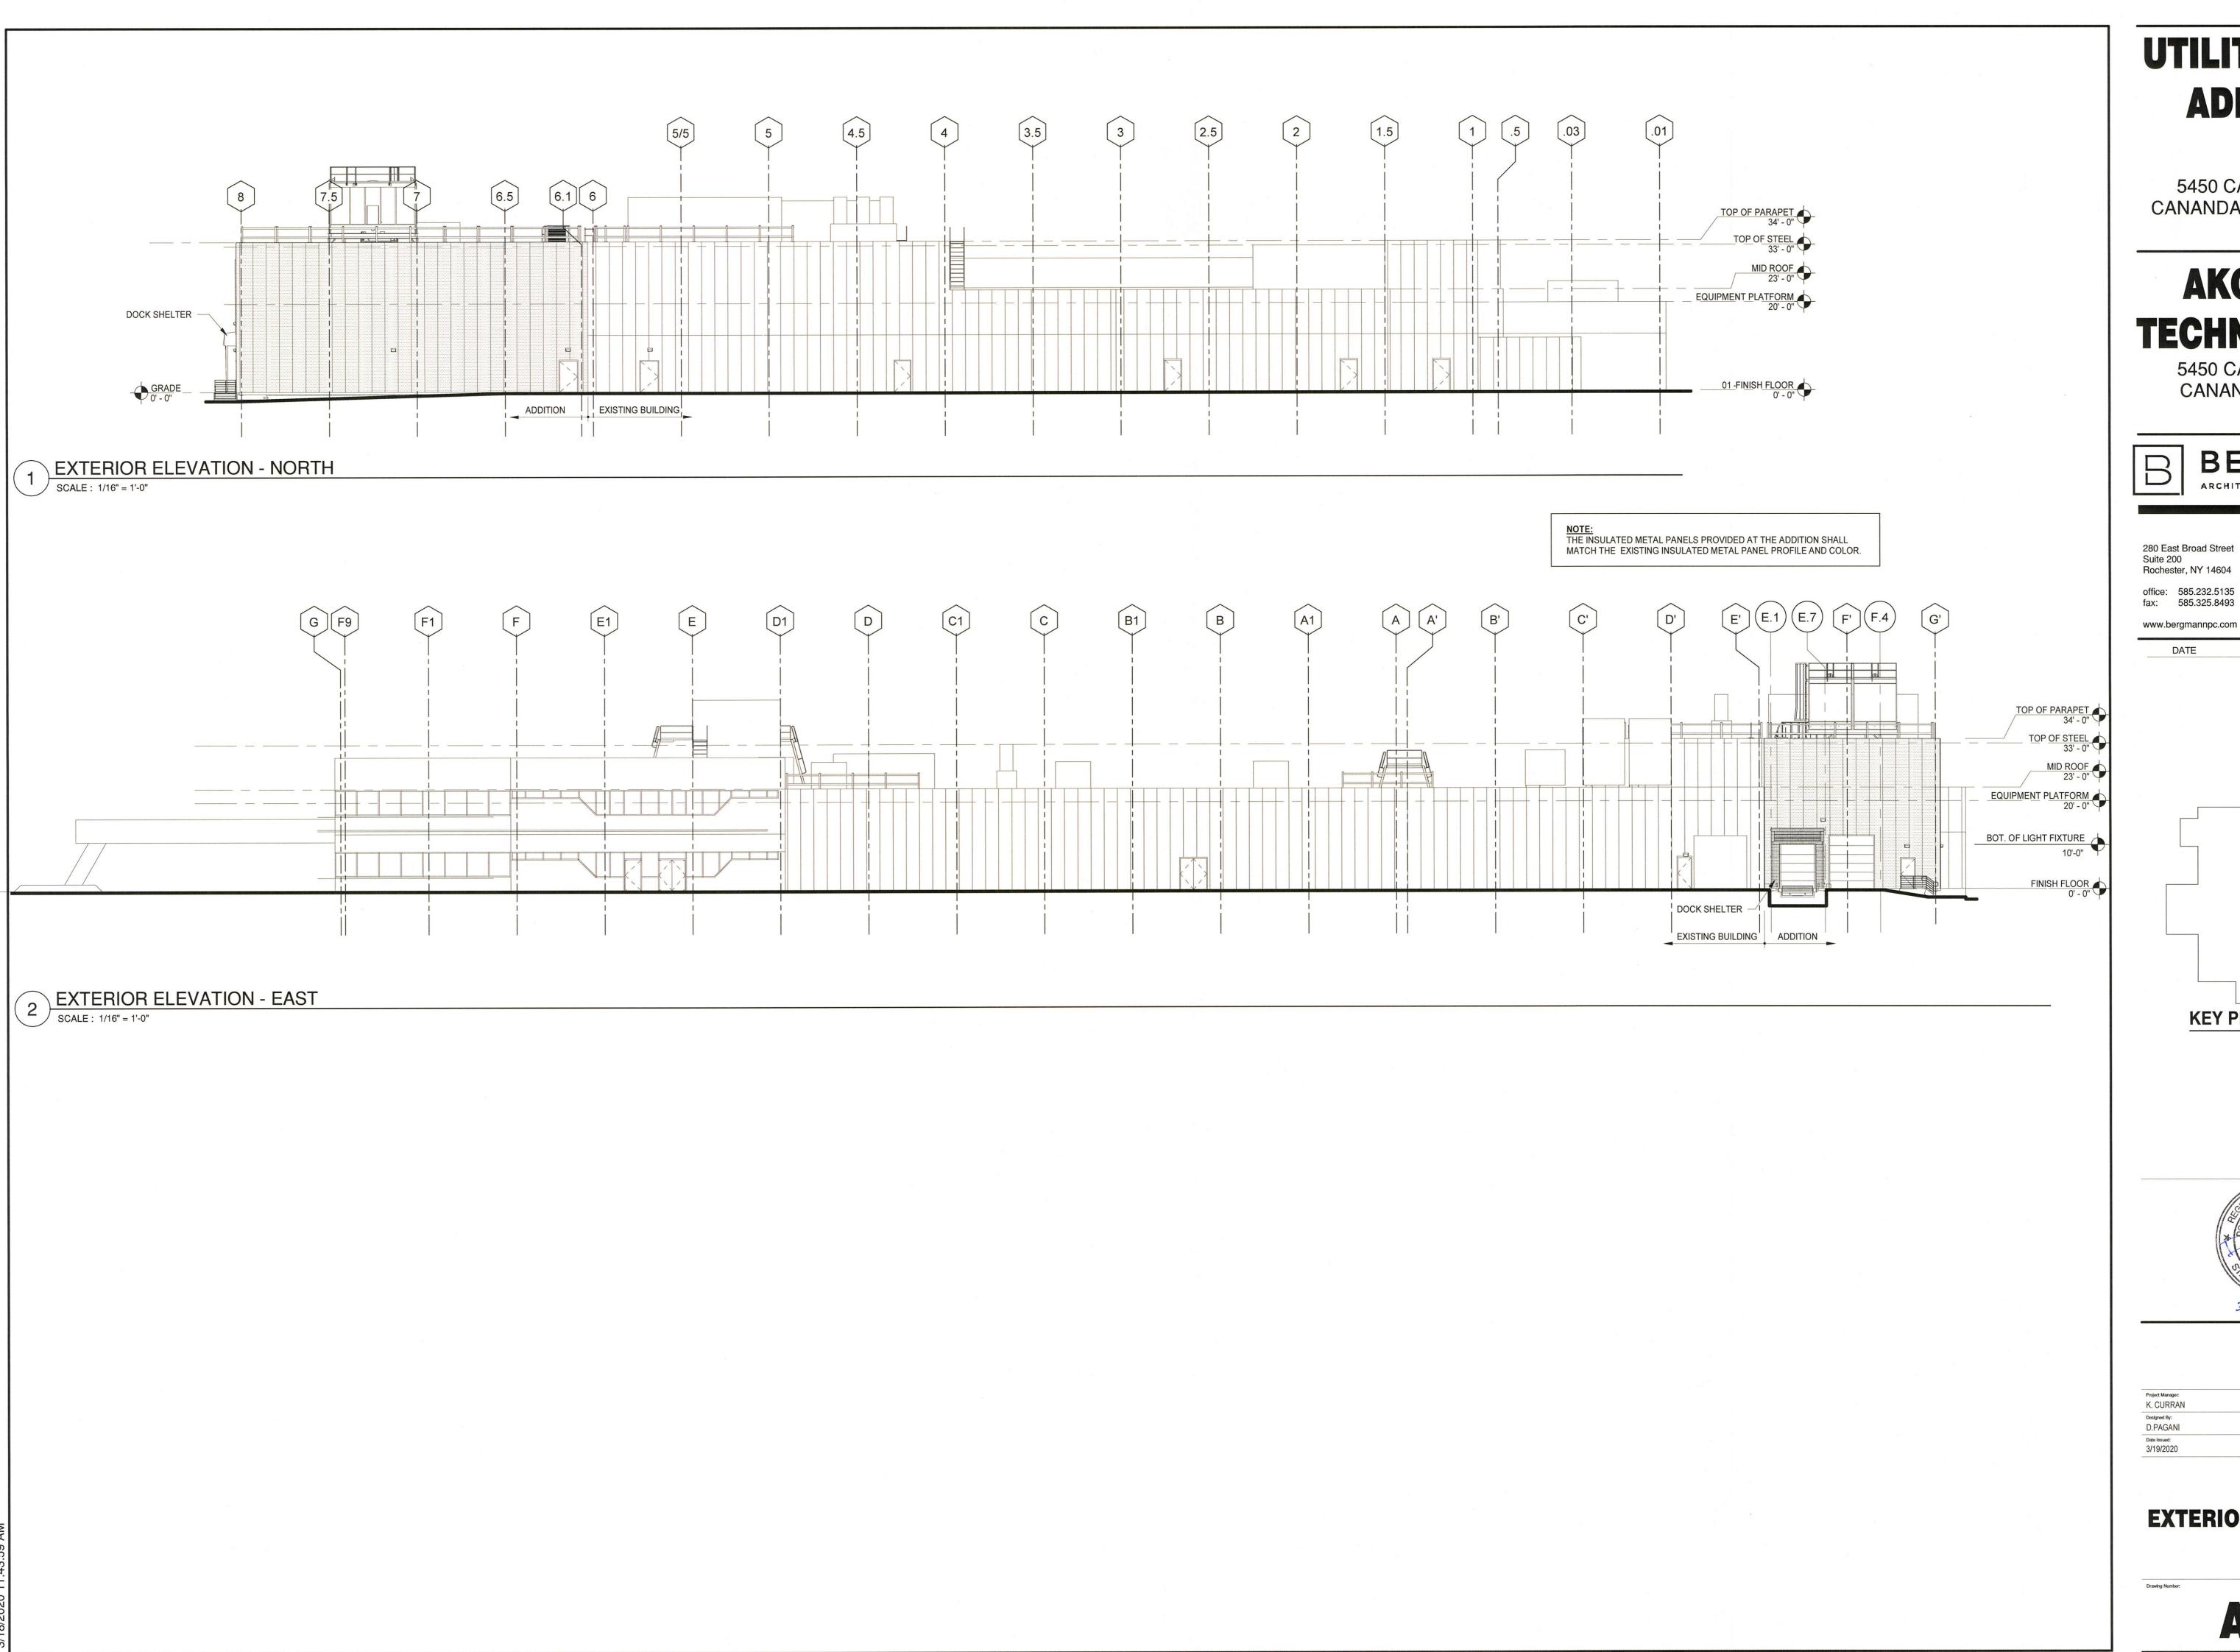
DESCRIPTION ADDENDUM #1



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Designed By: P. HOLSBERGER, EIT	Drawn By: P. HOLSBERGER, EIT
Date Issued: 3/20/2020	Project Number: 14208.01

COVER SHEET

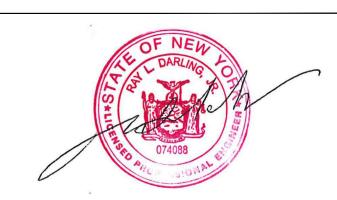

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DESCRIPTION



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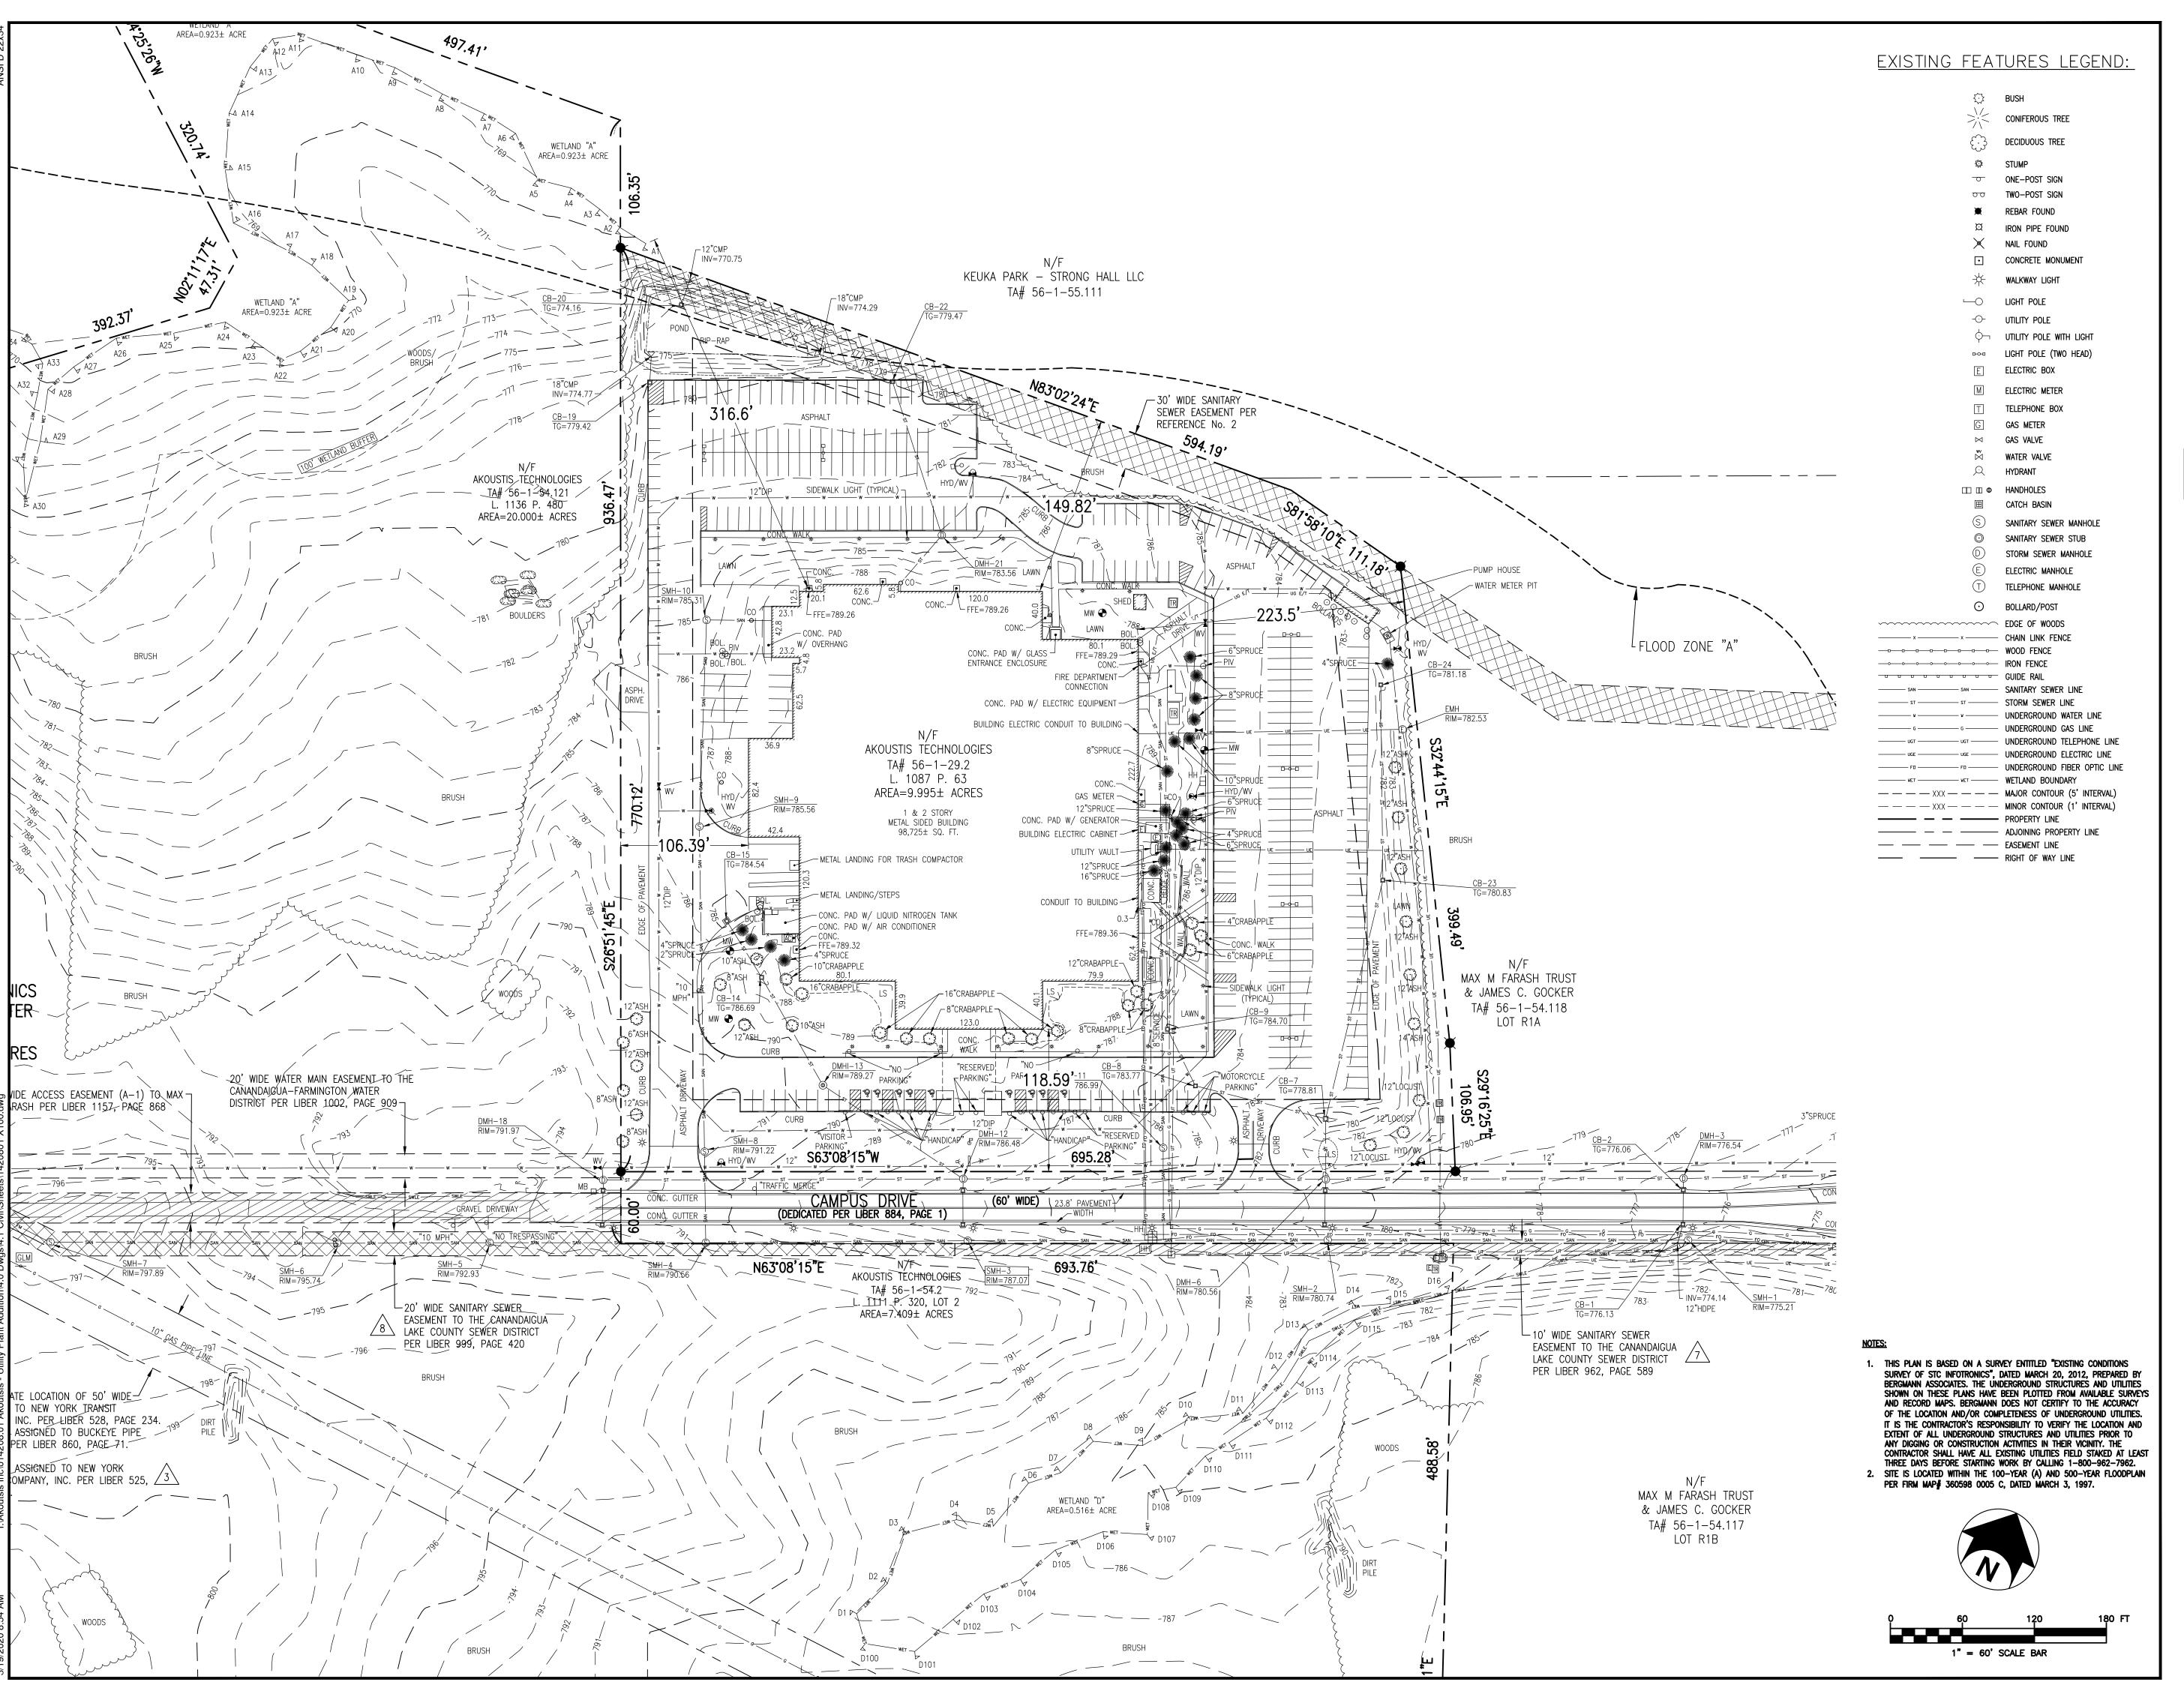
KEY PLAN



Project Manager:	Checked By:	
K. CURRAN	D.PAGANI	
Designed By:	Drawn By:	
D.PAGANI	M. TINGLEY	
Date Issued:	Project Number:	
3/19/2020	014208.01	

EXTERIOR ELEVATIONS

A201



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3/19/2020

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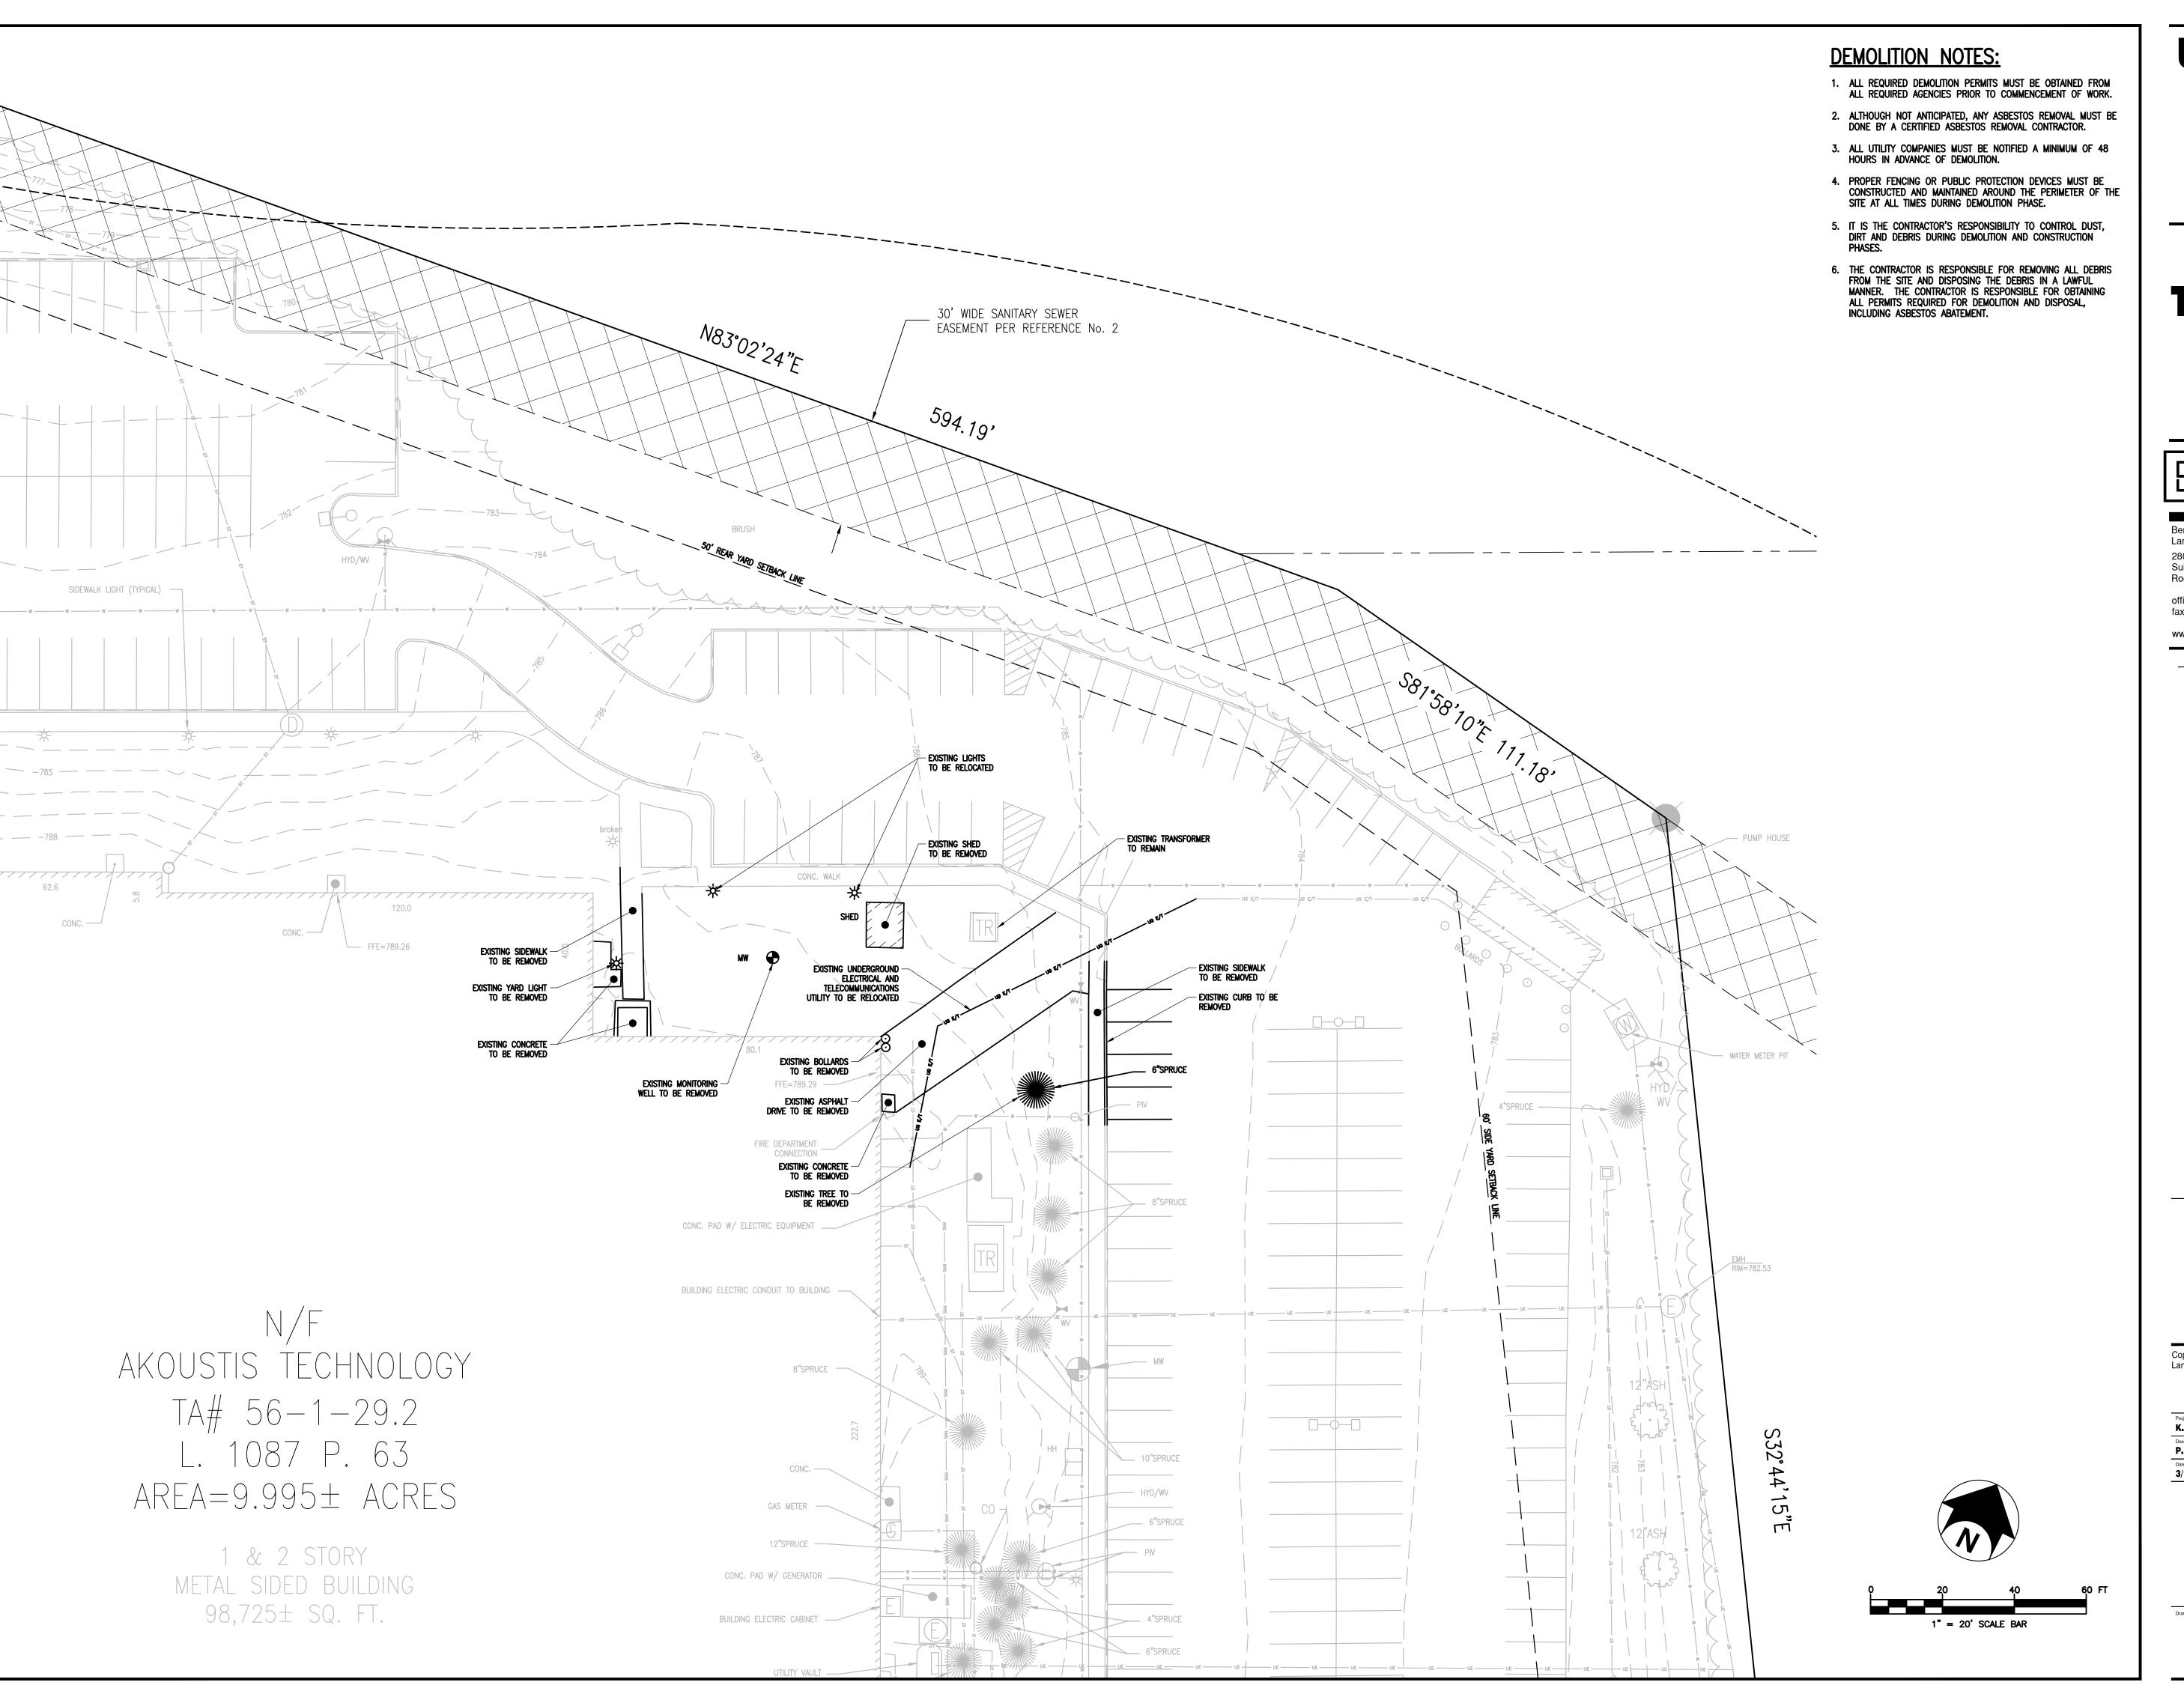
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Project Number:
14208.01

EXISTING CONDITIONS PLAN

X100

3 of **10**



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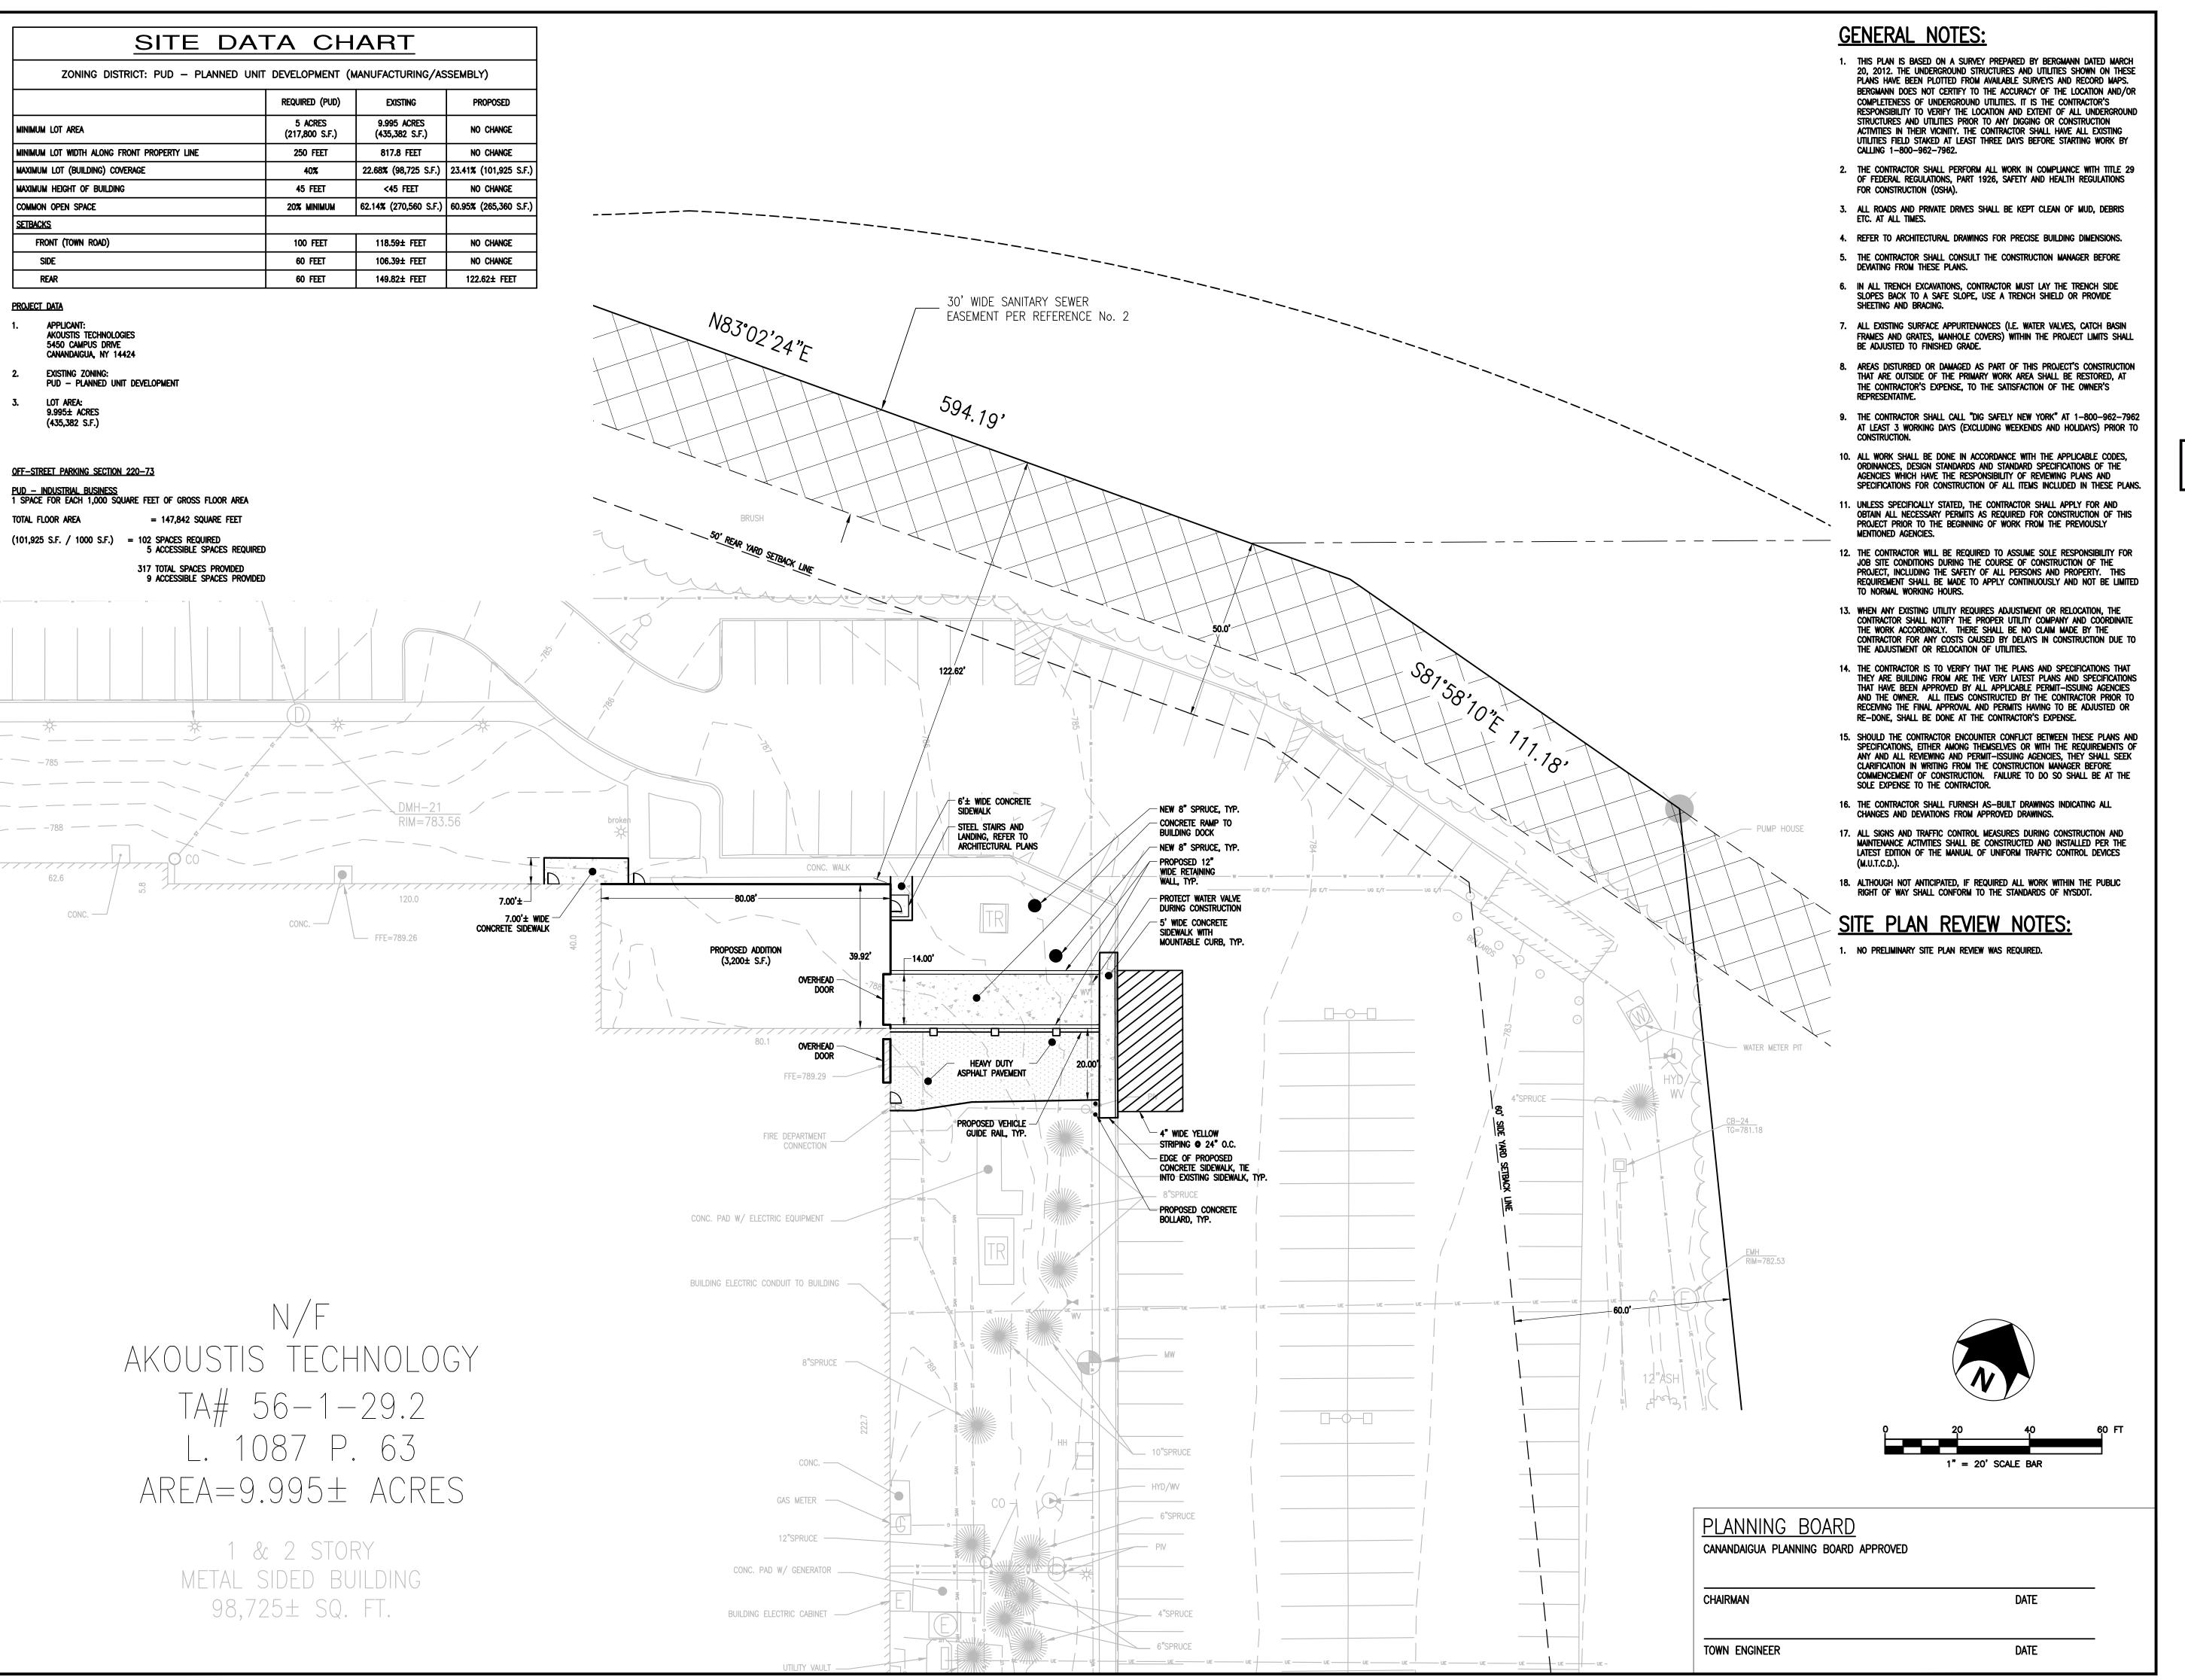


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P. HOLSBERGER, EIT	P. HOLSBERGER, EIT
Date Issued:	Project Number:
3/19/2020	14208.01

DEMOLITION PLAN

C080



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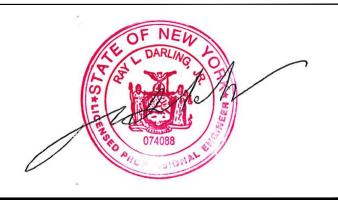
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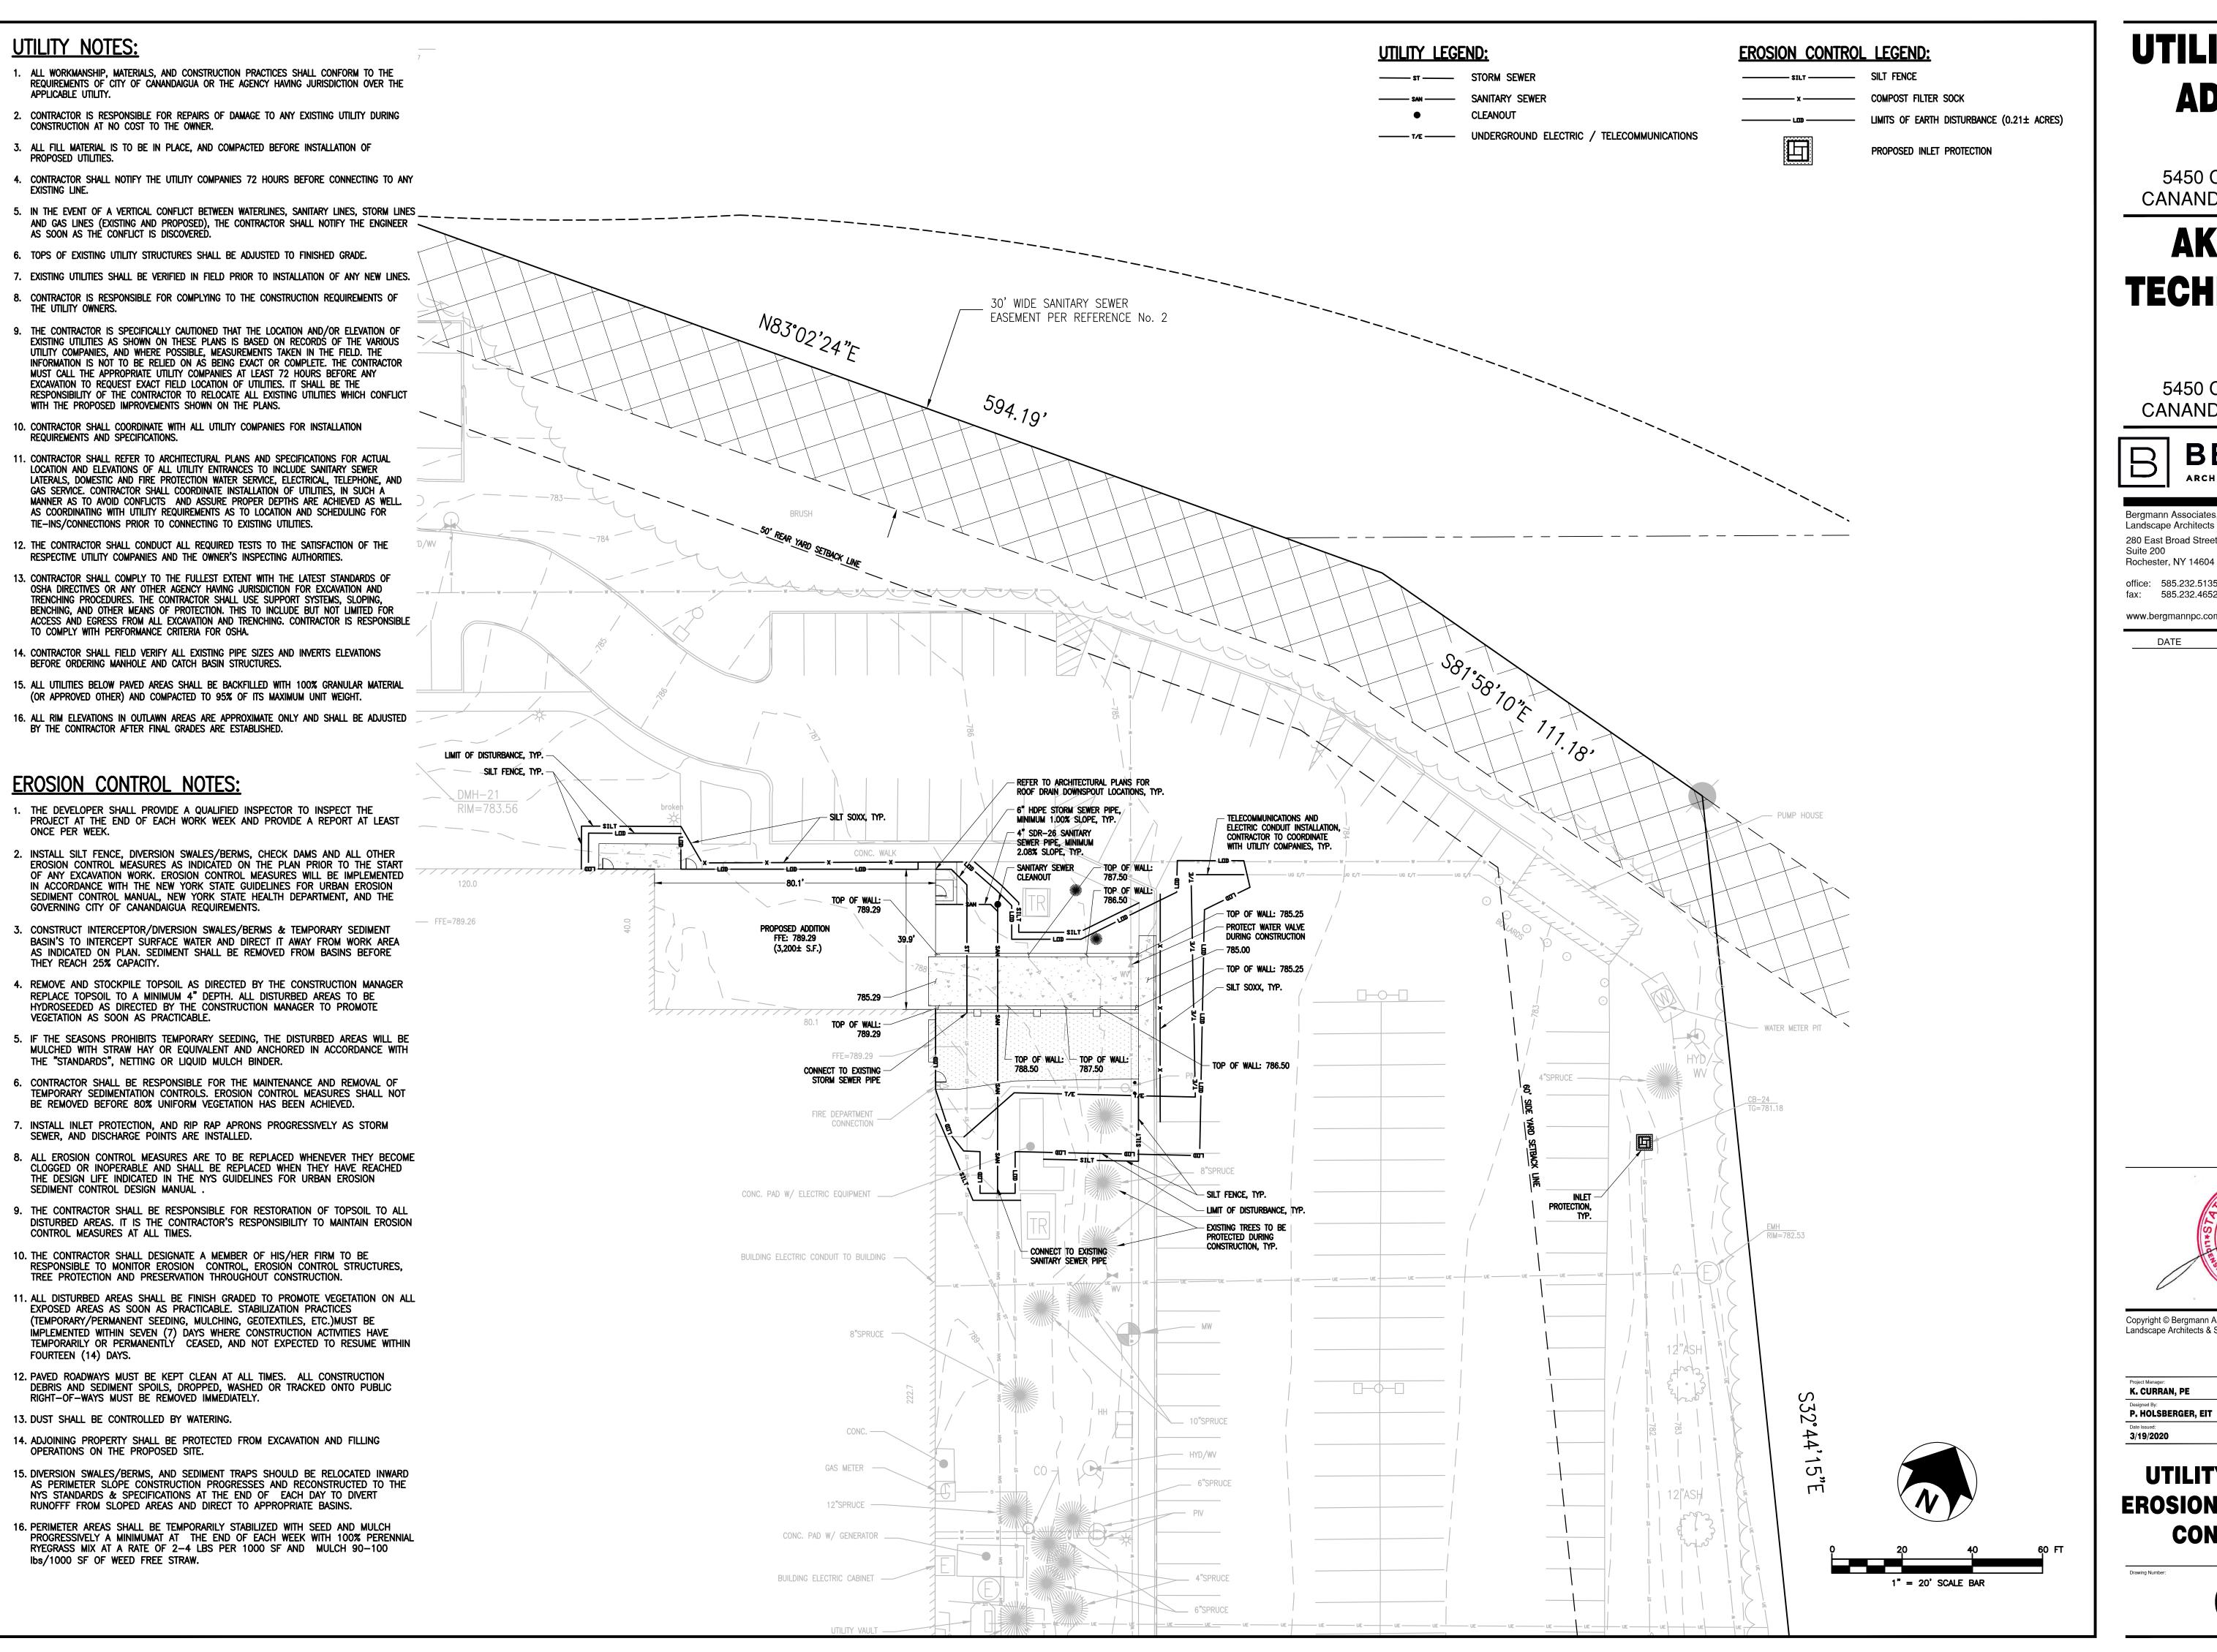
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Project Manager:

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R. DARLING, PE Drawn By:
P. HOLSBERGER, EIT P. HOLSBERGER, EIT Date Issued: 3/19/2020

FINAL SITE PLAN



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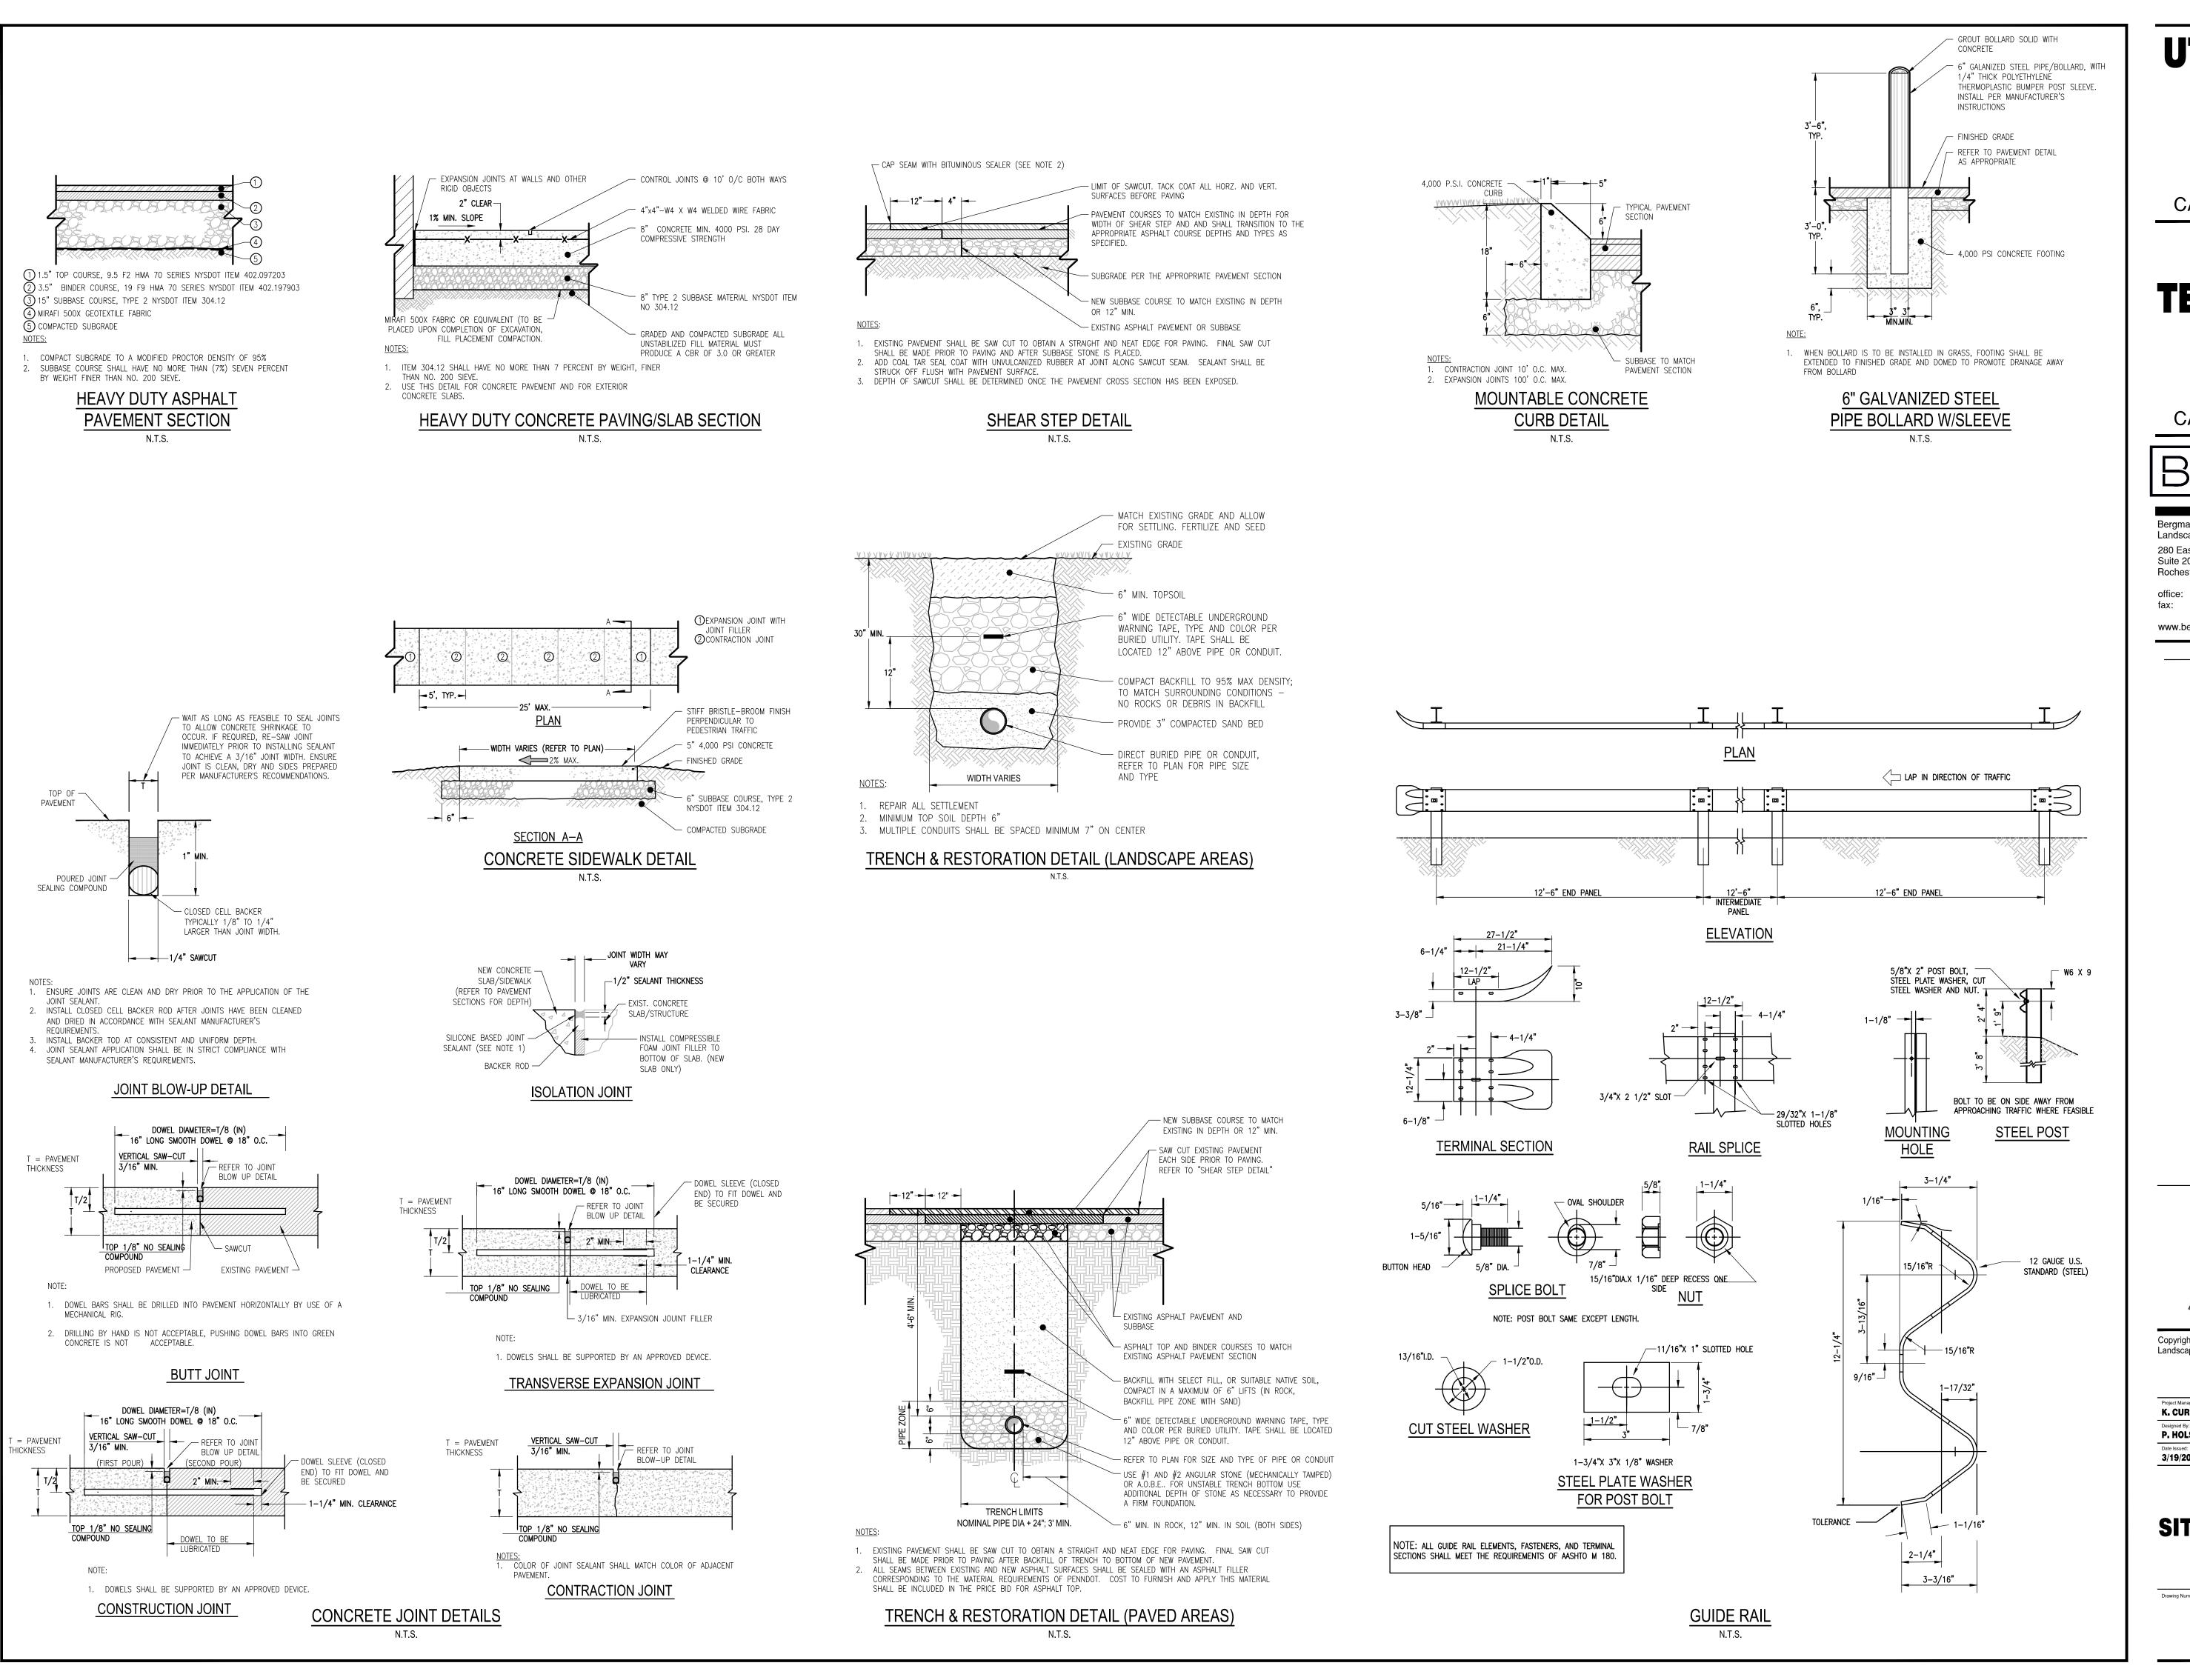
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UTILITY, GRADING & EROSION AND SEDIMENT CONTROL PLAN



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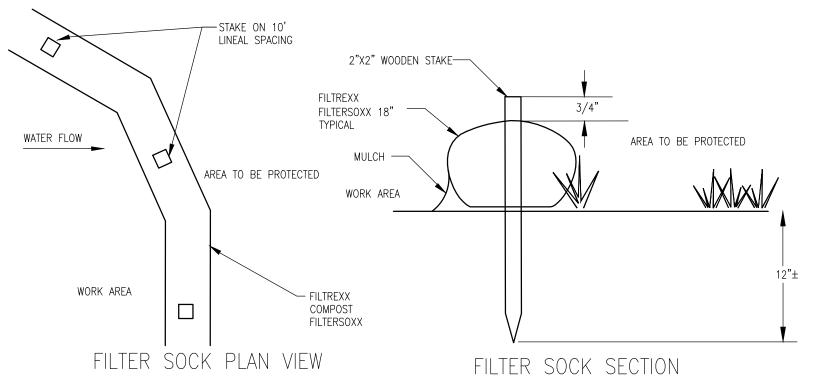
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SITE & UTILITY DETAILS




NOTES:

1. FILTER SOCK TO BE FILTREXX FILTERSOXX OR APPROVED EQUAL

- 2. ALL MATERIAL TO MEET FILTREXX SPECIFICATIONS
- 3. FILTERSOXX COMPOST/JSOIL/ROCK/SEED FILL TO MEET APPLICATION REQUIREMENTS
- 4. FILTERSOXX DEPICTED IS FOR MINIMUM SLOPES. GREATER SLOPES MAY REQUIRE LARGER SOCKS PER ENGINEER
- 5. COMPOST MATERIAL TO BE DISPERSED ON SITE, AS DETERMINED BY ENGINEER.
- 1. THE CONTRACTOR SHALL MAINTAIN THE FILTERSOXX IN A FUNCTIONAL CONDITION AT ALL TIMES AND IT SHALL BE ROUTINELY INSPECTED.
- 2. IF THE FILTERSOXX HAS BEEN DAMAGED, IT SHALL BE REPAIRED, OR REPLACED IF BEYOND REPAIR.
- 3. THE CONTRACTOR SHALL REMOVE SEDIMENT AT THE BASE OF THE UPSLOPE SIDE OF THE FILTERSOXX WHEN ACCUMULATION HAS REACHED 1/2 OF THE EFFECTIVE HEIGHT OF THE FILTERSOXX, ALTERNATIVELY, A NEW FILTERSOXX CAN BE PLACED ON TOP OF AND SLIGHTLY BEHIND THE ORIGINAL ONE CREATING MORE SEDIMENT STORAGE CAPACITY WITHOUT SOIL DISTURBANCE.
- 4. FILTERSOXX SHALL BE MAINTAINED UNTIL THE DISTURBED AREA ABOVE THE DEVICE HAS BEEN PERMANENTLY STABILIZED AND CONSTRUCTION ACTIVITY HAS CEASED. THE FILTER MEDIA WILL BE DISPERSED ON SITE ONCE THE DISTURBED AREA HAS BEEN PERMANENTLY STABILIZED
- 5. FOR LONG-TERM SEDIMENT AND POLLUTION CONTROL APPLICATIONS, FILTERSOXX CAN BE SEEDED AT THE TIME OF INSTALLATION TO CREATE A VEGETATIVE FILTERING SYSTEM FOR PROLONGED AND INCREASED FILTRATION OF SEDIMENT AND SOLUBLE POLLUTANTS (CONTAINED VEGETATIVE FILTER STRIP). THE APPROPRIATE SEED MIX SHALL BE DETERMINED BY THE DESIGN PROFESSIONAL.

FILTER SOCK SEDIMENT CONTROL NTS

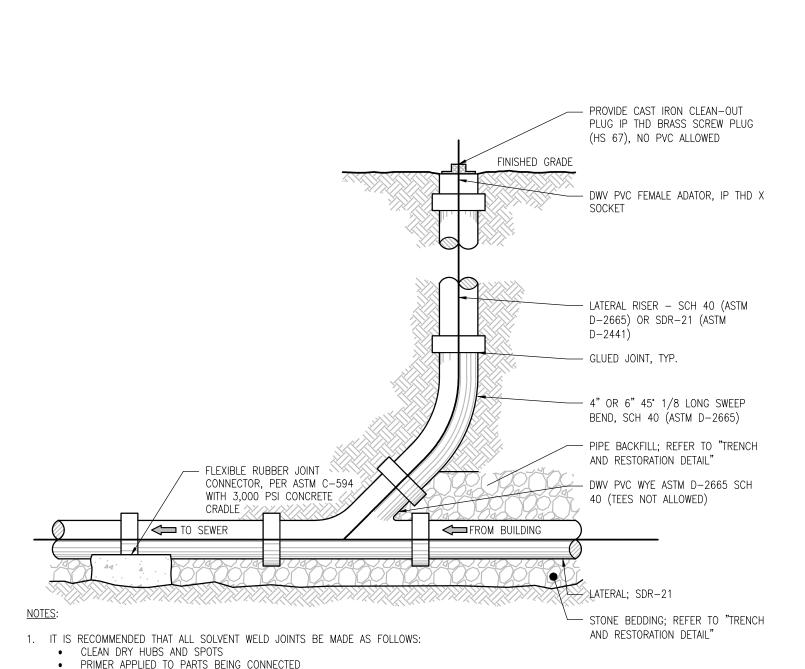


SANITARY SEWER LATERAL CLEAN-OUT

PVC SOLVENT WELD CEMENT APPLIED DIRECTLY OVER PRIMER

2. FILL SHALL BE PLACED IN 6" LIFTS AND TAMPED AFTER EACH LIFT.

PVC TYPE I IS COMPATIBLE FOR SOLVENT WELDING TO SDR-21 OR ANY

OTHER PVC TYPE I PIPE MADE TO "STEEL PIPE" OUTSIDE DIMENSIONS

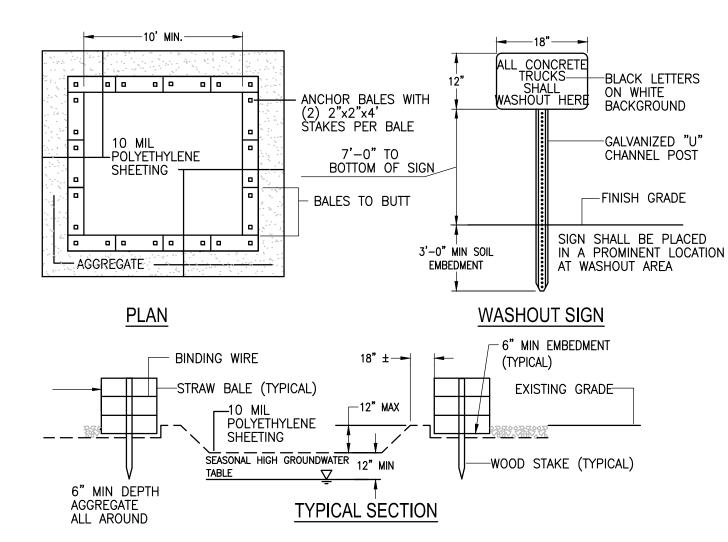


1. CONTAINMENT MUST BE STRUCTURALLY SOUND AND 4. WASHOUT AREA(S) SHALL BE INSTALLED IN A LEAK FREE AND CONTAIN ALL LIQUID WASTES. LOCATION EASILY ACCESSIBLE BY CONCRETE

2. CONTAINMENT DEVICES MUST BE OF SUFFICIENT QUANTITY OR VOLUME TO COMPLETELY CONTAIN THE 5. ONE OR MORE AREAS MAY BE INSTALLED ON THE LIQUID WASTES GENERATED. CONSTRUCTION SITE AND MAY BE RELOCATED AS CONSTRUCTION PROGRESSES. 3. WASHOUT MUST BE CLEANED OR NEW FACILITIES

CONSTRUCTED AND READY TO USE ONCE WASHOUT 6. AT LEAST WEEKLY REMOVE ACCUMULATION OF SAND IS 75% FULL. AND AGGREGATE AND DISPOSE OF PROPERLY.

> **CONCRETE WASHOUT AREA** N.T.S.

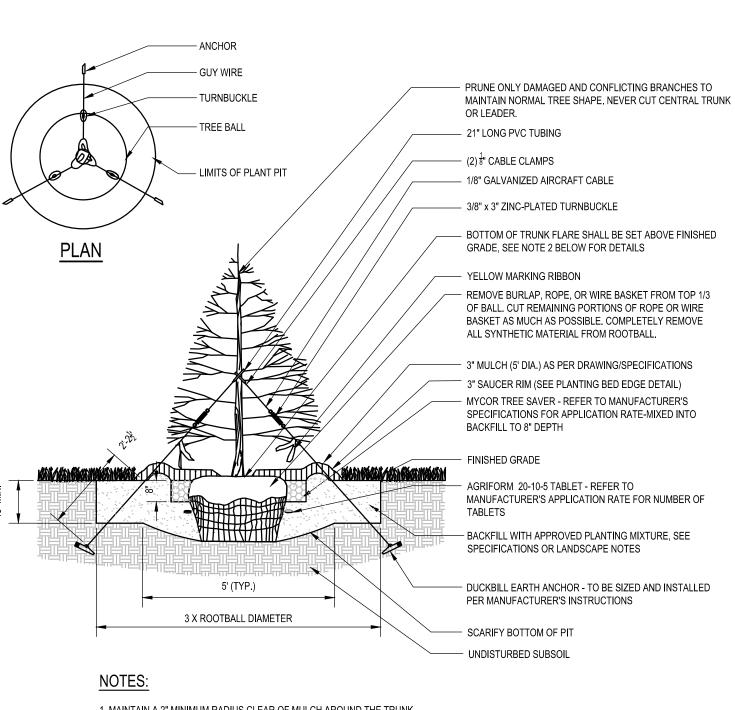

1. MAINTAIN A 2" MINIMUM RADIUS CLEAR OF MULCH AROUND THE TRUNK.

2. THE DISTANCE BETWEEN THE BOTTOM OF THE TRUNK FLARE AND THE FINISHED GRADE SHALL BE AS FOLLOWS: FOR SANDY OR LOAMY SOILS: 1"

FOR CLAY OR POORLY DRAINED SOILS: 3" THE CONTRACTOR SHALL REVIEW THE APPROPRIATE PLANTING DEPTH WITH THE OWNER'S REPRESENTATIVE PRIOR TO INSTALLATION.


3. WHEN TAGGING TREES AT THE NURSERY, MARK THE NORTH SIDE OF THE TREE IN THE FIELD AND WHEN INSTALLING, ROTATE TREE TO FACE NORTH WHENEVER POSSIBLE.

EVERGREEN TREE PLANTING

REMOVE EXISTING ROOF DRAIN PIPE -GLUED JOINT, TYP. -AND INSTALL WYE CONNECTION AND PROPOSED ROOF DRAIN PIPE. MATCH EXISTING PIPE SIZE AND MATERIAL - PIPE BACKFILL; REFER TO "TRENCH AND RESTORATION DETAIL" EXISTING ROOF -DRAIN PIPE PROPOSED ROOF DRAIN, MATCH EXISTING PIPE SIZE AND MATERIAL 1. FILL SHALL BE PLACED IN 6" LIFTS AND TAMPED AFTER EACH LIFT. STONE BEDDING; REFER TO "TRENCH AND RESTORATION DETAIL" STORM SEWER ROOF-DRAIN CONNECTION DETAIL

- EXISTING ROOF DRAIN PIPE

FINISHED GRADE

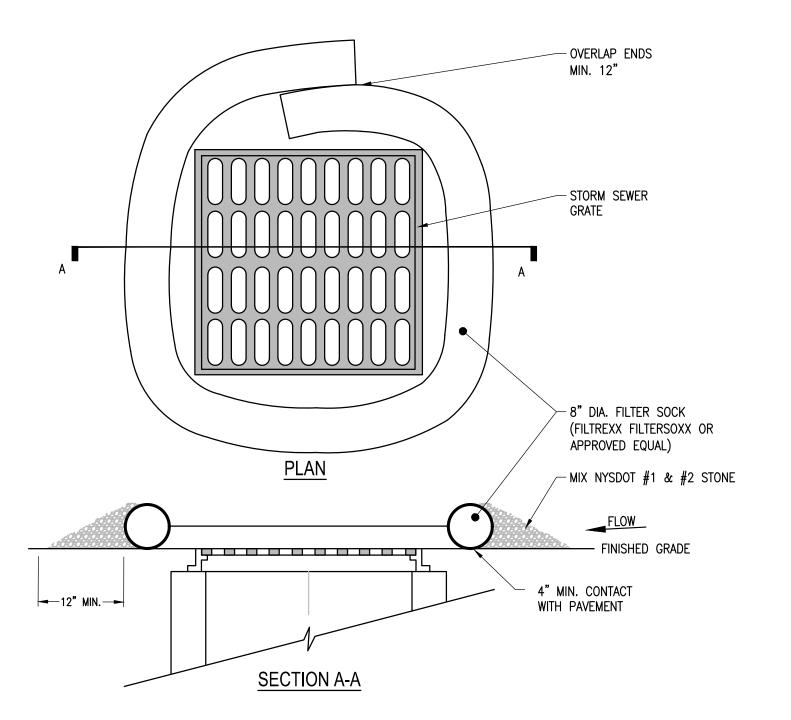

- 1. REPLACE AND DISPOSE OF PER MANUFACTURERS SPECIFICATIONS.
- 2. THIS PRACTICE INCLUDES SANDBAGS, COMPOST FILTER SOCKS, GEO-TUBES FILLED WITH BALLAST, AND MANUFACTURED SURFACE BARRIERS. PEA GRAVEL CAN ALSO BE USED IN CONJUNCTION WITH THESE PRACTICES TO IMPROVE PERFORMANCE. WHEN INLET IS NOT AT A LOW POINT, AND IS OFF-SET FROM THE PAVEMENT OR GUTTER LINE, PROTECTION SHOULD BE SELECTED AND INSTALLED SO THAT FLOWS ARE NOT DIVERTED AROUND
- 3. THE DRAINAGE AREA SHOULD BE LIMITED TO 1 ACRE AT THE DRAINAGE INLET. ALL PRACTICES WILL BE PLACED AT THE INLET PERIMETER OR BEYOND TO MAXIMIZE THE FLOW CAPACITY OF THE INLET. PRACTICES SHALL BE WEIGHTED, BRACED, TIED, OR OTHERWISE ANCHORED TO PREVENT MOVEMENT OR SHIFTING OF LOCATION ON PAVED SURFACES. TRAFFIC SAFETY SHALL BE INTEGRATED WITH THE USE OF THIS PRACTICE. ALL PRACTICES SHOULD BE MARKED WITH TRAFFIC SAFETY CONES AS APPROPRIATE. STRUCTURE HEIGHT SHALL NOT CAUSE FLOODING OR BY-PASS FLOW THAT WOULD CAUSE ADDITIONAL EROSION. THE STRUCTURE SHOULD BE INSPECTED AFTER EVERY STORM EVENT. ANY SEDIMENT SHOULD BE REMOVED AND DISPOSED OF ON THE SITE. ANY BROKEN O DAMAGED COMPONENTS SHOULD BE REPLACED. CHECK ALL MATERIALS FOR PROPER ANCHORING AND SECURE AS NECESSARY.
- 4. IF USING THE COMPOST FILTER SOCK, THE COMPOST INFILL SHALL BE WELL DECOMPOSED (MATURED AT LEAST 3 MOTHS), WEED-FREE, ORGANIC MATTER. IT SHALL BE AEROBICALLY COMPOSTED, POSSESS NO OBJECTIONABLE ODORS, AND CONTAIN LESS THAN 1%, BY DRY WEIGHT, OF MANMADE FOREIGN MATTER. WHEN USING COMPOST FILTER SOCKS ADJACENT TO SURFACE WATER, THE COMPOST SHOULD HAVE LOW NUTRIENT VALUE.

PAVED SURFACE INLET PROTECTION DETAIL

UTILITY PLANT ADDITION

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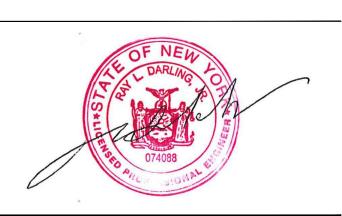
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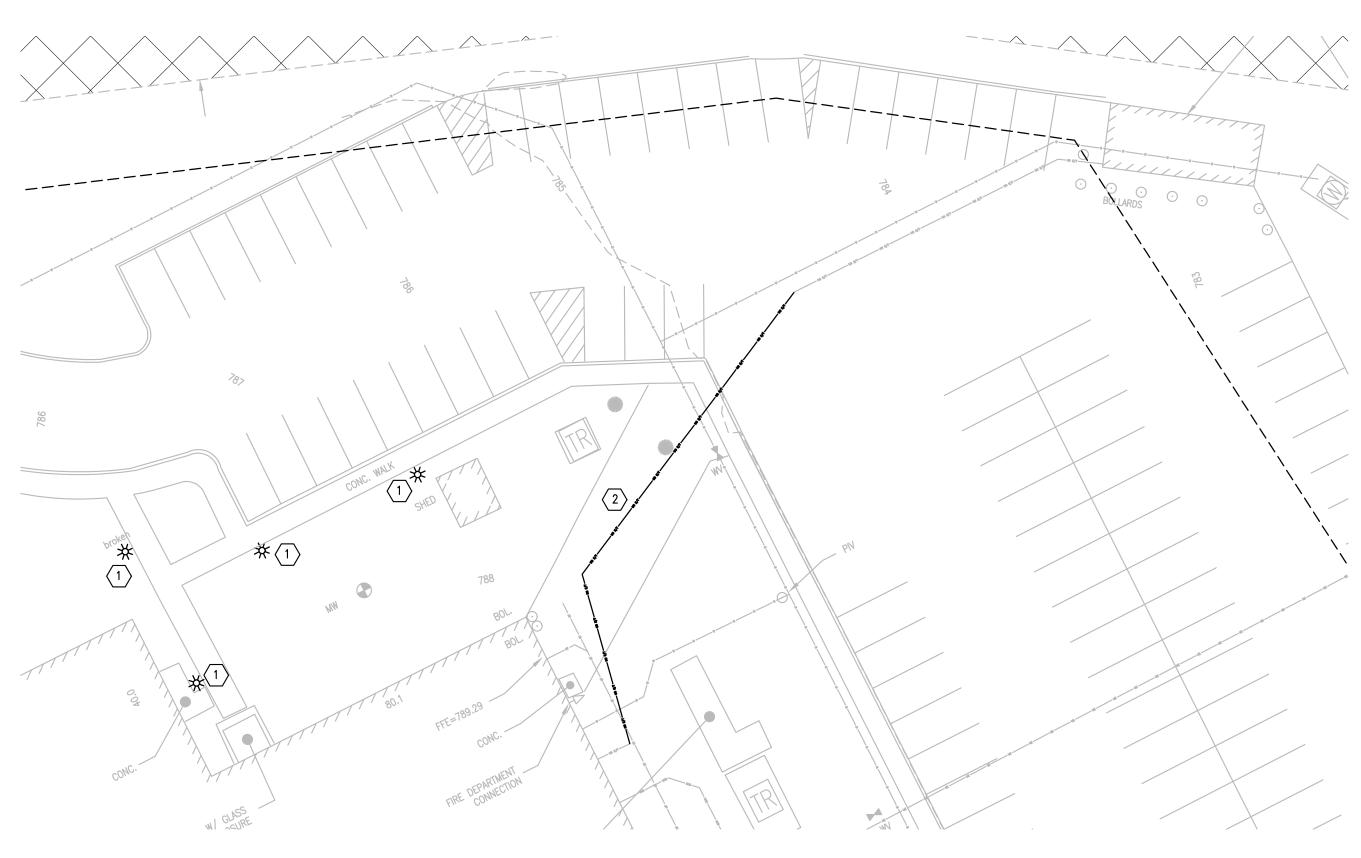
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UTILITY & EROSION AND SEDIMENT CONTROL DETAILS



AKOUSTICS DEMOLITION SITE PLAN

SCALE: 1"= 20"



DEMOLITION KEYNOTES:

- 1. DISCONNECT AND REMOVE (3) SITE LIGHTING PEDESTRIAN POLES AND SAVE FOR RELOCATION. REMOVE UNDERGROUND CONDUIT AND WIRING BACK TO NEAREST PEDESTRIAN POLE ON CIRCUIT. REMOVE (1) EXISTING PEDESTRIAN LIGHT THAT IS
- 2. DISCONNECT AND REMOVE EXISTING UNDERGROUND POWER AND COMMUNICATIONS CONDUIT WITH ALL FIRE PUMP WIRING AND COMMUNICATIONS CABLING. COORDINATE DOWN TIME WITH OWNER. FIRE PUMP CONDUIT IS ENCASED IN DUCTBANK.

LEGEND (NOT ALL SYMBOLS USED THIS SHEET SOME SHOWN FOR REFERENCE ONLY)

DUPLEX RECEPTACLE

CARD READER

WALL MOUNTED LIGHTS

CAMERA

SIDEWALK DECORATIVE LIGHTS

MANHOLE

RENOVATION KEYNOTES:

- 1. REINSTALL (3) PEDESTRIAN POLES WHERE SHOWN. PROVIDE CONDUIT AND WIRING TO RECONNECT TO PREVIOUS CIRCUITING.
- 2. PROVIDE NEW PEDESTRIAN POLE TO MATCH EXISTING. REINSTALL IN SAME LOCATION AND RECONNECT WIRING. CONTRACTOR TO VERIFY ALL COMPONENTS OF THE LIGHT FIXTURE TO ENSURE A MATCH.
- 3. PROVIDE NEW UNDERGROUND CONDUIT AND WIRING TO MATCH EXISTING. PROVIDE MANHOLES WHERE SHOWN. PROVIDE DUCTBANK FOR FIRE PUMP FEEDER.

UTILITY PLANT ADDITION

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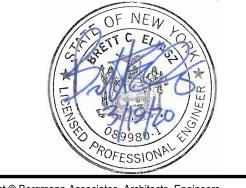
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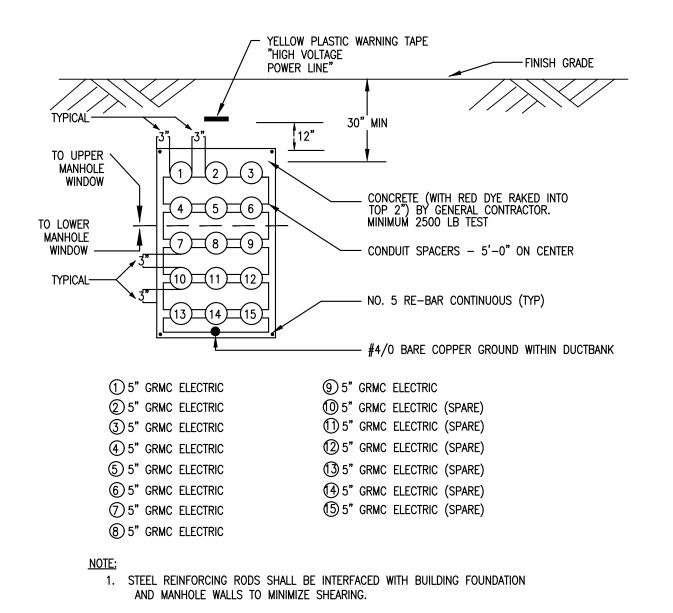
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Designed By:	Drawn By:	
B. ELIASZ, PE	R. FREEMAN	
Date Issued:	Project Number:	
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ELECTRICAL SITE PLAN


Drawing Number:

E101

2 of **2**




?? DUCTBANK SECTION "F-F" SCALE: N.T.S.

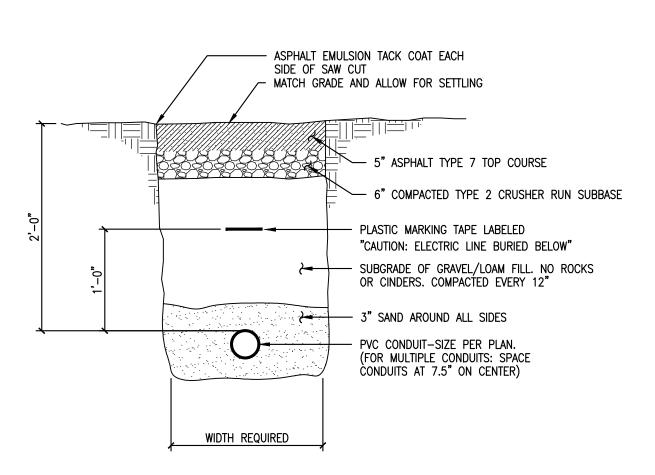


TYPICAL CONDUIT BURIAL—PAVED AREAS

(??) SCALE: N.T.S.

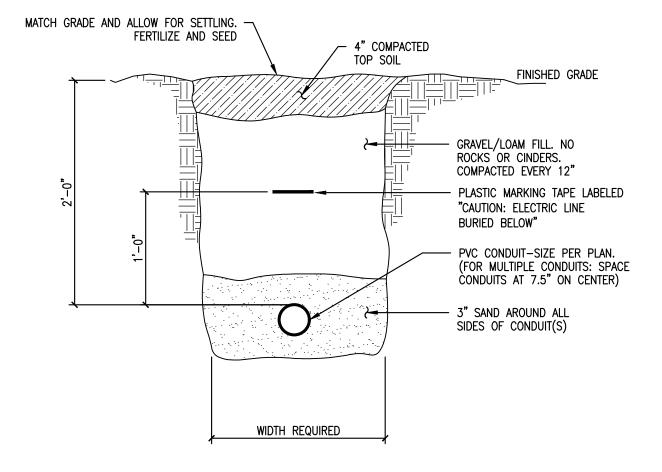

TYPICAL CONDUIT BURIAL—GRASS AREAS

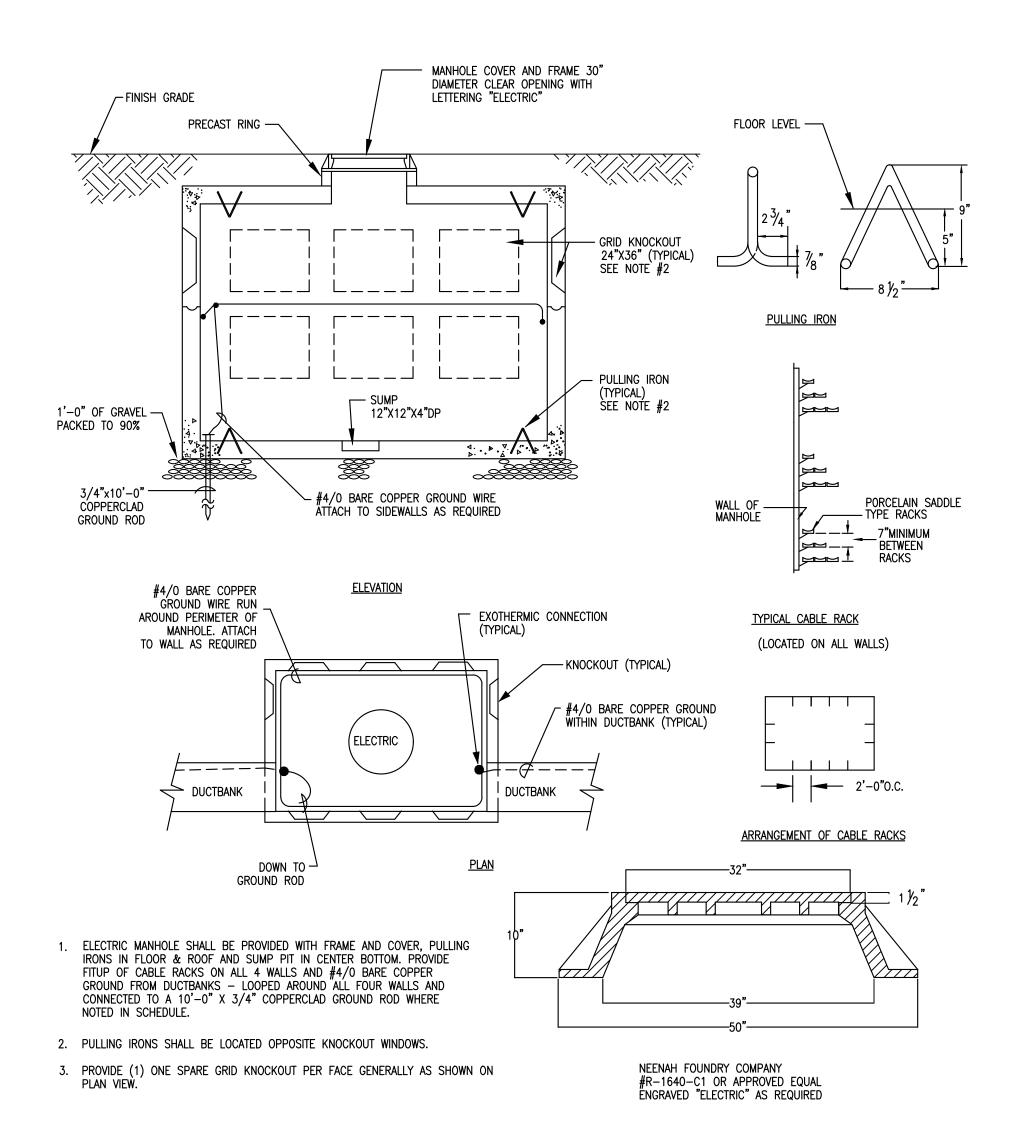

MANHOLE COVER & FRAME

TYPICAL ELECTRIC MANHOLE DETAIL SCALE: N.T.S

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Date Issued:	Project Number:
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ELECTRICAL DETAILS

E201

2 of **2**