

FLOOR PLAN

SCALE: 1/4" = 1'-0"

CONTRACTOR SHALL CONFIRM
ALL DIMENSIONS PRIOR TO
ORDERING MATERIALS OR
STARTING CONSTRUCTION

CONTRACTOR SHALL CONFIRM
LOCATION AND SIZE OF ALL
DOORS WITH OWNER PRIOR
ORDERING MATERIALS OR
STARTING CONSTRUCTION

WARNING

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DRAWN BY:	JTM			
PROJ. ENGR.:	JTM			
PROJ. MNGR.:	JTM	0	04/09/22	FOR APPROVAL
CHECKED BY:	JTM	NO.	DATE	DESCRIPTION
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McCormick Engineering P.C.

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Geneva, New York 14456

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JOB No. 22-164


PRO-CUTTER LANDSCAPE
COUNTY ROAD 47
CANANDAIGUA, NY
Ontario County, New York


FLOOR PLAN

Scale:
AS NOTED

04/22

DWG. A-2.0

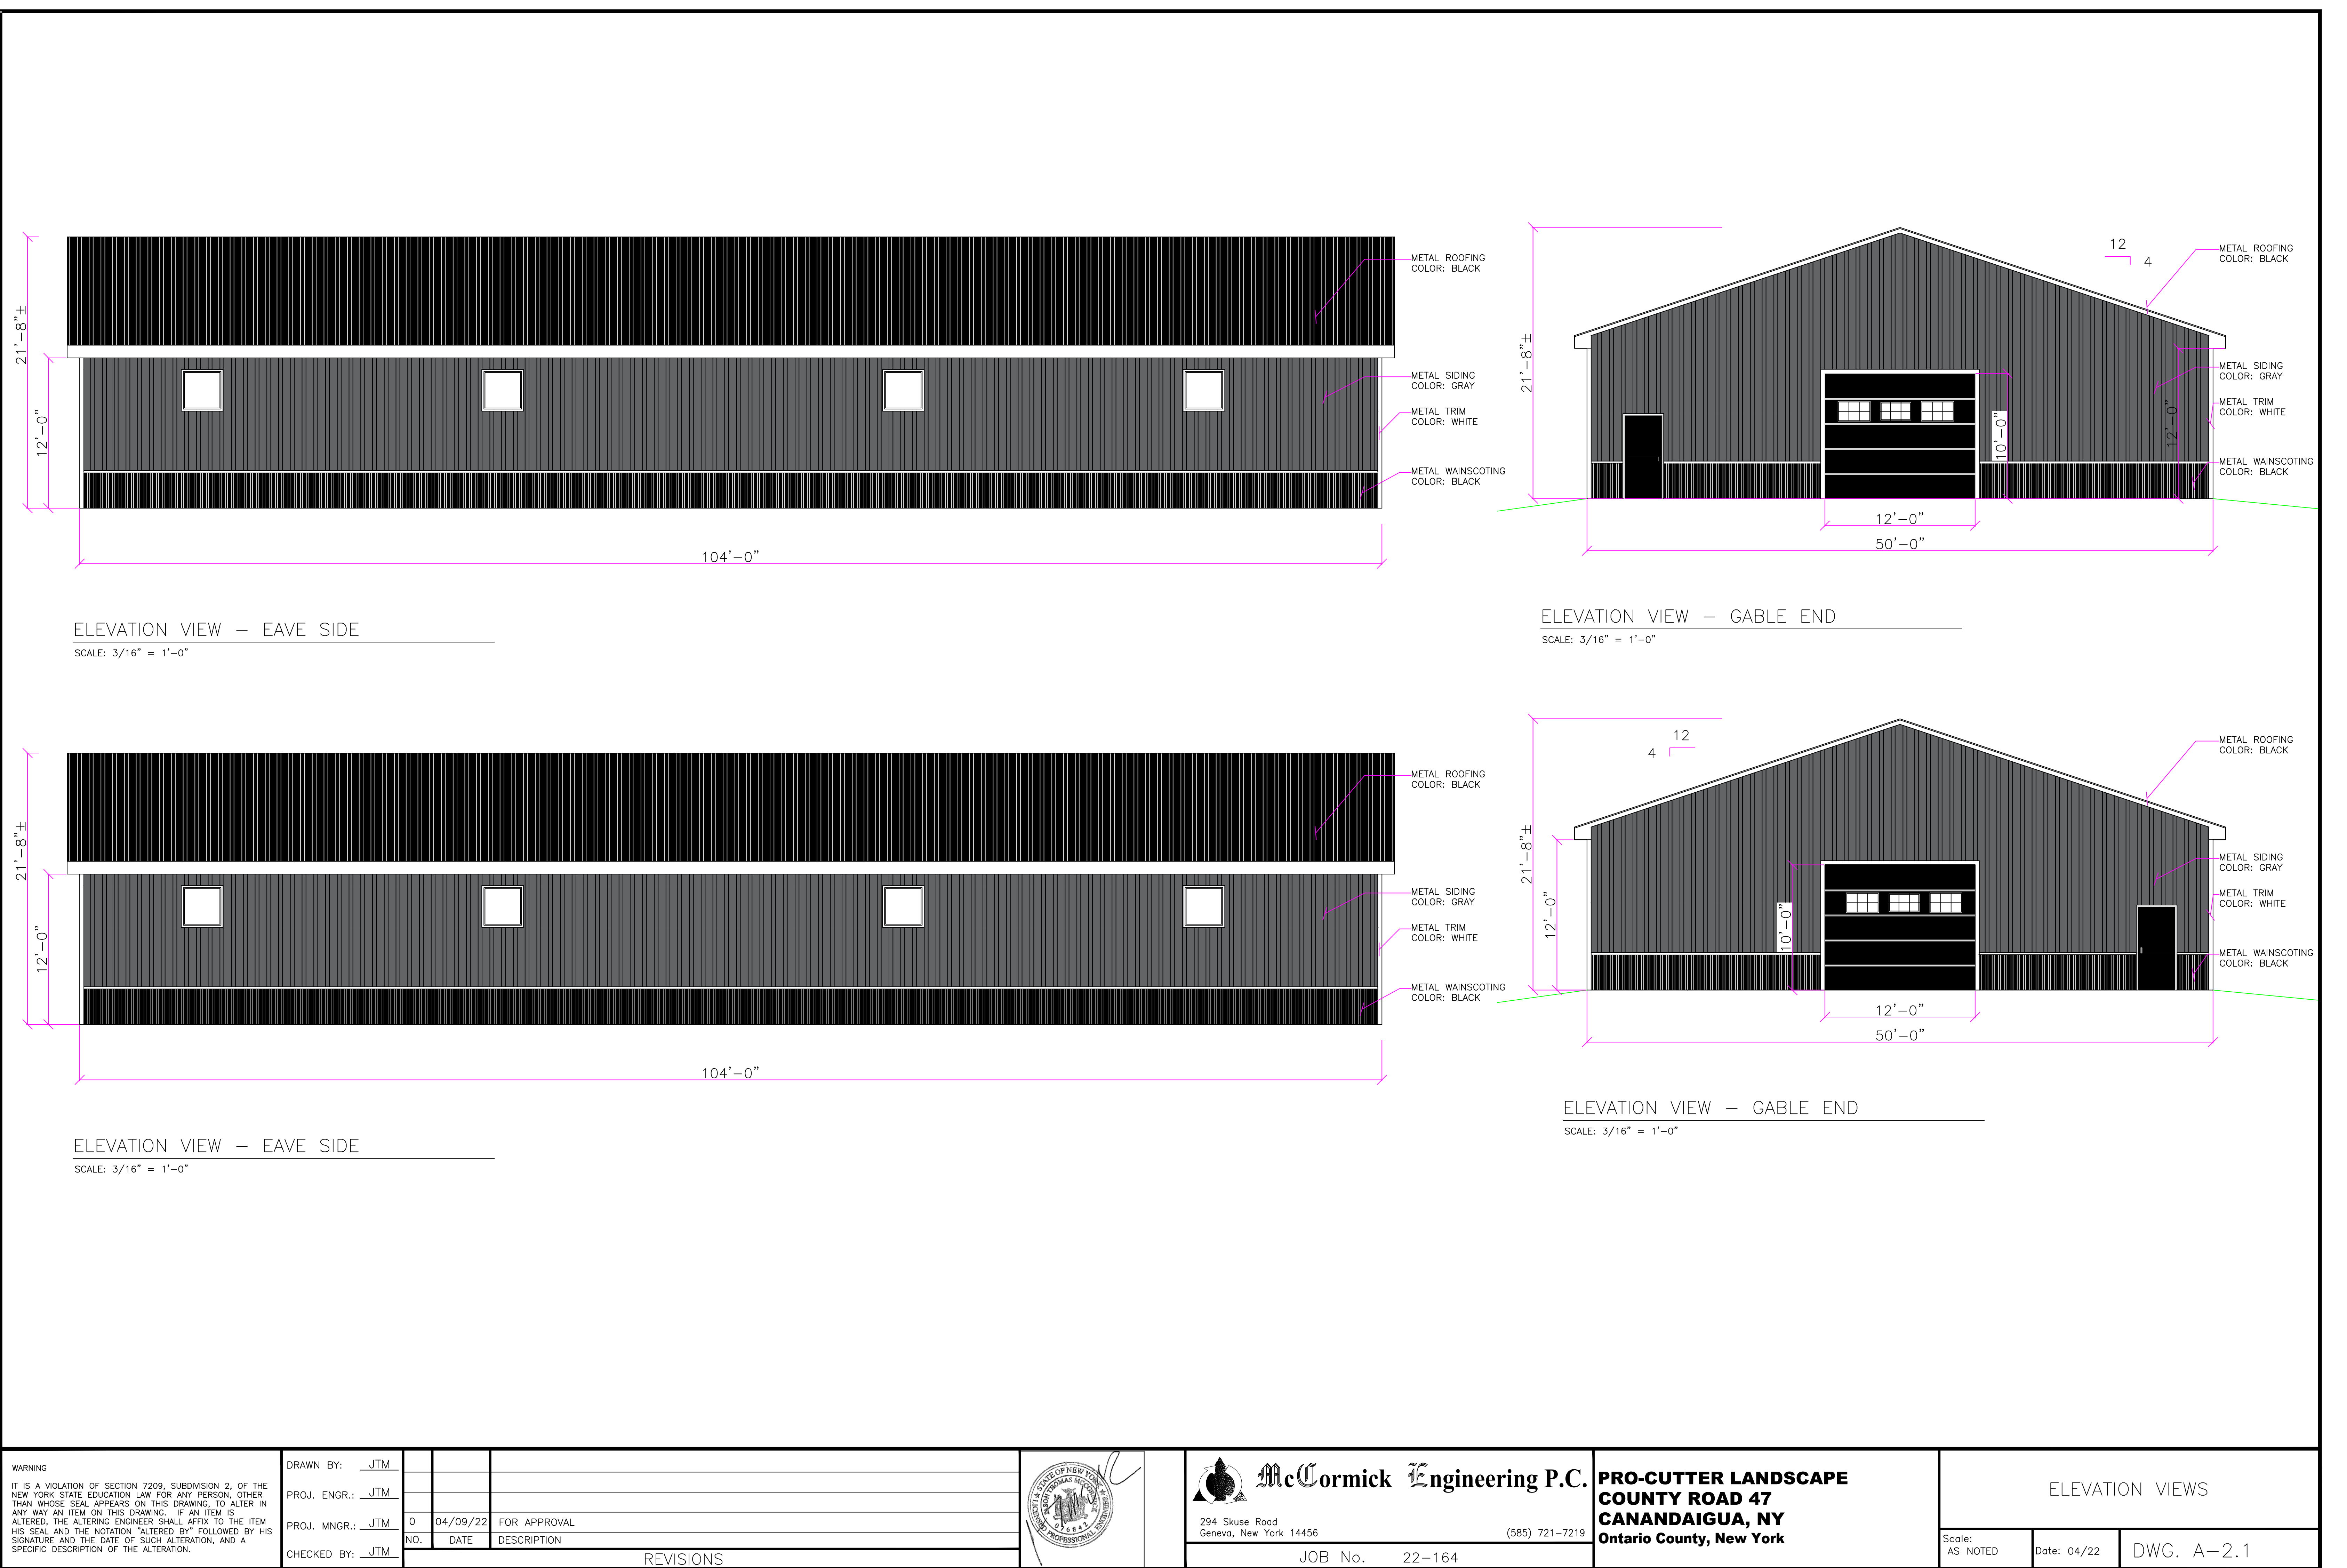

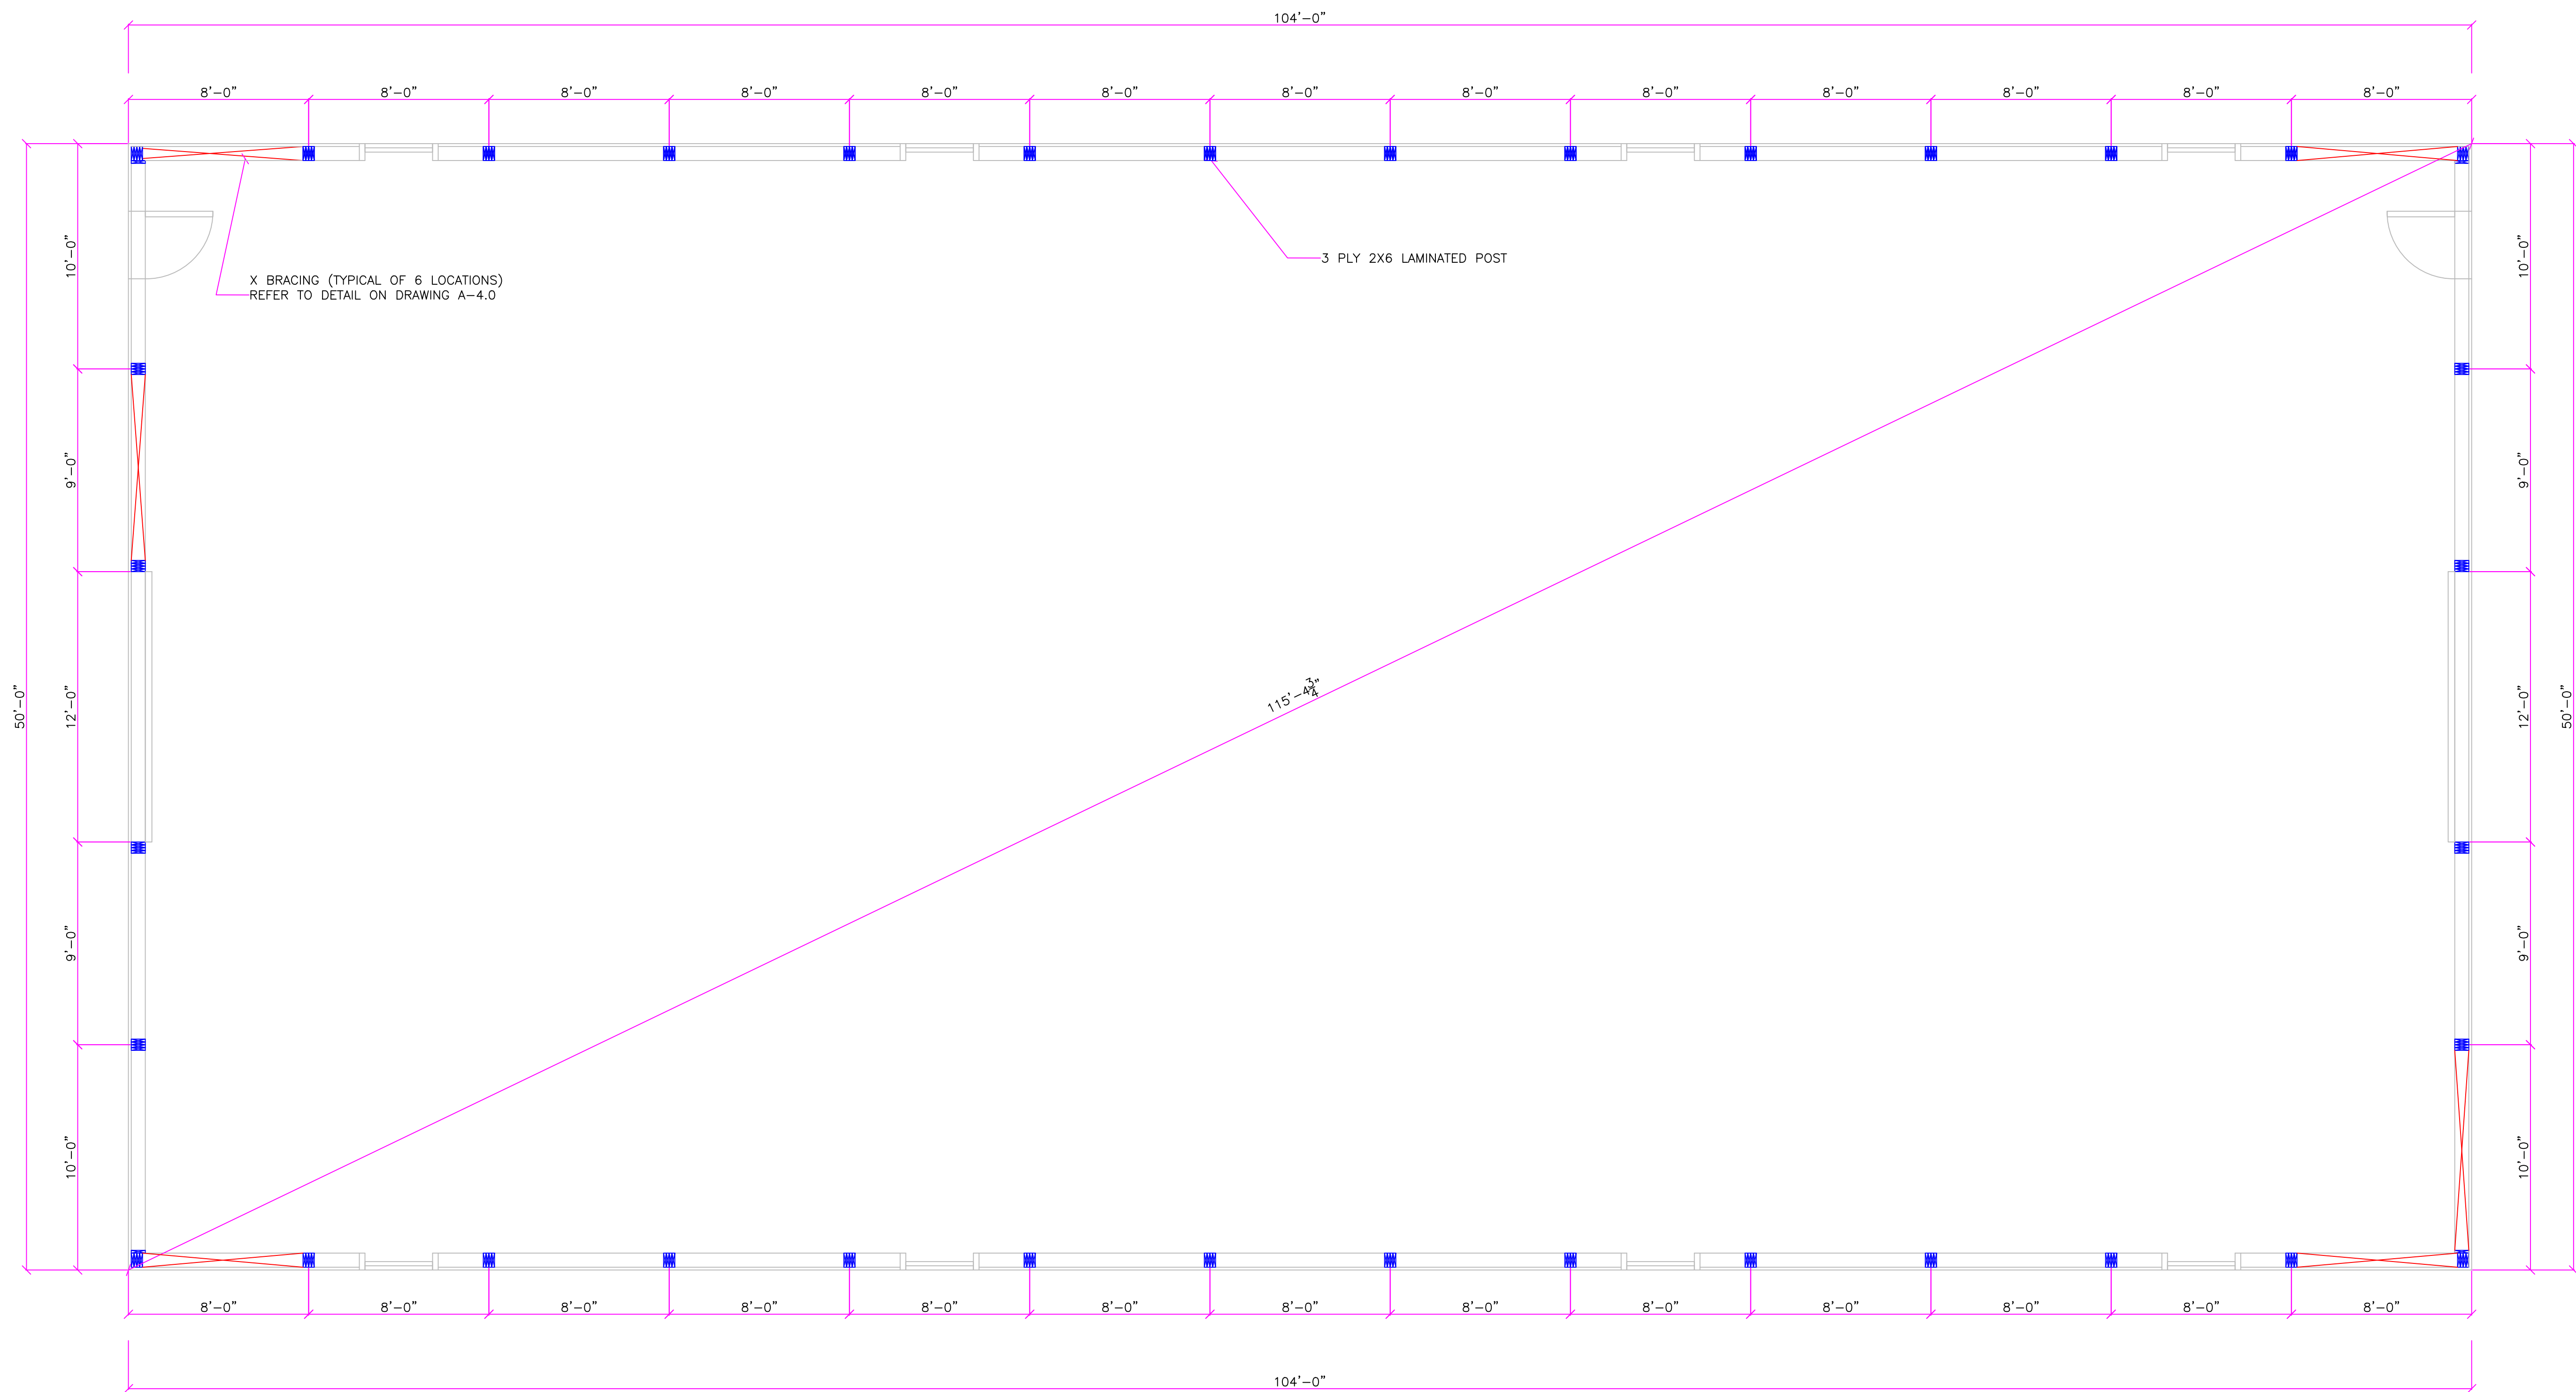

POST LOCATION PLAN

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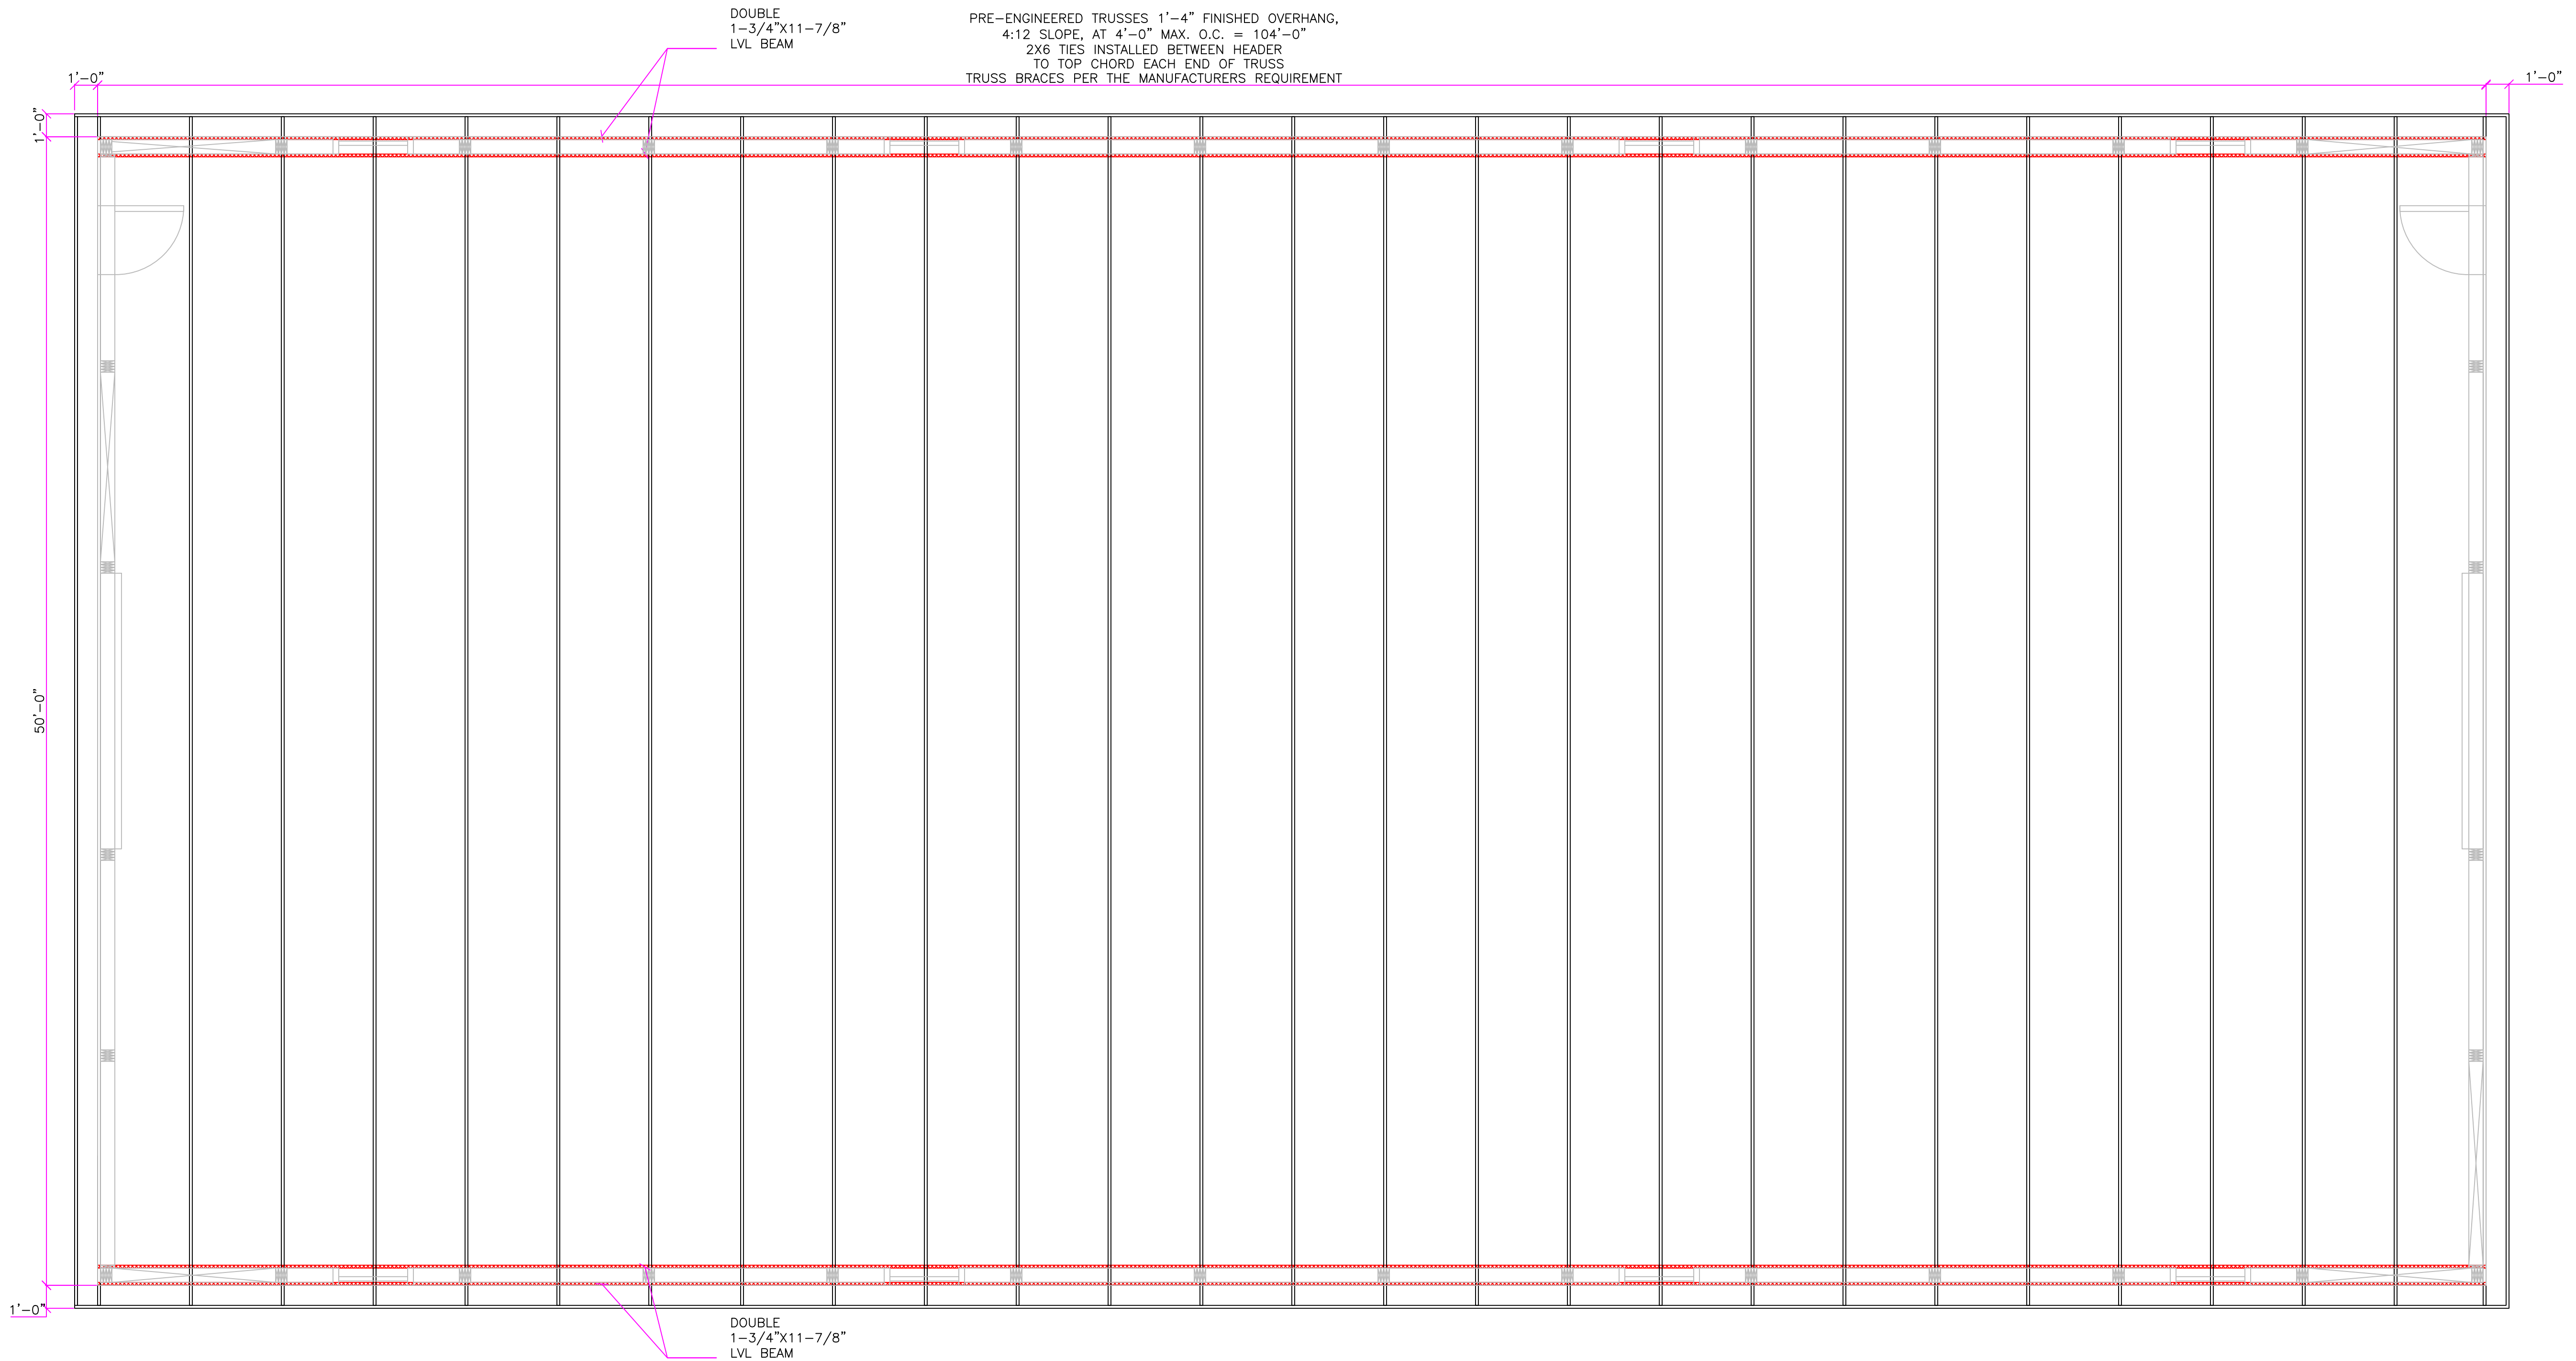
**PRO-CUTTER LANDSCAPE
COUNTY ROAD 47
CANANDAIGUA, NY
Ontario County, New York**

POST LOCATION PLAN

Scale:
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Date: 04/22

DWG. A-3.0



ROOF FRAMING PLAN

SCALE: 1/4" = 1'-0"

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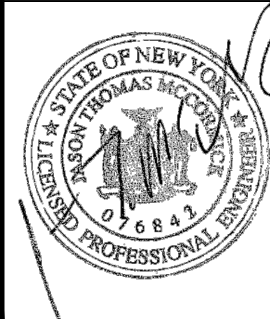
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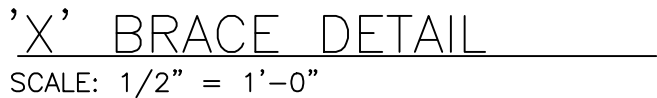
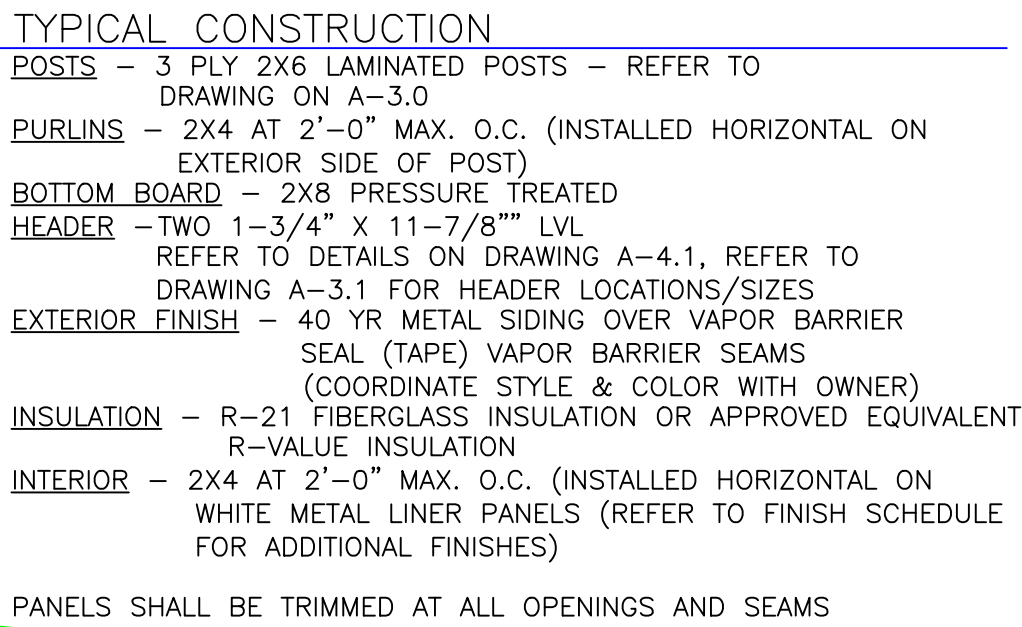
**PRO-CUTTER LANDSCAPE
COUNTY ROAD 47
CANANDAIGUA, NY
Ontario County, New York**

ROOF FRAMING PLAN

Scale:
AS NOTED

Date: 04/22

DWG. A-3.1





1. ALL WOOD IN CONTACT WITH EARTH OR CONCRETE SHALL BE ACQ TREATED LUMBER

LAMINATED POST WITH POST WRAP AND
FOOTER SHALL BE A MINIMUM OF 42"
BELOW GRADE. REFER TO DETAILS ON
DRAWING A-4.1 (TYPICAL ALL POSTS)

TYPICAL SECTION

SCALE: 1/4" = 1'-0"

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	PROJ. ENGR.: JTM									
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MATERIALS SUMMARY TABLE

ITEM	DIMENSIONS
POSTS	3 PLY 2X6 LAMINATED POST (BUILDING) REFER TO DRAWING A-3.0
HEADERS	(2) 1-3/4"x11-7/8" LVL (AT OHDS) REFER TO ROOF FRAMING PLAN ON DRAWING A-3.1
PURLINS (ROOF & SIDES)	2X4 @ 24" MAX. O.C.
BOTTOM\BASE BOARD	2X8 PRESSURE TREATED
'X' BRACES	2X6 AT LOCATIONS SHOWN ON POST LOCATION PLAN
'Y' BRACES	2X6 AT EVERY POST (EXCEPT OVERHED DOOR LOCATIONS)
TRUSS CROSS BRACE	2X4
TRUSS FOR BUILDING	PRE-ENGINEERED RAISED HEEL ENERGY TRUSS @ 4' MAX OC, 12" OVERHANG REFER TO ROOF FRAMING PLAN ON DRAWING A-3.0
TRUSS TIES	2X6 (BOTH ENDS AND INTERIOR BEARING POINTOF EACH TRUSS) BETWEEN HEADERS
STRUCTURAL SCREWS	0.220 X 6 STRONG DRIVE SDWS TIMBER SCREW BY SIMPSON STRONG TIE OR APPROVED EQUAL
ROOFING	40 YEAR STEEL ROOFING PANELS OVER DOUBLE BUBBLE INSULATION STYLE AND COLOR TO BE DETERMINED
SIDING	40 YEAR STEEL SIDING PANELS OVER VAPIER BARRIER STYLE AND COLOR TO BE DETERMINED
INTERIOR FINISH	WALLS - WHITE METAL LINER PANELS/CEILING - WHITE METAL LINER PANELS
INSULATION	R-21 FIBERGLASS WALLS/R-38 BLOWN-IN OR BATT FIBERGLASS CEILING
GUTTERS	6" SEAMLESS (OPTIONAL)

POST DETAIL

3-PLY 2X6 LAMINATED POST (BUILDING)

GRADE

APPROVED ON-SITE MATERIAL OR CRUSHER RUN STONE

UNDISTURBED EARTH

6" PRECAST CONCRETE FOUNDATION DISC OR 10" CONCRETE (80 LBS SACRETE MIXED)

1'-6" DIA

4'-0"

3'-6"

6"

1'-6"

1'-6"

SCALE: 3/4" = 1'-0"

HEADER DETAIL

(4) 0.220 X 5 STRUCTURAL SCREWS (SIMPSON STRONG TIE SDWS TIMBER SCREW OR APPROVED EQUAL) PER BEAM FOR A TOTAL OF 8 PER POST (16 PER POST AT BUTT JOINTS)

HEADER BEAM (2) 1-3/4"x11-7/8 LVL

2X6 BLOCK SECURED TO POST WITH 16d NAILS @ 4" O.C. (OR NOTCH HEADER INTO POST)

2X4 PURLINS @ 24" MAX. O.C.

3-PLY 2X6 LAMINATED POST

1 1/2"

SCALE: 3/4" = 1'-0"

'Y' BRACE DETAIL

HEADER BEAM (REFER TO DRAWING A-3.0 FOR SIZE)

REFER TO HEADER DETAIL FOR FASTENER REQUIREMENTS

SECURE 'Y' BRACES TO HEADER WITH 16d NAILS @ 4" O.C.

2X6 'Y' BRACE

2X6 X 1'-6" SUPPORT BLOCK

3-PLY 2X6 LAMINATED POST

1'-6"

1'-6"

SCALE: 1/2" = 1'-0"

DOOR SCHEDULE

MARK	QUANTITY	SIZE	TYPE/SPECIFICATIONS
D001	1	3'-0"x6'-8"	EXTERIOR MAN DOOR, PAINTED METAL FRAME AND DOOR, WINDOW, R-15 MINIMUM R-VALUE, ADA LEVER HANDLES, LOCKSET
D002	1	12'X10'	OVERHEAD DOOR, R-15 MINIMUM R-VALUE, DOUBLE GASKET SEALS, JACK SHAFT OPERATOR, WINDOWS
D003	1	3'-0"x6'-8"	EXTERIOR MAN DOOR, PAINTED METAL FRAME AND DOOR, WINDOW, R-15 MINIMUM R-VALUE, ADA LEVER HANDLES, LOCKSET
D004	1	12'X10'	OVERHEAD DOOR, R-15 MINIMUM R-VALUE, DOUBLE GASKET SEALS, JACK SHAFT OPERATOR, WINDOWS

WINDOW SCHEDULE

MARK	QUANTITY	SIZE	TYPE	MANUFACTURER	U-FACTOR	SHGC
W001	1	36"X36"	DOUBLE HUNG, DOUBLE PANE, LOW-E	ANDERSEN SILVERLINE	0.29	0.26
W002	1	36"X36"	DOUBLE HUNG, DOUBLE PANE, LOW-E	ANDERSEN SILVERLINE	0.29	0.26
W003	1	36"X36"	DOUBLE HUNG, DOUBLE PANE, LOW-E	ANDERSEN SILVERLINE	0.29	0.26
W004	1	36"X36"	DOUBLE HUNG, DOUBLE PANE, LOW-E	ANDERSEN SILVERLINE	0.29	0.26
W005	1	36"X36"	DOUBLE HUNG, DOUBLE PANE, LOW-E	ANDERSEN SILVERLINE	0.29	0.26
W006	1	36"X36"	DOUBLE HUNG, DOUBLE PANE, LOW-E	ANDERSEN SILVERLINE	0.29	0.26
W007	1	36"X36"	DOUBLE HUNG, DOUBLE PANE, LOW-E	ANDERSEN SILVERLINE	0.29	0.26
W008	1	36"X36"	DOUBLE HUNG, DOUBLE PANE, LOW-E	ANDERSEN SILVERLINE	0.29	0.26

FINISH SCHEDULE

ROOM	FLOOR	WALLS	CEILING
STORAGE AREA	SEALED CONCRETE	WHITE METAL LINER PANELS	WHITE METAL LINER PANELS OR TRUS-CORE PANELS

Ridge Vent Detail

2" LONG FASTENER 9" C/C MAX

AR-3 RIDGE FLASH

ROOF PANEL

SEALANT TAPE TOP & BOTTOM OF CLOSURE

PURLIN

GAP AS REQUIRED

OUTSIDE CLOSURE (ON HIP ROOFS, USE 1"X1"X13" SEALER STRIP & RR-1 FLASHING)

If closures are omitted, Fabral suggests using screen wire between panels and ridge gap area to keep insects and birds out of attic area. Closures and sealant are recommended where weather resistance is necessary.

TYPICAL ROOF CONSTRUCTION

REFER TO SECTION A-A

2X SUB FASCIA AS REQUIRED

METAL DRIP EDGE

ALUMINUM FASCIA

6" SEAMLESS ALUMINUM GUTTER WITH 6" DOWNSPOUTS CONNECTED TO DRAINAGE SYSTEM (OPTIONAL)

VINYL SOFFIT WITH CONTINUOUS HORIZONTAL SOFFIT VENT

HEADER BEAM REFER TO ROOF FRAMING PLAN

2X4 PURLINS @ 24" MAX. O.C.

1'-0" MIN

2'-0" MAX

FASCIA DETAIL

SCALE: 1/2" = 1'-0"

RADIANT HEAT FLOOR PIPING - PEX TUBING (SPECIFICATION PER ASTM F876 & F877) 1/2 INCH LEGENDFLEX TM, INSTALLED 1'-0" MAX. O.C. FASTEN TO WIRE MESH WITH QUIP CLIPS (PART SKU: QC1-250S)

SAW CUT JOINT (20'-0" X 20'-0" GRID) WITHIN 8 HOURS AFTER FINISHING. FILL WITH JOINT SEALANT.

4000 PSI CONCRETE WITH FIBERMESH AND #6 WIRE MESH REINFORCEMENT, TROWEL FINISH

6-MIL VAPOR BARRIER

PRESSURE TREATED 2X8 BOTTOM\BASE BOARD

RIGID FOAM BOARD INSULATION - EXTEND A MINIMUM OF 2'-0" UNDER PERIMETER OF SLAB, MINIMUM R-VALUE OF R-15

RUN OF BANK GRAVEL (IF REQUIRED)

UNDISTURBED EARTH

RIGID FOAM BOARD INSULATION UNDER SLAB, MINIMUM R-VALUE OF R-10

3'-0" MIN.

2"

6'-0"

6'-6"

TYPICAL CONCRETE FLOOR SECTION

(RADIANT HEAT)

SCALE: 1" = 1'-0"

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