



<u>SITE DATA:</u>

ADDRESS: 4015 WEST LAKE ROAD, CANANDAIGUA, NY 14424 TAX ACCOUNT # 113.17-1-14

ZONING: RESIDENTIAL LAKE DISTRICT (RLD) LOT SIZE = 1.002 ACRES $(\pm 43,651 \text{ SF})$

PROPOSED HOUSE SIDE SETBACK

 $SIDE \ SETBACK = 14.91 \ FT / 15.74 \ FT$ $REAR \ SETBACK = 121.80 \ FT$ $FRONT \ SETBACK = 42.17 \ FT$ $BUILDING \ HEIGHT = 25.0 \ FT$

EXISTING LOT COVERAGE = 2,666.4 SF (6.11%)
PROPOSED LOT COVERAGE = 12,728.2 (29.16%)

 $\begin{array}{lll} DRIVEWAY & = 1,713.6 \ SF \ (3.926\%) \\ PATH \ TO \ FRONT \ DOOR & = 328.0 \ SF \ (0.751\%) \\ HOUSE & DECK & = 5,708.7 \ SF \ (13.08\%) \\ ROOF \ OVERHANG & = 459.2 \ SF \ (1.05\%) \\ WALKING \ PATH & = 1,391.9 \ SF \ (3.189\%) \\ \hline \end{array}$

 LOWER PATIO AREA
 = 250.0 SF (0.573%)

 STAIRS
 = 131.0 SF (0.300%)

 RETAINING WALL
 = 30.0 SF (0.069%)

 GRAVEL PAD FOR HVAC
 = 49.5 SF (0.113%)

 EXISTING BLDG. COVERAGE
 = 575.5 SF (1.32%)

 PROPOSED HOUSE & DECK
 = 5,708.7 SF (13.08%)

 TOTAL BLDG. COVERAGE
 = 6,284.2 SF (14.40%)

MAXIMUM BUILDING HEIGHT = 25 FT

MAXIMUM LOT COVERAGE = 22.5%

NOTE: INCLUDING 10% REDUCTION GIVEN

DEVELOPMENT IN STEEP SLOPE PROTECTION AREAS

MAXIMUM BUILDING COVERAGE = 15%

ANTICIPATED DISTURBED AREA = 29,700 SF (0.682 ACRES)

ANTICIPATED START OF CONSTRUCTION: SPRING 2021

\underline{LEGEND}

PROPERTY LINE
PROPOSED CONTOUR

EXISTING CONTOUR

----- SETBACK

SILT FENCE

— w — DOMESTIC WATER

— st — st — STORM PIPE

— SAN — SAN — SANITARY

— E — OVERHEAD ELECTRIC

EXISTING VEGETATION EXTENT

------ PROPOSED ELECTRIC SERVICE

DRIVEWAY / WALKING PATH

DRYWELL

↑ DISTURBED AREA BOUNDARY


LAND SLOPED GREATER THAN 10%

△ Æ EXISTING MONUMENTATION

UTILITY POLE

COPYRIGHT PROTECTION
UNAUTHORIZED USE, REPRODUCTION
AND/OR DISTRIBUTION OF THE
INFORMATION SHOWN HEREON IS
STRICTLY PROHIBITED. ANY SUCH
UNAUTHORIZED USE SHALL
INDEMNIFY AND HOLD HARMLESS
MEAGHER ENGINEERING FROM ALL
CLAIMS, LOSSES AND EXPENSES
ARISING THEREFROM. COPYRIGHT
MEAGHER ENGINEERING PLLC. 2013

-						
				10-15-20	DATE	
REVISIONS:				PRC COMMENTS	DESCRIPTION	
	Ш		о В	⋖	NO.	
20105	AXT	10-6-20	:D: WLM	10-6-20		

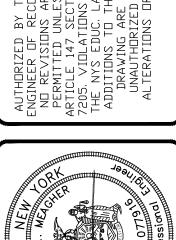




76 MCCOORD WOODS DRIVE
FAIRPORT, NEW YORK 14450

WETMAN SITE PLAN
4015 W. LAKE ROAD
SANANDAIGUA, NEW YORK 14424

ROJECT:

DRAWING NO.

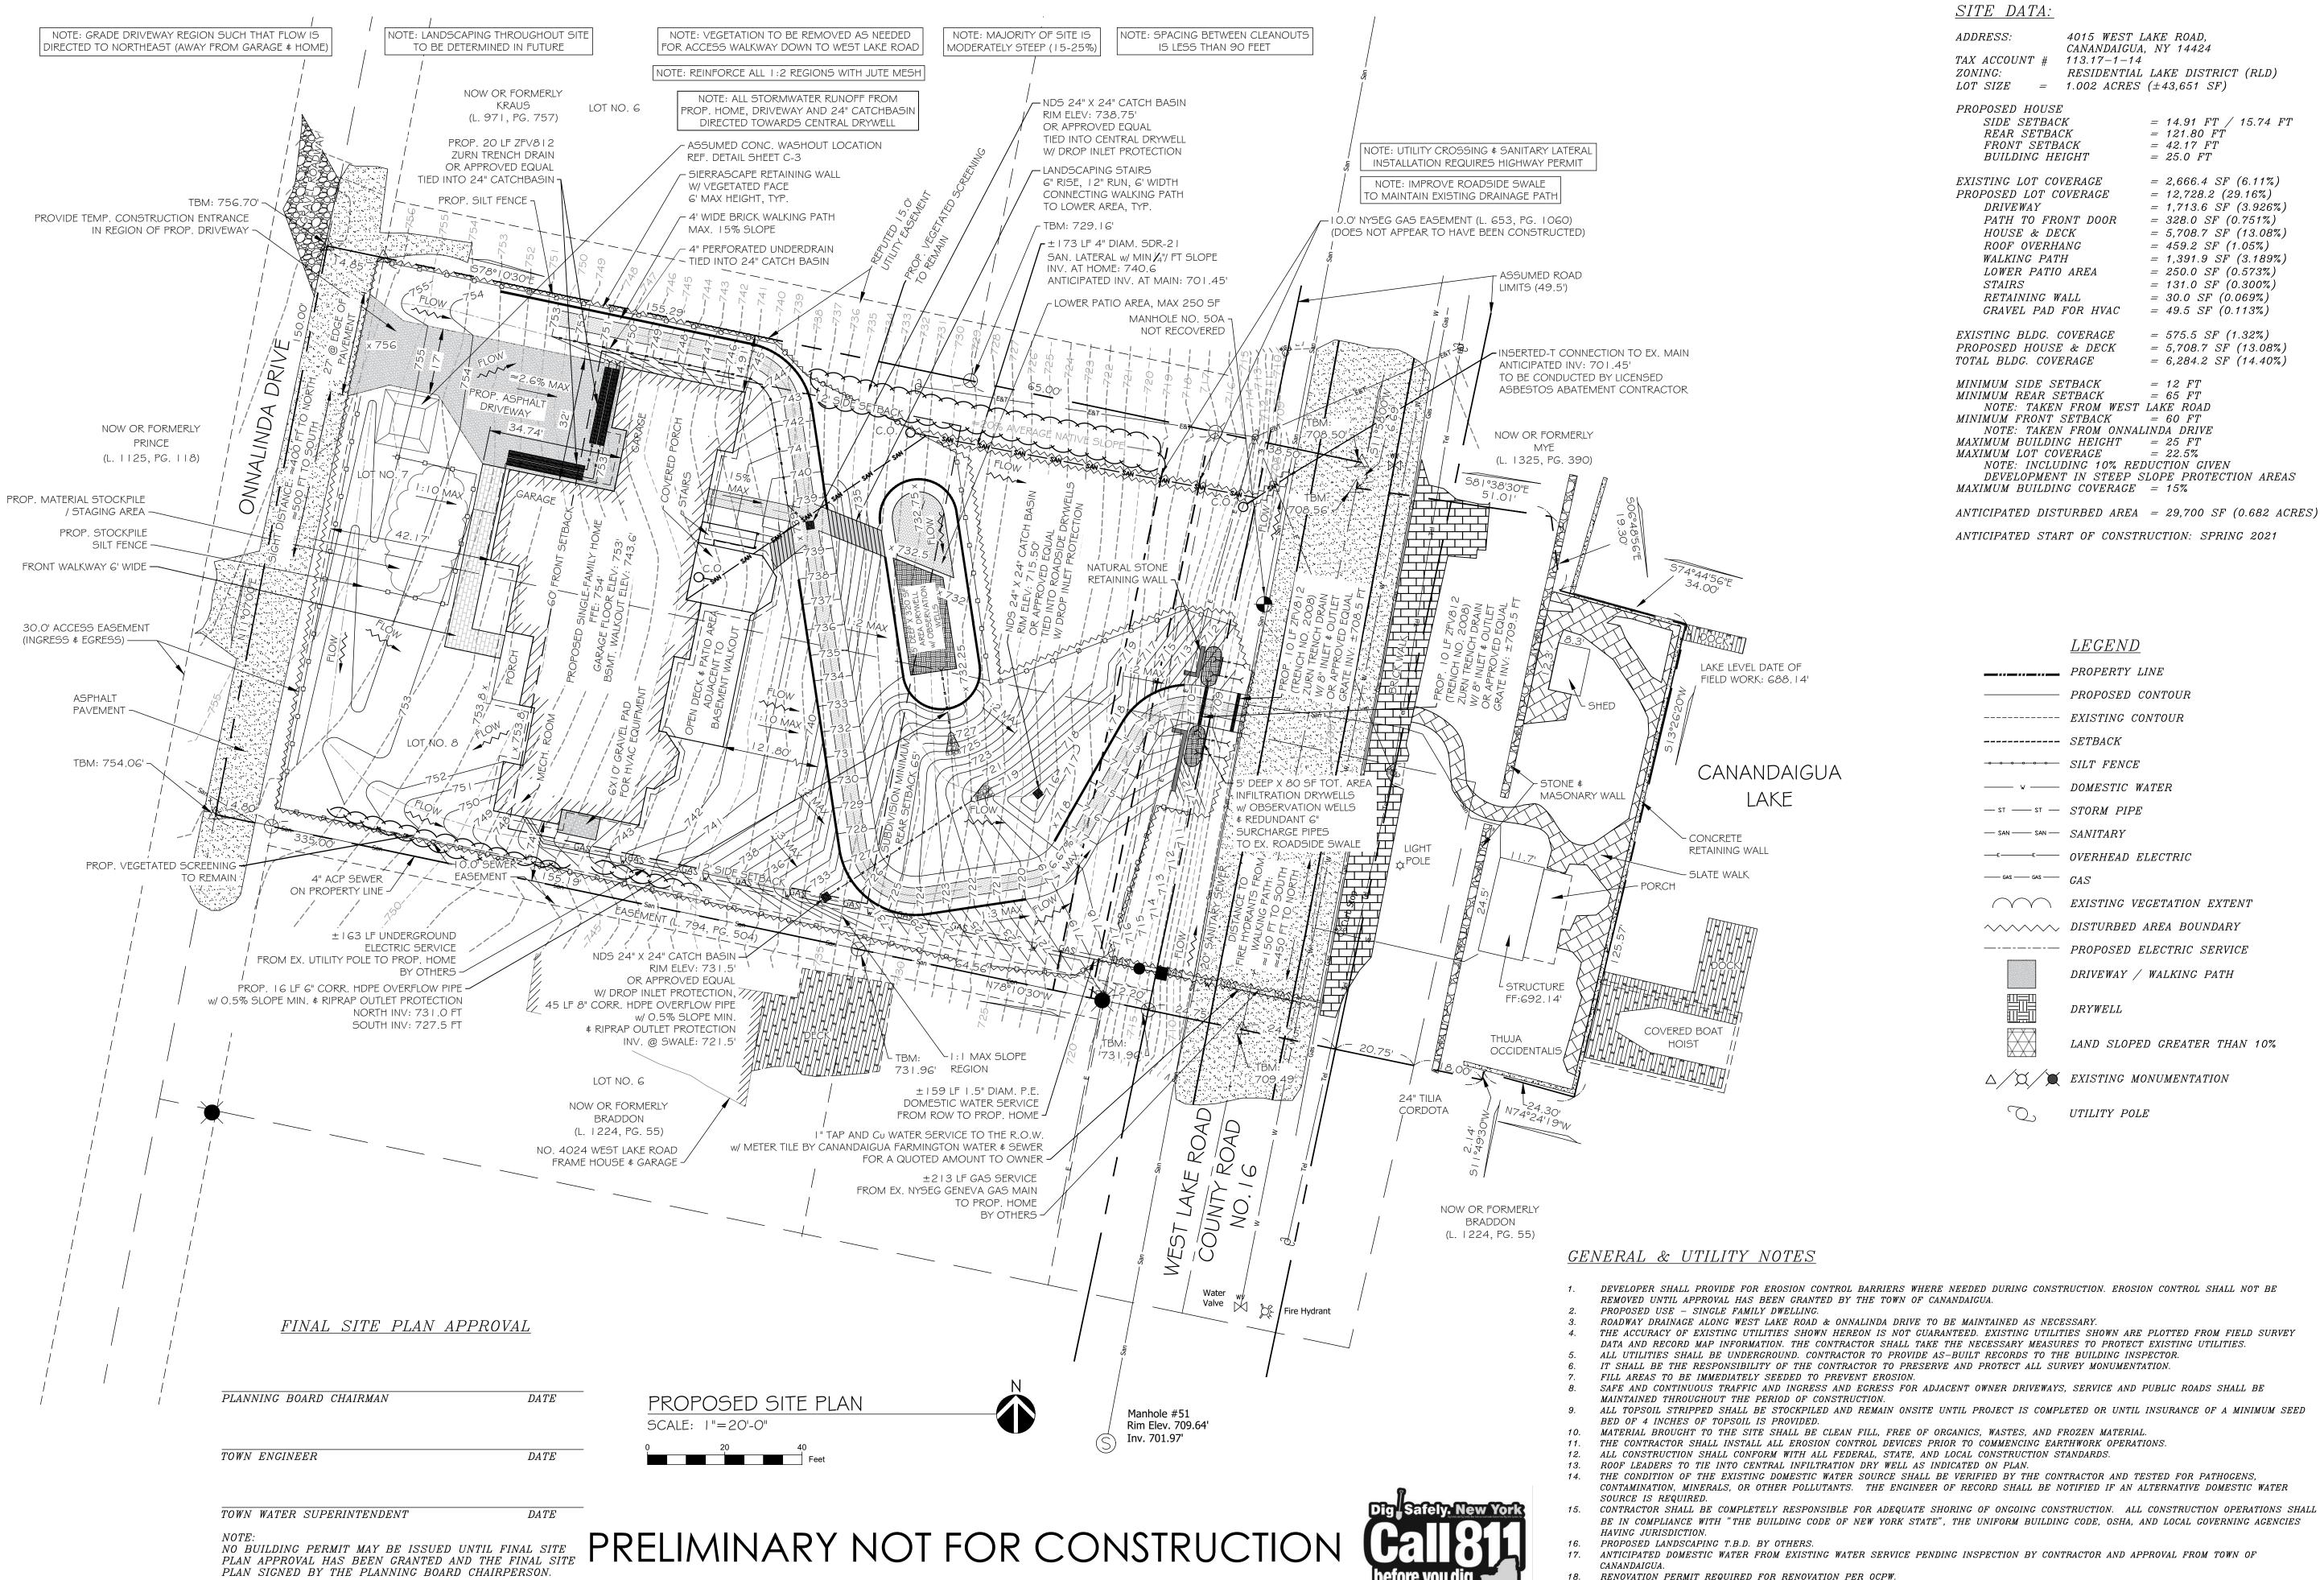

4015 WEST LAKE ROAD,

= 575.5 SF (1.32%)

CANANDAIGUA, NY 14424 TAX ACCOUNT # 113.17-1-14

RESIDENTIAL LAKE DISTRICT (RLD) $LOT SIZE = 1.002 ACRES (\pm 43,651 SF)$

 $= 14.91 \ FT / 15.74 \ FT$

 $= 121.80 \ FT$ = 42.17 FT= 25.0 FT= 2,666.4 SF (6.11%)

= 12,728.2 (29.16%)= 1,713.6 SF (3.926%)PATH TO FRONT DOOR = 328.0 SF (0.751%)= 5,708.7 SF (13.08%)= 459.2 SF (1.05%)= 1,391.9 SF (3.189%)

= 250.0 SF (0.573%)= 131.0 SF (0.300%)= 30.0 SF (0.069%)GRAVEL PAD FOR HVAC = 49.5 SF (0.113%)

PROPOSED HOUSE & DECK = 5,708.7 SF (13.08%)= 6,284.2 SF (14.40%)MINIMUM SIDE SETBACK MINIMUM REAR SETBACK = 65 FTNOTE: TAKEN FROM WEST LAKE ROAD MINIMUM FRONT SETBACK $= 60 \ FT$ NOTE: TAKEN FROM ONNALINDA DRIVE

 \underline{LEGEND}

■ PROPERTY LINE — PROPOSED CONTOUR

----- EXISTING CONTOUR

—— w —— DOMESTIC WATER

— SAN — SANITARY OVERHEAD ELECTRIC

EXISTING VEGETATION EXTENT

↑ DISTURBED AREA BOUNDARY

----- PROPOSED ELECTRIC SERVICE

DRIVEWAY / WALKING PATH

DRYWELL

LAND SLOPED GREATER THAN 10% EXISTING MONUMENTATION


UTILITY POLE

- DEVELOPER SHALL PROVIDE FOR EROSION CONTROL BARRIERS WHERE NEEDED DURING CONSTRUCTION. EROSION CONTROL SHALL NOT BE
- THE ACCURACY OF EXISTING UTILITIES SHOWN HEREON IS NOT GUARANTEED. EXISTING UTILITIES SHOWN ARE PLOTTED FROM FIELD SURVEY
- ALL UTILITIES SHALL BE UNDERGROUND. CONTRACTOR TO PROVIDE AS-BUILT RECORDS TO THE BUILDING INSPECTOR.
- ALL TOPSOIL STRIPPED SHALL BE STOCKPILED AND REMAIN ONSITE UNTIL PROJECT IS COMPLETED OR UNTIL INSURANCE OF A MINIMUM SEED
- MATERIAL BROUGHT TO THE SITE SHALL BE CLEAN FILL, FREE OF ORGANICS, WASTES, AND FROZEN MATERIAL.
- THE CONTRACTOR SHALL INSTALL ALL EROSION CONTROL DEVICES PRIOR TO COMMENCING EARTHWORK OPERATIONS.
- ALL CONSTRUCTION SHALL CONFORM WITH ALL FEDERAL, STATE, AND LOCAL CONSTRUCTION STANDARDS.
- THE CONDITION OF THE EXISTING DOMESTIC WATER SOURCE SHALL BE VERIFIED BY THE CONTRACTOR AND TESTED FOR PATHOGENS, CONTAMINATION, MINERALS, OR OTHER POLLUTANTS. THE ENGINEER OF RECORD SHALL BE NOTIFIED IF AN ALTERNATIVE DOMESTIC WATER
- CONTRACTOR SHALL BE COMPLETELY RESPONSIBLE FOR ADEQUATE SHORING OF ONGOING CONSTRUCTION. ALL CONSTRUCTION OPERATIONS SHALL BE IN COMPLIANCE WITH "THE BUILDING CODE OF NEW YORK STATE", THE UNIFORM BUILDING CODE, OSHA, AND LOCAL GOVERNING AGENCIES
- ANTICIPATED DOMESTIC WATER FROM EXISTING WATER SERVICE PENDING INSPECTION BY CONTRACTOR AND APPROVAL FROM TOWN OF
- RENOVATION PERMIT REQUIRED FOR RENOVATION PER OCPW. ALL NEW SITE LIGHTING SHALL BE DARK SKY COMPLIANT.

				10-15-20	DATE
REVISIONS:				PRC COMMENTS	DESCRIPTION
	Ш		<u>م</u> د	4	NO.
20105	AXT	10-6-20): WLM	10-6-20	
OB No.	3AWN:	ATE:	HECKED: WLM	ATE:	



DRAWING NO.

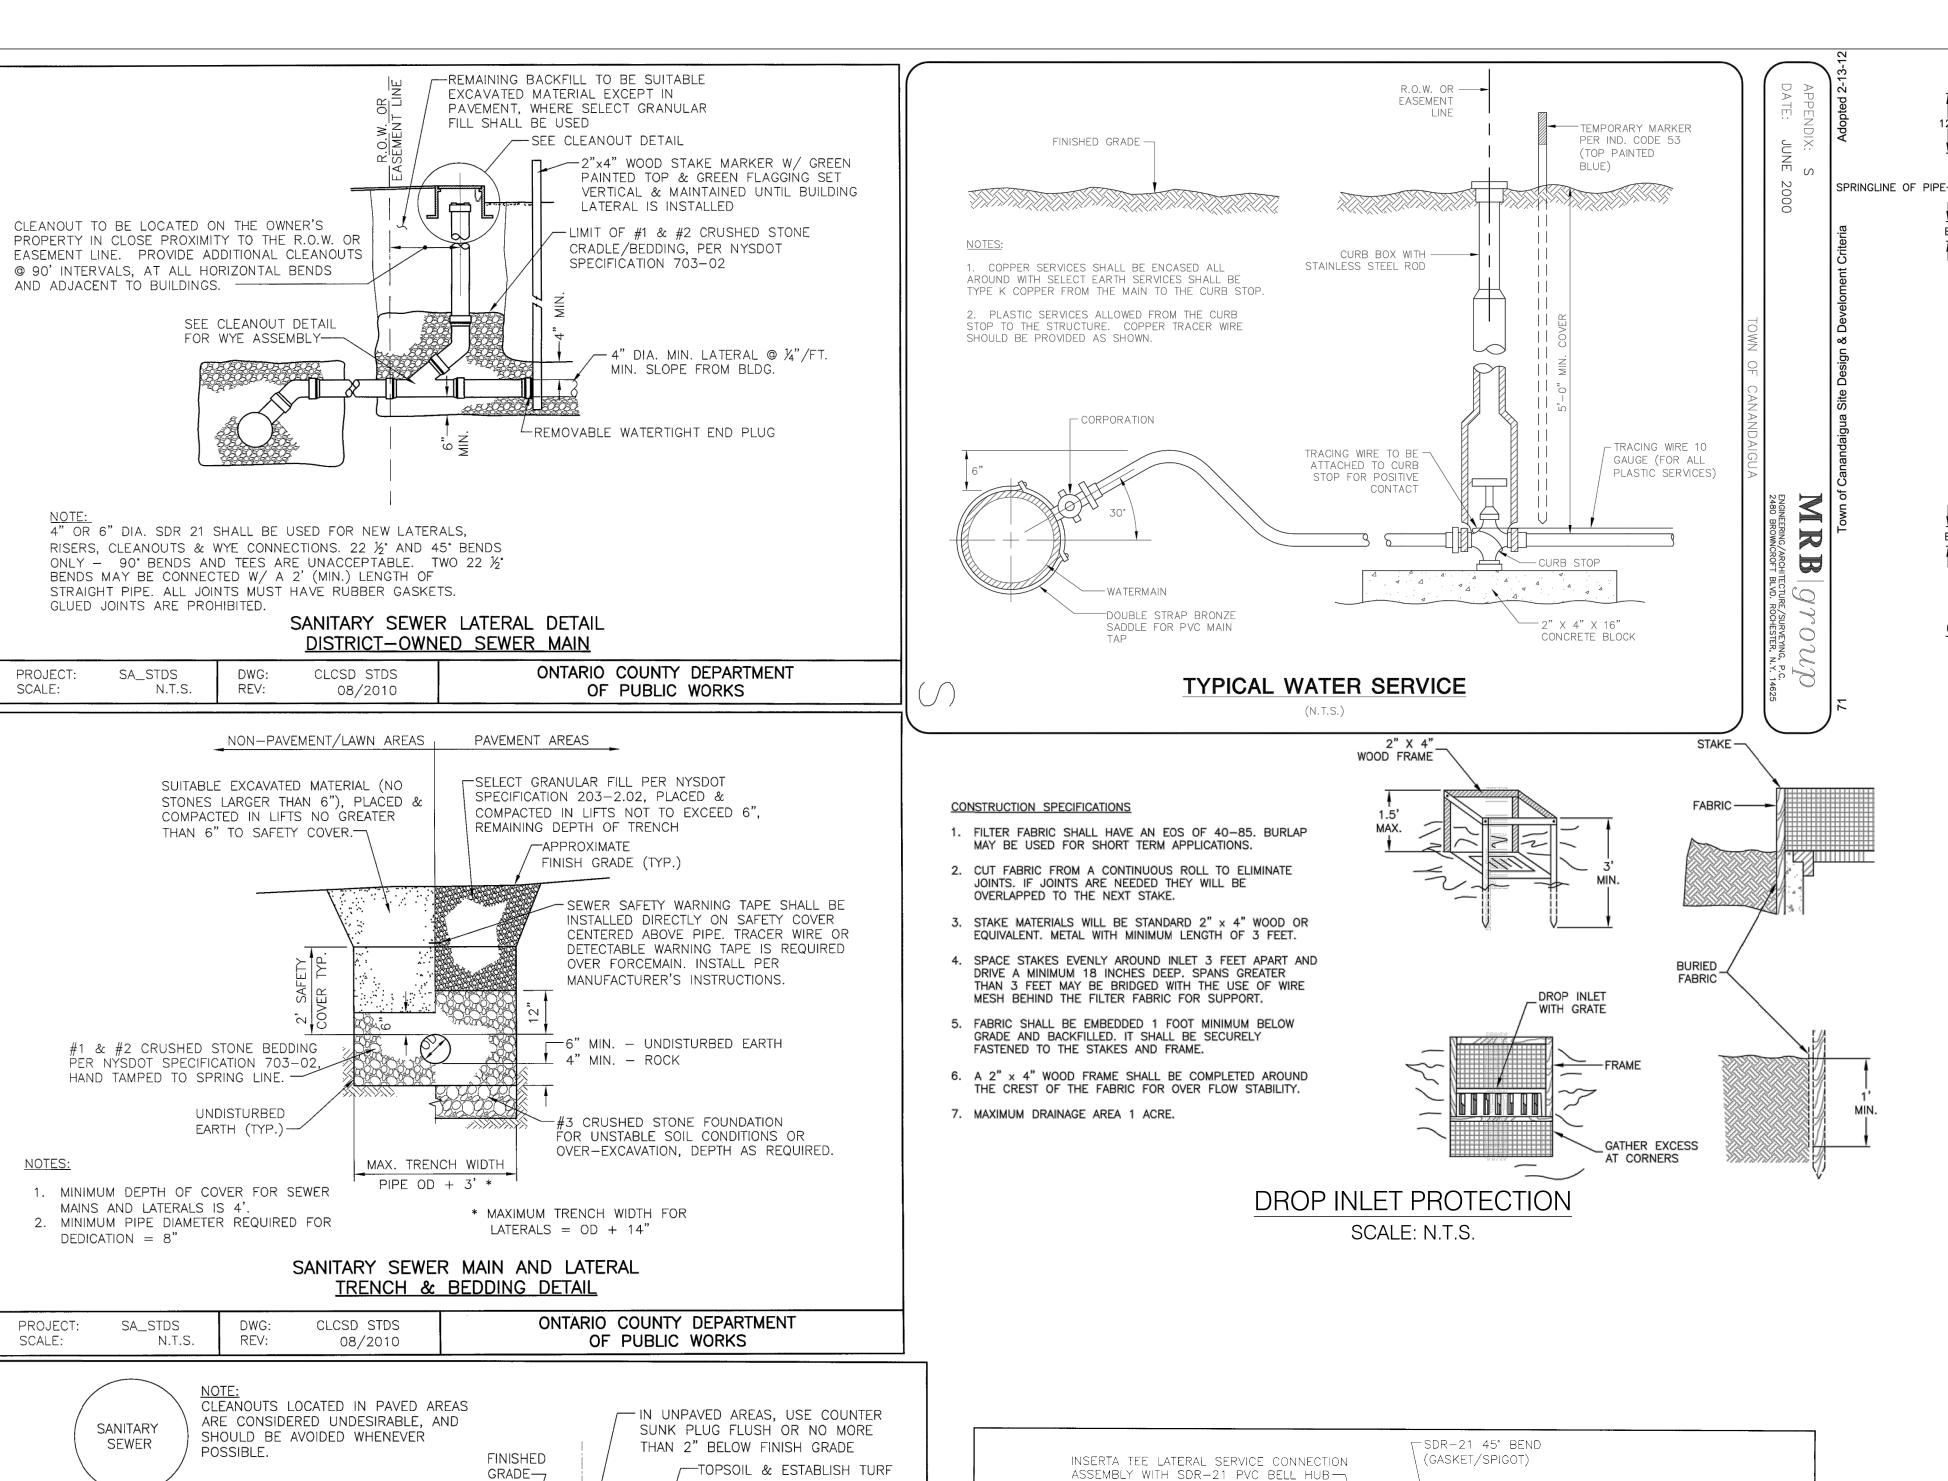

-PROVIDE PVC HUB ADAPTER &

BRASS OR PLASTIC SCREW PLUG

CLEANOUT PIPE - SDR-21 W/ELASTROMERIC JOINTS,

4" MIN. DIA.

-SUITABLE NATIVE

MATERIAL BACKFILL

-LIMIT OF #1 & #2 CRUSHED

STONE CRADLE/BEDDING

LONG SWEEP 45° BEND (2-

-SEWER LATERAL FROM BUILDING

'MIN. #1 & #2 CRUSHED STONE CRADLE PER NYSDOT

SPECIFICATION 703-02

ONTARIO COUNTY DEPARTMENT

OF PUBLIC WORKS

22 1/2" BENDS PERMISSIBLE WITH 2' LENGTH OF PIPE)

LETTERING ON COVER

10"

MIN.

SELECT GRANULAR

PROJECT:

SCALE:

BACKFILL TO SUBBASE-

CLEANOUT IN ASPHALT

GRADE

-SYRACUSE 4155 OR

W/FINISHED GRADE

DWG:

REV:

N.T.S.

APPROVED EQUAL FRAME &

SCH. 40 PVC. 4"x4" WYE (MIN.)

W/FACTORY SOLVENT WELDED IPS


CLCSD STDS


08/2010

SANITARY CLEANOUT DETAIL


GÁSKETED SPIGOT ADAPTERS ----

COVER INSTALLED FLUSH

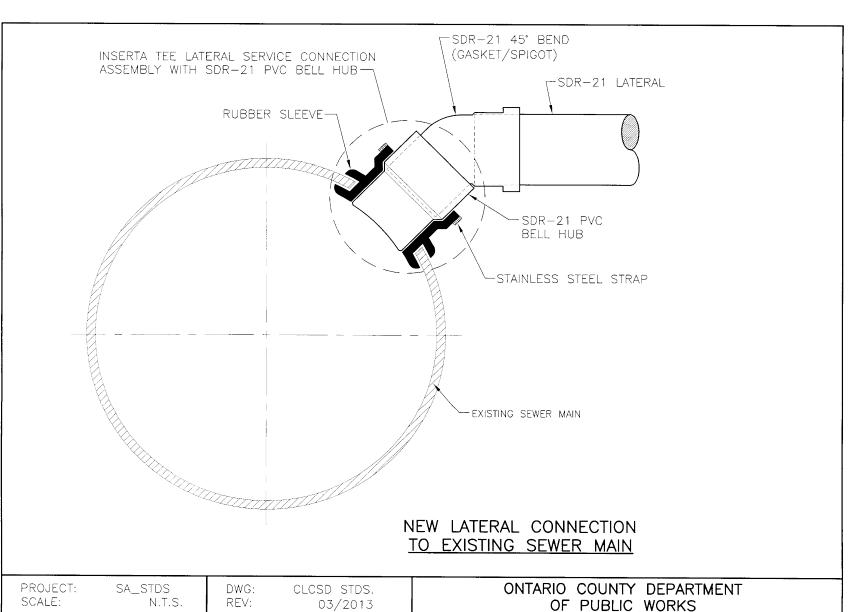

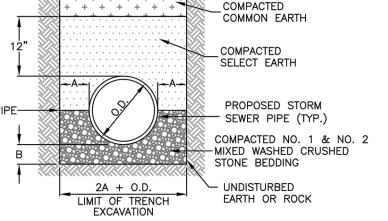

TYPICAL STORM BEDDING DETAIL

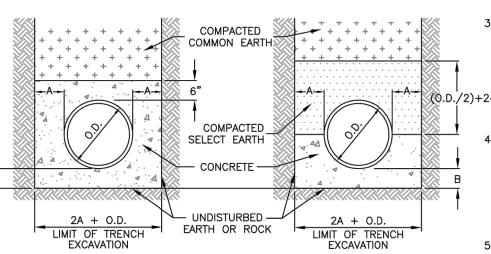

CONCRETE CRADLE CONCRETE ENCASEMENT

CULVERT PIPE UP TO 18" | 12" | 6" **BEDDING DETAILS** 21" TO 36" 18" 9" OVER 36" | 24" | 12"

SCALE: N.T.S.

NOTES:

PIPE DIA.

- 1. ALL STORM SEWER PIPE SHALL BE 12" MINIMUM PIPE DIAMETER, POLYVINYL CHLORIDE PIPE (PVC SDR-35) OR HEAVY DUTY CORRUGATE POLY-ETHYLENE (PE) SMOOTH INNER WALL TYPE D BELL & SPIGOT TYPE & RUBBER GASKET.
- ALL STORM LATERAL PIPE SHALL BE 4" MINIMUM PIPE DIAMETER, POLYVINYL CHLORIDE PIPE (PVC SDR-21), BELL & SPIGOT TYPE & RUBBER GASKET OR SCHEDULE 40.
- . SELECT EARTH SHALL BE SAND GRAVEL AND SIMILAR MATERIAL WHICH SHALL BE FREE FROM CLAY, LOAM, ORGANIC MATERIAL, DEBRIS, FROZEN MATERIAL AND SHALL CONTAIN ONLY SMALL AMOUNTS OF STONE, PEBBLES OR LUMPS OVER D./2)+24" ONE INCH IN GREATEST DIMENSION BUT NONE OVER TWO INCHES IN GREATEST DIMENSIONS.
 - STONE ENCASEMENT SHALL MEAN APPROVED IMPORTED AGGREGATE MEETING THE REQUIREMENTS OF THE NYSDOT, STANDARD SPECIFICATION, MAY 1, 2008 EDITION PAGES 7-14, SUBSECTION 703-0201 "CRUSHED STONE". PRIMARY SIZE OR A MIXTURE OF PRIMARY SIZES
- 5. CONCRETE SHALL BE CAST-IN-PLACE CLASS "A" MEETING NYSDOT SECTION 501


SANITARY LATERAL NOTES:

ALL PROJECTS

- 1. ALL SANITARY SEWER CONSTRUCTION AND/OR IMPROVEMENTS SHALL BE IN ACCORDANCE WITH THE MOST RECENT STANDARDS AND SPECIFICATIONS OF THE CANANDAIGUA LAKE COUNTY SEWER DISTRICT, N.Y.S. DEPARTMENT OF ENVIRONMENTAL CONSERVATION. N.Y.S. DEPARTMENT OF HEALTH. THE LATEST EDITION OF RECOMMENDED STANDARDS FOR WASTEWATER FACILITIES AND ANY OTHER AGENCIES HAVING JURISDICTION.
- 2. NO SANITARY SEWER-RELATED WORK MAY BE PERFORMED WITHOUT FIRST OBTAINING A WRITTEN PERMIT FROM THE CANANDAIGUA LAKE COUNTY SEWER DISTRICT.
- 3. DISTRICT PERSONNEL SHALL BE NOTIFIED A MINIMUM OF 48 HOURS PRIOR TO BEGINNING ANY SANITARY SEWER-RELATED WORK.
- 4. THE CONTRACTOR SHALL LOCATE, MARK AND PRESERVE ANY RIGHT OF WAY MONUMENTS OR SURVEY CONTROL IN THE AREA OF CONSTRUCTION.
- 5. UTILITY LOCATIONS SHOWN ARE APPROXIMATE ONLY. THE CONTRACTOR SHALL DETERMINE EXACT LOCATION OF UTILITIES, EXCAVATING TO EXPOSE THE UTILITY, IF NECESSARY IN THE AREA OF CONSTRUCTION, BEFORE COMMENCING CONSTRUCTION. CONTACT U.F.P.O. AT 1-800-962-7962 AT LEAST 72 HOURS PRIOR TO BEGINNING
- 6. LATERALS SHALL BE MIN. 4" DIA. SDR-21 WITH ELASTOMERIC JOINTS; FOR COMMERCIAL ESTABLISHMENTS, LATERALS ARE TO BE 6" DIA. SDR-21. MINIMUM DEPTH OF BURIAL IS FOUR FEET. CLEANOUTS SHALL BE INSTALLED WITHIN 30 INCHES OF THE OUTSIDE FACE OF BUILDINGS, AT ALL CHANGES IN HORIZONTAL ALIGNMENT, AT THE RIGHT OF WAY OR EASEMENT LINE, AND AT SPACING NOT TO EXCEED 90 FEET. IF EXISTING LATERAL IS SDR-35, THIS MATERIAL MAY BE REUSED IF DEEMED ACCEPTABLE BY OCPW DISTRICT STAFF.
- SEWER MAINS AND LATERALS SHALL BE LOCATED A MINIMUM HORIZONTAL DISTANCE OF TEN FEET FROM ANY EXISTING OR PROPOSED WATERMAIN (AS MEASURED FROM THE OUTSIDE OF THE SEWER/LATERAL TO THE OUTSIDE OF THE WATERMAIN). IN CASES WHERE THE MAIN OR LATERAL CROSSES A WATERMAIN, THE MINIMUM VERTICAL SEPARATION SHALL BE EIGHTEEN INCHES (MEASURED OUT-TO-OUT). THE CROSSING SHALL BE ARRANGED SO THAT THE SEWER JOINTS WILL BE EQUIDISTANT AND AS FAR AS POSSIBLE FROM THE WATERMAIN JOINTS.
- 8. THE CONTRACTOR SHALL PROVIDE THE DISTRICT WITH SHOP DRAWINGS AND MATERIAL SPECIFICATIONS THAT HAVE BEEN PRE-APPROVED BY THE DESIGN ENGINEER BEFORE A PERMIT WILL BE ISSUED.
- 9. THE CONTRACTOR IS RESPONSIBLE FOR COMPLIANCE WITH OSHA REQUIREMENTS IN ALL ASPECTS OF
- 10. THE CONTRACTOR SHALL BE RESPONSIBLE FOR MAINTAINING SANITARY FLOWS AT ALL TIMES BY METHODS ACCEPTABLE TO THE DISTRICT.
- 11. FLOOR DRAINS IN BASEMENTS OR GARAGES ARE TO BE CONNECTED TO THE SANITARY SEWER. FLOOR DRAINS DO NOT INCLUDE FOUNDATION OR FOOTER DRAINS INSTALLED TO INTERCEPT UNCONTAMINATED GROUNDWATER. ALL DISCHARGES TO THE SANITARY SEWER MUST COMPLY WITH EFFLUENT LIMITS OF THE ONTARIO COUNTY SEWER USE LAW. FOUNDATION AND FOOTER DRAINS SHALL BE CONSTRUCTED IN A MANNER THAT PROHIBITS
- 12. LATERAL CONNECTIONS REQUIRING OPENINGS IN ASBESTOS CEMENT PIPE WILL BE DESIGNED, INSPECTED AND CERTIFIED BY THE DESIGN ENGINEER OR REPRESENTATIVE THEREOF

GROUNDWATER FROM DRAINING INTO THE SANITARY SEWER PIPE CRADLE

- 13. ANY EXCAVATION NOT BACKFILLED BY THE END OF THE WORKDAY SHALL BE FENCED, BARRICADED AND LIGHTED FOR SAFETY AND PROTECTION OF THE PUBLIC.
- 14. THE CONTRACTOR SHALL BE RESPONSIBLE FOR THE REMOVAL OF EXISTING SANITARY MAINS, STRUCTURES AND
- APPURTENANCES, IF ANY, NEEDED TO COMPLETE THE WORK. 15. A FOUNDATION SLEEVE OF AT LEAST 6 INCHES IS REQUIRED FOR LATERALS THAT DON'T ENTER UNDER SLAB.
- 16. EXISTING LATERAL AND TAP MAY BE REUSED IF TELEVISED AND WITNESSED BY OCPW DISTRICT STAFF TO DETERMINE VIABILITY FOR REUSE.

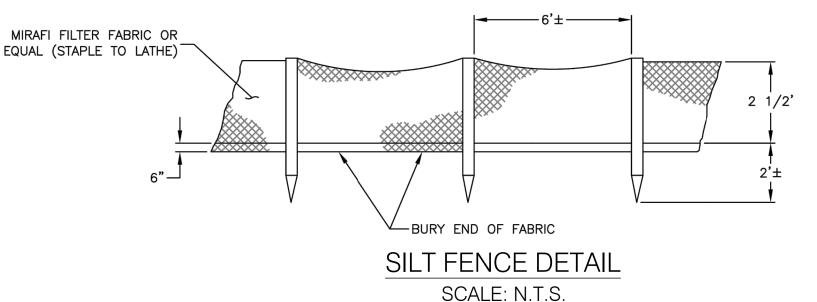

FINAL SITE PLAN APPROVAL

DATE

PRELIMINARY NOT FOR CONSTRUCTION TOWN ENGINEER DATE

TOWN WATER SUPERINTENDENT DATE

PLANNING BOARD CHAIRMAN

NO BUILDING PERMIT MAY BE ISSUED UNTIL FINAL SITE PLAN APPROVAL HAS BEEN GRANTED AND THE FINAL SITE PLAN SIGNED BY THE PLANNING BOARD CHAIRPERSON.


				10-15-20	DATE
REVISIONS:				PRC COMMENTS	DESCRIPTION
	Ш		o m	A	NO.
20105	AXT	10-6-20	CHECKED: WLM	10-6-20	




TMAN SITE 4015 W. LAKE RC NDAIGUA, NEW YO SWE

DRAWING NO.

3 of 5

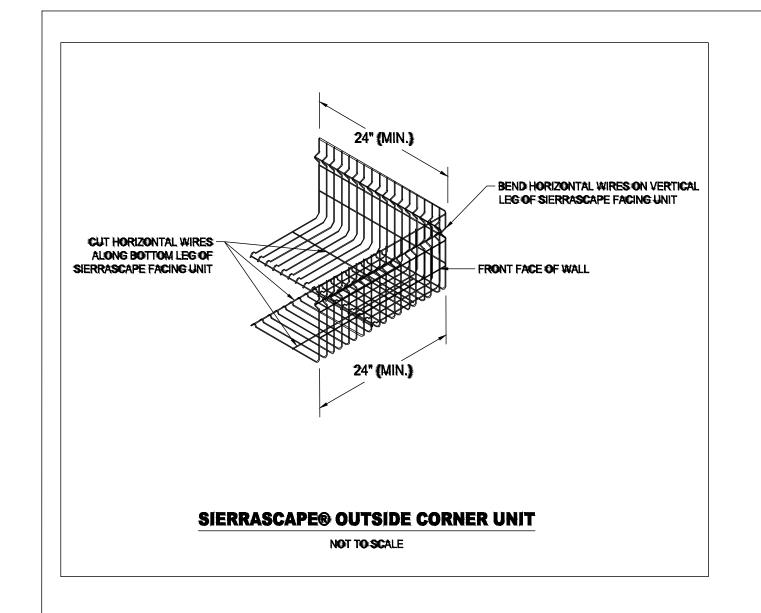

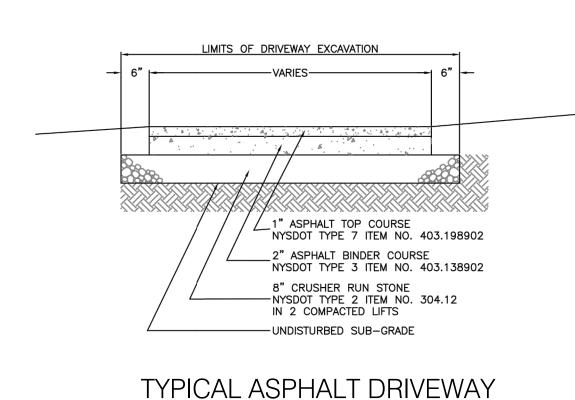

SCALE: N.T.S.

- SURCHARGE PIPE


- SPLASH BLOCK

TYP. DRY WELL

BANK

— RUN -

GRAVEL

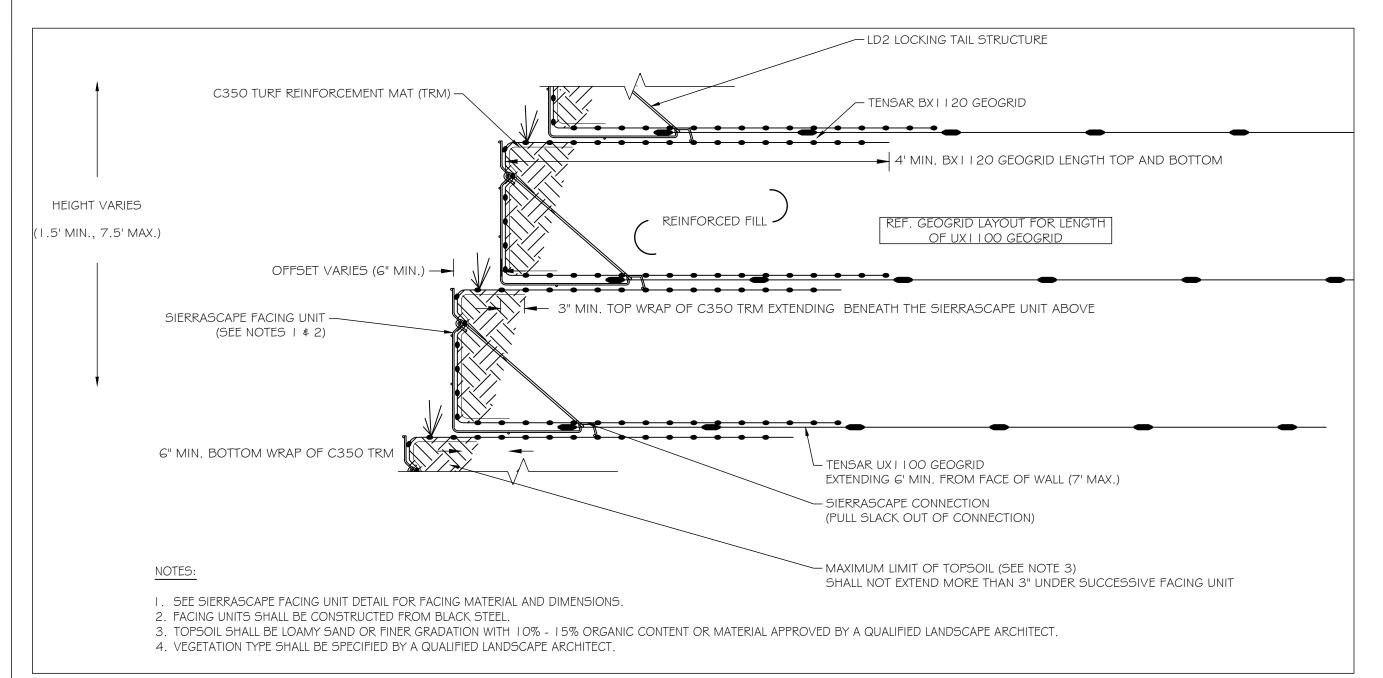

SIERRASCAPE FACING DETAIL (PLANTABLE FACE FILL)

SCALE: N.T.S.

- REMOVABLE WELL CAP

- UNDISTURBED SOIL -

— 6" DIAMETER PVC PIPE

%" DIAMETER REBAR ANCHOR

3'-0"

UNDISTURBED SOIL


GEOTEXTILE FILTER FABRIC

MINIMUM INFILTRATION RATE

9" SQUARE STEEL FOOT PLATE -

OBSERVATION WELL DETAIL

OF 0.50 INCH PER HOUR

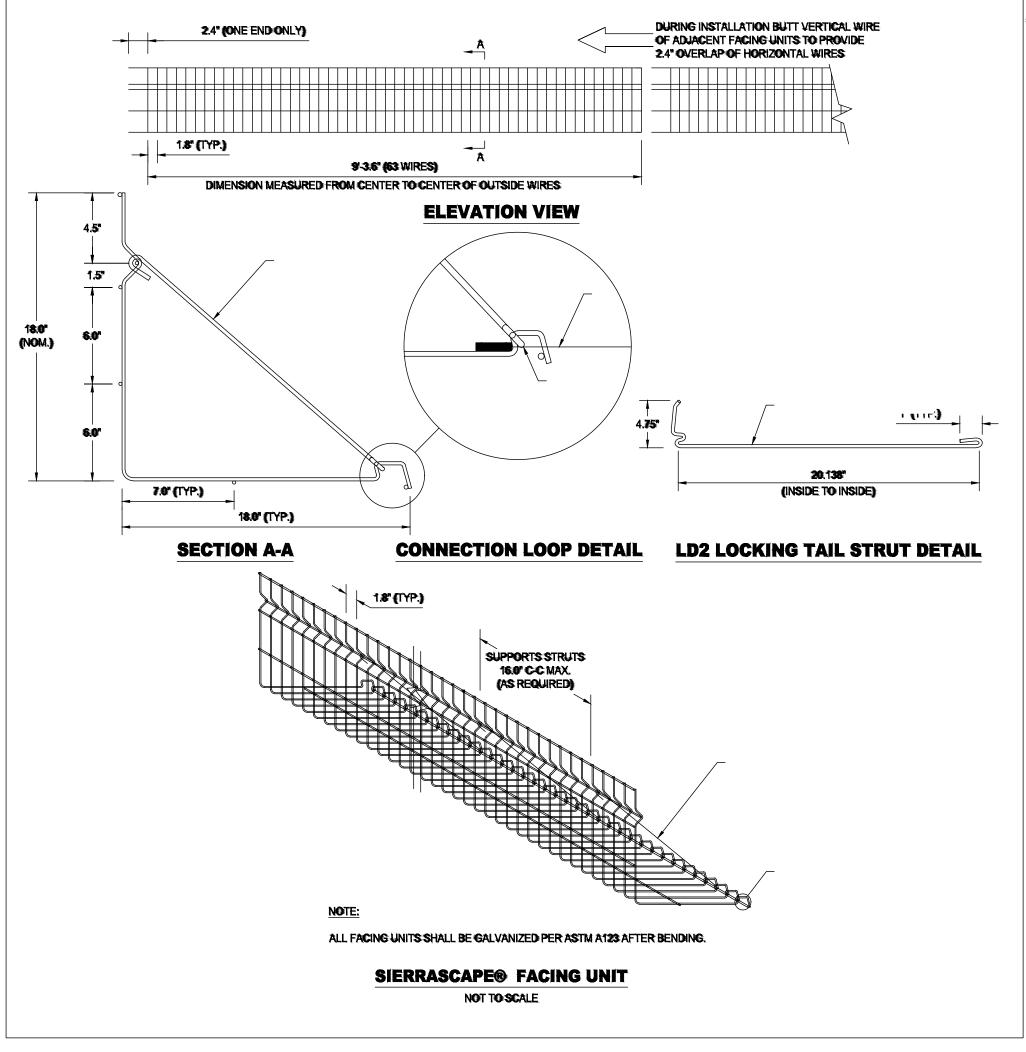

NOT FOR CONSTRUCTION

CONSTRUCTION ENTRANCE NOTES:

- CAP w/ SCREW TOP LID

AT GRADE

- FILTER FABRIC

- OBSERVATION WELL

- CONCRETE EQUIVALENT.
- 2. LENGTH AS REQUIRED, BUT NOT LESS THAN 50 FEET (EXCEPT ON A SINGLE RESIDENCE LOT WHERE A 30 FOOT MINIMUM LENGTH WOULD
- 3. THICKNESS NOT LESS THAN SIX (6) INCHES.
- 4. WIDTH TEN (10) FOOT MINIMUM, BUT NOT LESS THAN THE FULL WIDTH AT POINTS WHERE INGRESS OR EGRESS OCCURS.
- 5. FILTER CLOTH WILL BE PLACED OVER THE ENTIRE AREA PRIOR TO PLACING OF STONE. FILTER WILL NOT BE REQUIRED ON A SINGLE FAMILY RESIDENCE LOT.
- TOWARD CONSTRUCTION ENTRANCES SHALL BE PIPED ACROSS THE ENTRANCE. IF PIPING IS IMPRACTICAL, A MOUNTABLE BERM WITH 5:1 SLOPES WILL BE PERMITTED.
- 7. MAINTENANCE THE ENTRANCE SHALL BE MAINTAINED IN A CONDITION WHICH WILL PREVENT TRACKING OR FLOWING OF SEDIMENT ONTO PUBLIC RIGHTS-OF-WAY. THIS MAY REQUIRE PERIODIC TOP DRESSING WITH ADDITIONAL STONE AS CONDITIONS DEMAND AND REPAIR AND/OR CLEANOUT OF ANY MEASURES USED TO TRAP SEDIMENT. ALL SEDIMENT SPILLED, DROPPED, WASHED OR TRACKED ONTO PUBLIC RIGHTS-OF-WAY MUST BE REMOVED IMMEDIATELY.
- 8. WASHING WHEELS SHALL BE CLEANED TO REMOVE SEDIMENT PRIOR TO ENTRANCE ONTO PUBLIC RIGHTS-OF-WAY. WHEN WASHING IS REQUIRED, IT SHALL BE DONE ON AN AREA STABILIZED WITH STONE
- 9. INSPECTION PERIODIC INSPECTION AND NEEDED MAINTENANCE SHALL BE PROVIDED AFTER EACH RAIN.

ANTICIPATED CONSTRUCTION SEQUENCE:

- INSTALL PERIMETER SEDIMENT CONTROLS, (I.E. SILT FENCE).
- PROTECT VEGETATION TO REMAIN.
- CLEAR AND REMOVE VEGETATION FROM SITE WHERE NECESSARY
- CONSTRUCT SWALES, DRY WELLS, AND INSTALL DRAINAGE INLETS AND STORM PIPING.
- CONSTRUCT HOUSE STRUCTURE AND RETAINING WALL SYSTEMS
- INSPECT ALL EROSION CONTROL DEVICES DAILY AND REPAIR AS
- RESTORE AREAS AS DEFINED BY CONTRACT DOCUMENTS.
- REMOVE EROSION CONTROL MEASURES AS AREAS REESTABLISH WITH GROUND COVER.
- IF SITE PREPARATIONS OCCUR BETWEEN SEPTEMBER 1 AND MARCH 31, ADDITIONAL EROSION CONTROLS MUST BE TAKEN INCLUDING REDUCING THE SIZE OF DISTURBED AREAS AND PLACING HEAVY STRAW MULCH WHERE PRACTICAL.

EROSION CONTROL NOTES


- NO FILLING, CONSTRUCTION, OR STORING OF MATERIALS ON SITE WILL BE ALLOWED UNTIL EROSION CONTROL MEASURES ARE IN PLACE AS SHOWN, DESCRIBED AND DETAILED ON THIS SHEET.
 - NO PAYMENT REQUESTS WILL BE ACCEPTED UNLESS THE EROSION CONTROL MEASURE REQUIREMENTS STIPULATED ON THIS PLAN HAVE BEEN ADHERED TO. EROSION CONTROL MEASURES ARE TO BE TO THE SATISFACTION THE TOWN OF CANANDAIGUA AND THEIR ENGINEER.
 - EXISTING UNDERGROUND UTILITIES SHOWN HEREON WERE PLOTTED FROM FIELD LOCATIONS AND/OR UTILITY COMPANY RECORD PLANS. PRIOR TO ANY CONSTRUCTION. THE CONTRACTOR SHALL CALL THE UFPO HOTLINE AT 1 (800) 962-7962 FOR STAKEOUT OF EXISTING UTILITIES.
- EROSION CONTROL DEVICES ARE TO BE ESTABLISHED PRIOR TO COMMENCING EARTHWORK. EROSION CONTROL DEVICES TO BE MAINTAINED BY THE CONTRACTOR PER THE SPECIFICATIONS UNTIL UPSTREAM GROUND COVER HAS BEEN ESTABLISHED AND REMOVAL IS APPROVED BY THE TOWN OF CANANDAIGUA AND THEIR ENGINEER. THE CONTRACTOR WILL BE RESPONSIBLE FOR REPLACING ANY SILT FENCE THAT HAS BECOME CLOGGED, INOPERABLE OR DAMAGED. SILT FENCE SHALL BE INSPECTED DAILY FOR REPLACEMENT. REPLACEMENT WILL BE AS NECESSARY OR AS DIRECTED BY THE TOWN OF CANANDAIGUA AND THEIR ENGINEER.
- THE CONTRACTOR SHALL TAKE SPECIAL CARE NOT TO ALLOW SILT RUNOFF ONTO ADJOINING PROPERTIES OR CANANDAIGUA LAKE. THIS MAY INCLUDE THE USE OF INTERCEPTOR SWALES, STRAW WATTLES AND/OR CRUSHED STONE FILTERS. THE CONTRACTOR WILL ALSO BE RESPONSIBLE FOR CLEANING THE ADJACENT STREETS. GUTTERS AND/OR DOWNSTREAM STORM SEWERS ARE NECESSARY OR AS DIRECTED BY THE TOWN OF CANANDAIGUA AND THEIR ENGINEER. DISTURBED AREAS ARE TO BE SEEDED UPON COMPLETION OF THE EARTHWORK AND
- SLOPES SHALL NOT EXCEED 1' VERTICAL TO 3' HORIZONTAL WITHOUT SLOPE REINFORCEMENT PER SITE PLANS.

FINAL SITE PLAN APPROVAL

PLANNING BOARD CHAIRMAN TOWN ENGINEER

TOWN WATER SUPERINTENDENT


NO BUILDING PERMIT MAY BE ISSUED UNTIL FINAL SITE PLAN APPROVAL HAS BEEN GRANTED AND THE FINAL SITE PLAN SIGNED BY THE PLANNING BOARD CHAIRPERSON.

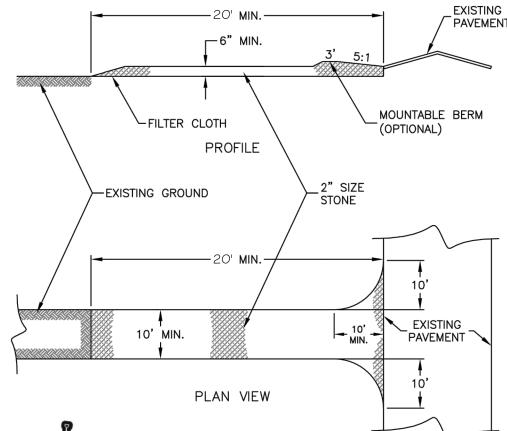



PAVEMENT



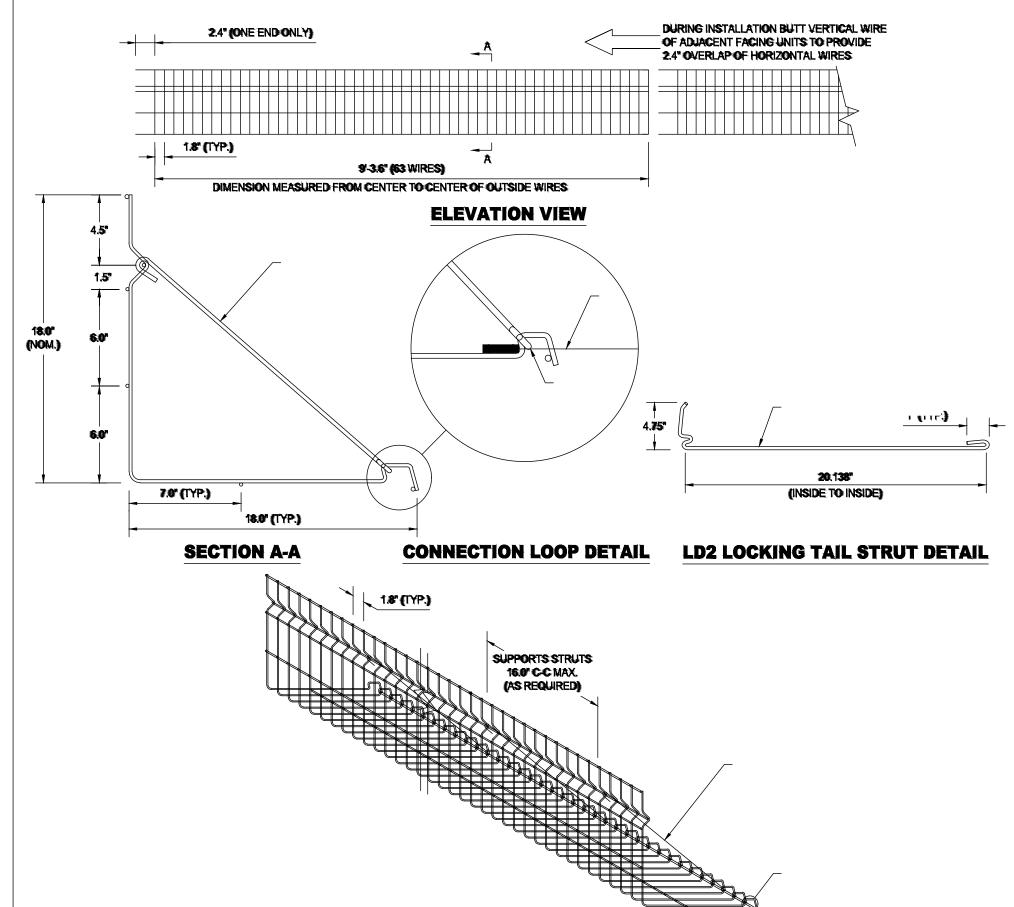

PRELIMINARY


- 1. STONE SIZE USE 2" STONE, OR RECLAIMED OR RECYCLED

- 6. SURFACE WATER ALL SURFACE WATER FLOWING OR DIVERTED
- AND WHICH DRAINS INTO AN APPROVED SEDIMENT TRAPPING DEVICE.

CONSTRUCTION ENTRANCE DETAIL

SWE

DRAWING NO.

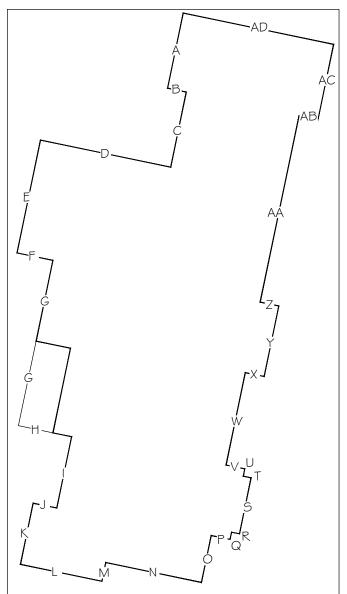

PRELIMINARY

NOT FOR

CONSTRUCTION

			AVE	RAGE G	RADE		
SIDE	LENGTH (α)	GRADE 1	GRADE 2	GRADE 3	GRADE 4	AVE. GRADE (β)	αχβ
Α	16	753			753	753.0	12048.0
В	4	753			753	753.0	3012.0
С	16	753			753	753.0	12048.0
D	27.67	753			753	753.0	20835.5
Ε	24	753			753	753.0	18072.0
F	7.67	753			753	753.0	5775.5
G	35.17	753			753	753.0	26483.0
Н	11.33	753			753	753.0	8531.5
l	15.17	753			753	753.0	11423.0
J	5	753			752	752.5	3762.5
K	13	752			749	750.5	9756.5
L	17.33	749			745	747.0	12945.5
М	4	745			745	745.0	2980.0
N	20.33	745	745	744	743	744.3	15130.6
0	10	743			742.33	742.7	7426.7
Р	4	742.33			742.33	742.3	2969.3
Q	1.54	742.33			742.33	742.3	1143.2
R	1.67	742.33			742.33	742.3	1239.7
S	11.92	742.33			742.33	742.3	8848.6
Т	1.67	742.33			742.33	742.3	1239.7
U	1.54	742.33			742.33	742.3	1143.2
V	4	742.33			742.33	742.3	2969.3
W	19.67	742.33			742.33	742.3	14601.6
Χ	4	742.33			742.33	742.3	2969.3
Υ	15	742.33			742.33	742.3	11135.0
Z	4	742.33			742.33	742.3	2969.3
AA	39.67	742.33			742.33	742.3	29448.2
AB	4	742.33			742	742.2	2968.7
AC	16	742			745	743.5	11896.0
AD	32	745			753	749.0	23968.0
TOTAL	387.35						289739.4
AVERA	GE GRADE =	289	739.4		387.4 =	748.	0
						7/19 00)// 1

	AVENAGE GNADE - 203	7733.4	367.4 =	740.0
				748.0041
	TOP OF ROOF (FT)	773		
	BUILDING HEIGHT (FT)	25.00		

AVERAGE GRADE / BUILDING HEIGHT CALCS

FINAL SITE PLAN APPROVAL

DATE

DATE

PLANNING BOARD CHAIRMAN

TOWN ENGINEER

TOWN WATER SUPERINTENDENT

NOTE: NO BUILDING PERMIT MAY BE ISSUED UNTIL FINAL SITE PLAN APPROVAL HAS BEEN GRANTED AND THE FINAL SITE PLAN SIGNED BY THE PLANNING BOARD CHAIRPERSON.

Dig Safely. New York

Call 811

before you dig

LOT SIZE (SF)	43651.95	NOTE: NOT	^r INCLUDII	IG EASEN	IENT ON W	EST SIDE (C	NNALINDA	ACCESS)	AND ROW	FOR WEST	LAKE ROAI)				
LOT SIZE (ACRES)	1.002	NOTE: PER	CORRESP	ONDENCE	WITH ERIC	COOPER 8-	27-20, NO	TINCLUDIN	IG LOT AR	EA WITHIN	ROW / EAS	SEMENTS F	OR WEST I	LAKE ROAL	ONNALIN	VDA DRIVE
BUILDING COVERAGE (SF)	6547.8	NOTE: 15%	NOTE: 15% ACCORDING TO ZONING SCHEDULE FOR RLD LOT OF THIS SIZE													
EXISTING BUILDING COVERAGE (SF)	575.5	1.318%														
	SHED (SF)	102.95	0.236%											T		
	STRUCTURE (SF)	472.55	1.083%													
EXISTING LOT COVERAGE EXCLUDING EXISTING STRUCTURES (SF)	2090.9															
	RETAINING WALL (SF)	425.74	0.975%													
	PARKING AREA (SF)	428.38	0.981%													
	WALKWAY / PATIO (SF)	1236.73	2.833%													
PROPOSED DEVELOPMENT (SF)	10061.84															
	DRIVEWAY (SF)	1713.56	3.926%	NOTE: NO	OT INCLUDI	NG ROOF C	VERHANG	OVERLAP;	INCLUDES	TRENCH D	RAINS IN L	DRIVEWAY				
	PATH TO FRONT DOOR (SF)	328.04	0.751%	NOTE: NO	OT INCLUDI	NG ROOF C	VERHANG	OVERLAP								
	HOUSE & DECK (SF)	5708.65	13.078%	NOTE: IN	CLUDES BA	CK DECKS A	ND STAIRS	LEADING	DOWN TO	SITE						
	ROOF OVERHANG (SF)	459.24	1.052%	NOTE: IN	CLUDES EV	ERYTHING I	PAST BUILD	ING FOOT	PRINT							
	WALKING PATH - IMPERMEABLE (SF)	1391.87	87 3.189% NOTE: NEED TO MANUALLY ADJUST VALUE IN FORMULA													
	LOWER PATIO AREA (SF)	250	0.573% NOTE: SITUATED BETWEEN WALKING PATH LANDING AT WEST LAKE ROAD AND INTESECTION OF STAIRS WITH UPPER WALKING PATH													
	STAIRS (SF)	131.01	31.01 0.300% NOTE: NOT INCLUDING DECK STAIRS (STAIRS BETWEEN WALKING PATH LANDING BY SCREENED PORCH) & ROOF OVERHANG OVERLAP							VERLAP						
	RETAINING WALL (SF)	30	0.069%	NOTE: OI	NLY INCLUE	DING ENTRY	AREA FRO	M WEST LA	KE ROAD							
	GRAVEL PAD FOR HVAC (SF)	49.47	0.113%	NOTE: NO	OT INCLUDI	NG AREA V	/ITHIN ROC	OF OVERHA	NG							
PROPOSED BUILDING COVERAGE (SF)	6284.15	14.396%														
PROPOSED BUILDING COVERAGE (ACRE)	0.144															
PROPOSED LOT COVERAGE (SF)	12728.19	29.158%														
·																
ALLOWABLE BUILDING COVERAGE (%)	15%	NOTE: 15%	ACCORDI	NG TO ZO	NING SCHE	DULE FOR F	RLD LOT OF	THIS SIZE								
ALLOWABLE LOT COVERAGE (%)	25%	NOTE: 25%	ACCORDI	NG TO ZO	NING SCHE	DULE FOR F	RLD LOT OF	THIS SIZE								
EDUCED ALLOWABLE LOT COVERAGE (%)	22.5%	NOTE: ASS	UMING 50	% OF DIST	URBANCE '	WILL BE LO	CATED IN S	TEEP SLOP	E PROTECT	ION AREA						

COPYRIGHT PROTECTION
NAUTHORIZED USE, REPRODUCTION
ND/OR DISTRIBUTION OF THE
IFORMATION SHOWN HEREON IS
TRICTLY PROHIBITED. ANY SUCH
NAUTHORIZED USE SHALL
IDEMNIFY AND HOLD HARMLESS
EAGHER ENGINEERING FROM ALL
LAIMS, LOSSES AND EXPENSES
RISING THEREFROM. COPYRIGHT
EAGHER ENGINEERING, PLLC, 2013

	5 REVISIONS:	В	20 D	<u>م</u> د	20 A PRC COMMENTS 10-15-20	NO. DESCRIPTION DATE
	20105	AXT	10-6-20 D	WLM B	10-6-20 A	ON
	JOB NO.	DRAWN:	DATE:	CHECKED: WLM	DATE:	

AUTHORIZED ENGINEER OF NO REVISION PERMITTED URINITED URINITED URINITED URINITED URINITED THE NYS EDUCATION OF PROPERTIES OF NO PROPERTIONS TO DEAVING UNAUTHORION ALTERATION ALTERATION



JIM & COLLEEN SWETMAN
76 MCCOORD WOODS DRIVE
FAIRPORT, NEW YORK 14450
4015 W. LAKE ROAD
JANDAIGUA, NEW YORK 14424

PROJECT:

DRAWING NO.

C-5

5 of 5