4885 COUNTRY ROAD 16 (WEST LAKE ROAD)

TOWN OF CANANDAIGUA

ONTARIO COUNTY - STATE OF NEW YORK

LIST O	F DRAWINGS
L0.0	COVER SHEET
L0.1	EXISTING CONDITIONS PLAN
L0.2	EXISTING SLOPES PLAN
L1.0	SITE PLAN
L2.0	GRADING PLAN
L2.1	TENNIS COURT ENLARGEMENT PLAN
L3.0	PLANTING PLAN
L4.0	SITE AND PLANTING DETAILS
C1.1	SITE DRAINAGE AND EROSION CONTROL PLAN
C1.2	SITE DRAINAGE AND EROSION CONTROL DETAILS
A1.1	TENNIS COURT PAVILION (JAMES FAHY DESIGN)
·	

ZONING CHART - TOWN	OF CANANDAIGUA
ZONING DISTRICT: RESIDENTIA	AL LAKE DISTRICT (RLD)
MIN. LOT SIZE	20,000 SQ. FT
MIN. LOT WIDTH	125 FT.
MIN. FRONT YARD SETBACK	60 FT.
MIN. REAR YARD SETBACK	60 FT.
MIN. SIDE YARD SETBACK	12 FT.
MIN. REAR YARD SETBACK (ACCESSORY)	15 FT.
MAX. BUILDING HEIGHT	25 FT.
MAX. BUILDING COVERAGE ON LOT	15%
MAX. LOT COVERAGE	25%





LOT COVERAGE CALCULATIONS

LOT COVERAGE CALCULATIONS	SQ. FT
MAIN HOUSE AND GARAGES	6735
CARRIAGE HOUSE	970
BEACH HOUSE	1106
WINDOW WELL WALL	33
SOUTH STONE WALL	293
MAIN HOUSE REAR PATIO (AND NEW STEPS)	861
LAKEFRONT SOUTH LEDGESTONE RET. WALL	75
LAKEFRONT BREAKWALLS	989
BEACH HOUSE PATIO AND WALKWAY	846
BEACH HOUSE TIMBER / STONE WALLS	1306
TRAM PATIO, PATH, AND WALLS	910
UPPER PATIO CONCRETE	845
UPPER PATIO - STAIRS AND WALL <u>ONLY</u>	200
WOODLAND STONE RET. WALLS	383
WOODLAND STAIRS	454
AUTOCOURT TIMBER / BOULDER WALLS	1083
ROADSIDE BERM RET. WALL	325
FRAME GARAGE PATIO	121
SOUTH SIDE SERVICE AREA (GRAVEL)	493
BOARDWALK TO THE BOAT STATION	296
LOWER TERRACE, WALLS, AND STAIRS	834
LOWER DRIVEWAY	797
UPPER DRIVEWAY	6218
BOULDER RAMP EDGE	161
LAKE ACCESS STAIRS	252
AUTOCOURT PAVING, PORCHES, AND GARAGE WALKWAYS	4350
AUTOCOURT STONE RET. WALL	134
TOTAL COVERAGE	31070
TOTAL SITE AREA	145186
BUILDING COVERAGE	6%
TOTAL LOT COVERAGE	21%

LOT COVERAGE CALCULATIONS	SQ. FT
MAIN HOUSE AND GARAGES	6735
CARRIAGE HOUSE	970
BEACH HOUSE	1106
WINDOW WELL WALL	33
SOUTH STONE WALL	293
MAIN HOUSE REAR PATIO (AND NEW STEPS)	861
LAKEFRONT SOUTH LEDGESTONE RET. WALL	75
LAKEFRONT BREAKWALLS	989
BEACH HOUSE PATIO AND WALKWAY	846
BEACH HOUSE TIMBER / STONE WALLS	1306
TRAM PATIO, PATH, AND WALLS	910
UPPER PATIO CONCRETE	845
UPPER PATIO - STAIRS AND WALL <u>ONLY</u>	200
WOODLAND STONE RET. WALLS	383
WOODLAND STAIRS	454
AUTOCOURT TIMBER / BOULDER WALLS	1083
ROADSIDE BERM RET. WALL	325
ROADSIDE BERM RET. WALL EXTENSION	42
FRAME GARAGE PATIO	121
FRAME GARAGE PATIO ACCESS WALK	86
FRAME GARAGE GRAVEL DRIVE W/ LAWN STRIPS	740
SOUTH SIDE SERVICE AREA (GRAVEL)	493
BOARDWALK TO THE BOAT STATION	296
LOWER TERRACE, WALLS, AND STAIRS	834
LOWER DRIVEWAY	797
IMPROVED UPPER DRIVEWAY	4513
CAR PULL-OFF AREA	311
BOULDER RAMP EDGE	161
LAKE ACCESS STAIRS	252
AUTOCOURT PAVING, PORCHES, AND GARAGE WALKWAYS	4350
AUTOCOURT STONE RET. WALL	134
TENNIS COURT	7000
TENNIS COURT ACCESS WALK	303
TENNIS COURT PAVILION AND STEPS	405
TENNIS COURT PAVILION RETAINING WALL	35
TENNIS COURT HITTING WALL	149
TENNIS COURT ENCLOSURE CURB	227
TENNIS COURT ACCESS STAIRS	75
LEDGESTONE OUTFALL / LEVEL SPREADER	70
TOTAL COVERAGE	38946
TOTAL SITE AREA	145186
BUILDING COVERAGE	6%
TOTAL LOT COVERAGE	26.82%

PF	ROJECT SCHEDULE		
		START DATE	COMPLETION DATE
1.	ANTICIPATED START DATE	03/16/2020	
2.	EROSION CONTROL IN-PLACE	03/16/2020	03/18/2020 (ON-GOING MAINTENANCE)
3.	DEMOLITION & SITE PREPARATION ACTIVITIES	03/18/2020	03/25/2020
4.	TENNIS COURT & SITE IMPROVEMENTS	03/26/2020	05/01/2020
5.	INSTALLATION OF PERMANENT VEGETATION & SEEDING	05/01/2020	05/25/2020
6.	ANTICIPATED DATE OF SUBSTANTIAL COMPLETION		05/25/2020

GENERAL NOTES:

- 1. EXISTING CONDITIONS/ BASE MAP INFORMATION IS FROM A SITE SURVEY CONDUCTED BY VENEZIA LAND SURVEYORS AND CIVIL ENGINEERS DATED 6/11/19.
- 2. PROPERTY LINE INFORMATION SHOWN ON PLANS IS BASED ON AVAILABLE RECORD INFORMATION AND A FIFLD INSTRUMENT SURVEY
- INFORMATION AND A FIELD INSTRUMENT SURVEY.
- UTILITIES SHOWN ON THIS PLAN ARE APPROXIMATE. ACTUAL LOCATION SHALL BE FIELD VERIFIED PRIOR TO CONSTRUCTION. THE CONTRACTOR SHALL PROTECT AND MAINTAIN ALL EXISTING UTILITY SERVICES THROUGHOUT CONSTRUCTION. CONTACT U.F.P.O AT 1-8000-962-7962 AT LEAST 72 HOURS PRIOR TO CONSTRUCTION.
- 4. THIS UPLAND PORTION OF THE SITE DOES NOT FALL WITHIN ANY FEMA SPECIAL FLOOD HAZARD ZONES. THE LAKE FRONTAGE IS LOCATED IN ZONE AE, PER C.P #3605980025C MAP REVISED MARCH 3, 1997.
- 5. NO CHANGES ARE TO BE MADE TO THIS DESIGN WITHOUT PRIOR APPROVAL OF THE DESIGN
- 6. ALL IMPROVEMENTS SHALL BE IN ACCORDANCE WITH THE MOST RECENT STANDARDS AND SPECIFICATIONS OF THE TOWN OF CANANDAIGUA AND THE APPROPRIATE WATER/ SEWER AGENCIES, UNLESS OTHERWISE NOTED.
- 7. PROPOSED LIGHTING TO BE COORDINATED WITH THE LANDSCAPE ARCHITECT AND OWNER.
- 8. THE CONTRACTOR SHALL OBTAIN ALL NECESSARY PERMITS FROM THE ONTARIO COUNTY HIGHWAY DEPARTMENT FOR ALL WORK WITHIN THE RIGHT OF WAY.
- 9. DUE TO THE FACT THAT THE PROJECT WILL DISTURB MORE THAN 1-ACRE OF LAND, THE PROJECT WILL BE REQUIRED TO FILE A NOTICE OF INTENT (NOI) FOR STORMWATER DISCHARGES ASSOCIATED WITH CONSTRUCTION ACTIVITY UNDER THE NYS DEC SPDES GENERAL PERMIT GP-0-15-002. THE FILLING OF THE NOI WILL INCLUDE THE DEVELOPMENT AND IMPLEMENTATION OF A STORMWATER POLLUTION PREVENTION PLAN.

ONE STAGE SITE PLAN APPROVAL


PLANNING BOARD CHAIRPERSON DATE

TOWN HIGHWAY & WATER SUPERINTENDENT DATE

TOWN ENGINEER DATE

NOTE:
NO BUILDING PERMIT MAY BE ISSUED UNTIL FINAL SITE PLAN
APPROVAL HAS BEEN GRANTED AND THE FINAL SITE PLAN
SIGNED BY THE PLANNING BOARD CHAIRPERSON

© 2019 BAYER LANDSCAPE ARCHITECTURE, PLLC

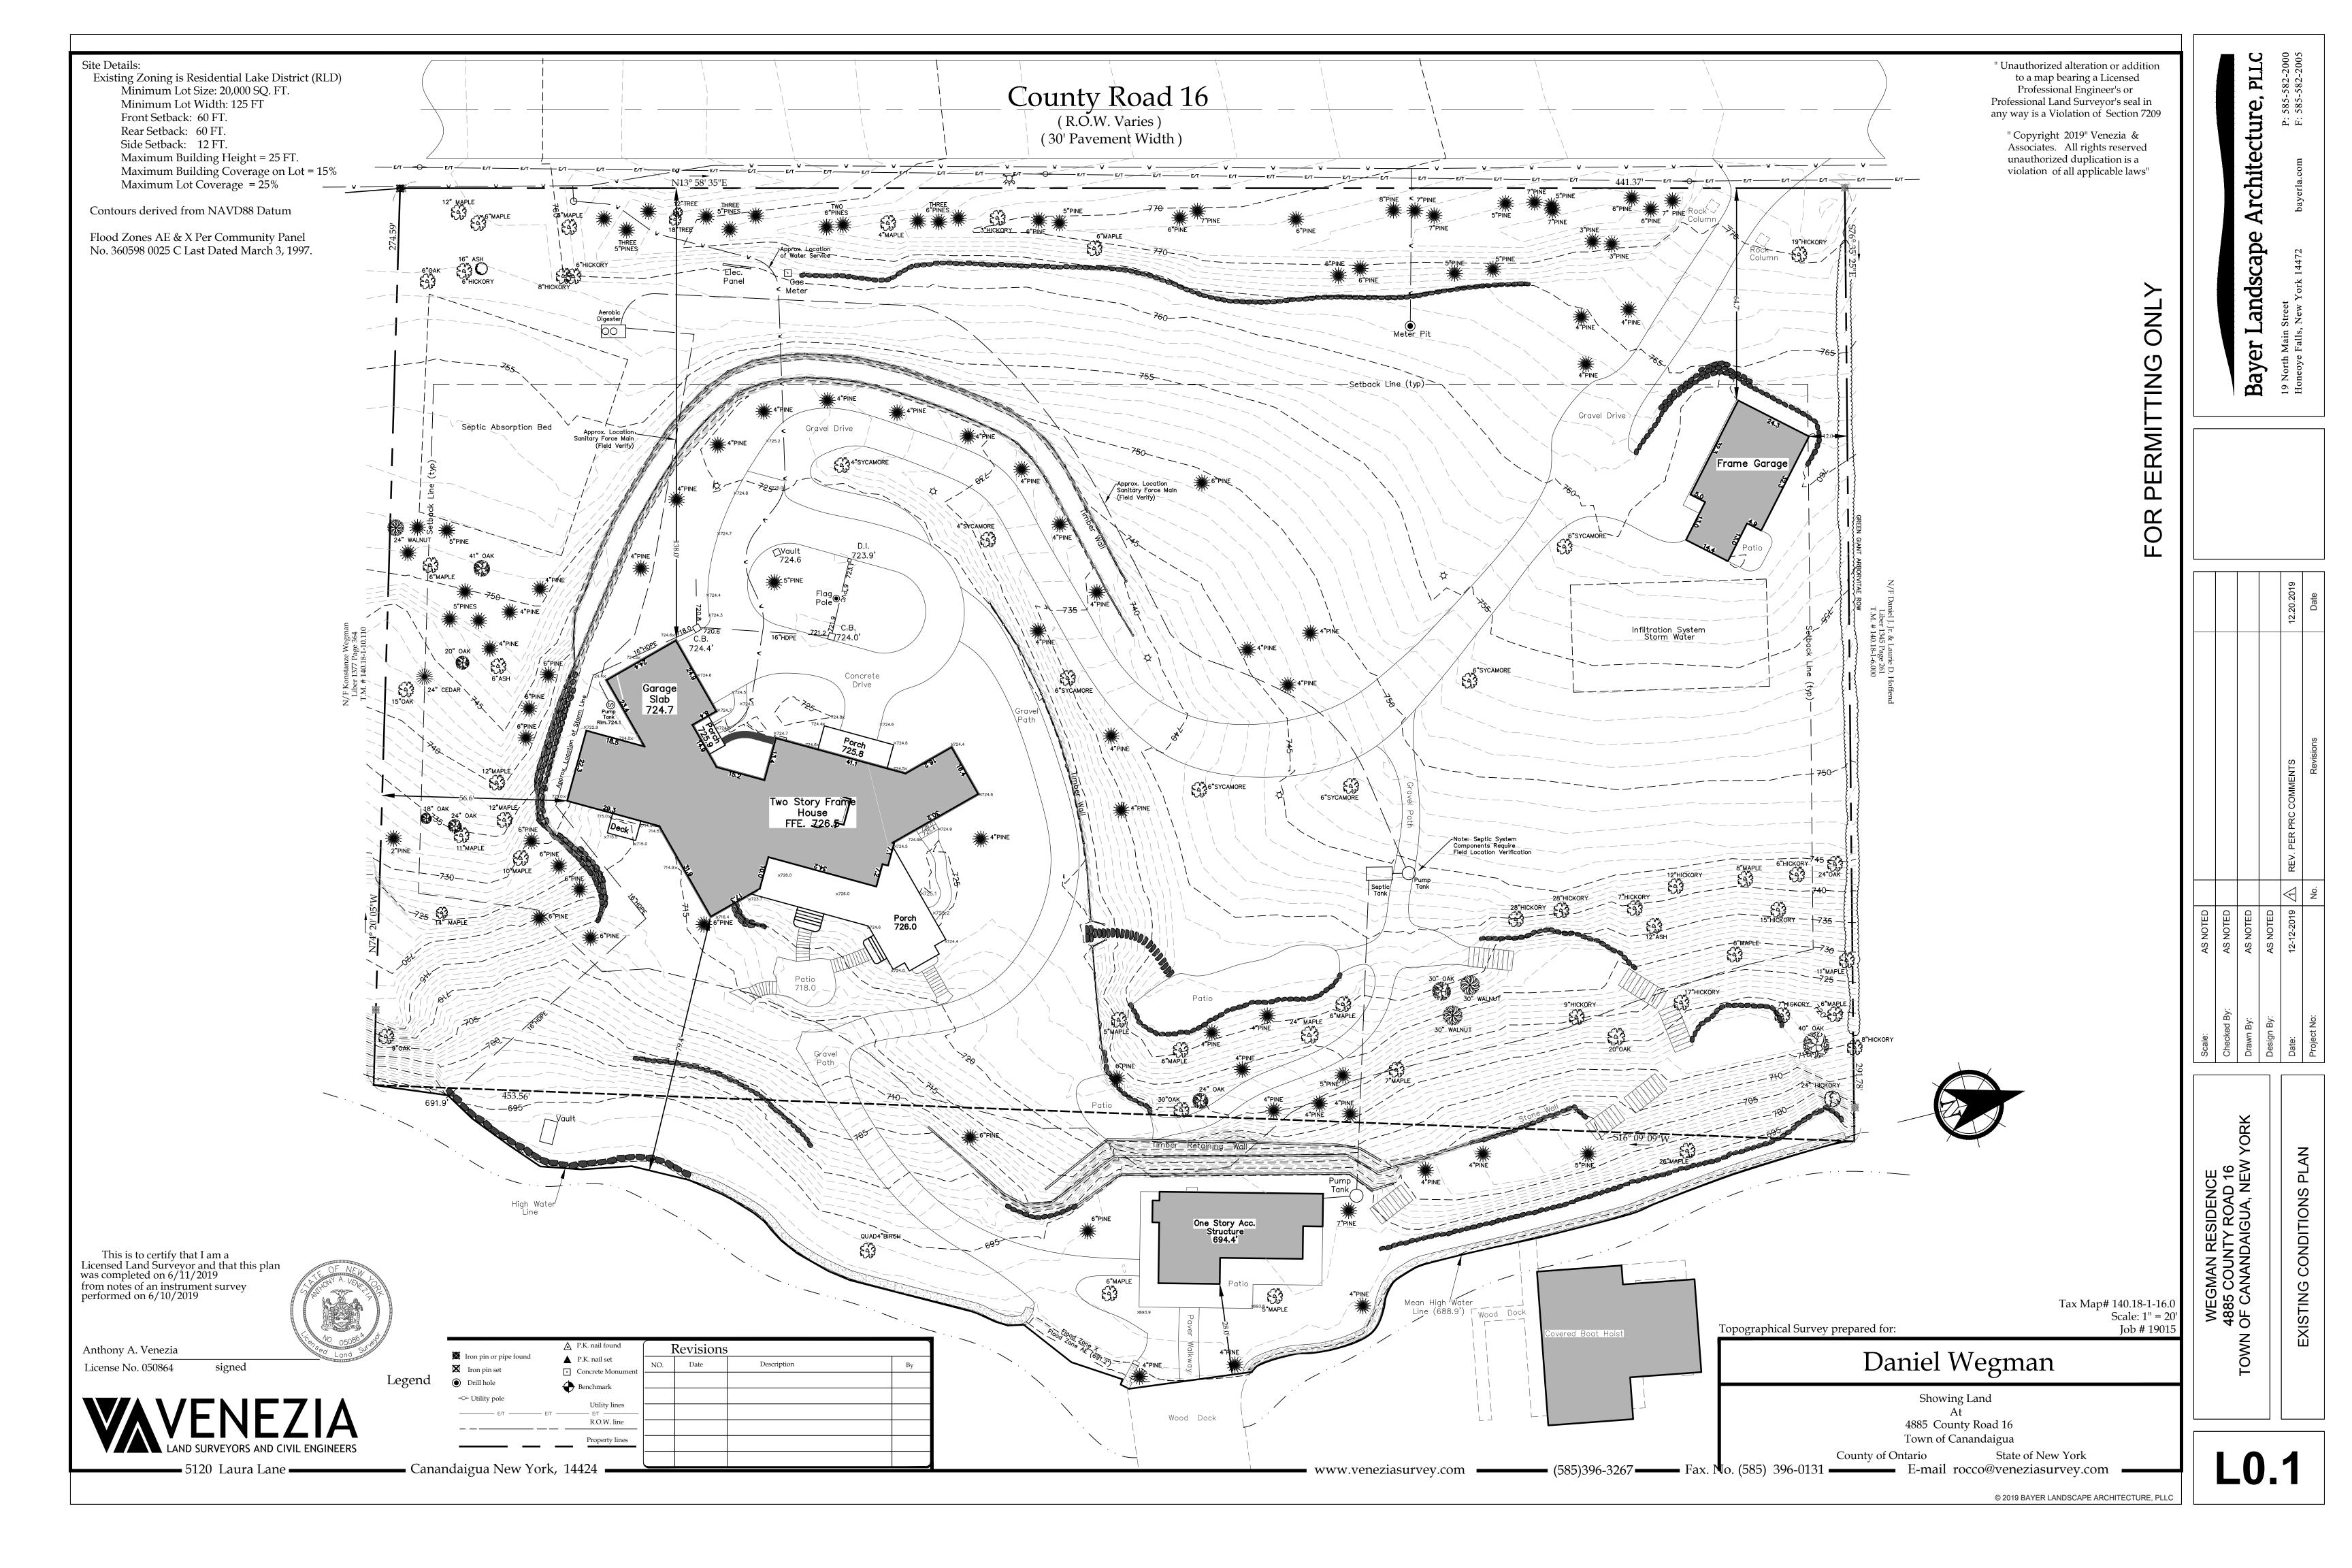





Scale: 1"=20'-0"			
Checked By: MHB			
Drawn By: DPZ / SKP			
Design By: BLA			
Date: 12.12.2019 4	\mathbb{W}	REV. PER PRC COMMENTS	12
Project No:	No.	Revisions	

DATE


AREA

26,008 SQ. FT.

14,761 SQ. FT.

4,190 SQ. FT.

1,486 SQ. FT.

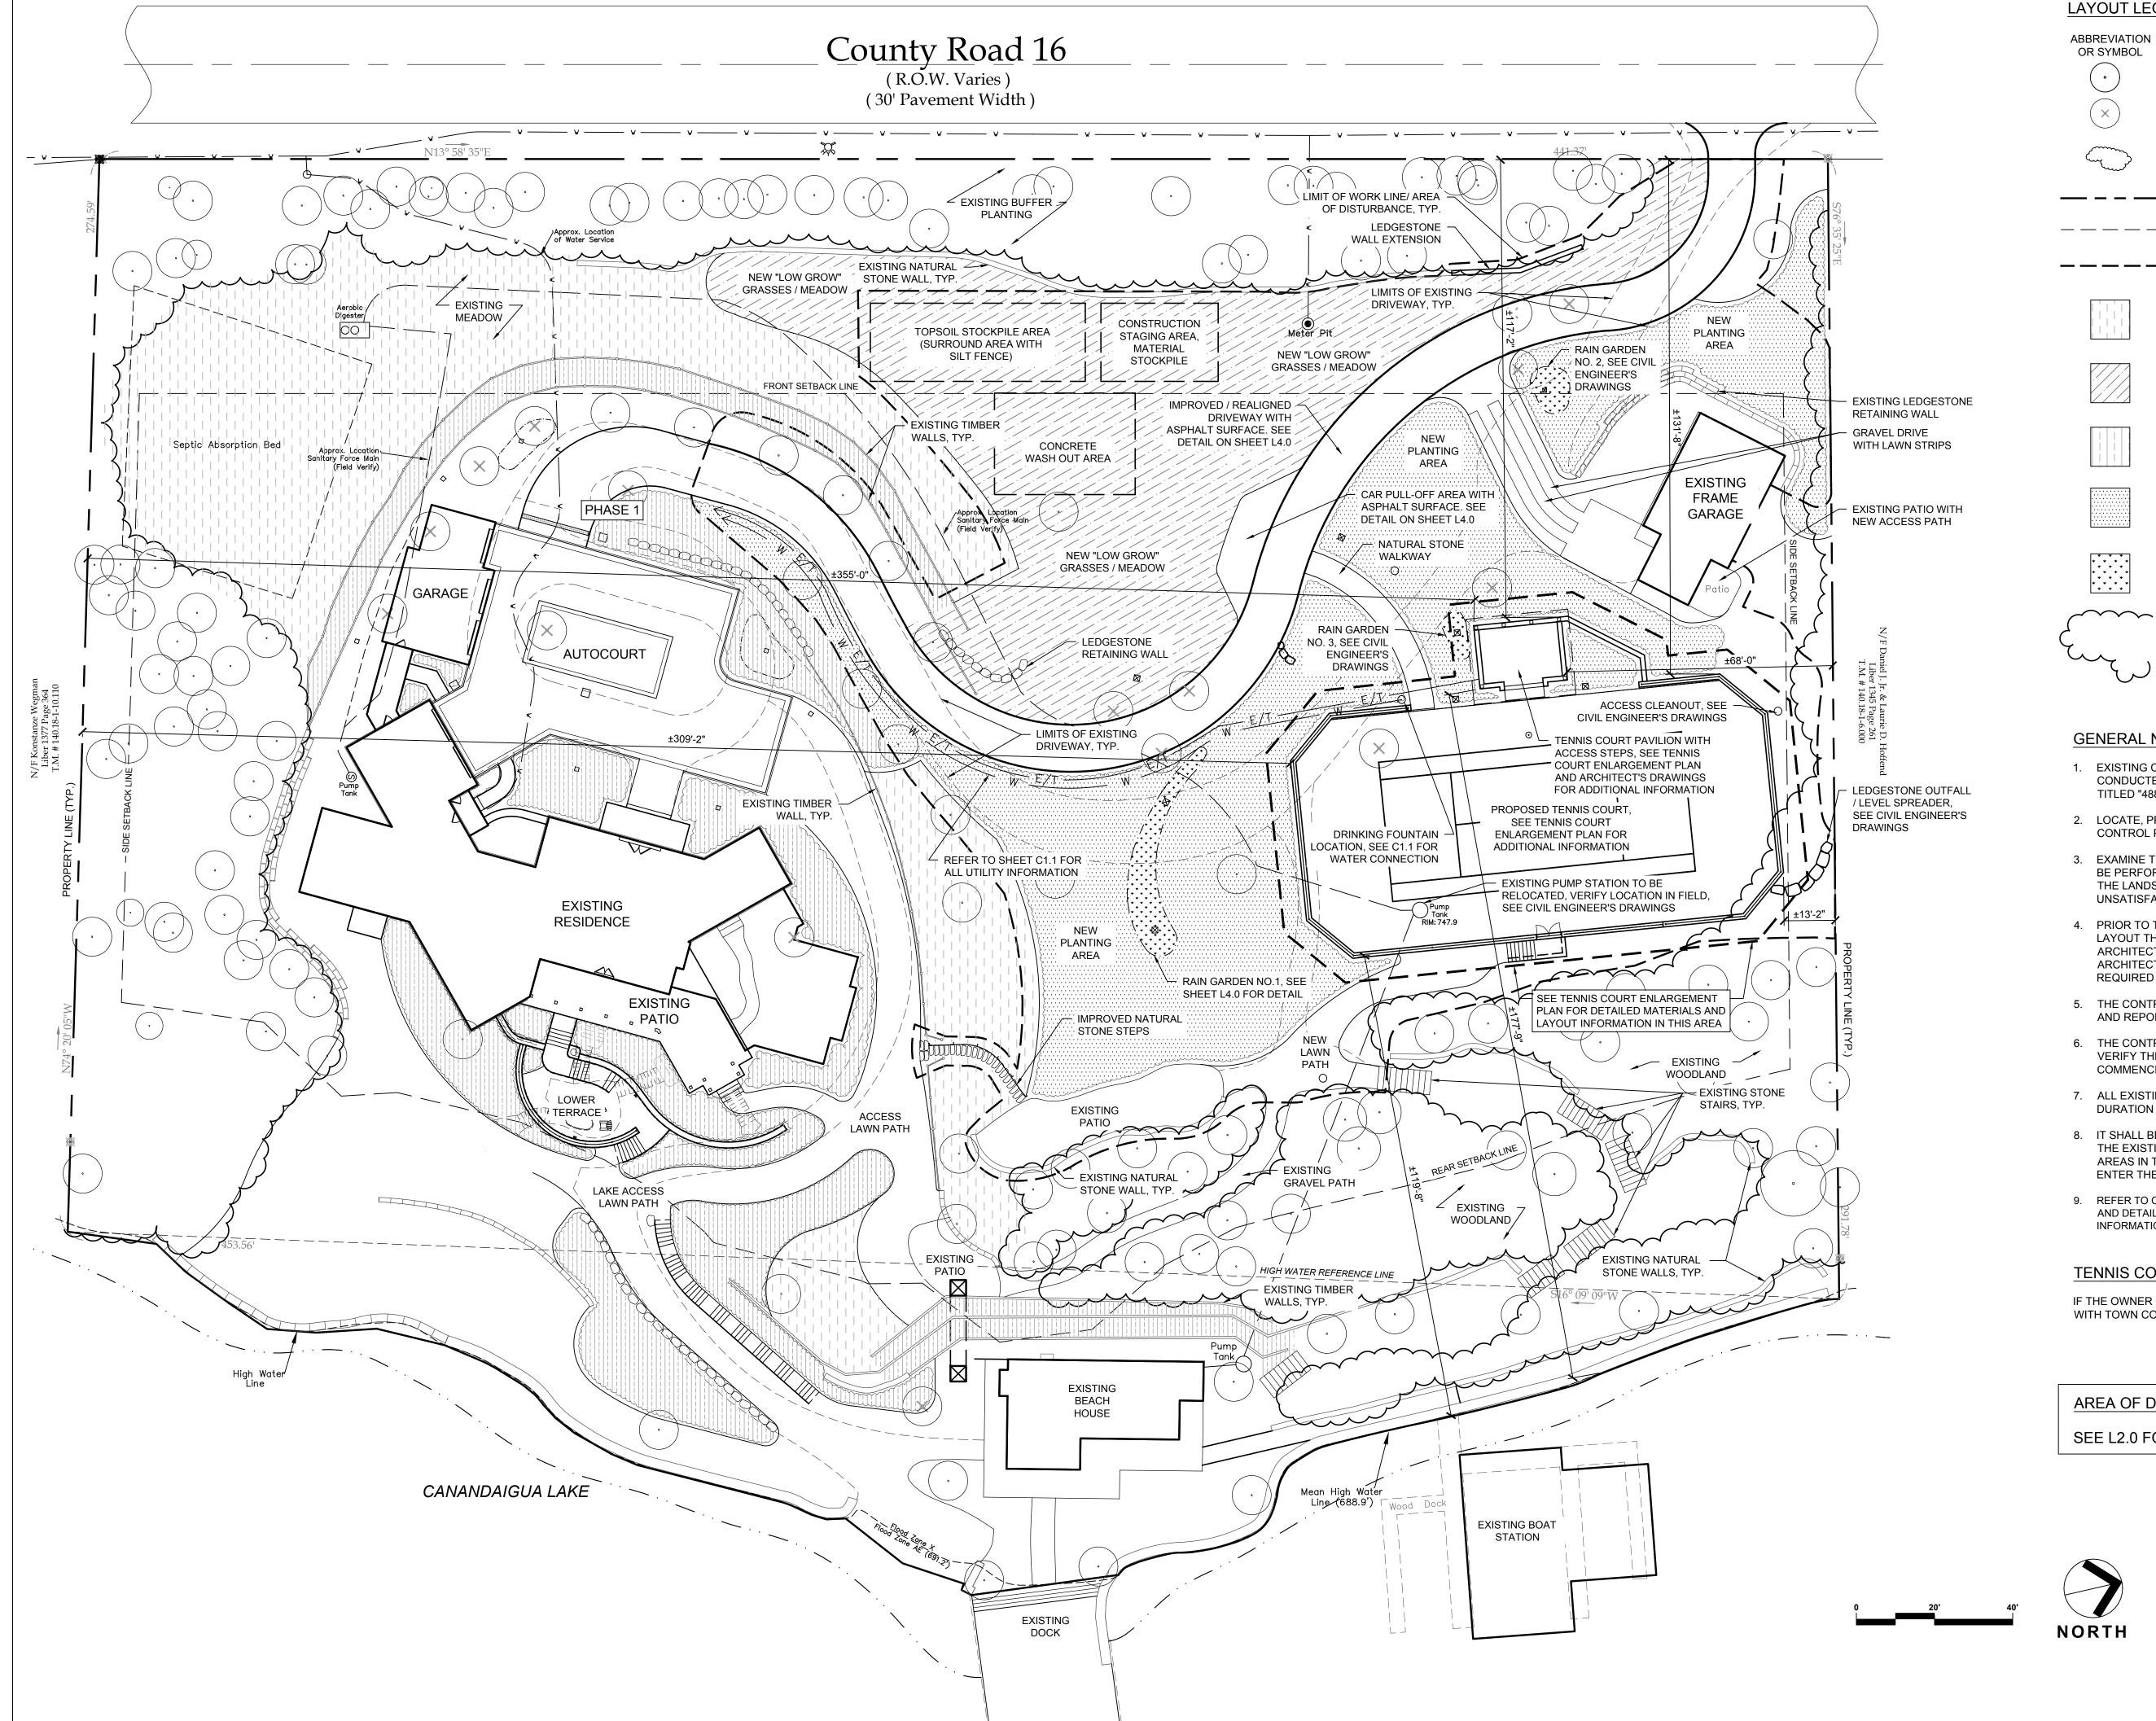

LAYOUT LEGEND

DESCRIPTION

EXISTING TREE EXISTING TREE TO


BE REMOVED

PLANTING AREA

PROPERTY LINE SETBACK LINE

LIMITS OF WORK / AREA OF DISTURBANCE

EXISTING MEADOW

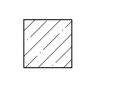

NEW "LOW-GROW" **GRASSES/ MEADOW**



PLANTING AREA

PLANTING AREA

EXISTING



NEW RAIN GARDEN



EXISTING EDGE OF WOODLAND / WOODED AREA

GENERAL NOTES:

- 1. EXISTING CONDITIONS/ BASE MAP INFORMATION IS FROM A SITE SURVEY CONDUCTED BY VENEZIA LAND SURVEYORS AND CIVIL ENGINEERS TITLED "4885 COUNTY ROAD 16" AND DATED 06/11/2019.
- 2. LOCATE, PROTECT, AND MAINTAIN BENCH MARKS, MONUMENTS, CONTROL POINTS, AND PROJECT ENGINEERING REFERENCE POINTS.
- 3. EXAMINE THE AREAS AND CONDITIONS UNDER WHICH SITE WORK WILL BE PERFORMED. REPORT ANY DISCREPANCIES WITH THE DRAWINGS TO THE LANDSCAPE ARCHITECT. DO NOT PROCEED WITH THE WORK UNTIL UNSATISFACTORY CONDITIONS ARE CORRECTED.
- 4. PRIOR TO THE START OF CONSTRUCTION. THE CONTRACTOR SHALL LAYOUT THE PROJECT IN THE FIELD FOR REVIEW WITH THE LANDSCAPE ARCHITECT. CONTRACTOR SHALL COORDINATE WITH THE LANDSCAPE ARCHITECT TO MAKE MINOR FIELD ADJUSTMENTS TO THE LAYOUT AS REQUIRED TO ACHIEVE THE DESIGN INTENT.
- 5. THE CONTRACTOR SHALL VERIFY THE LAYOUT OF ALL SITE ELEMENTS AND REPORT CONFLICTS TO THE LANDSCAPE ARCHITECT.
- 6. THE CONTRACTOR SHALL COORDINATE WITH UTILITY AGENCIES TO VERIFY THE LOCATION OF ALL UNDERGROUND UTILITIES PRIOR TO COMMENCING WORK.
- 7. ALL EXISTING TREES TO REMAIN SHALL BE PROTECTED FOR THE DURATION OF CONSTRUCTION.
- 8. IT SHALL BE THE RESPONSIBILITY OF THE CONTRACTOR TO DELINEATE THE EXISTING STORMWATER INFILTRATION AREA AND ALL RAIN GARDEN AREAS IN THE FIELD, AND THAT NO EQUIPMENT SHALL BE PERMITTED TO ENTER THESE AREAS TO AVOID COMPACTION IN THESE AREAS.
- 9. REFER TO CIVIL ENGINEER'S SITE DRAINAGE AND EROSION CONTROL PLAN AND DETAILS FOR ALL UTILITY, EROSION CONTROL, AND DRAINAGE INFORMATION.

TENNIS COURT LIGHTING NOTE:

IF THE OWNER OPTS TO LIGHT THE TENNIS COURT, THE LIGHTS WILL COMPLY WITH TOWN CODE "SECTION 220-77. LIGHTING STANDARDS AND REGULATIONS"

AREA OF DISTURBANCE

SEE L2.0 FOR AREAS OF DISTURBANCE

ONE STAGE SITE PLAN APPROVAL



PLANNING BOARD CHAIRPERSON DATE TOWN HIGHWAY & WATER SUPERINTENDENT DATE

TOWN ENGINEER

NO BUILDING PERMIT MAY BE ISSUED UNTIL FINAL SITE PLAN APPROVAL HAS BEEN GRANTED AND THE FINAL SITE PLAN SIGNED BY THE PLANNING BOARD CHAIRPERSON


© 2019 BAYER LANDSCAPE ARCHITECTURE, PLLC

DATE





					REV. PER PRC COMMENTS	Revisions
					\forall	No.
Scale: 1"=20'-0"	Checked By: MHB	Drawn By: DPZ	N 19	Design by.	Date: 12.12.2019 1	Project No:
		¥				

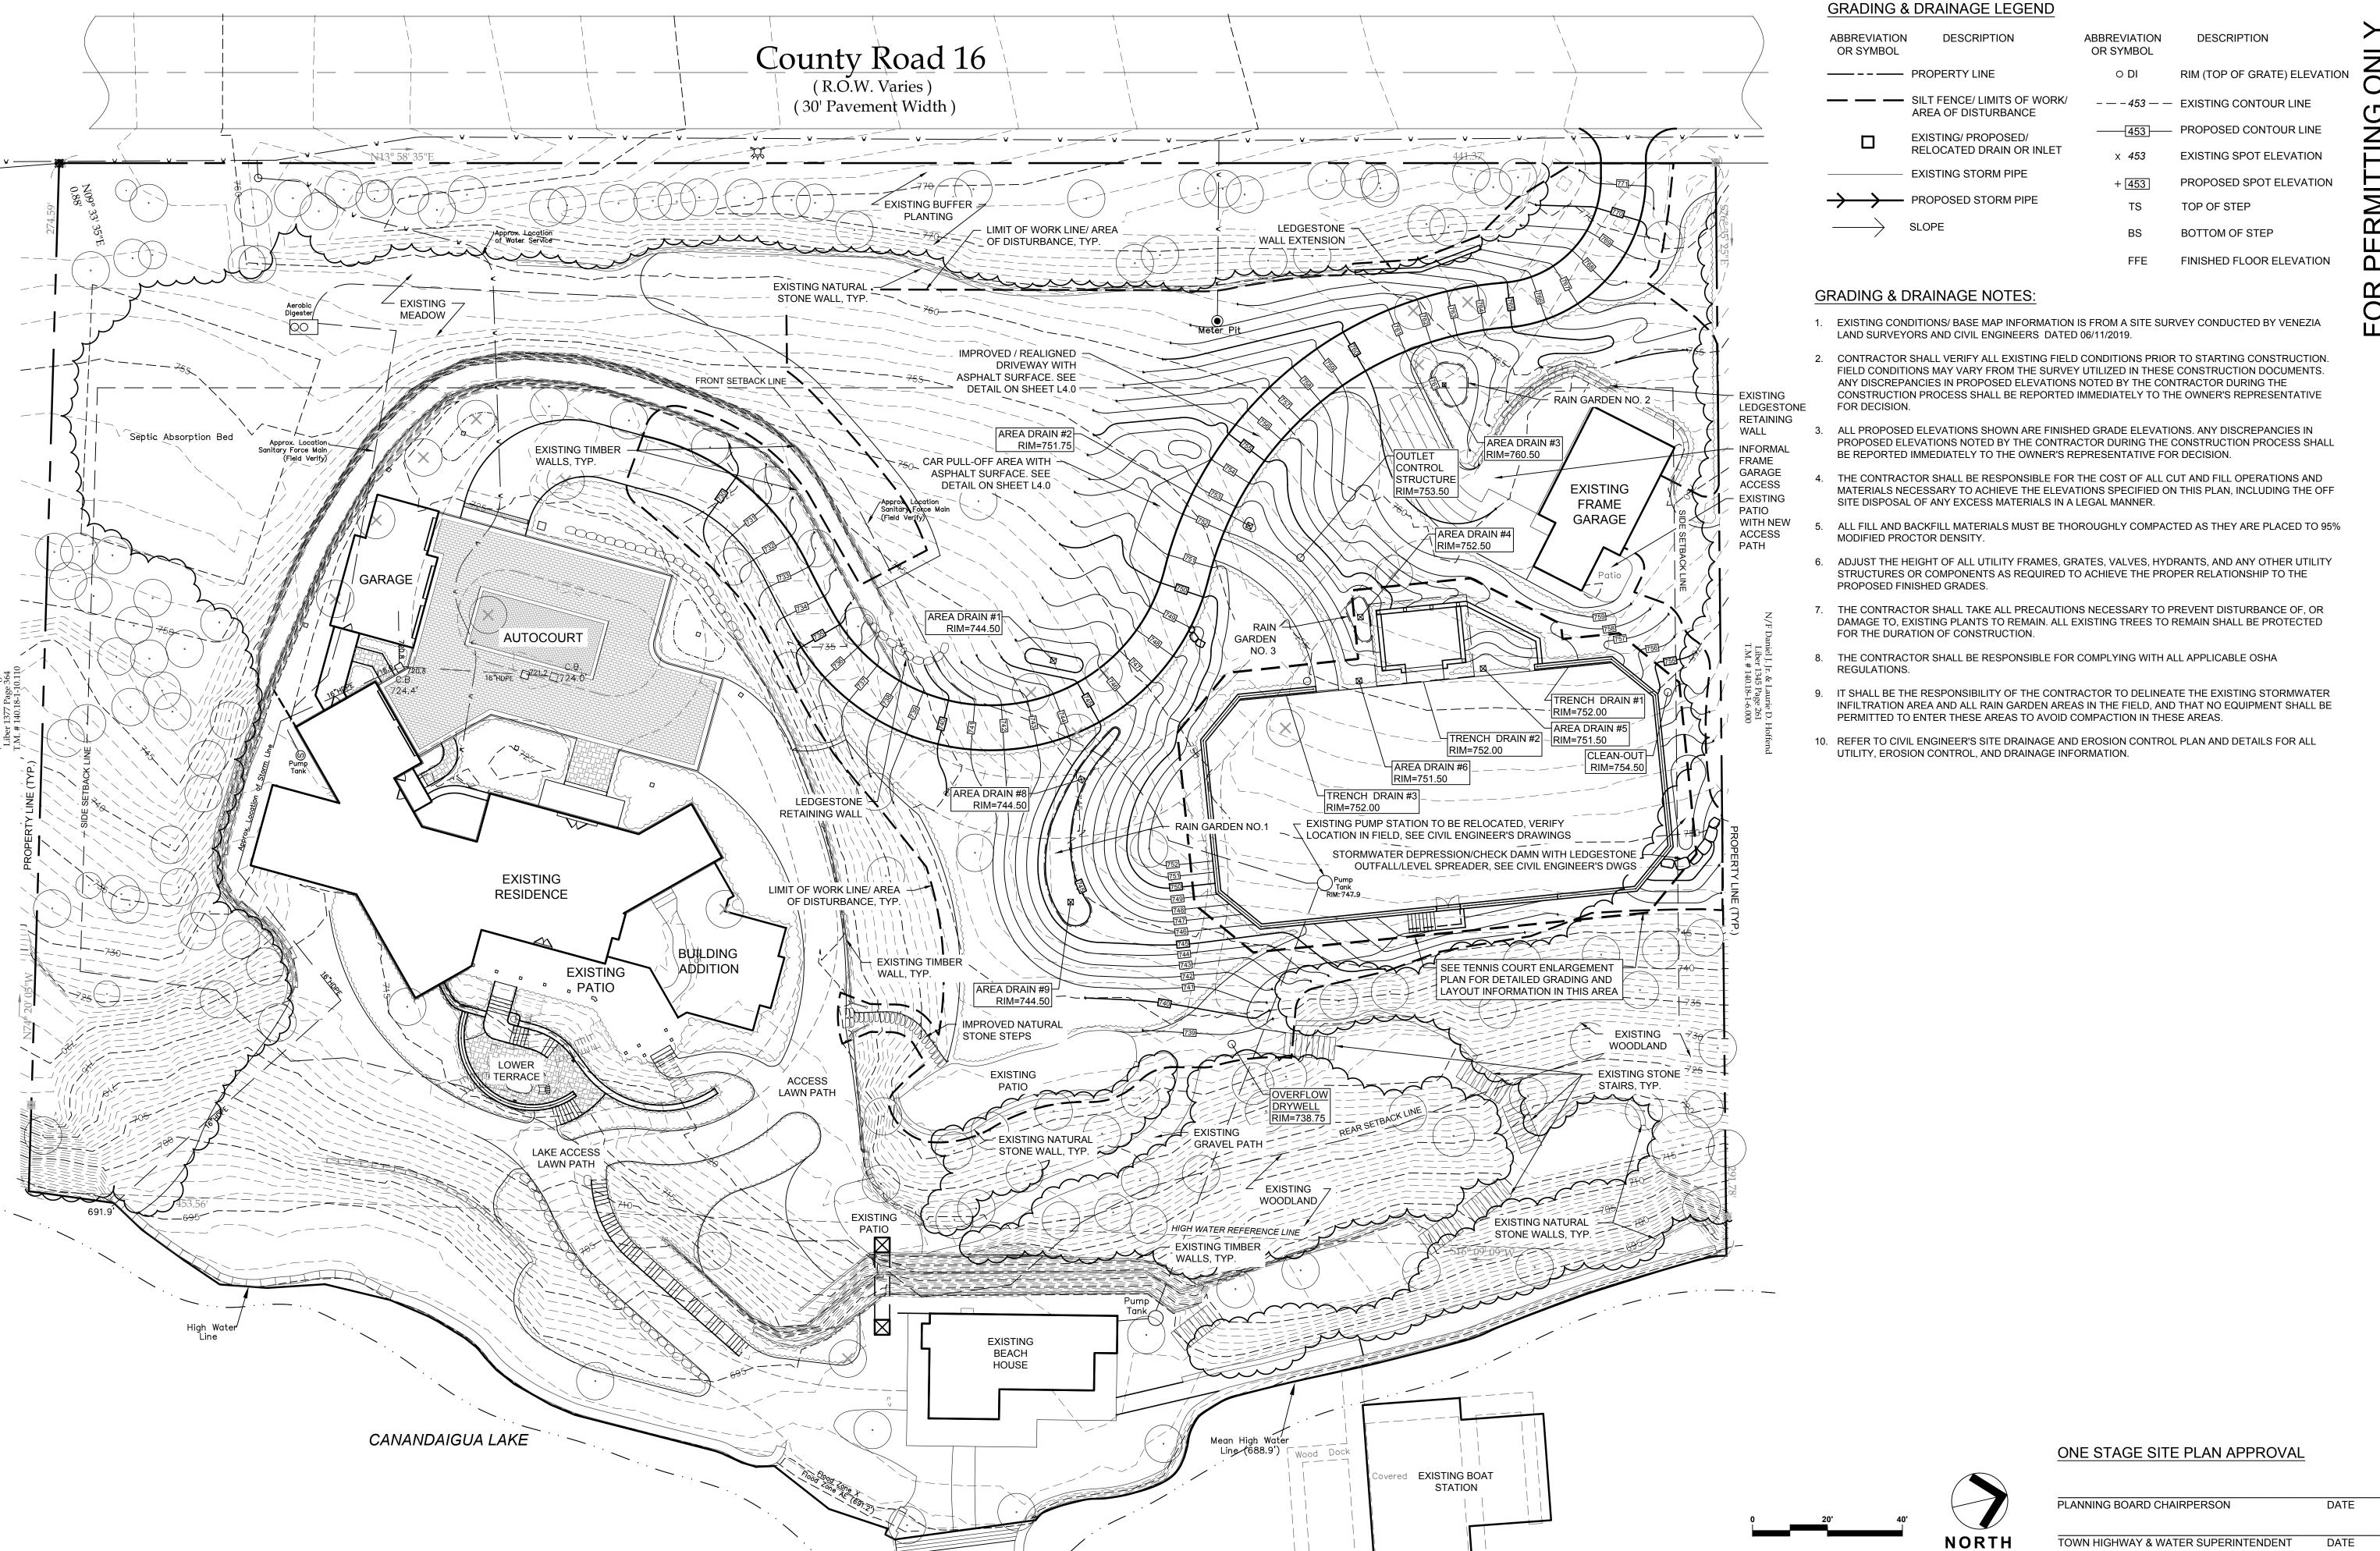

EXISTING DOCK

TOWN HIGHWAY & WATER SUPERINTENDENT

TOWN ENGINEER

AREA OF SITE DISTURBANCE:

TOTAL AREA OF SITE DISTURBANCE: 46,445 SF (1.1 ACRE)

NO BUILDING PERMIT MAY BE ISSUED UNTIL FINAL SITE PLAN APPROVAL HAS BEEN GRANTED AND THE FINAL SITE PLAN SIGNED BY THE PLANNING BOARD CHAIRPERSON


© 2019 BAYER LANDSCAPE ARCHITECTURE, PLLC


DATE



Bayer

				REV. PER PRC COMMENTS	Revisions
				\oplus	No.
Scale: 1"=20'-0"	Checked By:	Drawn By: DPZ	Design By: BLA	Date: 12.12.2019	Project No:
		쏫			

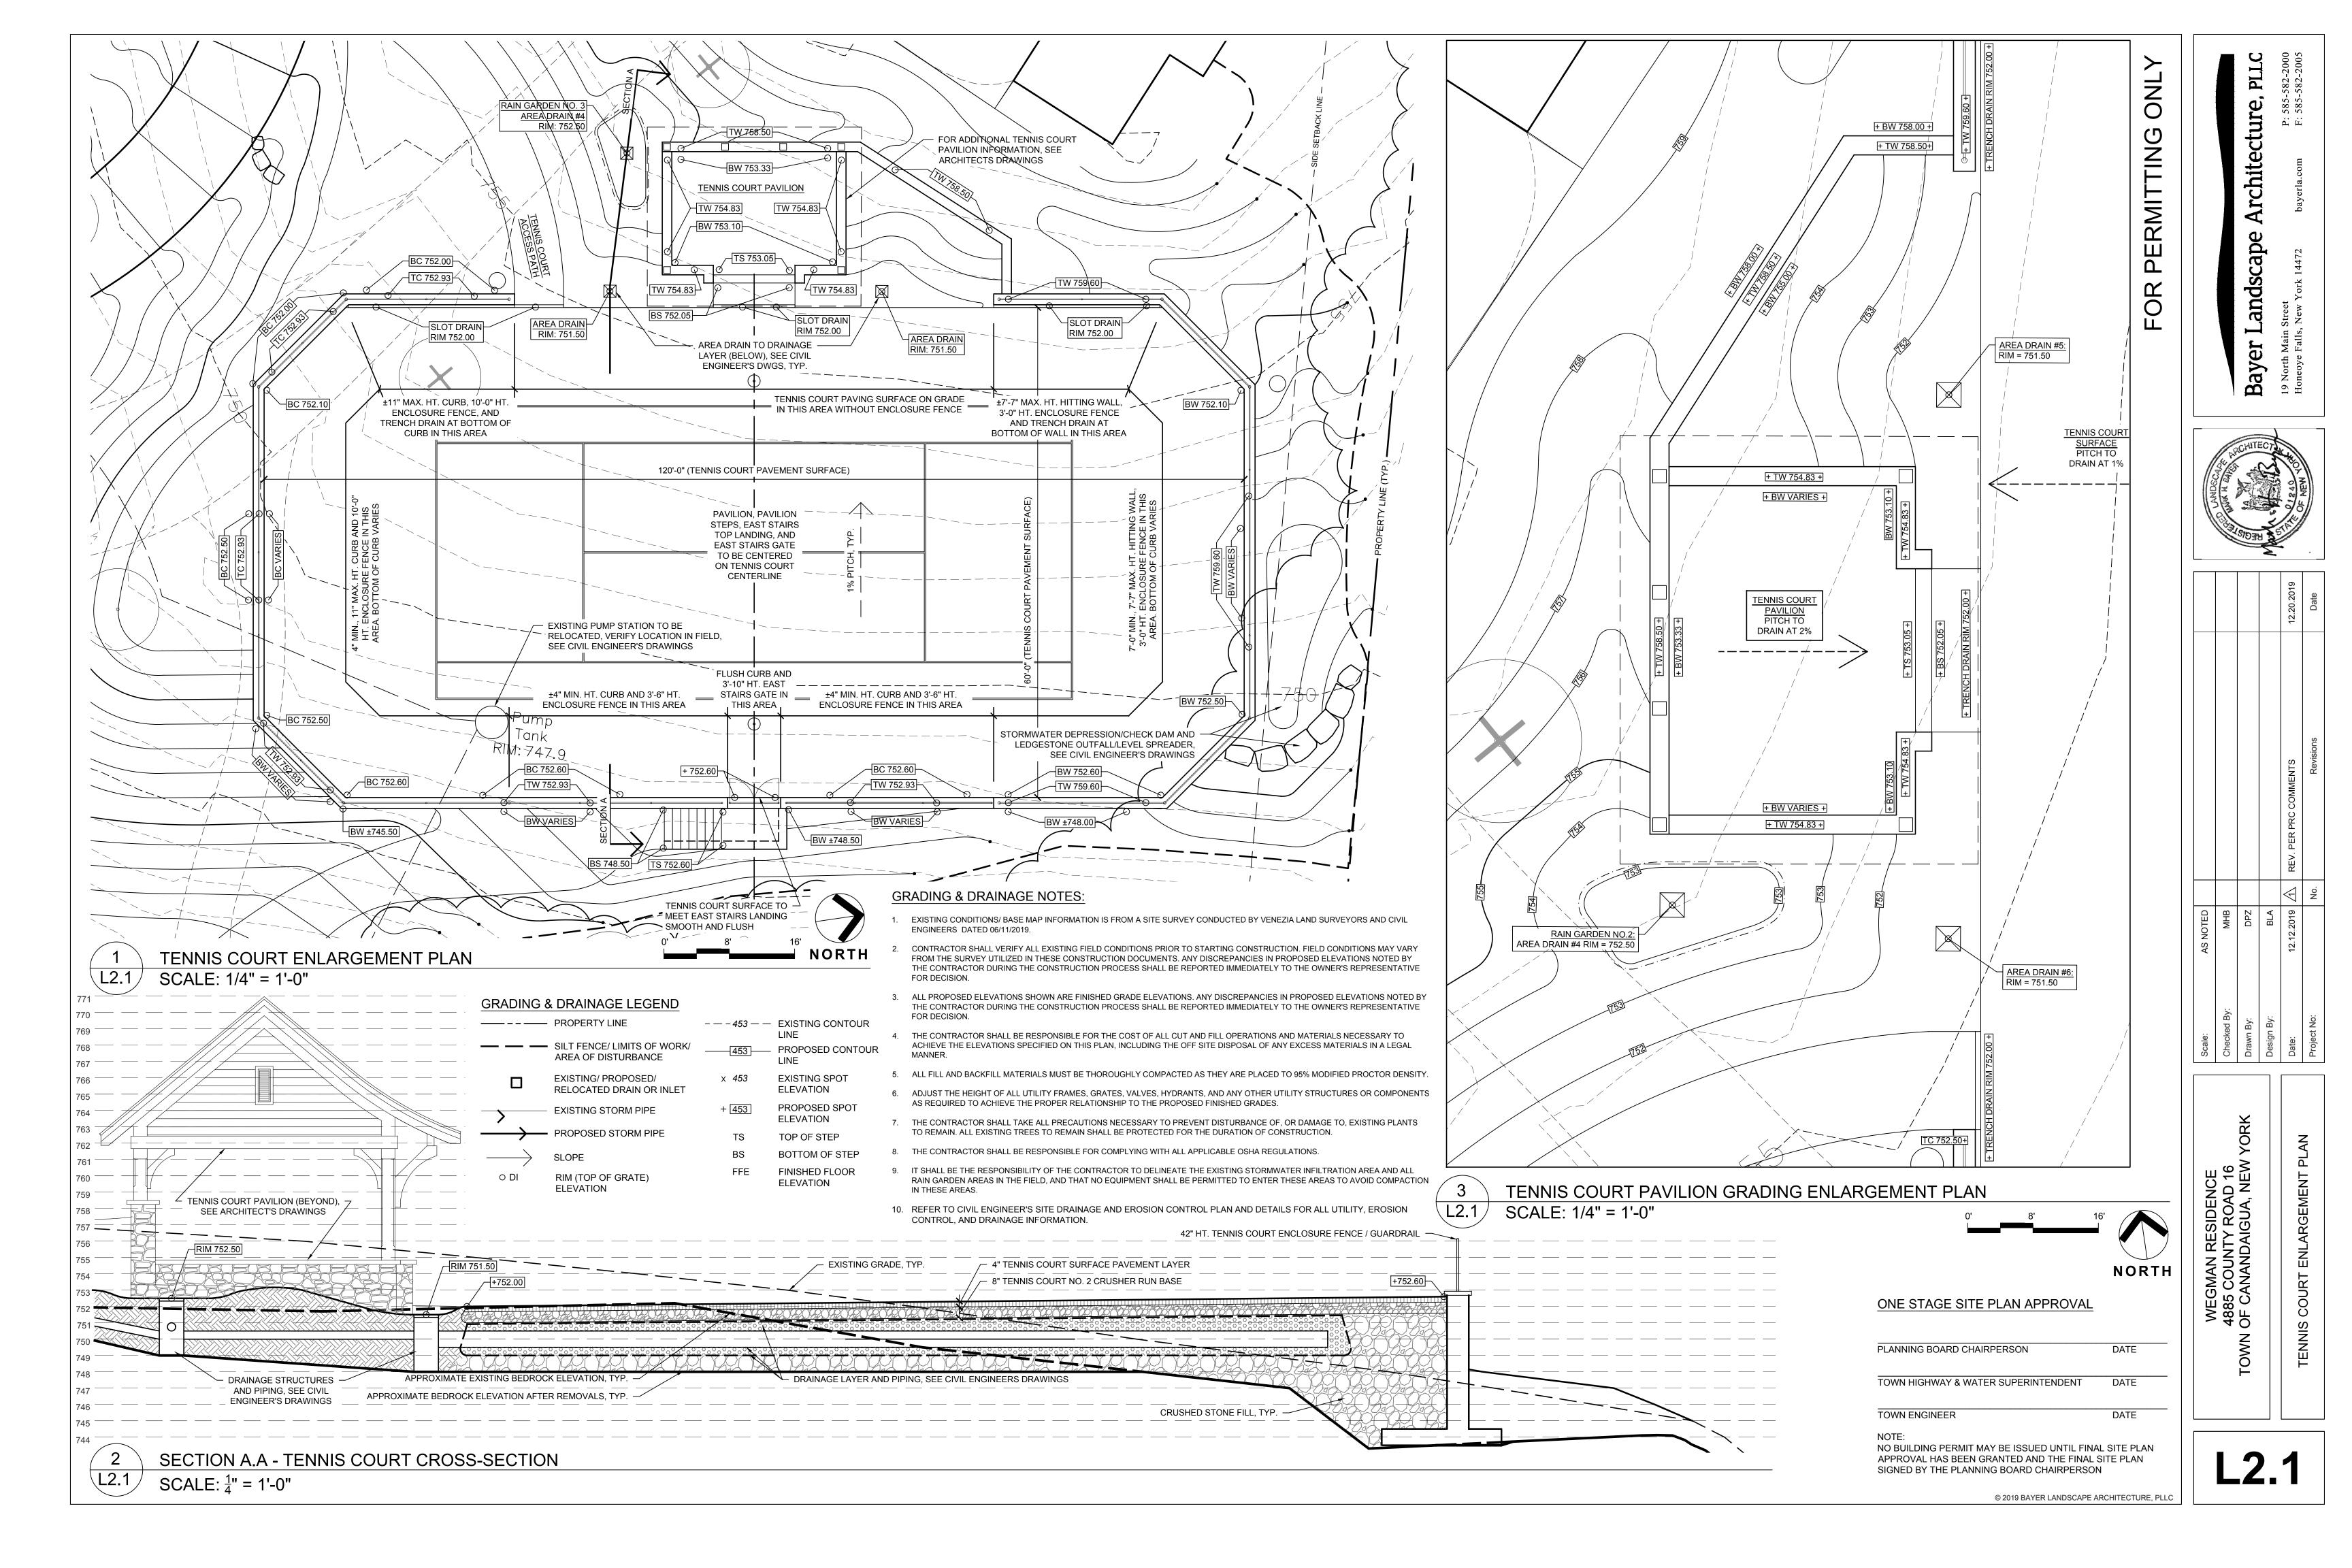

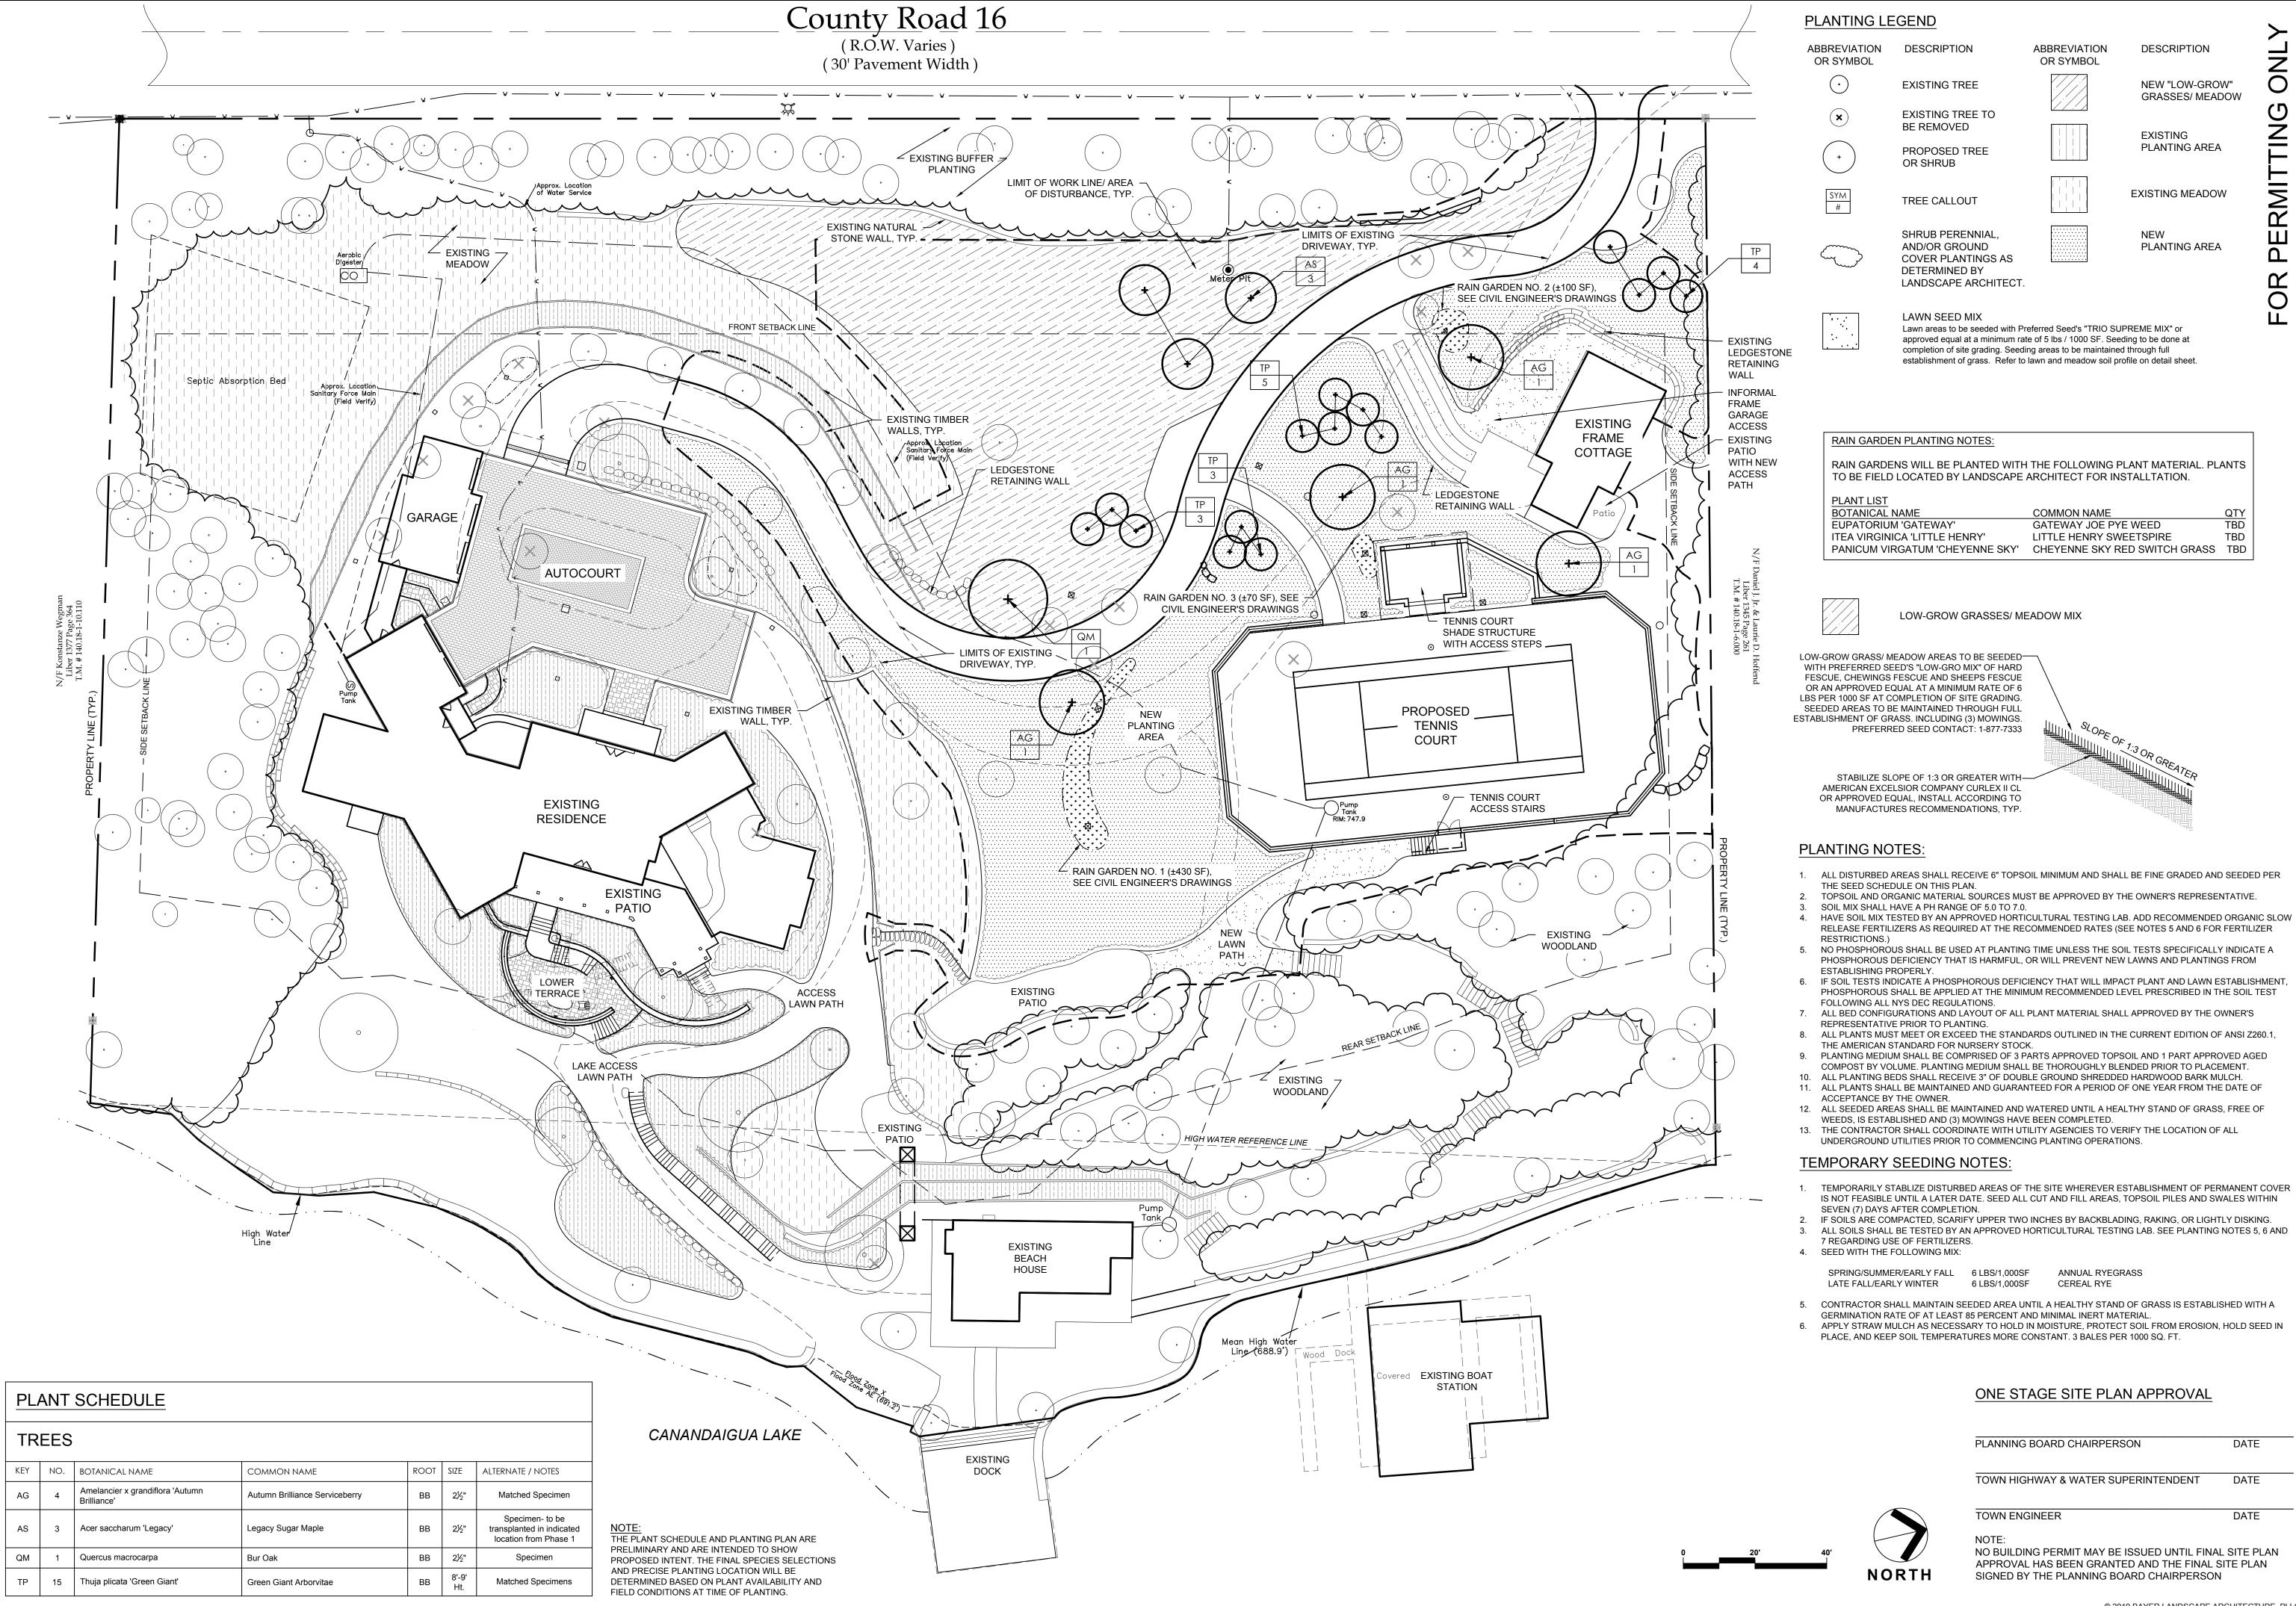

DESCRIPTION **ABBREVIATION** DESCRIPTION OR SYMBOL **EXISTING TREE NEW "LOW-GROW" GRASSES/ MEADOW** EXISTING TREE TO BE REMOVED **EXISTING** PLANTING AREA PROPOSED TREE **EXISTING MEADOW**

SHRUB PERENNIAL AND/OR GROUND **COVER PLANTINGS AS** DETERMINED BY

PLANTING AREA

Lawn areas to be seeded with Preferred Seed's "TRIO SUPREME MIX" or approved equal at a minimum rate of 5 lbs / 1000 SF. Seeding to be done at completion of site grading. Seeding areas to be maintained through full establishment of grass. Refer to lawn and meadow soil profile on detail sheet.

RAIN GARDEN PLANTING NOTES:

RAIN GARDENS WILL BE PLANTED WITH THE FOLLOWING PLANT MATERIAL. PLANTS TO BE FIELD LOCATED BY LANDSCAPE ARCHITECT FOR INSTALLTATION

GATEWAY JOE PYE WEED TBD ITEA VIRGINICA 'LITTLE HENRY' LITTLE HENRY SWEETSPIRE PANICUM VIRGATUM 'CHEYENNE SKY' CHEYENNE SKY RED SWITCH GRASS TBD

LOW-GROW GRASSES/ MEADOW MIX

LOW-GROW GRASS/ MEADOW AREAS TO BE SEEDED-WITH PREFERRED SEED'S "LOW-GRO MIX" OF HARD FESCUE, CHEWINGS FESCUE AND SHEEPS FESCUE OR AN APPROVED EQUAL AT A MINIMUM RATE OF 6 LBS PER 1000 SF AT COMPLETION OF SITE GRADING. SEEDED AREAS TO BE MAINTAINED THROUGH FULL ESTABLISHMENT OF GRASS. INCLUDING (3) MOWINGS. PREFERRED SEED CONTACT: 1-877-7333

> STABILIZE SLOPE OF 1:3 OR GREATER WITH AMERICAN EXCELSIOR COMPANY CURLEX II CL OR APPROVED EQUAL, INSTALL ACCORDING TO MANUFACTURES RECOMMENDATIONS, TYP.

- 1. ALL DISTURBED AREAS SHALL RECEIVE 6" TOPSOIL MINIMUM AND SHALL BE FINE GRADED AND SEEDED PER
- TOPSOIL AND ORGANIC MATERIAL SOURCES MUST BE APPROVED BY THE OWNER'S REPRESENTATIVE. SOIL MIX SHALL HAVE A PH RANGE OF 5.0 TO 7.0.
- RELEASE FERTILIZERS AS REQUIRED AT THE RECOMMENDED RATES (SEE NOTES 5 AND 6 FOR FERTILIZER
- PHOSPHOROUS DEFICIENCY THAT IS HARMFUL, OR WILL PREVENT NEW LAWNS AND PLANTINGS FROM
- IF SOIL TESTS INDICATE A PHOSPHOROUS DEFICIENCY THAT WILL IMPACT PLANT AND LAWN ESTABLISHMENT, PHOSPHOROUS SHALL BE APPLIED AT THE MINIMUM RECOMMENDED LEVEL PRESCRIBED IN THE SOIL TEST
- ALL BED CONFIGURATIONS AND LAYOUT OF ALL PLANT MATERIAL SHALL APPROVED BY THE OWNER'S
- ALL PLANTS MUST MEET OR EXCEED THE STANDARDS OUTLINED IN THE CURRENT EDITION OF ANSI Z260.1,
- PLANTING MEDIUM SHALL BE COMPRISED OF 3 PARTS APPROVED TOPSOIL AND 1 PART APPROVED AGED COMPOST BY VOLUME. PLANTING MEDIUM SHALL BE THOROUGHLY BLENDED PRIOR TO PLACEMENT.
- 10. ALL PLANTING BEDS SHALL RECEIVE 3" OF DOUBLE GROUND SHREDDED HARDWOOD BARK MULCH. 11. ALL PLANTS SHALL BE MAINTAINED AND GUARANTEED FOR A PERIOD OF ONE YEAR FROM THE DATE OF
- 12. ALL SEEDED AREAS SHALL BE MAINTAINED AND WATERED UNTIL A HEALTHY STAND OF GRASS, FREE OF WEEDS, IS ESTABLISHED AND (3) MOWINGS HAVE BEEN COMPLETED.
- 13. THE CONTRACTOR SHALL COORDINATE WITH UTILITY AGENCIES TO VERIFY THE LOCATION OF ALL UNDERGROUND UTILITIES PRIOR TO COMMENCING PLANTING OPERATIONS.

TEMPORARY SEEDING NOTES:

- TEMPORARILY STABLIZE DISTURBED AREAS OF THE SITE WHEREVER ESTABLISHMENT OF PERMANENT COVER IS NOT FEASIBLE UNTIL A LATER DATE. SEED ALL CUT AND FILL AREAS, TOPSOIL PILES AND SWALES WITHIN
- IF SOILS ARE COMPACTED, SCARIFY UPPER TWO INCHES BY BACKBLADING, RAKING, OR LIGHTLY DISKING.
- ALL SOILS SHALL BE TESTED BY AN APPROVED HORTICULTURAL TESTING LAB. SEE PLANTING NOTES 5, 6 AND

SPRING/SUMMER/EARLY FALL 6 LBS/1,000SF ANNUAL RYEGRASS CEREAL RYE

- 5. CONTRACTOR SHALL MAINTAIN SEEDED AREA UNTIL A HEALTHY STAND OF GRASS IS ESTABLISHED WITH A
- GERMINATION RATE OF AT LEAST 85 PERCENT AND MINIMAL INERT MATERIAL. APPLY STRAW MULCH AS NECESSARY TO HOLD IN MOISTURE, PROTECT SOIL FROM EROSION, HOLD SEED IN

ONE STAGE SITE PLAN APPROVAL

PLANNING BOARD CHAIRPERSON DATE

TOWN HIGHWAY & WATER SUPERINTENDENT DATE

TOWN ENGINEER


NO BUILDING PERMIT MAY BE ISSUED UNTIL FINAL SITE PLAN APPROVAL HAS BEEN GRANTED AND THE FINAL SITE PLAN SIGNED BY THE PLANNING BOARD CHAIRPERSON

© 2019 BAYER LANDSCAPE ARCHITECTURE, PLLC

DATE





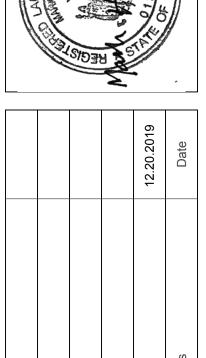

DRIP LINE + 10% STANDARD ORANGE CONSTRUCTION FENCING WITH HEAVY GAUGE STEEL STAKES @ 6' O.C. MIN.

1. DO NOT LEAVE CONSTRUCTION EQUIPMENT RUNNING (IDLING) UNDER TREE CANOPIES. 2. IF SPACE LIMITATIONS NECESSITATE THE USE OF A SMALLER FENCE ENCLOSURE, THE CONTRACTOR SHALL HAVE THE PROPOSED CONFIGURATION APPROVED BY THE OWNER'S REPRESENTATIVE PRIOR TO INSTALLATION.

EXISTING TREE PROTECTION DETAIL SCALE: 1/4" = 1'-0"


PRUNE BROKEN, CROSSING OR RUBBING BRANCHES AS DIRECTED BY LANDSCAPE ARCHITECT 3/4" TREE-TIE WEBBING SECURED TO TREE AT FIRST BRANCH WHORL, TYP. - (3) 2"x2"x7' STAKES, NOTCHED TO RECEIVE AND SECURE TREE-TIE WEBBING, DRIVE 12" MIN INTO UNDISTURBED GRADE OUTSIDE ROOTBALL - SET ROOT COLLAR OF TREE 2" ABOVE FINISHED SOIL GRADE REMOVE BURLAP/ ROPE /WIRE FROM TOP $\frac{1}{2}$ OF ROOTBALL, REMOVE ALL NON-BIODEGRADABLE ROPES/FABRICS COMPLETELY - 3"-4" DEEP SOIL-FORMED WATERING RING AT EDGE OF ROOTBALL, REMOVE AFTER ONE YEAR 3" FINE DOUBLE GROUND HARDWOOD BARK MULCH OVER FULL TREE PIT, HOLD 3" BACK FROM TRUNK - PLANTING PIT EQUALS Ø 3x ROOTBALL MIN. PLANTING SOIL BACKFILL TO CONSIST OF (3) PARTS EXISTING TOPSOIL AND (1) PART AGED COMPOST, THOROUGHLY BLENDED EXCAVATE PERIMETER OF TREE PIT 8" - 12" DEEPER THAN ROOTBALL FOR DRAINAGE UNDISTURBED GRADE BELOW BALL TO PREVENT SETTLING ROOTBALL DIAMETER 3X ROOTBALL DIAMETER

DECIDUOUS TREE PLANTING DETAIL SCALE: 1/4" = 1'-0"

SET CROWN OF ROOTBALL 2" ABOVE FINISHED SOIL GRADE FOR BALLED AND BURLAPED SHRUBS: REMOVE BURLAP / ROPE/WIRE FROM TOP 1/2 OF ROOTBALL, REMOVE ALL NON-BIODEGRADABLE ROPES / FABRICS COMPLETELY. FOR CONTAINER GROWN SHRUBS: LOOSEN POT BOUND OR CIRCLING ROOTS.

- 3" DEPTH FINE GROUND HARDWOOD BARK MULCH, KEEP FREE OF TRUNK/STEMS, SUBMIT MULCH SAMPLE FOR APPROVAL APPROVED PLANTING SOIL MIX CONSISTING OF 3 PARTS TOPSOIL AND 1 PART ORGANIC COMPOST BY VOLUME, SEE ALSO PLANTING NOTES. SCARIFIED/PREPARED SUBSOIL MIXED W/ PLANTING SOIL - UNDISTURBED SUBGRADE

SHRUB PLANTING DETAIL SCALE: 1" = 1'-0"

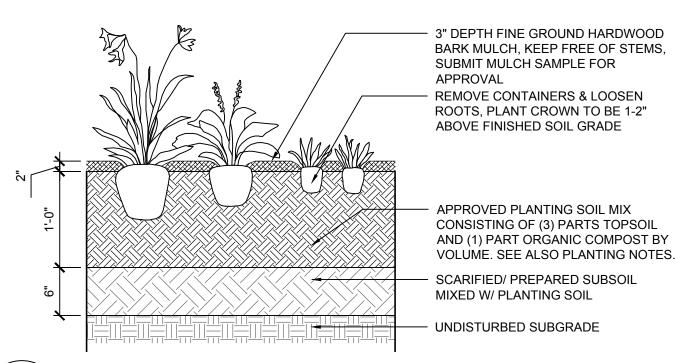


PERENNIAL AND GROUNDCOVER PLANTING DETAIL SCALE: 1" = 1'-0"

PITCH AS PER GRADING PLAN

BITUMINOUS (ASPHALT) CONCRETE WEARING (TOP) COURSE, NYSDOT TYPE 7F. BITUMINOUS (ASPHALT) CONCRETE BINDER COURSE, NYSDOT TYPE 3. SUBBASE COURSE, NYSDOT TYPE 2,

CRUSHED STONE - WOVEN GEOTEXTILE FABRIC, MIRAFI HP 370 COMPACTED SUBGRADE TO 93% MAX DRY DENSITY, PITCH AS PER SURFACE DRAINAGE

ASPHALT DRIVEWAY DETAIL \backslash L4.0 /SCALE: N.T.S.

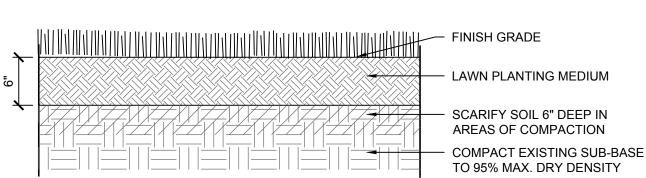

 LAWN PLANTING MEDIUM - SCARIFY SOIL 6" DEEP IN AREAS OF COMPACTION

TO 95% MAX. DRY DENSITY

TOWN ENGINEER

LAWN SOIL PROFILE SCALE: N.T.S.


ONE STAGE SITE PLAN APPROVAL


PLANNING BOARD CHAIRPERSON DATE TOWN HIGHWAY & WATER SUPERINTENDENT DATE


NO BUILDING PERMIT MAY BE ISSUED UNTIL FINAL SITE PLAN APPROVAL HAS BEEN GRANTED AND THE FINAL SITE PLAN SIGNED BY THE PLANNING BOARD CHAIRPERSON


© 2019 BAYER LANDSCAPE ARCHITECTURE, PLLC

DATE

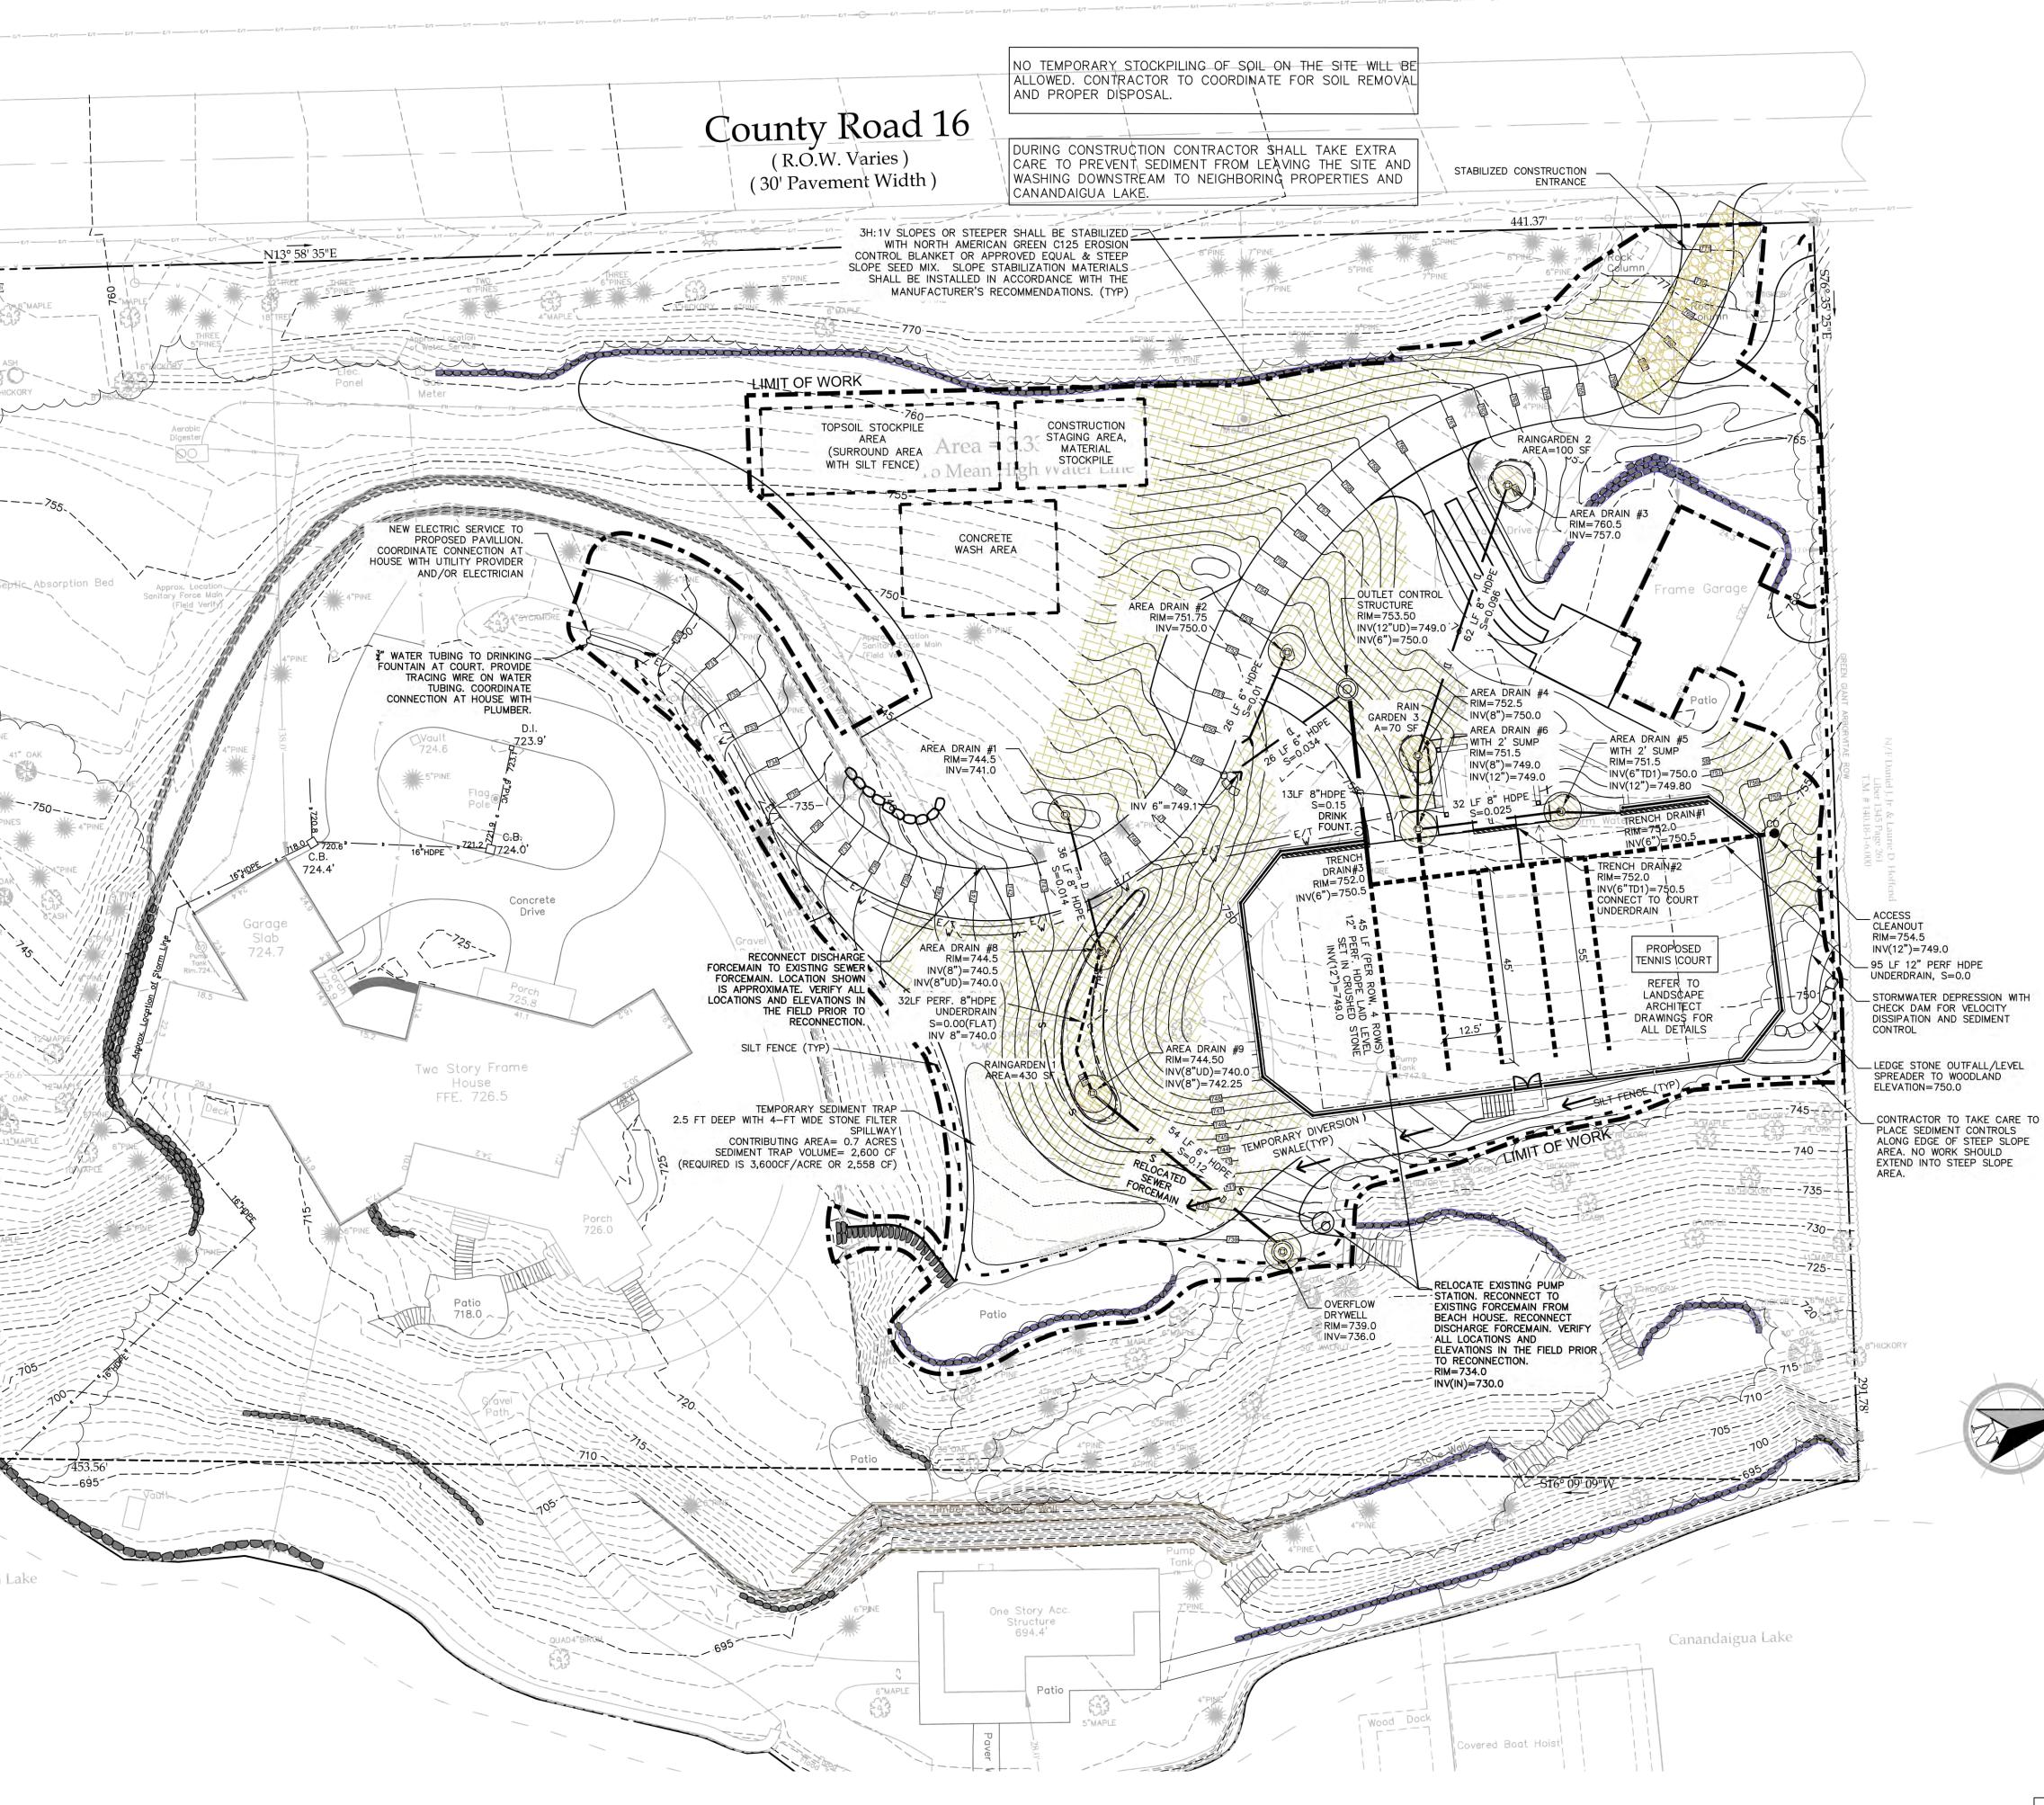

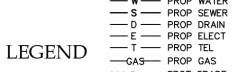

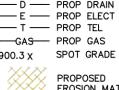

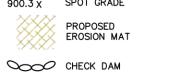

---900 --- PROP CONTOUR ----- PROPERTY LINE CENTERLINE LIGHT POLE DRAIN MANHOLE CATCH BASIN SEWER MANHOLE WATER VALVE HYDRANT

-900 - EXIST, CONTOUR

THE NEW YORK STATE EDUCATION LAW IT IS A VIOLATION FOR ANY PERSON TO ALTER ANY DOCUMENT THAT BEARS THE UNLESS THE PERSON IS ACTING UNDER THE DIRECTION OF A LICENSED PROFESSIONAL ENGINEER. IF A DOCUMENT BEARING THE SEAL OF AN ENGINEER IS ALTERED, THE ALTERING ENGINEER SHALL AFFIX TO THE DOCUMENT THEIR SEAL AND THE NOTATION "ALTERED BY" FOLLOWED BY THEIR SIGNATURE AND THE DATE OF SUCH ALTERATION, AND A SPECIFIC DESCRIPTION OF THE ALTERATION.



Scale:	"=20'-0"			
Checked By:	EVJ			
Drawn By:	evj			
Design By:	evj			
Date: 12.	12.2019	\bigcirc	REV. PER PRC COMMENTS	12.20.201
Project No:		No.	Revisions	Date
	ked By: n By: n By: ct No:	ked By: n By: n By: ct No:	ted By: EVJ By: evj n By: evj 12.12.2019 ct No:	ted By: EVJ EVJ evj evj evj 12.12.2019 A REV. PER PRC COMME ot No: No.

WEGMAN RESIDENCE 4885 COUNTY ROAD 16 OF CANANDAIGUA, NEW

GRADING & DRAINAGE NOTES:

- EXISTING CONDITIONS/ BASE MAP INFORMATION IS FROM A SITE SURVEY CONDUCTED BY VENEZIA LAND SURVEYORS AND CIVIL ENGINEERS DATED 06/11/2019.
- CONTRACTOR SHALL VERIFY ALL EXISTING FIELD CONDITIONS PRIOR TO STARTING CONSTRUCTION. FIELD CONDITIONS MAY VARY FROM THE SURVEY UTILIZED IN THESE CONSTRUCTION DOCUMENTS. ANY DISCREPANCIES IN PROPOSED ELEVATIONS NOTED BY THE CONTRACTOR DURING THE CONSTRUCTION PROCESS SHALL BE REPORTED IMMEDIATELY TO THE OWNER'S REPRESENTATIVE FOR DECISION.
- ALL PROPOSED ELEVATIONS SHOWN ARE FINISHED GRADE ELEVATIONS. ANY DISCREPANCIES IN PROPOSED ELEVATIONS NOTED BY THE CONTRACTOR DURING THE CONSTRUCTION PROCESS SHALL BE REPORTED IMMEDIATELY TO THE OWNER'S REPRESENTATIVE FOR DECISION.
- 4. THE CONTRACTOR SHALL BE RESPONSIBLE FOR THE COST OF ALL CUT AND FILL OPERATIONS AND MATERIALS NECESSARY TO ACHIEVE THE ELEVATIONS SPECIFIED ON THIS PLAN, INCLUDING THE OFF SITE DISPOSAL OF ANY EXCESS MATERIALS IN A LEGAL
- 5. ALL FILL AND BACKFILL MATERIALS MUST BE THOROUGHLY COMPACTED AS THEY ARE PLACED TO 95% MODIFIED PROCTOR
- ADJUST THE HEIGHT OF ALL UTILITY FRAMES, GRATES, VALVES, HYDRANTS, AND ANY OTHER UTILITY STRUCTURES OR COMPONENTS AS REQUIRED TO ACHIEVE THE PROPER RELATIONSHIP TO THE PROPOSED FINISHED GRADES.
- 7. THE CONTRACTOR SHALL TAKE ALL PRECAUTIONS NECESSARY TO PREVENT DISTURBANCE OF, OR DAMAGE TO, EXISTING PLANTS TO REMAIN. ALL EXISTING TREES TO REMAIN SHALL BE PROTECTED FOR THE DURATION OF CONSTRUCTION.
- 8. THE CONTRACTOR SHALL BE RESPONSIBLE FOR COMPLYING WITH ALL APPLICABLE OSHA REGULATIONS.
- 9. IT SHALL BE THE RESPONSIBILITY OF THE CONTRACTOR TO DELINEATE THE EXISTING STORMWATER INFILTRATION AREA AND ALL RAIN GARDEN AREAS IN THE FIELD, AND THAT NO EQUIPMENT SHALL BE PERMITTED TO ENTER THESE AREAS TO AVOID COMPACTION IN THESE AREAS.

EROSION CONTROL NOTES

- ALL EROSION CONTROL MEASURE SHALL BE INSTALLED PRIOR TO CONSTRUCTION AND SHALL BE MAINTAINED FOR THE DURATION OF CONSTRUCTION UNTIL FINAL GRADING, LANDSCAPE/PLANTING, AND PERMANENT STABILIZATION HAS BEEN
- NO SITE PREPARATION SHALL COMMENCE UNTIL A VISUAL INSPECTION BY THE TOWN OF CANANDAIGUA, CONFIRMS THE INSTALLATION OF PERIMETER SEDIMENT CONTROLS AND THE STABILIZED CONSTRUCTION ENTRANCE.
- ANY ADDITIONAL EROSION OR SEDIMENT CONTROL MEASURES DEEMED NECESSARY BY THE TOWN OF CANANDAIGUA OR A REPRESENTATIVE THEREOF SHALL BE PROVIDED BY THE OWNER AND INSTALLED BY THE CONTRACTOR.
- CONSTRUCTION SEQUENCE- ALL PLANS ARE TO BE PROVIDED WITH A DETAILED CONSTRUCTION SEQUENCE. THE CONTRACTOR SHALL COMPLETE CONSTRUCTION AND INSTALL EROSION CONTROL MEASURES IN ACCORDANCE WITH THE APPROVED CONSTRUCTION SEQUENCE UNLESS SPECIFIED OTHERWISE ON THE APPROVED DESIGN PLANS OR AT THE PRE-CONSTRUCTION
- ANY MODIFICATION OR DEVIATIONS FROM THE APPROVED PLANS, CONSTRUCTION SEQUENCE, INCLUDING IMPLEMENTATION OF EROSION CONTROL MEASURES AND STORM WATER MANAGEMENT, SHALL BE APPROVED BY THE TOWN OF CANANDAIGUA.
- 6. THE CONTRACTOR SHALL BE RESPONSIBLE FOR CLEANING ADJOINING PROPERTIES, ROADWAYS, DRAINAGE WAYS AND SINKS OF SILT ACCUMULATION AS NEEDED AND AS DETERMINED/REQUESTED BY THE TOWN OF CANANDAIGUA.
- IT SHALL BE THE RESPONSIBILITY OF THE CONTRACTOR TO STABILIZE ALL STEEP SLOPE AREAS (1:3 V:H OR STEEPER) WITH A ROLLED EROSION CONTROL PRODUCT AND STEEP SLOPE SEED MIX.
- 8. ALL AREAS OF SOIL DISTURBANCE SHALL RECEIVE TEMPORARY SEEDING IMMEDIATELY AFTER SOIL DISTURBANCE ACTIVITIES HAVE TEMPORARILY OR PERMANENTLY CEASED. STABILIZATION SHALL BE INITIATED WITHIN 1 BUSINESS DAY OF CEASING SOIL DISTURBANCE ACTIVITES AND COMPLETED WITHIN 14 DAYS.
- 9. IT SHALL BE THE RESPONSIBILITY OF THE CONTRACTOR TO PREVENT SEDIMENT FROM LEAVING THE PROJECT SITE AND WASHING INTO ADJACENT PROPERTIES AND CANANDAIGUA LAKE.
- 10. IT SHALL BE THE CONTRACTOR'S RESPONSIBILITY TO INSTALL ALL REQUIRED DUST PROTECTION AND BARRIERS ON SITE TO MITIGATE THE IMPACTS TO THE ADJACENT PROPERTIES AND LAKE.
- 11. EROSION CONTROL MEASURES SHALL BE REMOVED ONLY AFTER RECEIVING AUTHORIZATION FROM THE TOWN OF

EROSION CONTROL CONSTRUCTION SEQUENCE NOTES:


- 1. ALL EROSION CONTROL MEASURES INCLUDING PERIMETER EROSION CONTROL AND SEDIMENTATION DEVICES, STABILIZED CONSTRUCTION ENTRANCE, TREE PROTECTION DEVICES, AND DESIGNATED MATERIAL HOLDING AND STAGING AREAS SHALL BE INSTALLED PRIOR TO CONSTRUCTION.
- REMOVE ALL TREES THAT ARE SCHEDULED FOR REMOVAL DOWN TO STUMP. STUMP REMOVAL SHALL TAKE PLACE DURING SITE CONSTRUCTION PHASE.
- 3. BEGIN GENERAL CONSTRUCTION ACTIVITIES FOR BUILDING AND SITE IMPROVEMENTS
- 4. CONSTRUCT NEW BUILDING ADDITION, TERRACE, AND NEW GARAGE.
- CONSTRUCT ENHANCED AUTOCOURT, PATHWAYS, AND MISCELLANEOUS SITE IMPROVEMENTS IN THE UPPER AREA AND MAIN AREAS.
- COMPLETE ALL PLANTING AND SEEDING WORK.
- FINALIZE ALL WORK INCLUDING BUILDING, SITE WORK AND LANDSCAPE AND PLANTING WORK. PERMANENTLY STABILIZE ALL AREAS ON SITE.
- 8. AFTER SITE IS STABILIZED, ALL EROSION CONTROL MEASURES CAN BE REMOVED AND MONITORING OF THE SITE CAN CEASE ONLY AFTER APPROVAL HAVE BEEN GRANTED BY THE TOWN OF CANANDAIGUA AND/OR THEIR REPRESENTATIVE.
- 9. RAIN GARDENS SHALL NOT BE INSTALLED UNTIL ALL CONTRIBUTING DRAINAGE AREAS HAVE ACHIEVED FINAL STABILIZATION.

ONE STAGE SITE PLAN APPROVAL

PLANNING BOARD CHAIRPERSON	DATE
TOWN HIGHWAY & WATER SUPERINTENDENT	DATE
TOWN ENGINEER	DATE

NO BUILDING PERMIT MAY BE ISSUED UNTIL FINAL SITE PLAN APPROVAL HAS BEEN GRANTED AND THE FINAL SITE PLAN


SIGNED BY THE PLANNING BOARD CHAIRPERSON

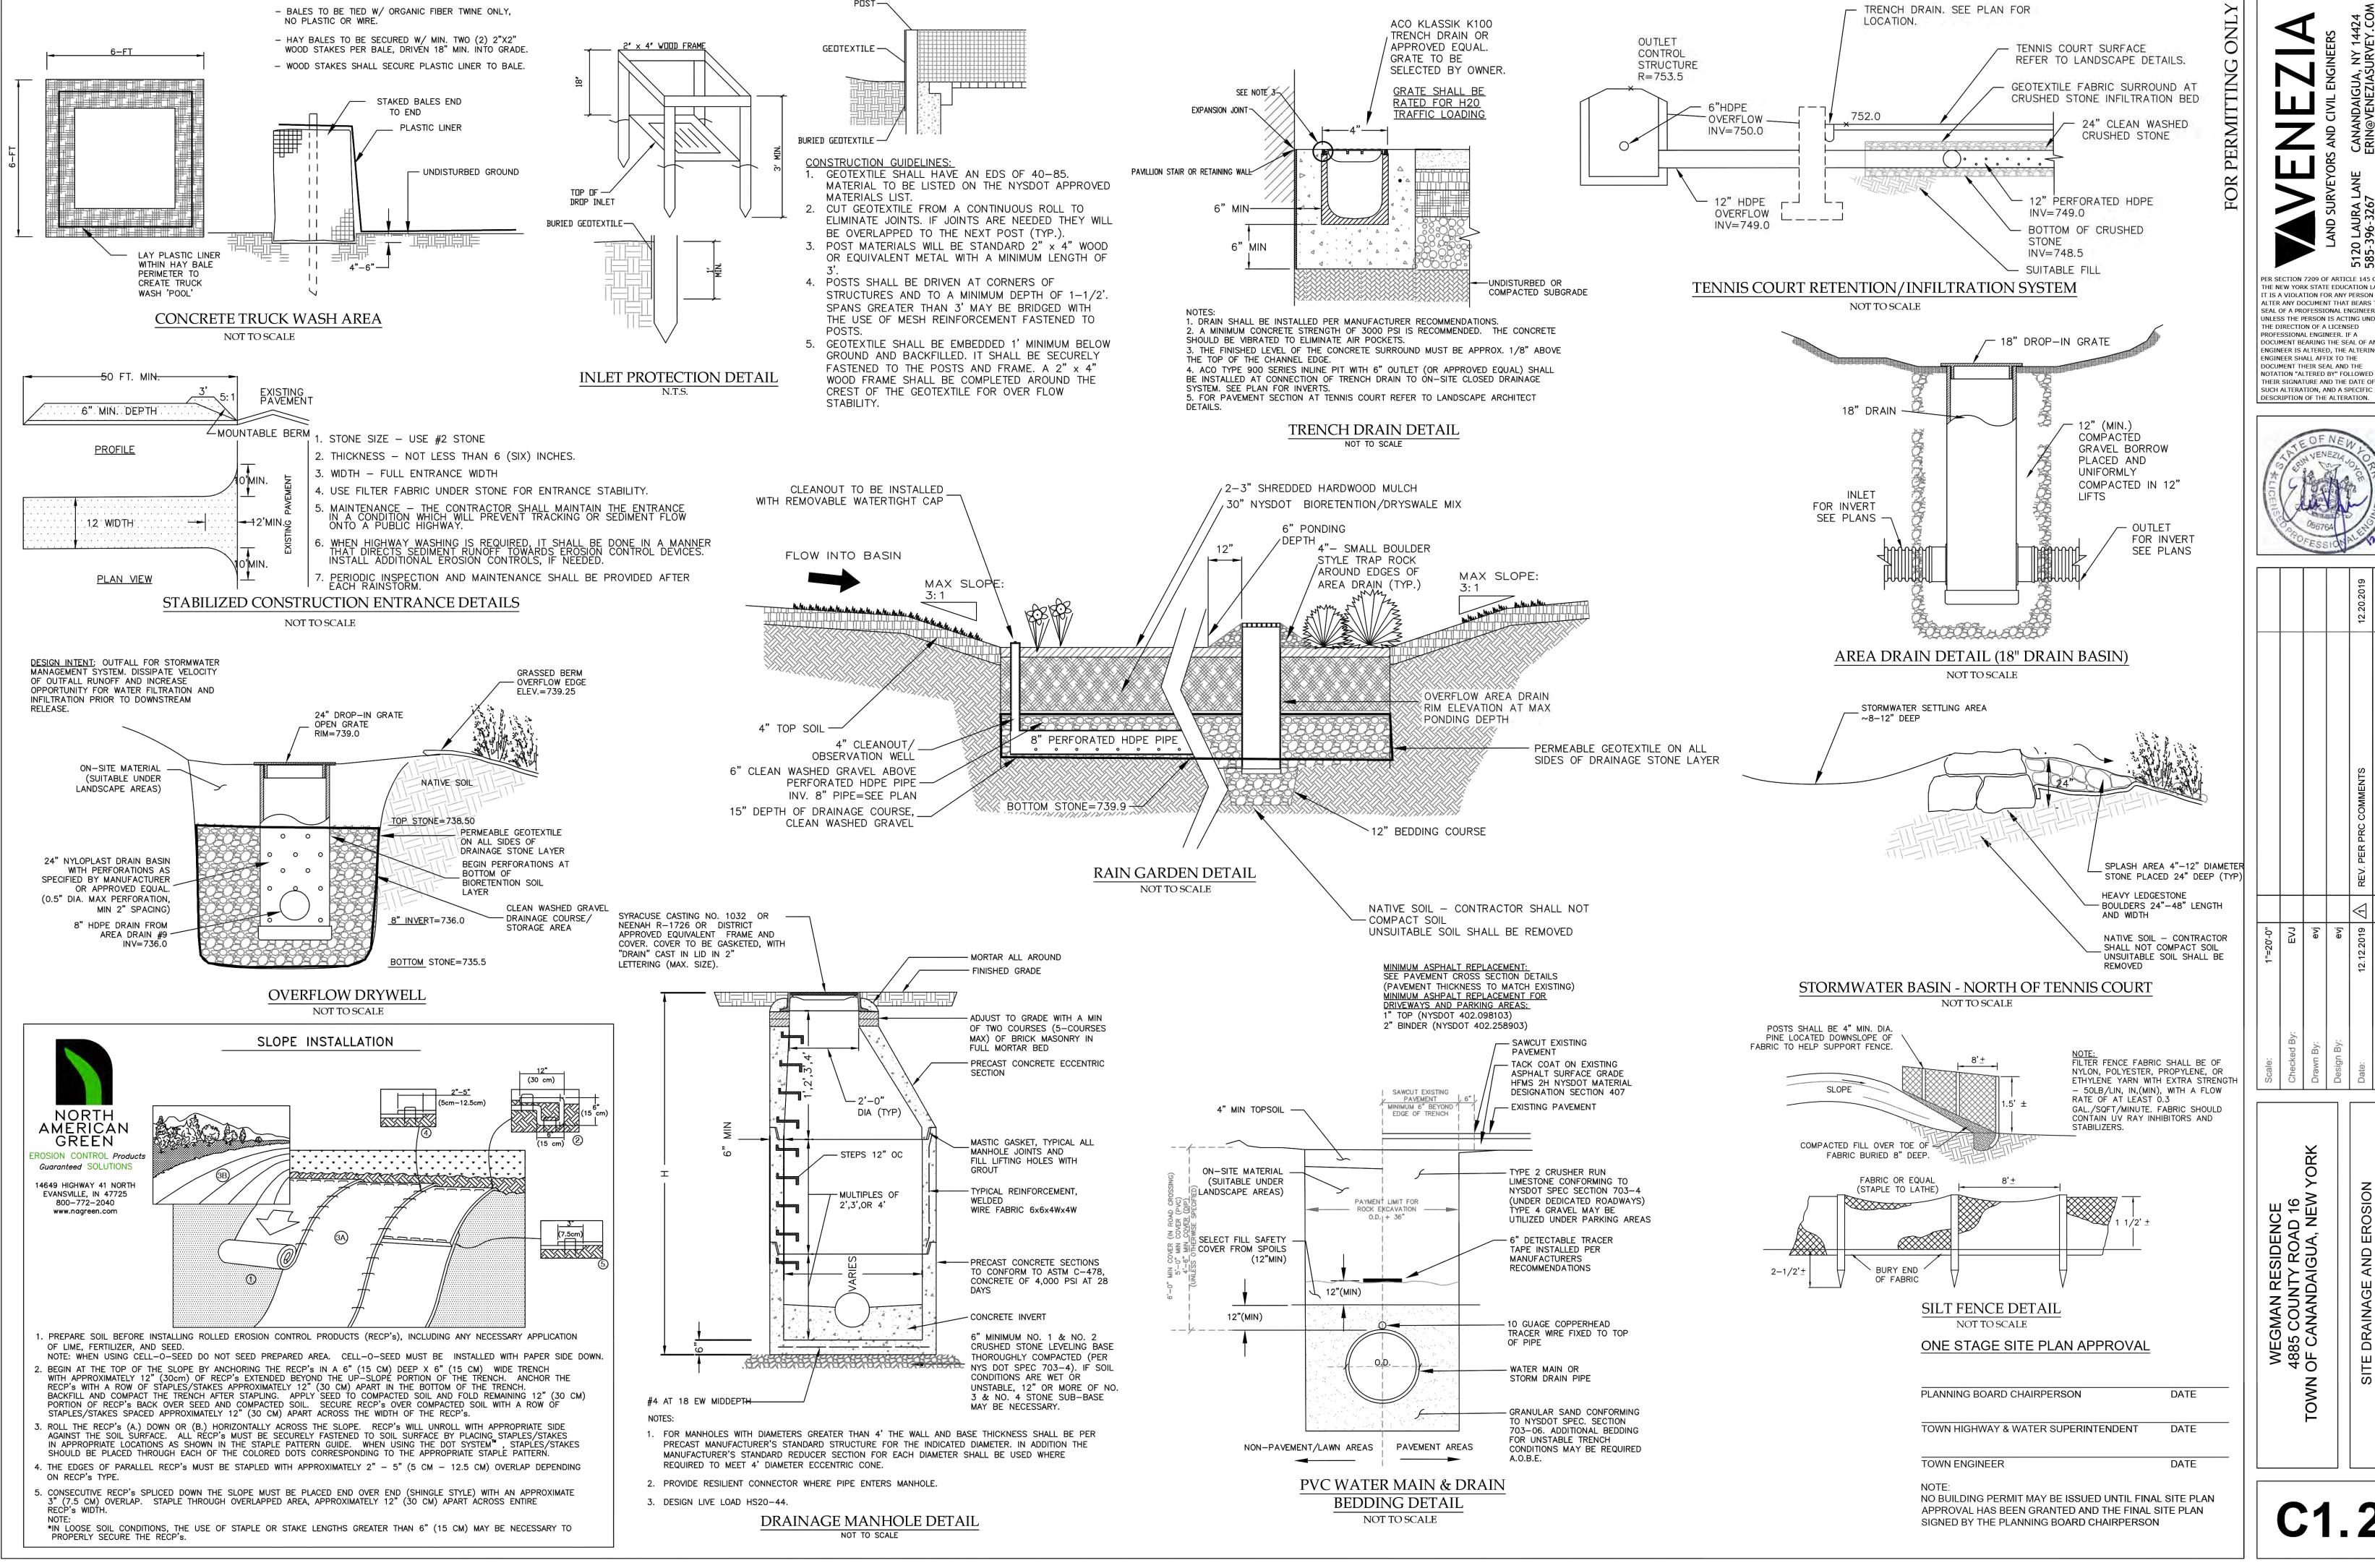

PER SECTION 7209 OF ARTICLE 145 OF THE NEW YORK STATE EDUCATION LAW IT IS A VIOLATION FOR ANY PERSON TO ALTER ANY DOCUMENT THAT BEARS THE SEAL OF A PROFESSIONAL ENGINEER, UNLESS THE PERSON IS ACTING UNDER THE DIRECTION OF A LICENSED PROFESSIONAL ENGINEER. IF A DOCUMENT BEARING THE SEAL OF AN ENGINEER IS ALTERED, THE ALTERING ENGINEER SHALL AFFIX TO THE DOCUMENT THEIR SEAL AND THE NOTATION "ALTERED BY" FOLLOWED BY THEIR SIGNATURE AND THE DATE OF

DESCRIPTION OF THE ALTERATION.

WEGMAN RESIDENCE 4885 COUNTY ROAD 16 OF CANANDAIGUA, NEW Щ

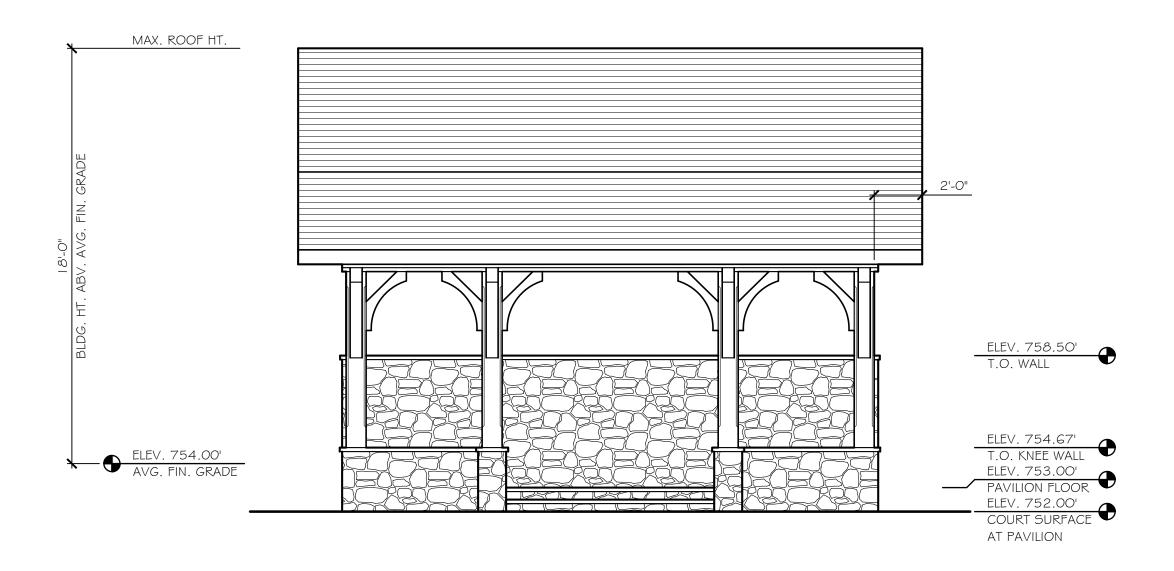

EAST ELEVATION 352 S.F.

SCALE: 1/4"=1'-0"

MAX. ROOF HT.

12
10
2-0'

BLEV. 758.50'
T.O. WALL
ELEV. 758.00'
MAX. FIN. GRADE

ELEV. 753.00'
MAX. FIN. GRADE

COURT SURFACE
AT PAVILLON

AT PAVILLON


AT PAVILLON

AT PAVILLON

COURT SURFACE
AT PAVILLON

NORTH & SOUTH ELEVATIONS

SCALE: 1/4"=1'-0"

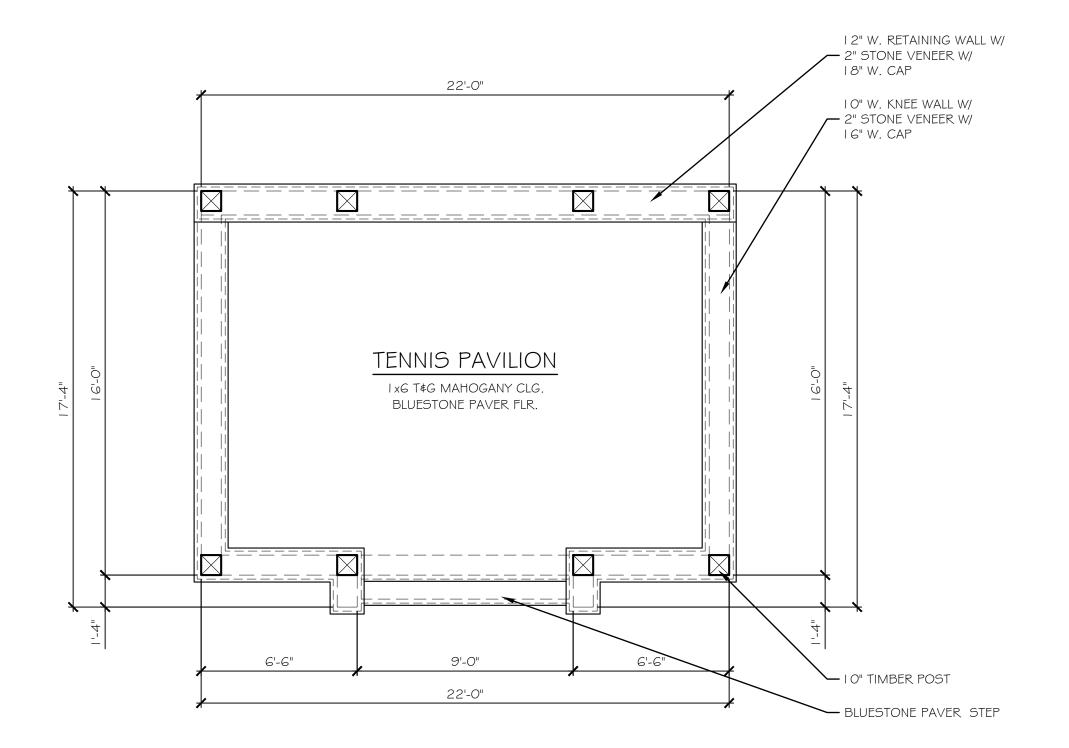



COPYRIGHT NOTICE:
THESE PLANS ARE PROTECTED UNDER FEDERAL
COPYRIGHT LAWS BY JAMES FAHY DESIGN. ANY
REPRODUCTION, OR MODIFICATION OF THESE
PLANS, IN WHOLE OR IN PART, WITHOUT THE
EXPRESS WRITTEN CONSENT OF JAMES FAHY
DESIGN IS A VIOLATION OF COPYRIGHT LAWS.
CLIENT RIGHTS ARE LIMITED TO ONE-TIME USE
FOR CONSTRUCTION OF THESE PLANS.

UNAUTHORIZED ALTERATIONS OR ADDITIONS TO THIS DRAWING IS A VIOLATION OF THE NEW YORK STATE EDUCATION LAW, ARTICLE 145, SECTION 7209.

Copyright © 2019 James Fahy, P.E., P.C. All rights reserved.

	BIONS:	D) :	DEC 62:27:3
NO.	DATE	BY	DESCRIPTION
		+	
		+	
		1	
		-	
		+	
		-	
		+	

PROJECT:
ADDITION
WEGMAN RESIDENCE
4885 WEST LAKE RD.
CANANDAIGUA, NY

CLIENT:

DANNY & PAULA WEGMAN

DRAWING TITLE:
TENNIS COURT PAVILION

PHASE: PRELIMINARY PLAN

JOB NO. A 19-133	PROJECT NO. ADDITION/REN
DRAWN BY: CRB	DRAWING NO:
CHECKED BY: JRF	
DATE: 12-11-2019	111.0

