

EROSION CONTROL NOTES

- 1) IF REQUIRED, THE CONTRACTOR SHALL PROVIDE ADDITIONAL TEMPORARY EROSION CONTROL MEASURES, AT THE EXPENSE OF THE CONTRACTOR OR OWNER, TO PREVENT SILTATION OF DOWNSTREAM PROPERTIES.
- 2) IN THE EVENT THERE IS A FAILURE OF AN EROSION CONTROL DEVICE, THE CONTRACTOR AND OWNER ARE RESPONSIBLE TO RESTORE DOWNSTREAM AREAS AT THEIR EXPENSE.
- 3) ALL EROSION AND SEDIMENT CONTROL MEASURES SHALL BE DESIGNED, INSTALLED AND MAINTAINED PER THE REQUIREMENTS SET FORTH IN THE LATEST EDITION (2016) OF THE NEW YORK STANDARDS AND SPECIFICATIONS FOR EROSION AND SEDIMENT CONTROL.

EXISTING CONDITIONS

- IMPERVIOUS AREA

AS MEASURED IN SQUARE FEET

HOUSE..... 6,190.0
PAVER DRIVEWAY.....2,937.0
PAVER PATIO.....3,117.0
BREAK WALL.....137.0
DECK.....730.0
PORCH.....346.0

TOTAL COVERAGE..... 13,457.0
TOTAL SITE/LAND AREA.....848,836.8
BUILDING COVERAGE.....0.7%
TOTAL LOT COVERAGE.....1.6%

PHOSPHOROUS NOTES



- 1) NO PHOSPHOROUS SHALL BE USED AT PLANTING TIME UNLESS SOIL TESTING HAS BEEN COMPLETED AND TESTED BY A HORTICULTURAL TESTING LAB AND THE SOIL TESTS SPECIFICALLY INDICATE A PHOSPHOROUS DEFICIENCY THAT IS HARMFUL, OR WILL PREVENT NEW LAWNS AND PLANTINGS FROM ESTABLISHING PROPERLY.
- 2) IF SOIL TESTS INDICATE A PHOSPHOROUS DEFICIENCY THAT WILL IMPACT PLANT AND LAWN ESTABLISHMENT, PHOSPHOROUS SHALL BE APPLIED AT THE MINIMUM RECOMMENDED LEVEL PRESCRIBED IN THE SOIL TEST FOLLOWING ALL NYS DEC REQUIREMENTS.

FARM NOTE

THIS PROPERTY WHICH IS THE SUBJECT OF THIS SITE PLAN IS LOCATED ADJACENT TO AN AGRICULTURAL DISTRICT. RESIDENTS SHOULD BE AWARE THAT SUCH FARM OPERATIONS MAY GENERATE DUST, ODOR, SMOKE, NOISE, VIBRATION AND OTHER ACTIVITIES WHICH MAY NOT BE COMPATIBLE WITH RESIDENTIAL USE OF THE PROPERTY.

LEGEND

(R)	DENOTES RECORD INFORMATION		DRAINAGE FLOW DIRECTION
560	EXISTING CONTOUR	G	GAS MAIN/SERVICE
560	PROPOSED CONTOUR	X X X X X X X X	FENCE LINE
---	EXISTING PROPERTY LINE	W	WATERMAIN/WATER SERVICE
---	SETBACK LINE		TREE/BRUSH LINE
---	EASEMENT LINE		UTILITY POLE
-SF-SF-SF-SF-SF-SF-	STAKED SILT FENCE		EDGE OF EXIST. PAVEMENT
---	ROADWAY CENTERLINE		TREE/ SHRUB
E/T	OVERHEAD WIRES-ELECTRIC/ TEL		EXISTING SIGN
X	SURFACE SPOT ELEVATION		HYDRANT/ WATER VALVE
695.8			DEEP/PERCOLATION TEST HOLE

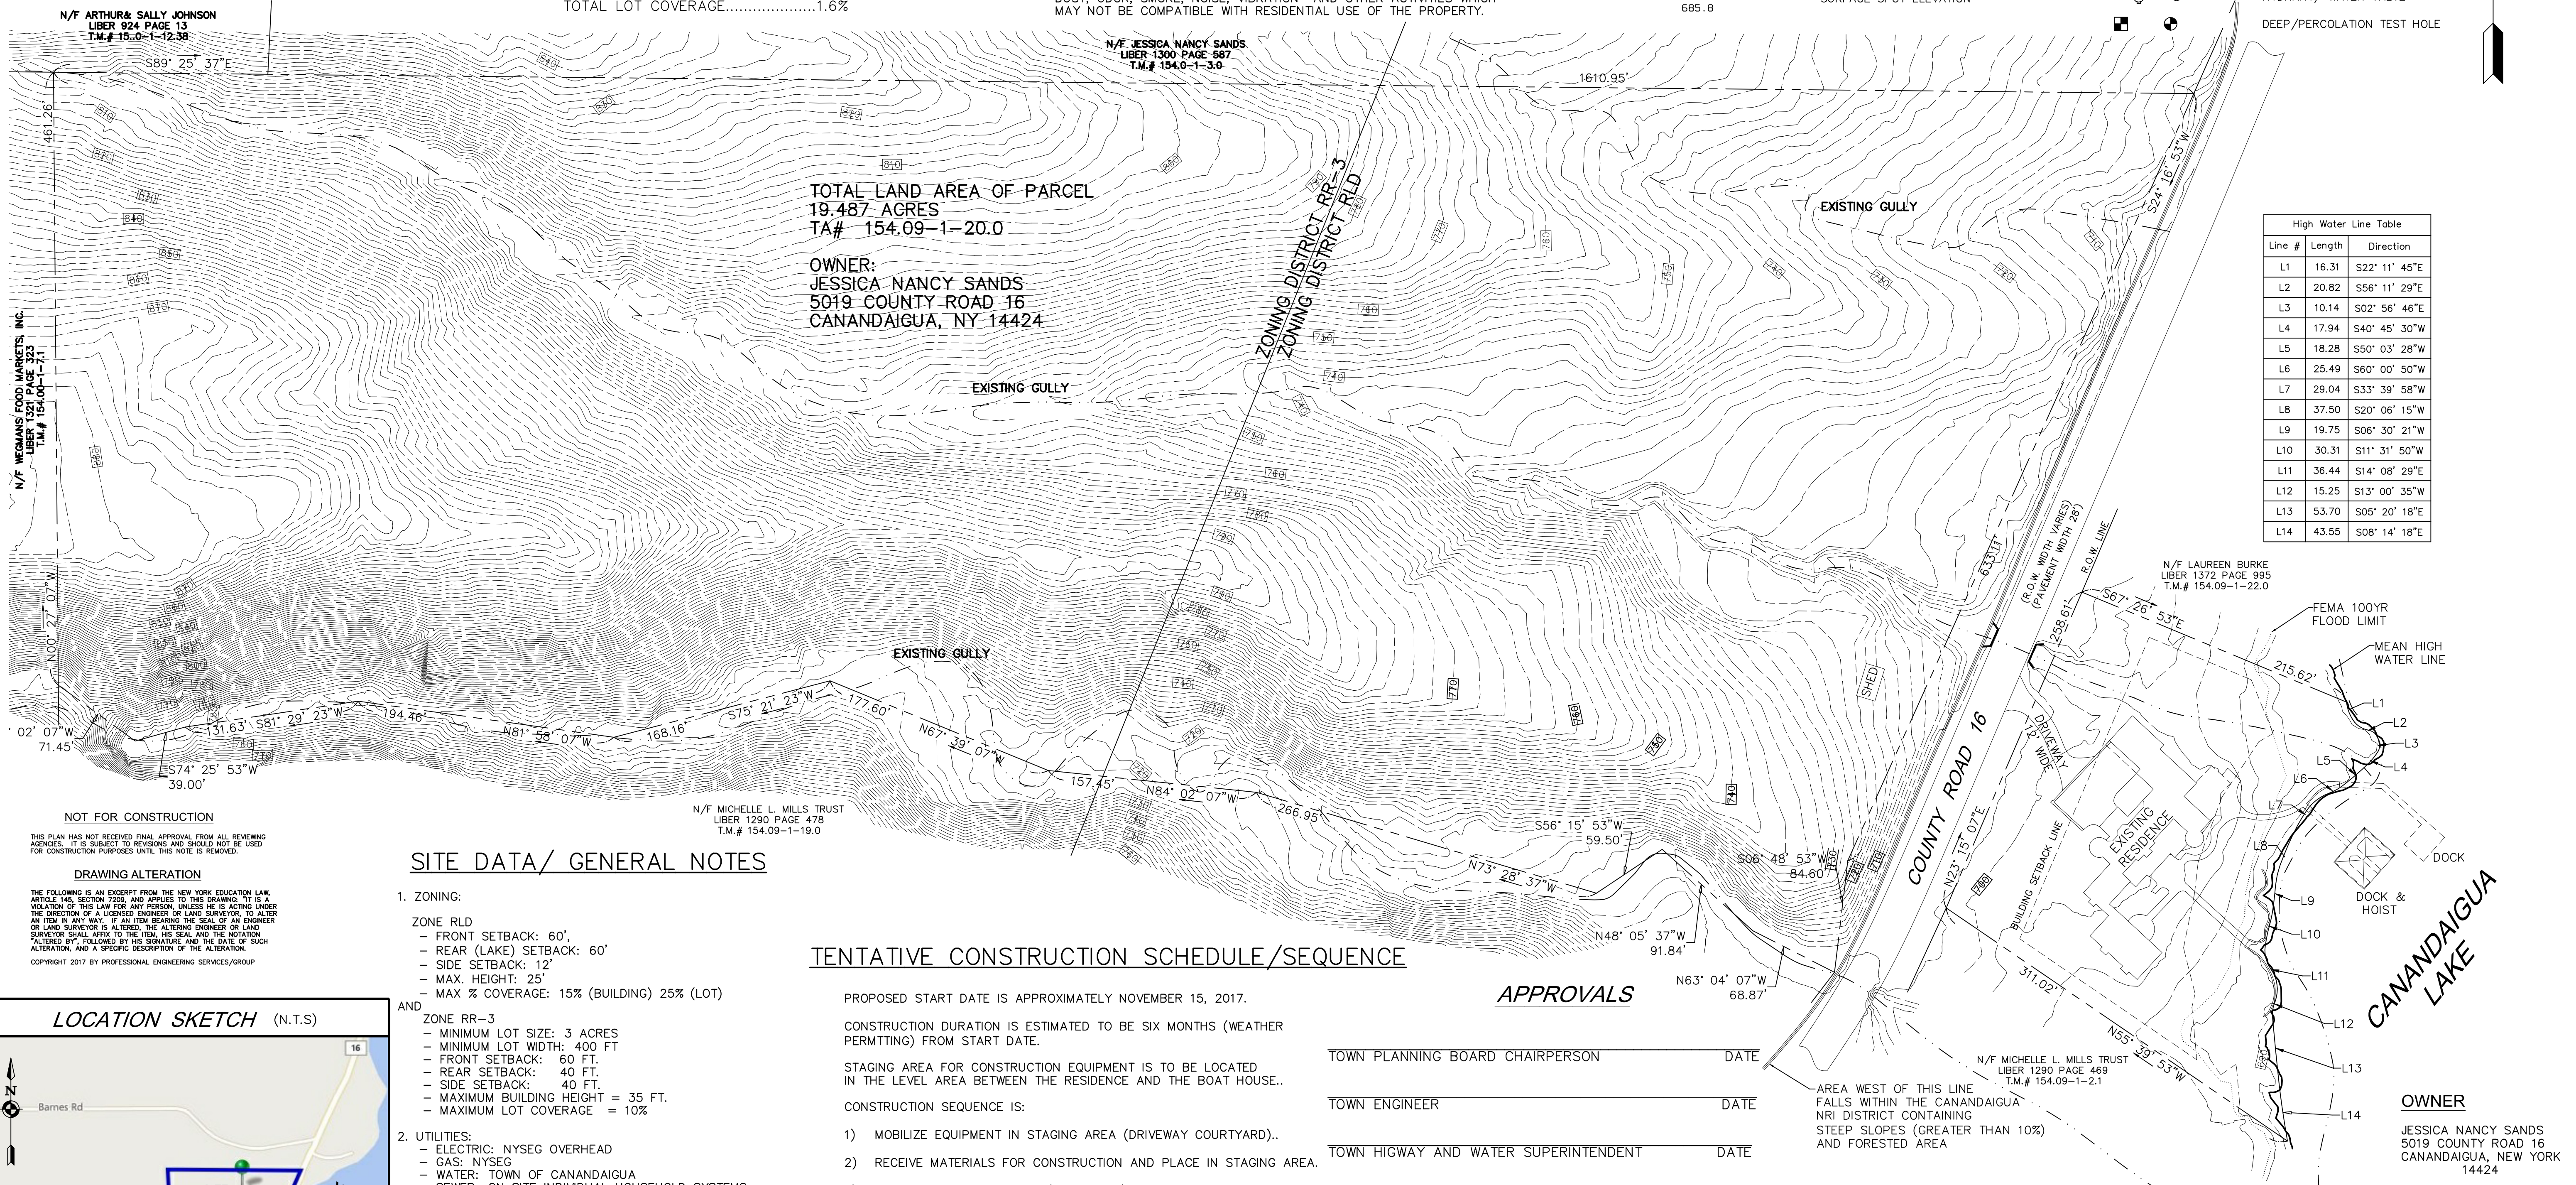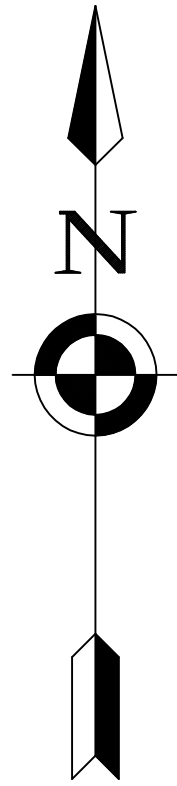

High Water Line Table		
Line #	Length	Direction
L1	16.31	S22° 11' 45"E
L2	20.82	S56° 11' 29"E
L3	10.14	S02° 56' 46"E
L4	17.94	S40° 45' 30"W
L5	18.28	S50° 03' 28"W
L6	25.49	S60° 00' 50"W
L7	29.04	S33° 39' 58"W
L8	37.50	S20° 06' 15"W
L9	19.75	S06° 30' 21"W
L10	30.31	S11° 31' 50"W
L11	36.44	S14° 08' 29"E
L12	15.25	S13° 00' 35"W
L13	53.70	S05° 20' 18"E
L14	43.55	S08° 14' 18"E

NOT FOR CONSTRUCTION

THIS PLAN HAS NOT RECEIVED FINAL APPROVAL FROM ALL REVIEWING AGENCIES. IT IS SUBJECT TO REVISIONS AND SHOULD NOT BE USED FOR CONSTRUCTION PURPOSES UNTIL THIS NOTE IS REMOVED.

DRAWING ALTERATION

THE FOLLOWING IS AN EXCERPT FROM THE NEW YORK EDUCATION LAW, ARTICLE 145, SECTION 7206, AND APPLIES TO THIS DRAWING: "IT IS A VIOLATION OF THIS LAW FOR ANY PERSON, UNLESS HE IS ACTING UNDER THE DIRECTION OF A LICENSED ENGINEER OR LAND SURVEYOR, TO ALTER AN ITEM IN ANY WAY, IF AN ITEM BEARING THE SEAL OF AN ENGINEER OR LAND SURVEYOR IS ALTERED, THE ALTERING ENGINEER OR LAND SURVEYOR SHALL AFFIX TO THE ITEM HIS SEAL AND THE NOTATION, 'ALTERED BY,' FOLLOWED BY HIS SIGNATURE AND THE DATE OF SUCH ALTERATION, AND A SPECIFIC DESCRIPTION OF THE ALTERATION."

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SITE DATA/ GENERAL NOTES

1. ZONING:
- ZONE RLD
- FRONT SETBACK: 60'
 - REAR (LAKE) SETBACK: 60'
 - SIDE SETBACK: 12'
 - MAX. HEIGHT: 25'
 - MAX % COVERAGE: 15% (BUILDING) 25% (LOT)
- AND
- ZONE RR-3
- MINIMUM LOT SIZE: 3 ACRES
 - MINIMUM LOT WIDTH: 400 FT
 - FRONT SETBACK: 60 FT.
 - REAR SETBACK: 40 FT.
 - SIDE SETBACK: 40 FT.
 - MAXIMUM BUILDING HEIGHT = 35 FT.
 - MAXIMUM LOT COVERAGE = 10%
2. UTILITIES:
- ELECTRIC: NYSEG OVERHEAD
 - GAS: NYSEG
 - WATER: TOWN OF CANANDAIGUA
 - SEWER: ON SITE INDIVIDUAL HOUSEHOLD SYSTEMS
3. FLOOD ZONE PER FEMA FIRM PANEL 3605980025C EFFECTIVE DATE MARCH 3, 1997, A PORTION OF THIS PROJECT IS LOCATED IN FLOOD ZONE AE THAT IS IDENTIFIED AS THE AREA DETERMINED TO BE WITHIN THE 100 YEAR FLOODPLAIN.
4. ALL DISTANCES AND ELEVATIONS ARE MEASURED IN DECIMAL FEET. ELEVATIONS SHOWN ARE ON NAD 1988 DATUM. ADD 0.50 FEET TO THESE ELEVATIONS TO OBTAIN 1929 NGVD ELEVATIONS.
5. BASE MAPPING FOR THIS DRAWING WAS PROVIDED BY VENEZIA ASSOCIATES FROM AN INSTRUMENT SURVEY COMPLETED IN MAY 2017.
6. DISTURBED AREA IS APPROXIMATELY 0.40 ACRES.

TENTATIVE CONSTRUCTION SCHEDULE/SEQUENCE

PROPOSED START DATE IS APPROXIMATELY NOVEMBER 15, 2017.

CONSTRUCTION DURATION IS ESTIMATED TO BE SIX MONTHS (WEATHER PERMITTING) FROM START DATE.

STAGING AREA FOR CONSTRUCTION EQUIPMENT IS TO BE LOCATED IN THE LEVEL AREA BETWEEN THE RESIDENCE AND THE BOAT HOUSE..

CONSTRUCTION SEQUENCE IS:

- 1) MOBILIZE EQUIPMENT IN STAGING AREA (DRIVEWAY COURTYARD)..
- 2) RECEIVE MATERIALS FOR CONSTRUCTION AND PLACE IN STAGING AREA.
- 3) PLACE EROSION CONTROLS (SILT FENCE) DOWNSLOPE OF WORK AREA.
- 4) PERFORM DEMOLITION WORK DEFINED IN WORK LEGEND, REMOVE ALL DEBRIS AND EXTRANEIOUS MATERIALS. EXCESS SOIL SHALL BE REMOVED AND NOT STOCKPILED.
- 5) CONSTRUCT IMPROVEMENTS PROGRESSIVELY AS GENERALLY FOLLOWS:
 - CONSTRUCT BUILDING ADDITION/RENOVATION
 - INSTALL LANDSCAPING IMPROVEMENTS
 - INSTALL NEW WASTEWATER SYSTEM COMPONENTS
 - INSTALL NEW WASTEWATER DISPERSAL AREA
- 6) TOPSOIL AND SEED DISTURBED AREAS PER EROSION CONTROL NOTES.
- 7) CLEAN SITE AND DEMOBILIZE EQUIPMENT AND MATERIALS.

APPROVALS

TOWN PLANNING BOARD CHAIRPERSON _____ DATE _____


TOWN ENGINEER _____ DATE _____

TOWN HIGWAY AND WATER SUPERINTENDENT _____ DATE _____

NO PRELIMINARY SITE PLAN REVIEW WAS REQUIRED




REVISIONS		
DATE	BY	DESCRIPTION
9/10/17	SH	LS ARCH AND ARCH DRAWINGS
9/21/17	SH	TOWN PRC COMMENTS

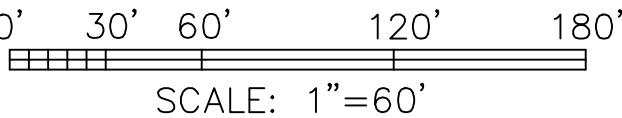

SITE SURVEY AND EXISTING CONDITIONS -1

5019 COUNTY ROAD 16			
TOWN OF CANANDAIGUA, ONTARIO COUNTY, NEW YORK STATE			
PROFESSIONAL ENGINEERING GROUP		CLIENT: DVC INC. 64 STONINGTON DRIVE PITTSFORD, NY 14564 PHONE: (585) 353-3307	
7171 VICTOR - PITTSFORD ROAD VICTOR, NEW YORK 14564 TEL: (585) 924-1860 EMAIL: PROENGINEER1@PRODIGY.NET		TAX ACCOUNT NO. 154.09-1-20.0	
DATE: MARCH 2017	ENGINEER: S.A.H	SURVEYOR: A.V.	SHEET NO.: 1 OF 4
SCALE: 1" = 60'	DRAWING NO.: 172012EX1		

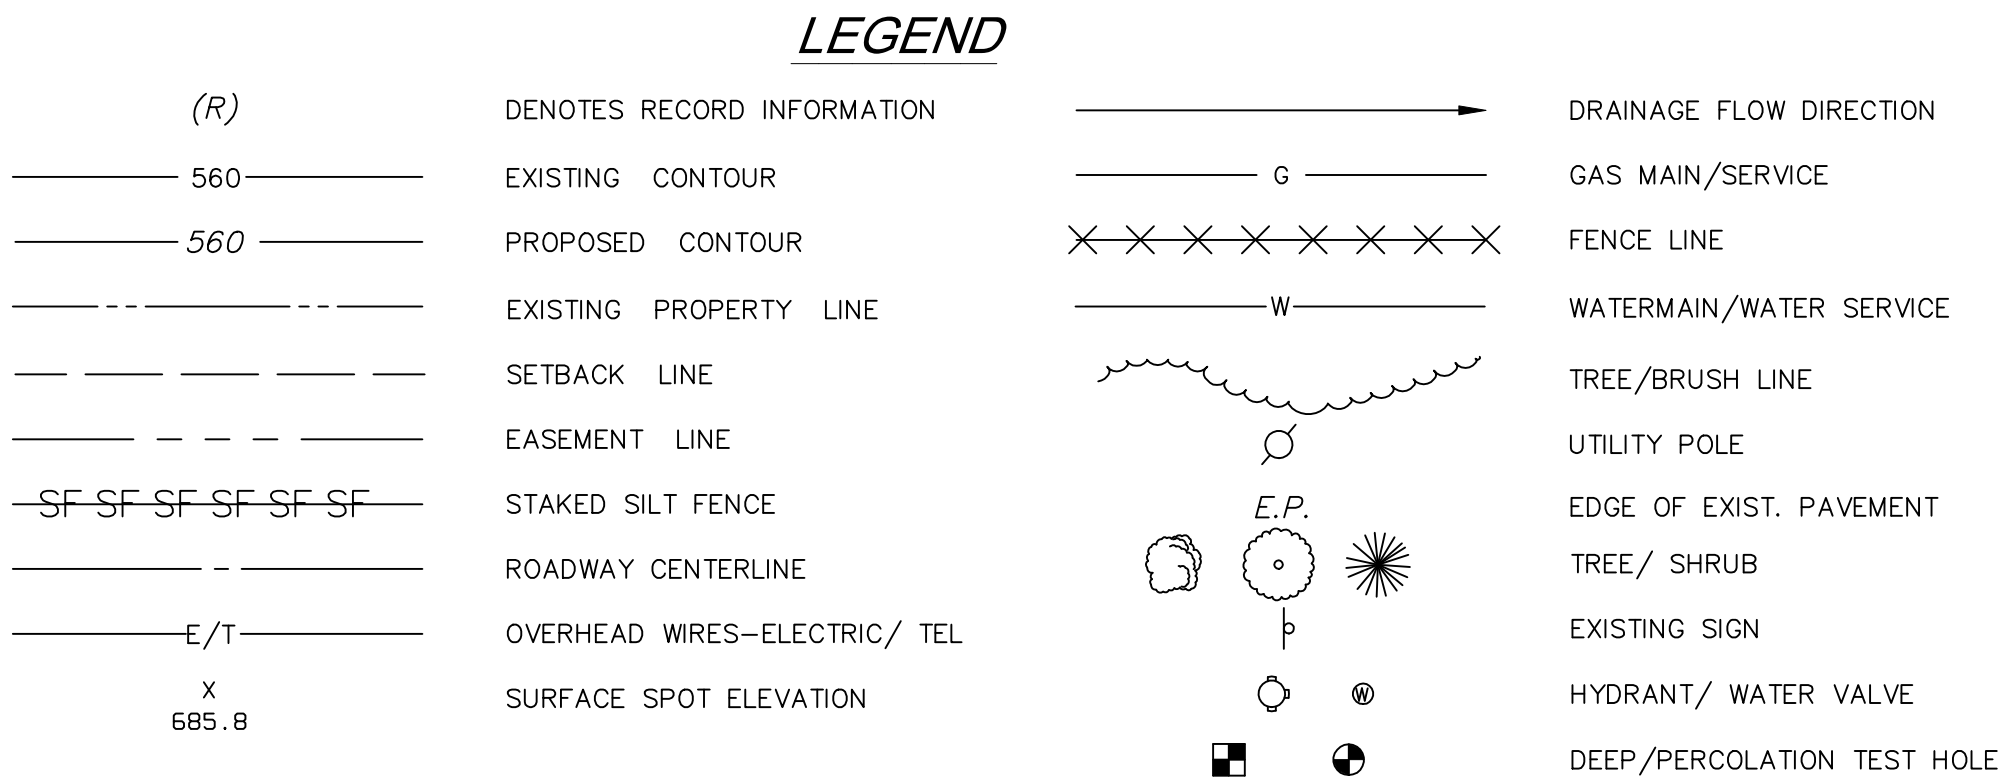

NO PRELIMINARY SITE PLAN REVIEW WAS REQUIRED

SHEET LEGEND	
	RESIDENCE
	EX. PATIO DEMO
	VEGETATION DEMO
	EX. VEGETATION / TREE LINE
	EX. VEGETATION

Plant Schedule					
KEY	BOTANICAL	COMMON	SIZE	ROOT	NOTES
TREES					
TJ	Thuja Occidentalis 'Green Giant'	Green giant Arborvitae	7'-8'	B&B	
SHRUBS					
BM	Buxus 'Green Mountain'	pyramidal boxwood	3'-4'	CONT.	B&B optional
BW	Buxus 'Green Velvet'	boxwood	#5 - #7	CONT.	
HS	Hibiscus syriacus 'Marina' Blue Satin	rose of sharon	#5 - #7	CONT.	
HA	Hydrangea arborescens 'Annabelle'	smooth hydrangea	#5 - #7	CONT.	
HMT	Hydrangea macrophylla 'Twist-n-Shout'	bigleaf hydrangea	#5 - #7	CONT.	
HLL	Hydrangea paniculata 'Limelight'	panicle Limelight hyd.	#5 - #7	CONT.	
PERENNIALS					
EP	Echinacea purpurea	purple coneflower	#3 - #5	CONT.	
VM	Vinca minor	lesser periwinkle	#1	CONT.	


SHORELINE COMPLIANCE NOTE:
THE SITE IS HEAVILY VEGETATED ALONG BOTH THE NORTH AND SOUTH PROPERTY LINES WITH A SERIES OF MATURE TREES BETWEEN THE STRUCTURES AND SHORELINE.

THE PROPOSED REMODELING OF THE EXISTING STRUCTURE FALLS WITHIN THE EXISTING STRUCTURE ENVELOPE WHICH IS AESTHETICALLY SOFTENED BY THE EXISTING CONDITIONS WHICH ARE REMAINING.


THE PROPOSED AREA SHALL HAVE NEW PLANTINGS TO SOFTEN ITS EDGES AND APPEAR AESTHETICALLY CONSISTENT WITH THE EXISTING CONDITIONS, MAKING THE PROJECT UPON ITS COMPLETION UNNOTICEABLE THAT ANY WORK HAD OCCURRED AND THUS CONSISTENT WITH THE SHORELINE COMPLIANCE GUIDELINES.

NOTE:
NET IMPERVIOUS SQUARE FOOTAGE ADDED TO EXISTING CONDITIONS EQUALS 1,310 SF OF FLAGSTONE PAVER


DISTURBED SOIL / TURF SEED NOTE:
ANY DISTURBED AREAS WILL BE BROUGHT TO FINISH GRADE WITH TOPSOIL & HYDROSEED WITH SUMMER GREEN SUPREME SEED MIX
21% 3RD MILLENNIUM SRP TALL FESCUE
21% RHAMBLER SRP TALL FESCUE
21% TRAVERSE SRP TALL FESCUE
21% COCHISE IV TALL FESCUE
10% AMAZING GS PERENNIAL RYEGRASS
6% BROOKLAWN KENTUCKY BLUEGRASS

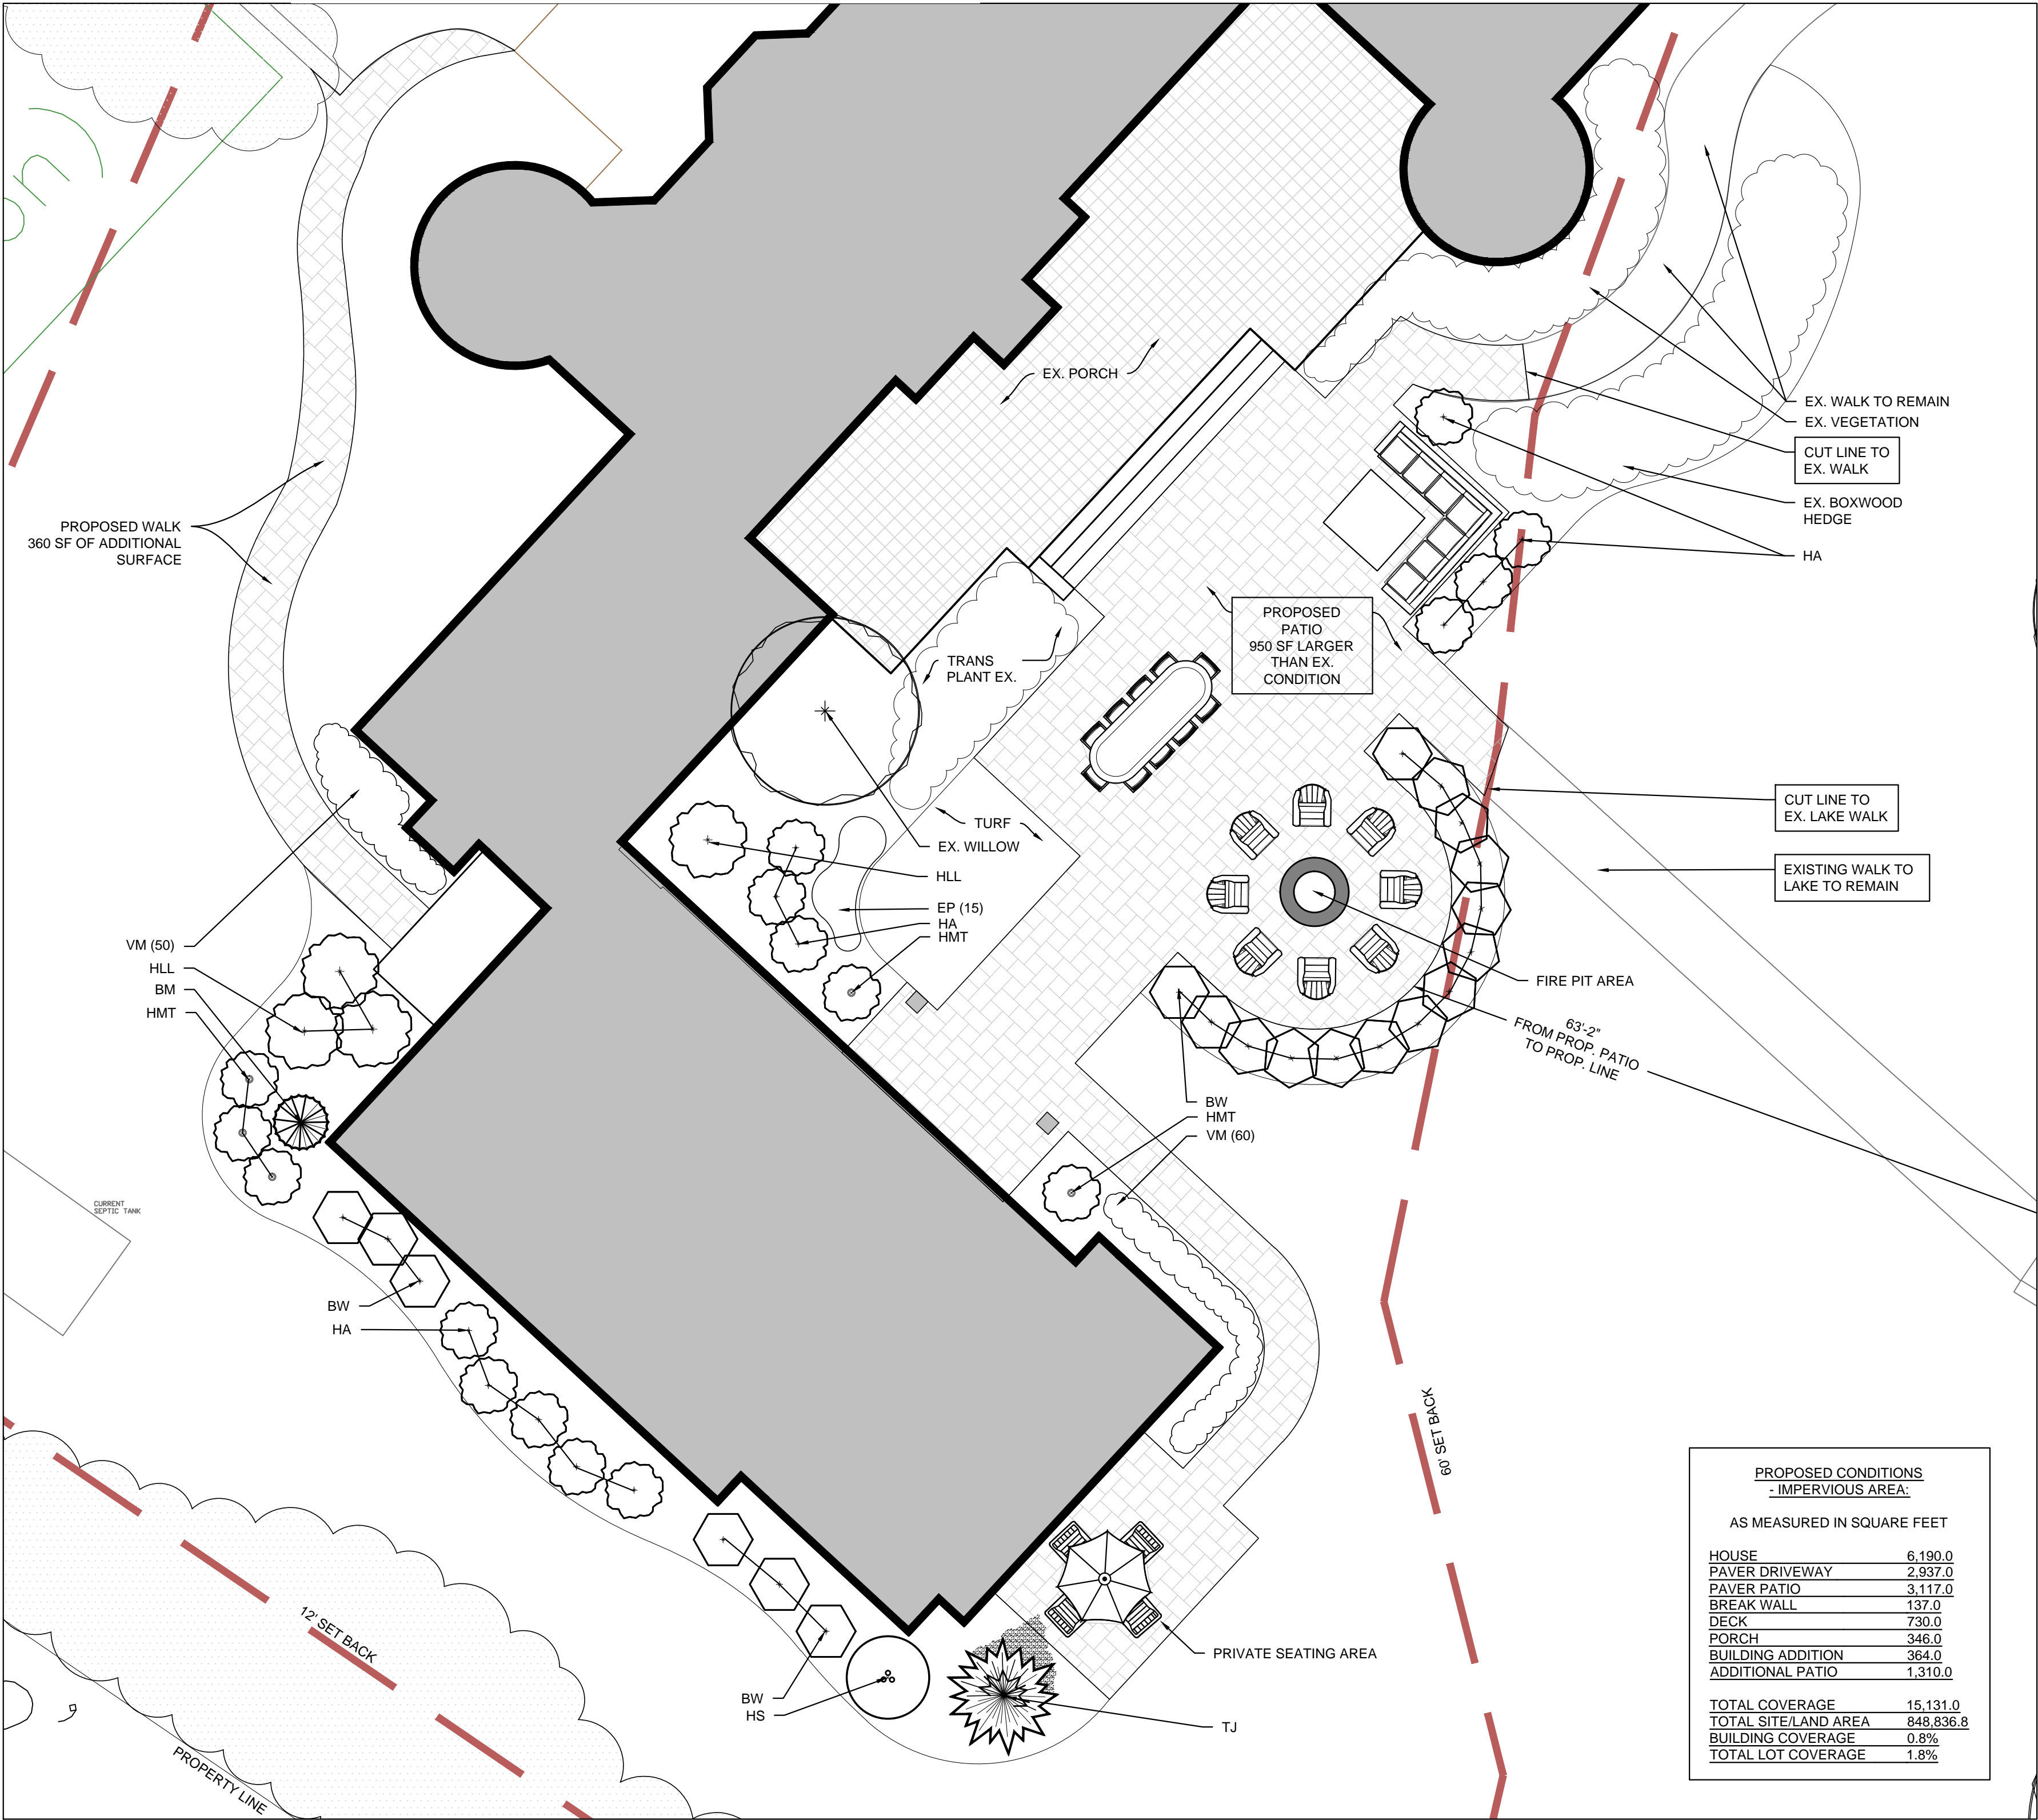

LAYOUT PLAN
SCALE: 1" = 8'

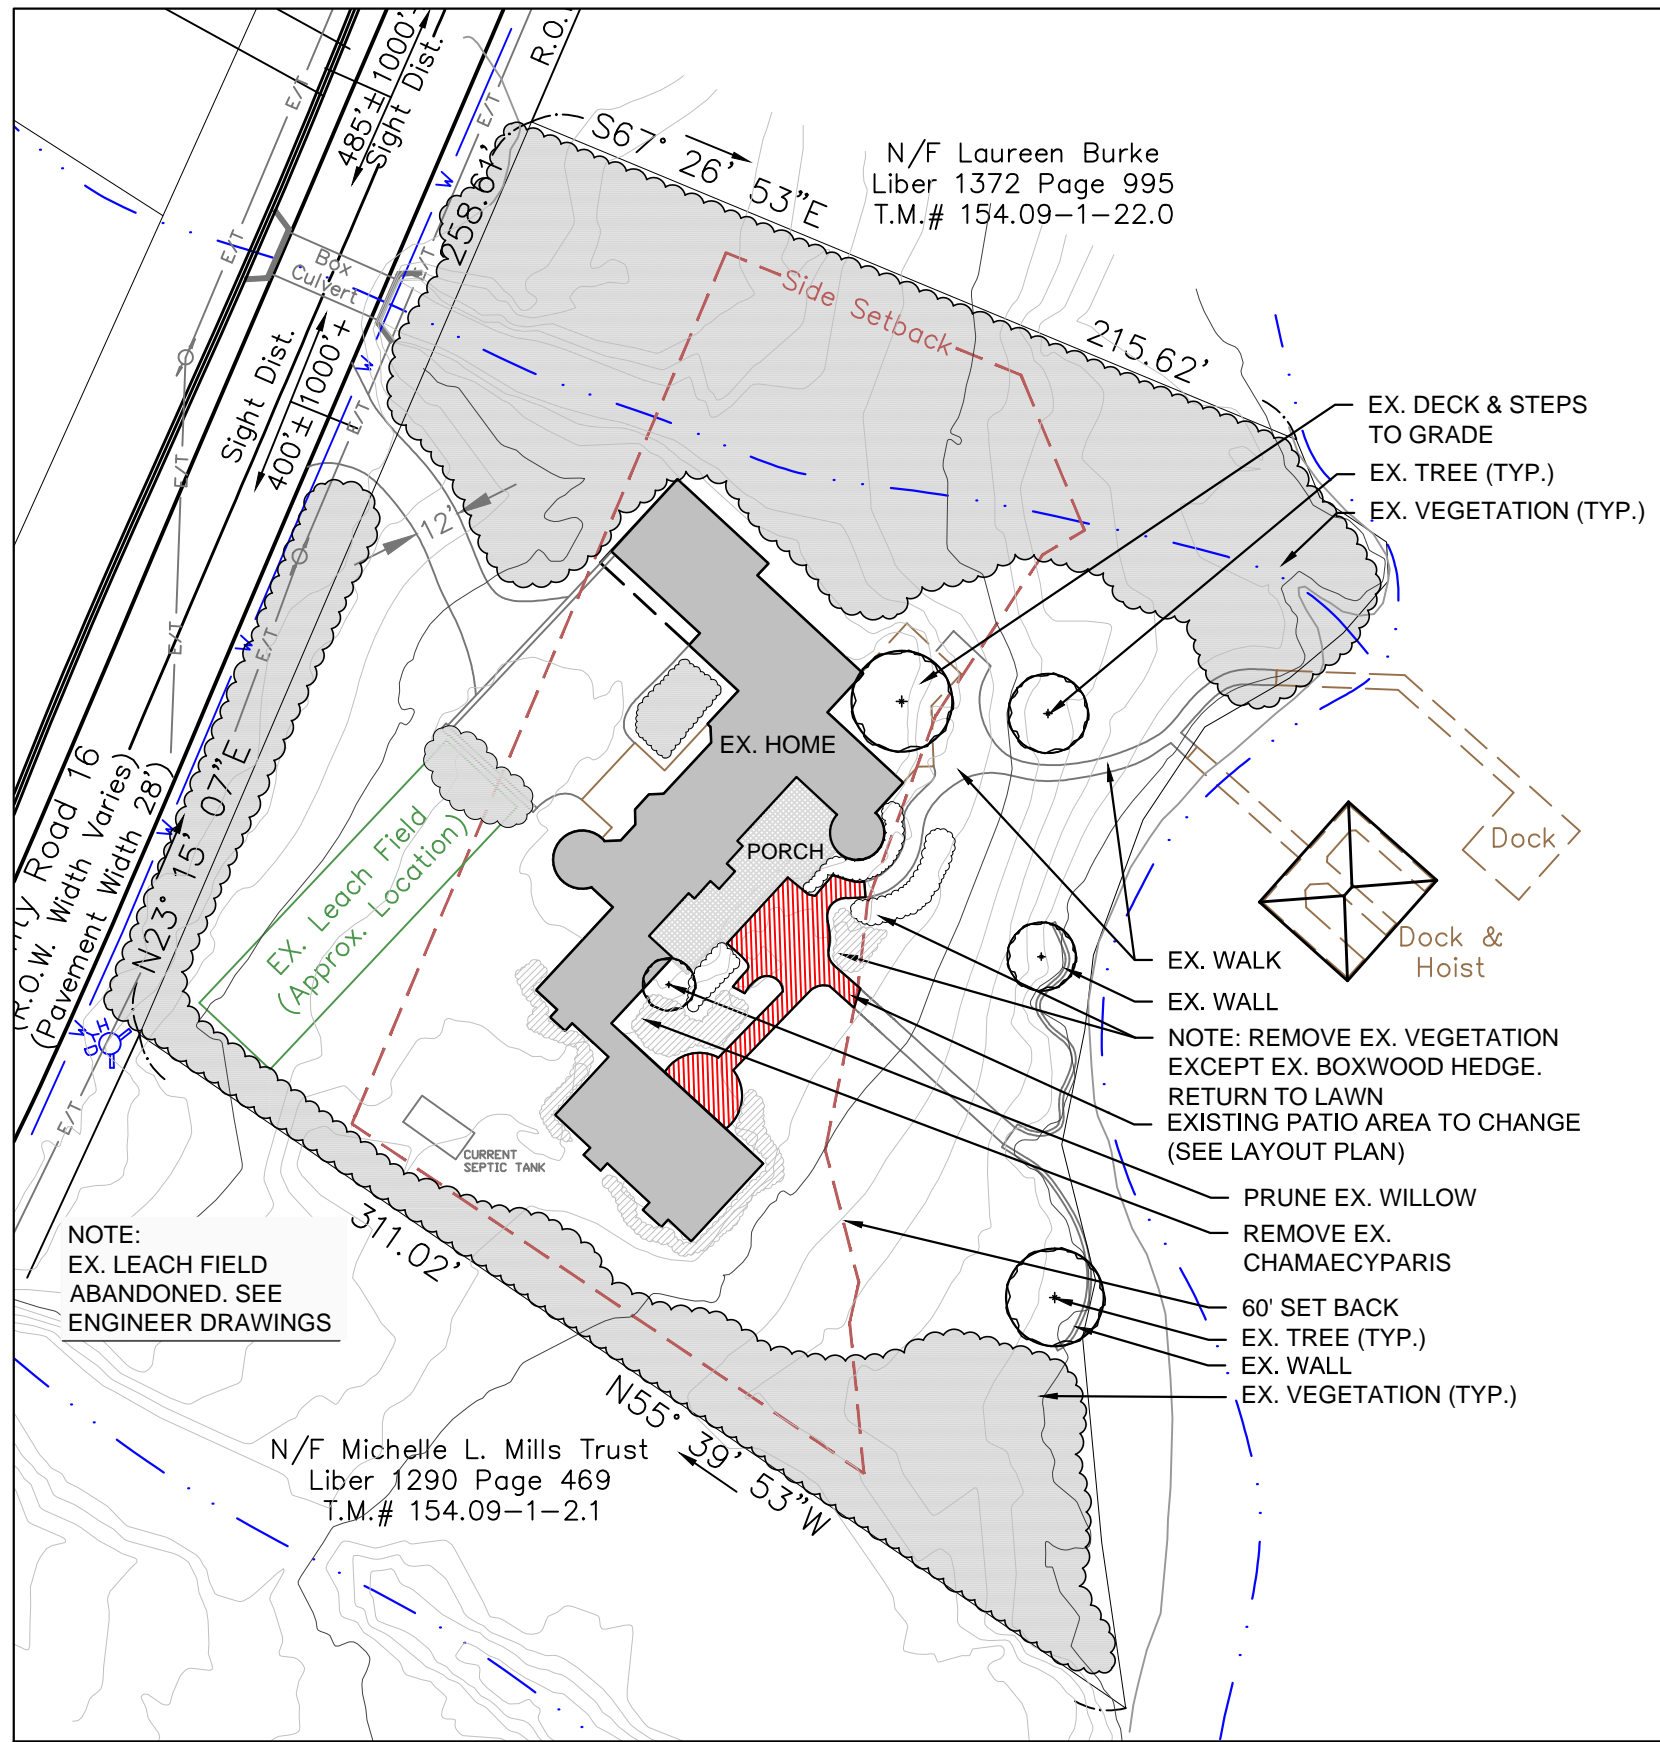

EX. CONDITIONS & LANDSCAPE DEMOLITION PLAN
SCALE: 1"=50'

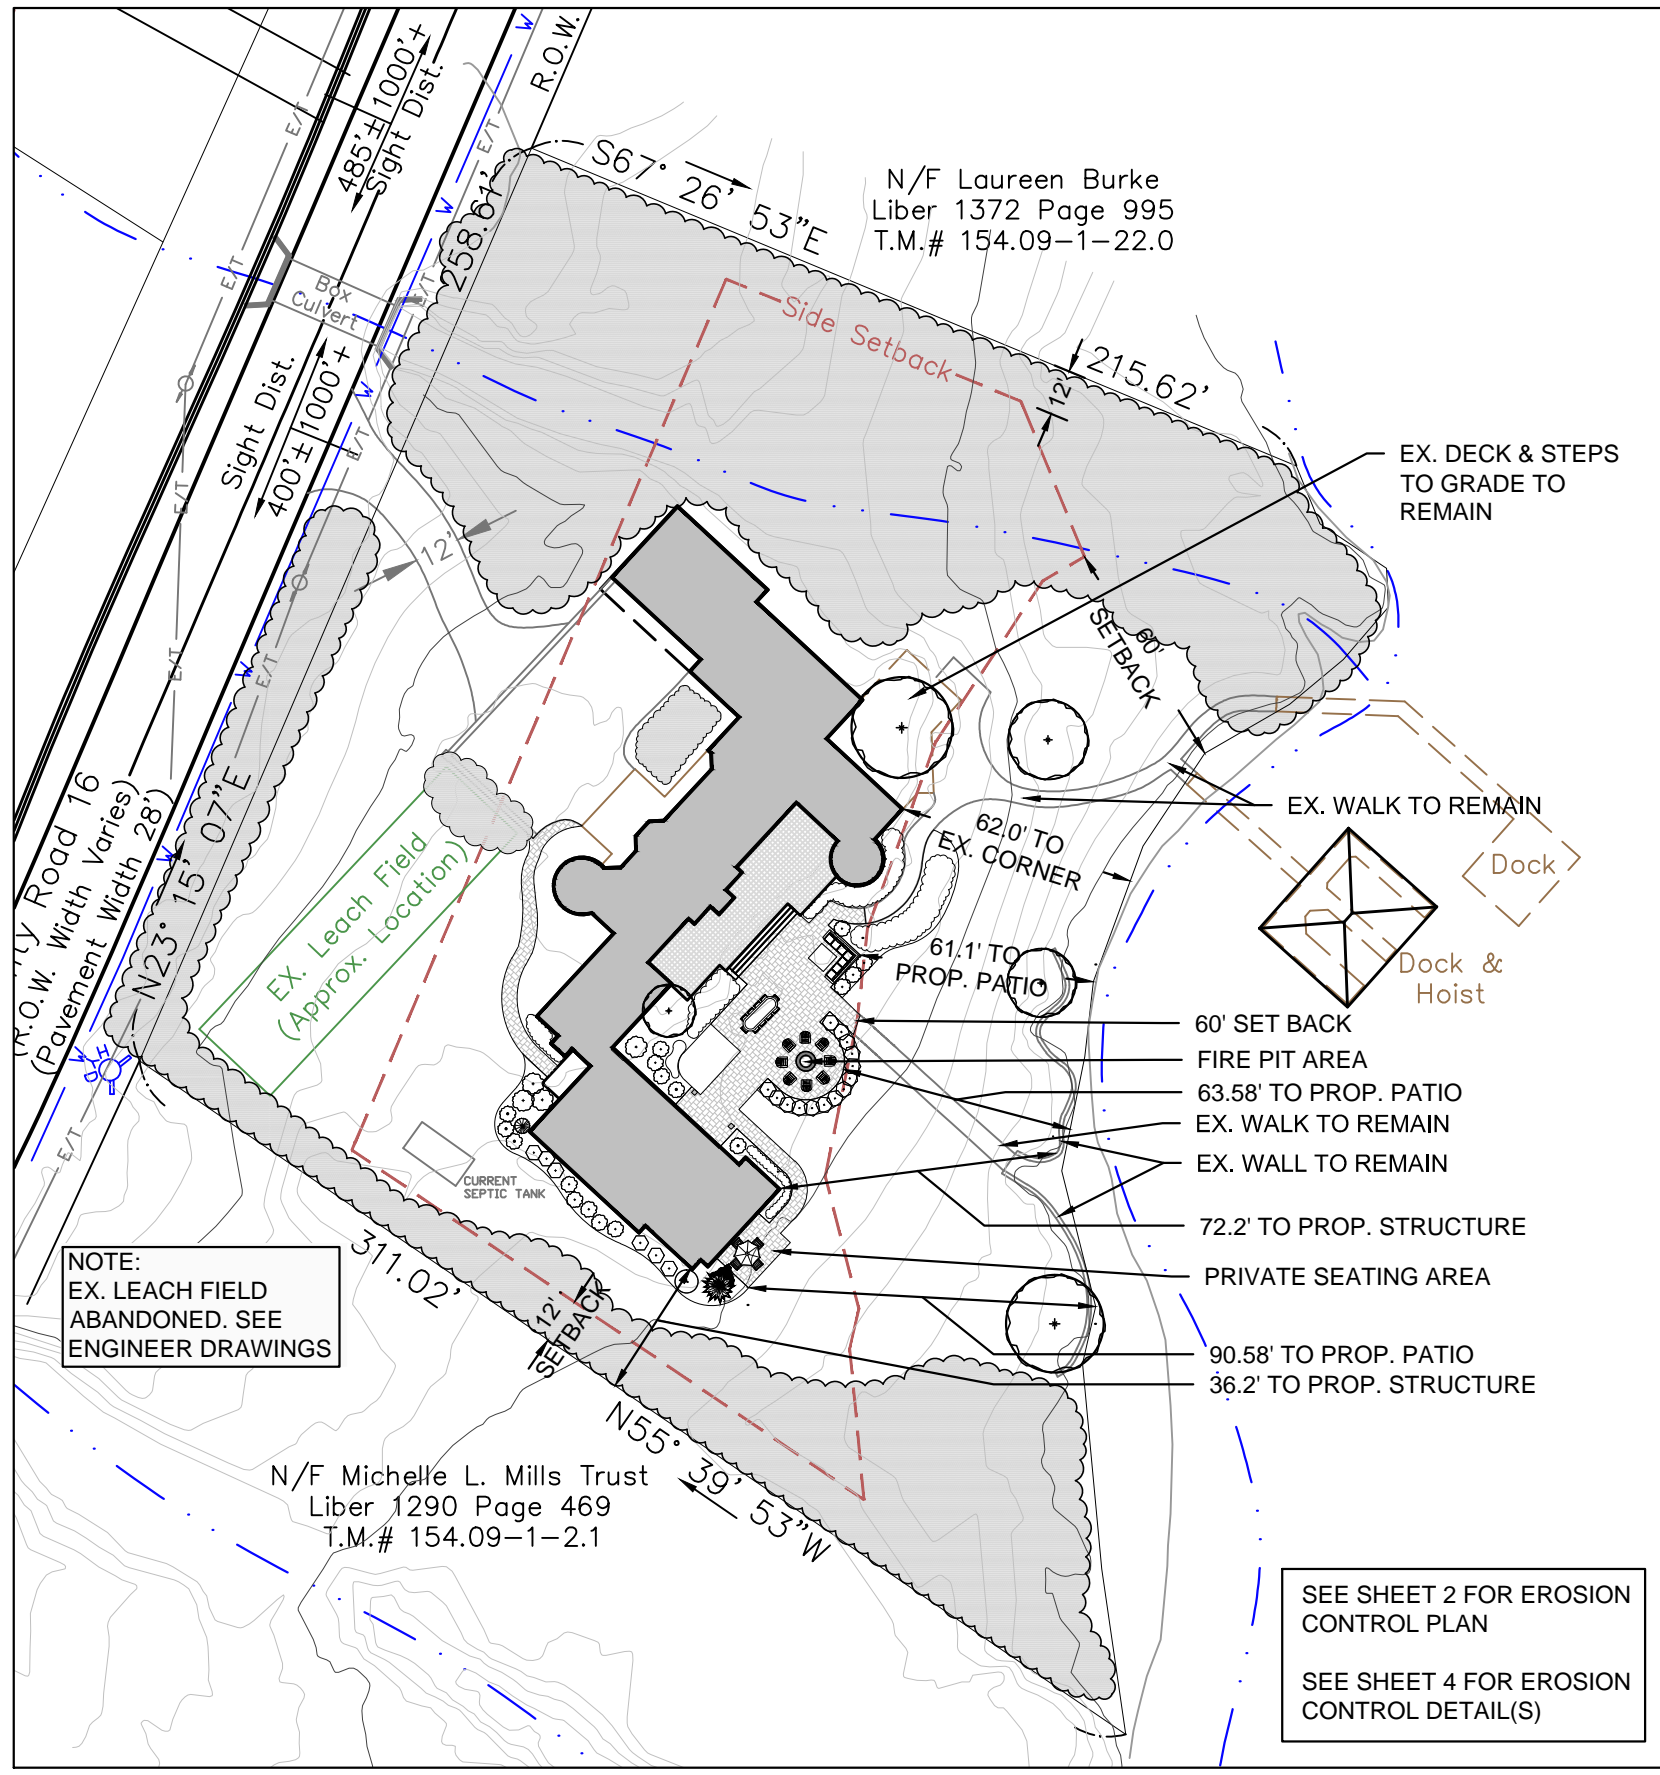


PROPOSED SITE PLAN
SCALE: 1"=50'

DRAWING TITLE:
SITE PLAN -
FOR LAND AT
5019 COUNTY ROAD 16
TOWN OF CANANDAIGUA, NY

CLIENT:
JESSICA NANCY SANDS
107 PARK PLACE,
BROOKLYN, NY 11217

NOTES:

VICINITY MAP:

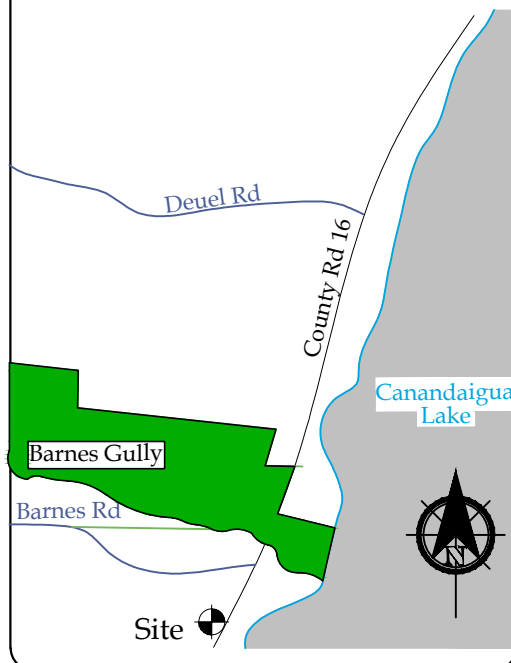

REVISIONS:

DATE	DESCRIPTION

STAMP:

SCALE: AS NOTED

NORTH ARROW: AS NOTED



8000 Victor-Mendon Rd.
Victor, New York 14564
(585)381-9000

SCALE: AS NOTED

DRAWN BY: M.V.

CHECKED BY: D. HACKETT RLA

DATE: 2017-9-21

DATE OF PRINT: 2017-9-21

PROJECT NO.
17088

SHEET NO.


3 OF 4

1. SAFE AND CONTINUOUS TRAFFIC AND INGRESS AND EGRESS FOR ADJACENT OWNER DRIVEWAYS, SERVICE AND PUBLIC ROADS SHALL BE MAINTAINED THROUGH THE PERIOD OF CONSTRUCTION. 14.
2. ALL CONSTRUCTION RELATED TO THIS PROJECT SHALL BE IN CONFORMANCE WITH ALL APPLICABLE LOCAL, STATE, AND FEDERAL REQUIREMENTS. 15.
3. THE CONTRACTOR SHALL OBTAIN ALL APPROPRIATE PERMITS BEFORE BEGINNING ANY CONSTRUCTION. 16.
4. THE CONTRACTOR IS REQUIRED TO NOTIFY CENTRAL STAKEOUT, TELEPHONE NO. 1-800-962-7962 (811) FOR FIELD STAKEOUT OF EXISTING UNDER UTILITIES BEFORE COMMENCING CONSTRUCTION. 17.
5. THE PROPOSED WATER APPURTENANCES SHALL CONFORM TO THE LOCAL WATER AUTHORITY'S STANDARDS. 18.
6. ALL WATER AND WASTEWATER APPURTENANCES SHALL CONFORM TO NYS HEALTH DEPARTMENT STANDARDS. 19.
7. THE CONTRACTOR SHALL PROVIDE FOR EROSION CONTROL BARRIERS DURING CONSTRUCTION AND FOR THE REMOVAL OF THE SAME AFTER GRADING AND SEEDING HAS BEEN ESTABLISHED. 20.
8. THE CONTRACTOR SHALL BE REQUIRED TO CLEAN MUD AND DEBRIS FROM PUBLIC ROADS SERVICING THE CONSTRUCTION SITE DURING AND AFTER THE COMPLETION OF THE PROJECT. 21.
9. THE CONTRACTOR SHALL NOTIFY AGENCIES PRIOR TO ANY EXCAVATING AND REQUEST SUCH UTILITY TO STAKE OUT WATER, GAS, ELECTRIC, AND/OR BURIED TELEPHONE LINES OR CABLES. 22.
10. ALL UTILITIES MUST BE BORED ACROSS THE COUNTY HIGHWAY. "OPEN CUT" OF THE HIGHWAY IS NOT PERMITTED. 23.
11. THE CONTRACTOR SHALL USE DUE CAUTION IN PROTECTING PROPERTY MARKERS AND ALL ELEVATION SURVEY STAKES. 24.
12. THE ACCURACY OF EXISTING UTILITIES ARE NOT GUARANTEED. EXISTING UTILITIES SHOWN ON THE PLANS ARE A RESULT OF THE BEST INFORMATION THAT CAN BE OBTAINED FROM FIELD SURVEYS AND RECORD MAPS AND ARE FOR GENERAL INFORMATION ONLY. IT SHALL BE THE CONTRACTOR'S RESPONSIBILITY TO DETERMINE THE LOCATION OF ALL EXISTING UTILITIES BY FIELD INVESTIGATION. THE CONTRACTOR SHALL ALSO TAKE THE NECESSARY MEASURES TO PRESERVE AND PROTECT EXISTING UTILITIES. 25.
13. ALL ELECTRICAL WORK SHALL BE PERFORMED IN CONFORMANCE WITH ALL NEC AND UL ELECTRICAL CODES. 26.

14. ALL WATERMANS AND SERVICES SHALL HAVE A MINIMUM OF 5' (FEET) OF COVER FROM THE TOP OF THE MAIN TO THE FINISHED GRADE. THE CONTRACTOR SHALL CHECK ALL EXISTING AND PROPOSED TRENCHES TO INSURE THAT ALL INSTALLED WATERMANS WILL HAVE THE REQUIRED COVER.
15. THE CONTRACTOR SHALL COMPLY WITH THE NEW YORK STATE INDUSTRIAL CODE, RULE 23, SUBPART 23-4 "EXCAVATION OPERATIONS," AND ALL APPLICABLE O.S.H.A. REQUIREMENTS SO AS TO PROVIDE SAFE EXCAVATION PROCEDURES.
16. IT IS THE CONTRACTOR'S RESPONSIBILITY TO TEMPORARILY SUPPORT AND MAINTAIN OTHER UTILITIES AS REQUIRED.
17. ALL TRAFFIC MAINTENANCE INCLUDING SIGNS, BARRIQUADES, LIGHTS AND OTHER TRAFFIC CONTROL DEVICES SHALL BE IN CONFORMANCE WITH THE REQUIREMENTS OF THE NEW YORK STATE MANUAL OF UNIFORM TRAFFIC CONTROL DEVICES.
18. PROPOSED SLOPES SHALL NOT EXCEED 1 ON 3 EXCEPT WHERE NOTED.
19. THE CONTRACTOR SHALL READ AND BECOME COMPLETELY FAMILIAR WITH THE APPROVED DESIGN PLANS. SHOULD THE CONTRACTOR HAVE ANY QUESTIONS CONCERNING THE PROJECT DESIGN, CONTACT THE DESIGN ENGINEER PRIOR TO COMMENCING CONSTRUCTION.
20. MINIMUM SEPARATION BETWEEN WATERMAIN AND SEWER MAINS TO BE MAINTAINED VERTICALLY FROM THE OUTSIDE OF THE PIPES AT THE POINT OF CROSSING. MINIMUM HORIZONTAL SEPARATION BETWEEN WATERMANS AND SEWER MAINS/SERVICES TO BE 10' (FEET) MEASURED FROM THE OUTSIDE OF THE PIPES. IF A CROSSING SHOULD OCCUR ONE FOOT OF SEPARATION SHALL BE MAINTAINED BETWEEN THE TOP OF THE WATERMAIN SO THAT BOTH THE JOINTS WILL BE AS FAR FROM THE SEWER AS POSSIBLE. WHERE A WATERMAIN CROSSES UNDER A SEWER ADEQUATE STRUCTURAL SUPPORT SHALL BE PROVIDED TO MAINTAIN THE SEWER SHALL BE PROVIDED FOR THE SEWER TO PREVENT SETTLING.

PER TESTING, MINIMUM TRENCH DEPTH IN NATIVE SOIL TO BE 24'

N.T.S.

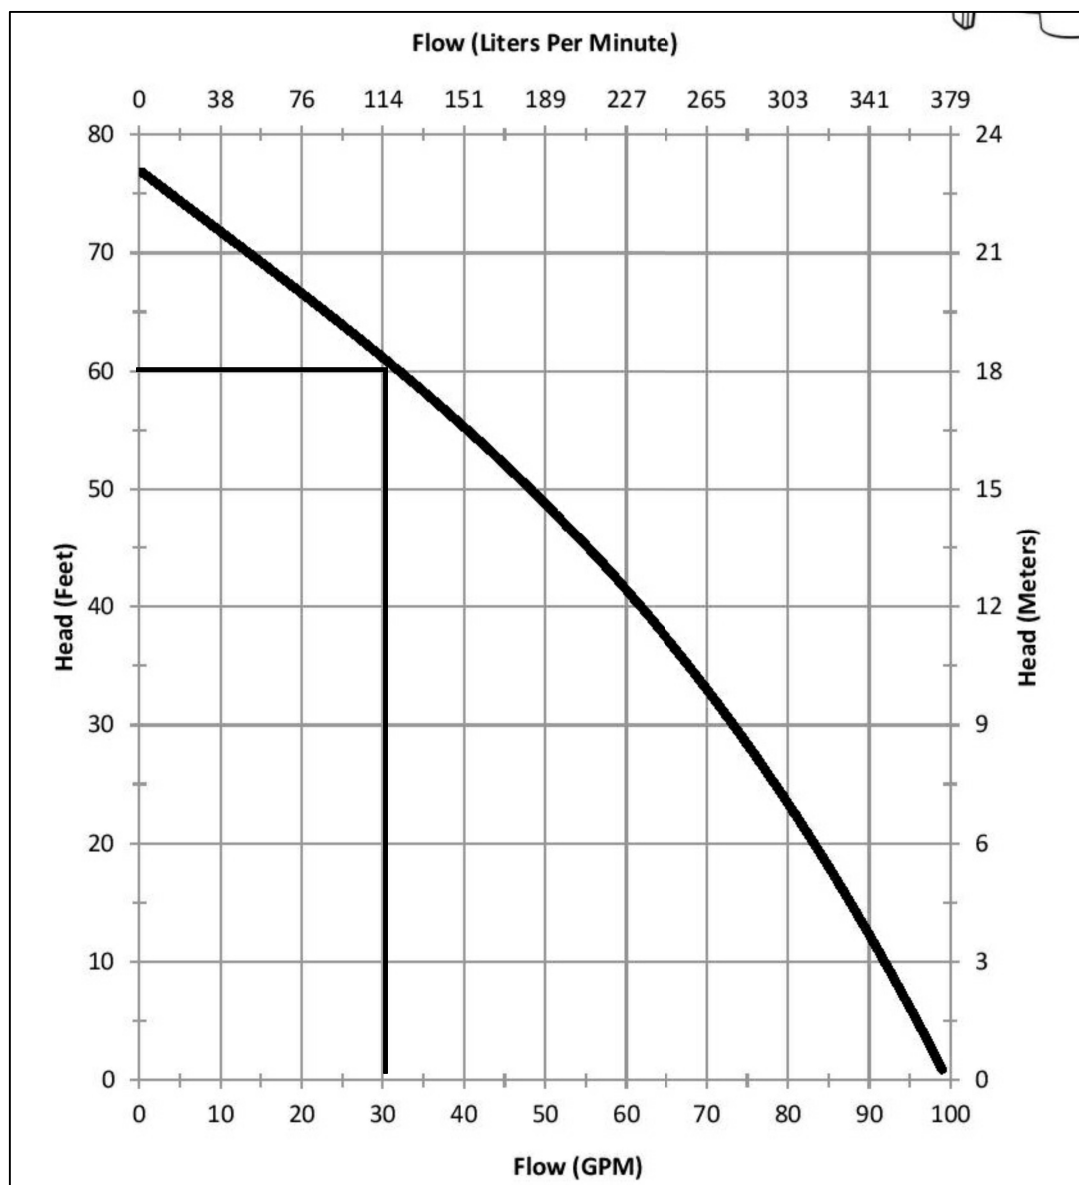

WASTEWATER PUMP SIZING CALCULATIONS

$$\text{ELEVATION DIFFERENCE FROM INVERT OF PUMP TO DISTRIBUTION BOX} = 691.0'(+/-) - 737.0'(+/-) = 46.0'(+/-).$$

HEADLOSS IN FEET THROUGH 1/4-1/2" DIA. 280' LENGTH OF HDPE OR PVC PIPE AT 30 GPM FLOW RATE = 9.7' (PER PIPE HEADLOSS CHART)

ESTIMATED HEADLOSS THROUGH FITTINGS = 5'

TOTAL HEADLOSS AT 35 GPM DOSE = $46+9.7+5=60.7$


PER CHART, FLOW RATE WILL WORK AT 30 GPM.

DOSING CALCULATION

50% OF 280 LINEAL FEET OF 4" DIA. PVC LINE EQUIVALENT. VOLUME = $792 \times \pi \times 0.333^{**2}/4$
 $\times 7.481 = 517$ GALLONS.

USING 6' DIAMETER MANHOLE, EACH VERTICAL FOOT WITHIN THE MANHOLE PROVIDES $\pi \times 6^2/4 \times 1 \times 7.481 = 211$ GALLONS. $517/211 = 2.45'$ ELEVATION RISE TO TRIGGER DOSING.

1. THE CONTRACTOR SHALL CONTACT THE CANANDAIGUA LAKE WATERSHED INSPECTOR PRIOR TO COMMENCING CONSTRUCTION OF THE WASTEWATER SYSTEM.
2. A PERPETUAL MAINTENANCE AGREEMENT BETWEEN THE WASTEWATER AERATION SYSTEM MANUFACTURER'S REPRESENTATIVE AND THE OWNER IS REQUIRED. A COPY OF THAT AGREEMENT IS TO BE PROVIDED TO THE CANANDAIGUA LAKE WATERSHED INSPECTOR'S OFFICE.
3. THE ABSORPTION SYSTEM AREA (DISPERSAL AREA OR LEACH FIELD) IS, AT MINIMUM, TO BE SEEDED AND MAINTAINED AS A LAWN.
4. SURFACE WATER IS TO BE ADEQUATELY CONTROLLED BY ACHIEVING POSITIVE SURFACE GRADING AS SHOWN.
5. PERCOLATION TESTING OF THE IMPORTED FILL MATERIAL IS REQUIRED TO CONFIRM THE DESIGN PERCOLATION RATE.
6. THE MALFUNCTION ALARMS FOR THE AERATION TREATMENT UNITS AND ALL PUMPS SHALL BE PROVIDED IN A CONSPICUOUS LOCATION WITHIN THE RESIDENCE, SUCH AS THE KITCHEN.
7. HOT TUBS MAY NOT CONNECT (DRAIN) TO THE WASTEWATER SYSTEM.
8. THE WW SYSTEM MUST BE DESIGNED, SUPERVISED AND CERTIFIED BY A DESIGN PROFESSIONAL.
9. GARBAGE GRINDERS ARE NOT ALLOWED.
10. THE AEROBIC TREATMENT UNIT WILL BE EQUIPPED WITH AN APPROPRIATE ALARM SYSTEM AS WILL EACH PUMP IN EACH PUMP STATION.
11. THE SERVICE CONTRACT FOR THE AEROBIC TREATMENT UNIT MUST PROVIDE FOR SEMI ANNUAL INSPECTIONS BY AN AUTHORIZED MANUFACTURERS REPRESENTATIVE FOR AS LONG A TIME PERIOD AS THE UNIT IS IN USE. A COPY OF THAT SERVICE CONTRACT AND REPORTS FO THE SEMI-ANNUAL INSPECTIONS SHALL BE PROVIDED TO THE OFFICE OF THE CANANDAIGUA LAKE WATERSHED INSPECTOR.
12. MULTI-FAUCET ("CAR WASH" STYLE) SHOWERS ARE NOT PERMITTED.

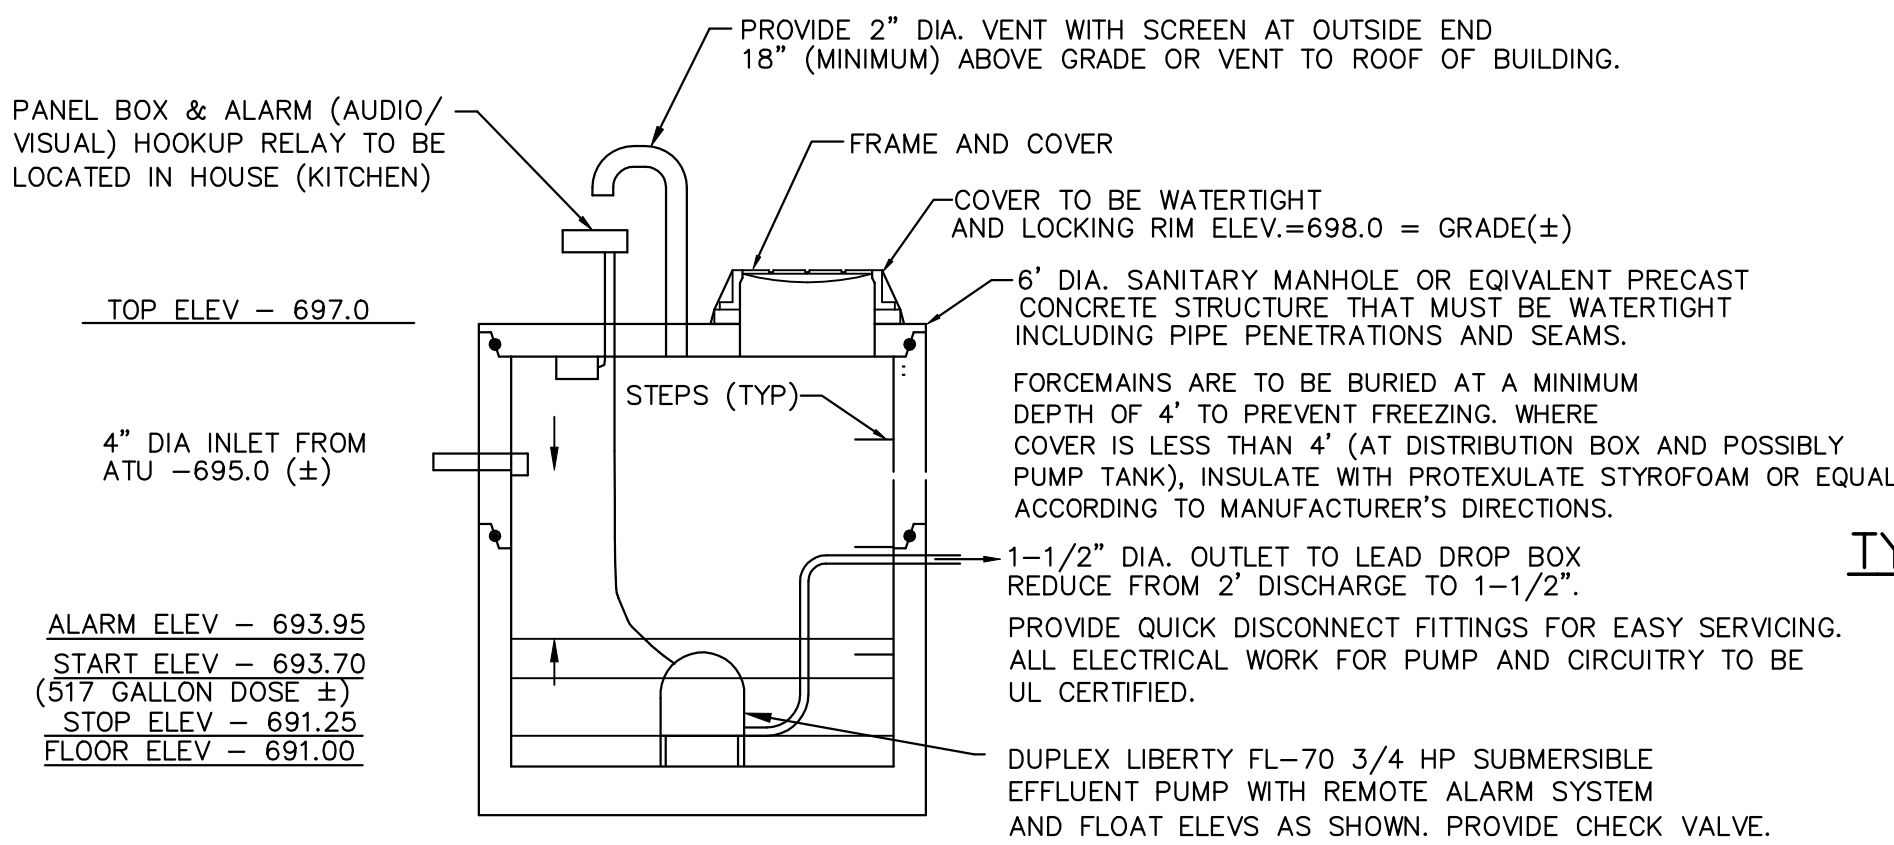

PROVIDE CONSTANT SLOPE BACK TO WET WELL FROM HIGH POINT AT LEAD DROP BOX

ALL PENETRATIONS AND SEAMS TO BE WATERTIGHT

N.T.S.

[illegible]

DETAIL SHEET				
5019 COUNTY ROAD 16				
TOWN OF CANANDAIGUA, ONTARIO COUNTY, NEW YORK STATE				
PROFESSIONAL ENGINEERING GROUP			CLIENT: DVC INC. 64 STONINGTON DRIVE PITTSFORD, NY 14564 PHONE: (585) 353-3307	
7171 VICTOR - PITTSFORD ROAD VICTOR, NEW YORK 14564 TEL. (585) 924-1860 EMAIL: PROENGINEER1@PRODIGY.NET			TAX ACCOUNT NO. 154.09-1-20.0	
DATE: MARCH 2017	ENGINEER: S.A.H	SURVEYOR: A.V.	SCALE: AS SHOWN	SHEET NO.: 4 OF 4 DRAWING NO.: 172012DT1

NO PRELIMINARY SITE PLAN REVIEW WAS REQUIRED

5019 COUNTY ROAD 16

TOWN OF CANANDAIGUA, ONTARIO COUNTY, NEW YORK STATE

*PROFESSIONAL
ENGINEERING*

7171 VICTOR - PITTSFORD ROAD

VICTOR, NEW YORK 14564 TAX ACCOUNT NO.

L. (585) 924-1860 EMAIL: PROENGINEER1@PRODIGY.NET 154.09-1-20.0

DATE:	ENGINEER:	SURVEYOR:	SCALE:	SHEET NO.:	DRAWING NO.:
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MARCH 2017	S A H	A V	AS SHOWN	4 OF 4	172012DT1
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L GINEERING <i>GROUP</i> PITTSFORD ROAD	CLIENT: DVC INC. 64 STONINGTON DRIVE PITTSFORD, NY 14564 PHONE:(585) 353-3307
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TAX ACCOUNT NO.
154.09-1-20.0

SHEET NO.: DRAWING NO.:

4 OF 4 172012DT1

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