# PRELIMINARY/FINAL SITE PLANS for MR. & MRS. JOHN SMITH 4519 DAVIDSON LANDING DRIVE

SITUATE IN:

TOWN OF CANANDAIGUA - ONTARIO COUNTY - STATE OF NEW YORK



LOCATION MAP

NOT TO SCALE



ROCHESTER LOCATION

3 9 CASCADE DRIVE
ROCHESTER, NY 14614
5 8 5 - 4 5 8 - 7 7 7 0

1THACA LOCATION

840 HANSHAW RD, STE 12


ITHACA, NY 14850
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LIST OF DRAWINGS		
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2	V1.0	EXISTING CONDITIONS & DEMOLITION PLAN
3	C2.0	SITE PLAN & NOTES
4	C2.1	EROSION CONTROL PLAN
5	C2.2	LANDSCAPING PLAN
6	C3.0	CONSTRUCTION DETAILS

APPLICANT:
JOHN AND JOANNE SMITH
4519 DAVIDSON LANDING
CANANDAIGUA, NY 14424



APPROVED BY:

PLANNING BOARD CHAIRMAN
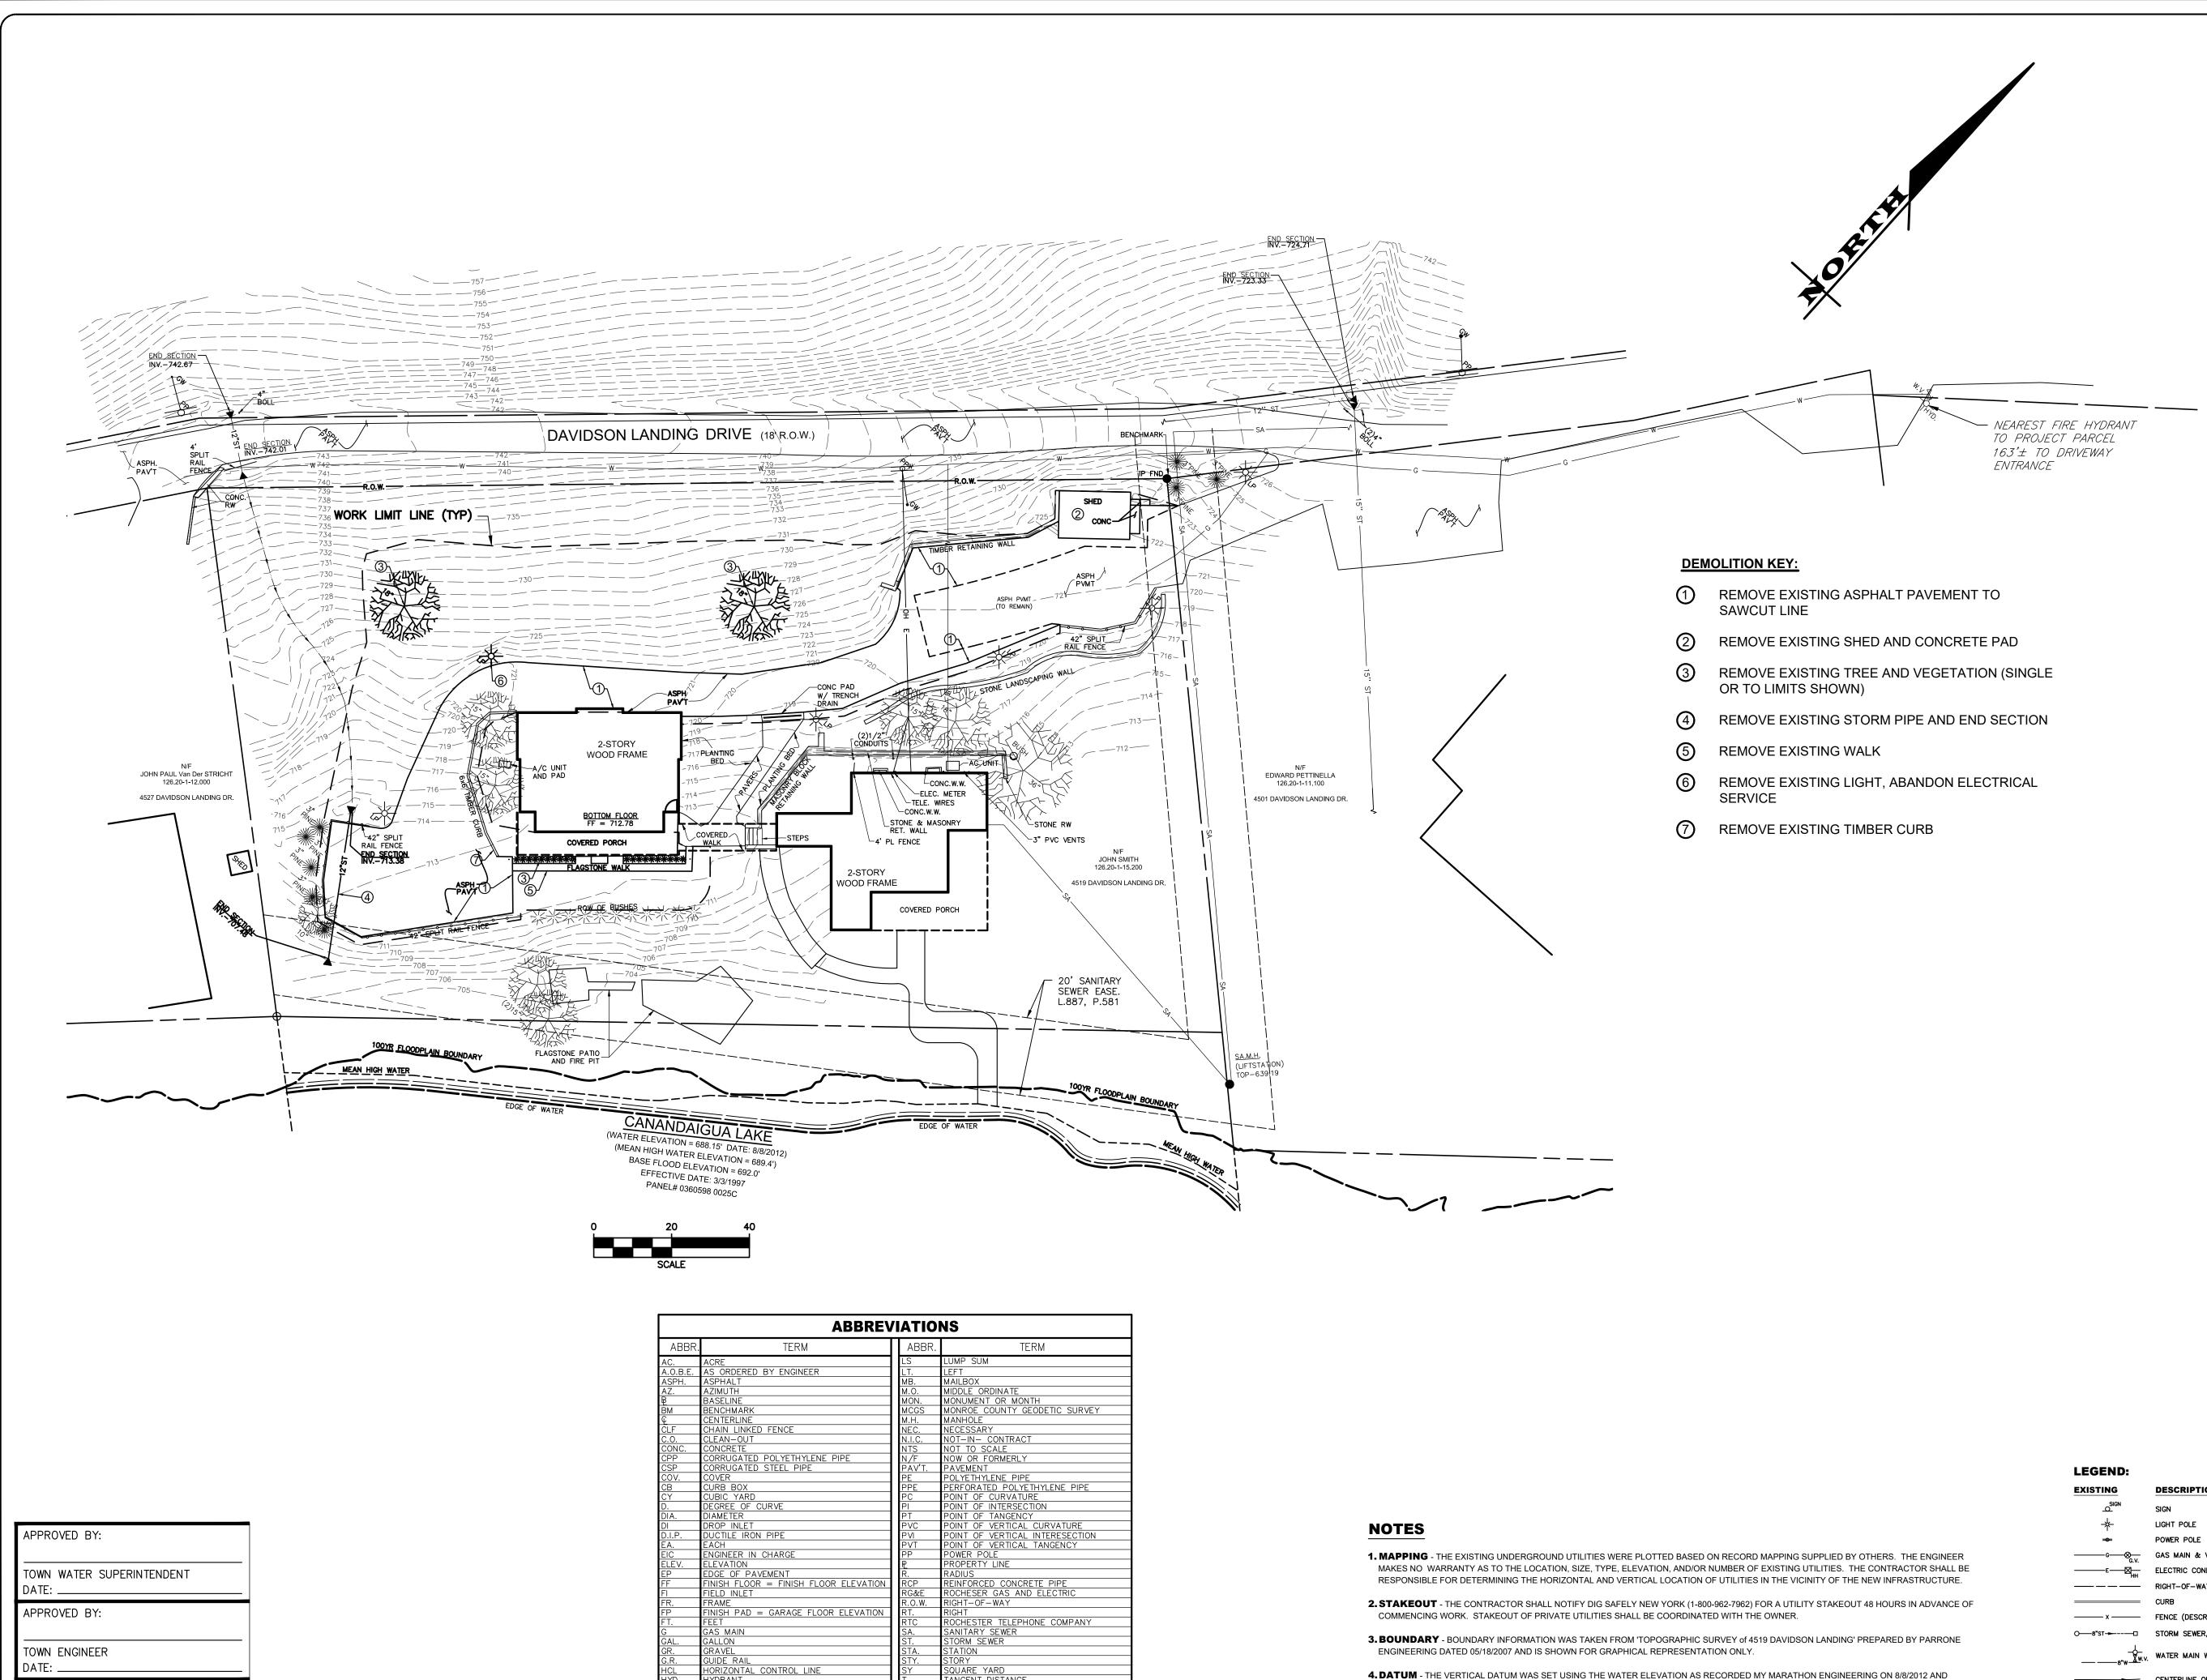
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ROCHESTER LOCATION 39 CASCADE DRIVE

MRS

JOB NO: 0437-18 SCALE: AS SHOWN DRAWN: DESIGNED: DATE: 10/12/18 REVISIONS

DATE BY REVISION 10/18/18 PG PRC COMMENTS 12/11/18 LB TOWN COMMENTS

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DRAWING TITLE: **EXISTING** CONDITIONS & **DEMOLITION PLAN** 

ROBERT P. BRINGLEY

SHEET No: 0437-18 DRAWING No:

————G———⊗—— GAS MAIN & VALVE ------ x ------ FENCE (DESCRIPTION) O—8"ST→---□ STORM SEWER, MANHOLE & FIELD/DROP INLET \_\_\_\_\_8\*W\_\_\_\_\_\_\_\_ WATER MAIN WITH HYDRANT & GATE VALVE CENTERLINE OF SWALE \_525 CONTOUR DRAINAGE FLOW ARROW


SPOT ELEVATION

TREE LINE

REFERENCED TO THE DAILY WATER ELEVATION RECORDED AT CANANDAIGUA WATER TREATMENT PLANT ON THE SAME DAY (NAVD 88). 5. IRRIGATION - THIS PROPERTY CONTAINS AN IRRIGATION SYSTEM. THE LOCATION SHALL BE COORDINATED WITH OWNER PRIOR TO

### 1) GENERAL NOTES: 1. APPLICABILITY - THE NOTES AND INFORMATION PROVIDED ON THIS SHEET ARE APPLICABLE TO ALL "C" SERIES DRAWINGS. THE "C" SERIES DRAWINGS COVER SITE RELATED IMPROVEMENTS OUTSIDE THE BUILDING ENVELOPE. THE BUILDING ENVELOPE INCLUDES ALL AREA WITHIN 5' OUTSIDE OF THE BUILDING'S EXTERIOR WALL. 2. MAPPING - THE EXISTING UNDERGROUND UTILITIES WERE PLOTTED BASED ON RECORD MAPPING SUPPLIED BY OTHERS. THE ENGINEER MAKES NO WARRANTY AS TO THE LOCATION, SIZE, TYPE, ELEVATION, AND/OR NUMBER OF EXISTING UTILITIES. THE CONTRACTOR SHALL BE RESPONSIBLE FOR DETERMINING THE HORIZONTAL AND VERTICAL LOCATION OF UTILITIES IN THE VICINITY OF THE NEW INFRASTRUCTURE. 3. STAKEOUT - THE CONTRACTOR SHALL NOTIFY DIG SAFELY NEW YORK (1-800-962-7962) FOR A UTILITY STAKEOUT 48 HOURS IN ADVANCE OF COMMENCING WORK. STAKEOUT OF PRIVATE 4. PROPERTY PROTECTION - THE CONTRACTOR IS RESPONSIBLE FOR DAMAGE TO EXISTING PAVEMENT, CURBS, WALKS, LAWNS, TREES, ETC. CAUSED BY THEIR CONSTRUCTION OPERATIONS. ALL DAMAGE SHALL BE REPAIRED OR REPLACED BY THE CONTRACTOR TO THE OWNER'S SATISFACTION AT NO ADDITIONAL EXPENSE. 5. ACCESS - THE CONTRACTOR SHALL PROVIDE SATISFACTORY VEHICULAR ACCESS TO ALL ADJOINING PROPERTIES, PRIVATE ROADWAYS, PARKING FACILITIES, AND PUBLIC STREETS DURING CONSTRUCTION. CONC. STOOP -6. SITE SAFETY - PRIOR TO AND THROUGHOUT CONSTRUCTION, THE CONTRACTOR SHALL POST SIGNAGE IN CONFORMANCE WITH THE REQUIREMENTS OF THE LOCAL MUNICIPALITY AND OCCUPATIONAL HEALTH AND SAFETY ACT (OHSA). JOB SAFETY AND MAINTENANCE AND PROTECTION OF TRAFFIC IS THE RESPONSIBILITY OF THE CONTRACTOR. 7. EXCAVATIONS - ALL EXCAVATIONS SHALL BE BACKFILLED/BARRICADED TO THE SATISFACTION OF THE OWNER'S REPRESENTATIVE AT THE CONCLUSION OF EACH WORKING DAY. 8. MAINTENANCE - PUBLIC STREETS, PRIVATE DRIVES AND PARKING FACILITIES SHALL BE KEPT FREE OF FOREIGN MATERIALS. ALL AREAS SHALL BE SWEPT CLEAN AT THE END OF EACH WORKING DAY AND/OR AS DIRECTED BY THE OWNER'S ON-SITE REPRESENTATIVE. 9. CONSTRUCTION STORAGE - STORAGE OF EQUIPMENT AND MATERIALS SHALL BE WITHIN A SPECIFIED AND SECURED AREA AS DETERMINED IN CONTRACT DOCUMENTS OR AS SPECIFIED BY THE OWNER'S ON-SITE REPRESENTATIVE. RESTORE TO LAWN -TOPSOIL (6" MIN), SEED 10. PERMIT(S) - PRIOR TO CONSTRUCTION, THE CONTRACTOR SHALL OBTAIN THE NECESSARY PERMITS FROM THE AND MULCH (TYP) APPLICABLE MUNICIPALITY OR AGENCY. THE CONTRACTOR IS RESPONSIBLE FOR ALL BONDS AND INSURANCES AND THE OWNER IS RESPONSIBLE FOR PERMIT FEES UNLESS OTHERWISE STATED IN THE OWNER/ CONTRACTOR AGREEMENT. JOHN PAUL Van Der STRICHT 126.20-1-12.000 11. STAKEOUT - THE CONSTRUCTION STAKEOUT SHALL BE PERFORMED BY A LICENSED LAND SURVEYOR USING CONTROL PROVIDED ON THE "LAYOUT PLAN". THE BUILDING FOOTPRINT(S), 4527 DAVIDSON LANDING DR DATED 08/16/12, WERE PROVIDED BY ARCHITECTUAL INOVATIONS. DISCREPANCIES WITH BUILDING(S), CONTROL POINTS, AND/ OR TIE DIMENSIONS SHALL BE REPORTED TO THE DESIGN ENGINEER (PRIOR TO THE INSTALLATION OF IMPROVEMENTS) FOR COORDINATION AND CLARIFICATION. 12. STAGING - AS DEFINED BY THE CONTRACT DOCUMENTS THE CONTRACTOR SHALL CONSTRUCT A SECURE STAGING AREA FOR STORAGE OF EQUIPMENT, MATERIALS, EMPLOYEE PARKING AND OFFICE SPACE. IF THE AREA/METHOD IS NOT SPECIFICALLY DEFINED ON THE DOCUMENTS THEN IT SHALL BE COORDINATED WITH THE OWNER'S ON-SITE REPRESENTATIVE. 13. CLOSE-OUT - THE CONTRACTOR'S WORK SCOPE INCLUDES BUT IS NOT LIMITED TO THE FOLLOWING AT PROJECT CLOSE-OUT TO THE SATISFACTION OF OWNER'S ON-SITE REPRESENTATIVE: REMOVAL OF ANY CONSTRUCTION DEBRIS. CLEANING PAVEMENT AND WALKWAY SURFACES. • RESTORATION OF ALL DISTURBED GRASS AND LANDSCAPED AREAS. • PROVIDING BONDS, GUARANTEES, CERTIFICATIONS, ETC. AS REQUIRED BY CONTRACT DOCUMENTS. PROVIDING A RECORD DRAWING. COMPLETION OF FINAL PUNCH LIST ITEMS. 2) RESTORATION AND LANDSCAPING NOTES: 1. TOPSOIL - PLACE A MINIMUM OF 6 INCHES (REQUIRED) OF TOPSOIL ON ALL DISTURBED SURFACES. FINE GRADE TO ESTABLISH THE DESIGN ELEVATIONS AND DRAINAGE PATTERNS. OBTAIN OWNER'S REPRESENTATIVE APPROVAL PRIOR TO SEEDING. 3. SEED - LAWN AREAS SHALL BE HYDROSEEDED WITH AN APPROVED; SEED MIXTURE, MULCH, AND FERTILIZER. THE APPLICATION RATE SHALL BE DETERMINED BY CONTRACTOR TO ESTABLISH A "STAND" OF GRASS. 4. LANDSCAPING - ALL PLANTINGS OF SHRUBS AND TREES SHALL BE SELECTED BY THE OWNER. **LAYOUT PLAN** 3) ADDITIONAL NOTES: 1. **ELECTRICAL SERVICE** - ELECTRICAL SERVICE TO GARAGE SHALL BE COORDINATED BY OWNER. 2. DOWNSPOUTS - ALL DOWNSPOUTS FOR NEW GARAGE SHALL BE DIRECTED TO THE STONE LINED SWALE.. 3. PROPOSED LIGHTING - ALL LIGHTING TO BE INSTALLED SHALL BE DARK SKY COMPLIANT A) PROJECT STATISTICS 1.1 GENERAL: A. PROPERTY OWNER - JOHN & JOANNE SMITH **B. PROPERTY ADDRESS** - 4519 DAVIDSON LANDING TOWN OF CANANDAIGUA ONTARIO COUNTY, NEW YORK **C. TAX ACCOUNT** - 126.20-1-15.200 D. LOT SIZE -0.782 ACRES OR 34,044 SF ( TO TIE LINE) 0.895 ACRES OR 38,997 SF (TO HIGH WATER LINE) E. IMPERVIOUS AREA - EXISTING = 10,171 SF (26.1%) PROPOSED = 9,580 SF (24.6%) DECREASED AREA = 591 SF (1.5%) **1.2 ZONING REGULATIONS:** A. ZONING DISTRICT - RLD - RESIDENTIAL LAKE DISTRICT **B. CODE REQUIREMENTS** -LOT SIZE 38,997 S.F. (TO MHW MARK) 20,000 SF LOT WIDTH 125 FT FRONT SETBACK 57.6 FT ± 24.0 FT (VARIANCE APPROVED BY ZBA ON 11/20/18) REAR SETBACK 43.7 FT ± (EXISTING NON-CONFORMITY) 59' - 12" PERF SIDE SETBACK 12.7% **BUILDING COVERAGE** 9.4% LOT COVERAGE 25% 26.1% 24.6% BUILDING HEIGHT 25 FT MAX JOHN PAUL Van Der STRICHT 126.20-1-12.000 • SOME UNDEVELOPED LANDS ON THE PARCEL HAVE A SLOPE GREATER THAN OR EQUAL TO 15%. REFER TO STEEP SLOPE SUMMARY MAP DATED 11/6/18 AND PREPARED BY MARATHON ENGINEERING. 4527 DAVIDSON LANDING DR • THERE ARE NO EXISTING DEED RESTRICTIONS ON THIS PROPERTY. NO PHOSPHOROUS SHALL BE USED AT PLANTING TIME UNLESS SOIL TESTING HAS BEEN COMPLETED AND TESTED BY A HORTICULTURAL TESTING LAB AND THE SOIL TESTS SPECIFICALLY INDICATE A PHOSPHOROUS DEFICIENCY THAT IS HARMFUL, OR WILL PREVENT NEW LAWNS AND PLANTINGS FROM ESTABLISHING PROPERLY. • IF SOIL TESTS INDICATE A PHOSPHOROUS DEFICIENCY THAT WILL IMPACT PLANT AND LAWN ESTABLISHMENT, PHOSPHOROUS SHALL BE APPLIED AT THE MINIMUM RECOMMENDED LEVEL PRESCRIBED IN THE SOIL TEST FOLLOWING ALL NYSDEC REQUIREMENTS. LEGEND: LIGHT POLE POWER POLE GAS MAIN & VALVE ELECTRIC CONDUIT & STRUCTURE RIGHT-OF-WAY OR PROPERTY LINE APPROVED BY: O12"PE ST @ 1.0% STORM SEWER, MANHOLE & FIELD/DROP INLET TOWN WATER SUPERINTENDENT WATER MAIN WITH HYDRANT & GATE VALVE APPROVED BY: APPROVED BY: **UTILITY AND** TOWN ENGINEER PLANNING BOARD CHAIRMAN SPOT ELEVATION

TREE LINE

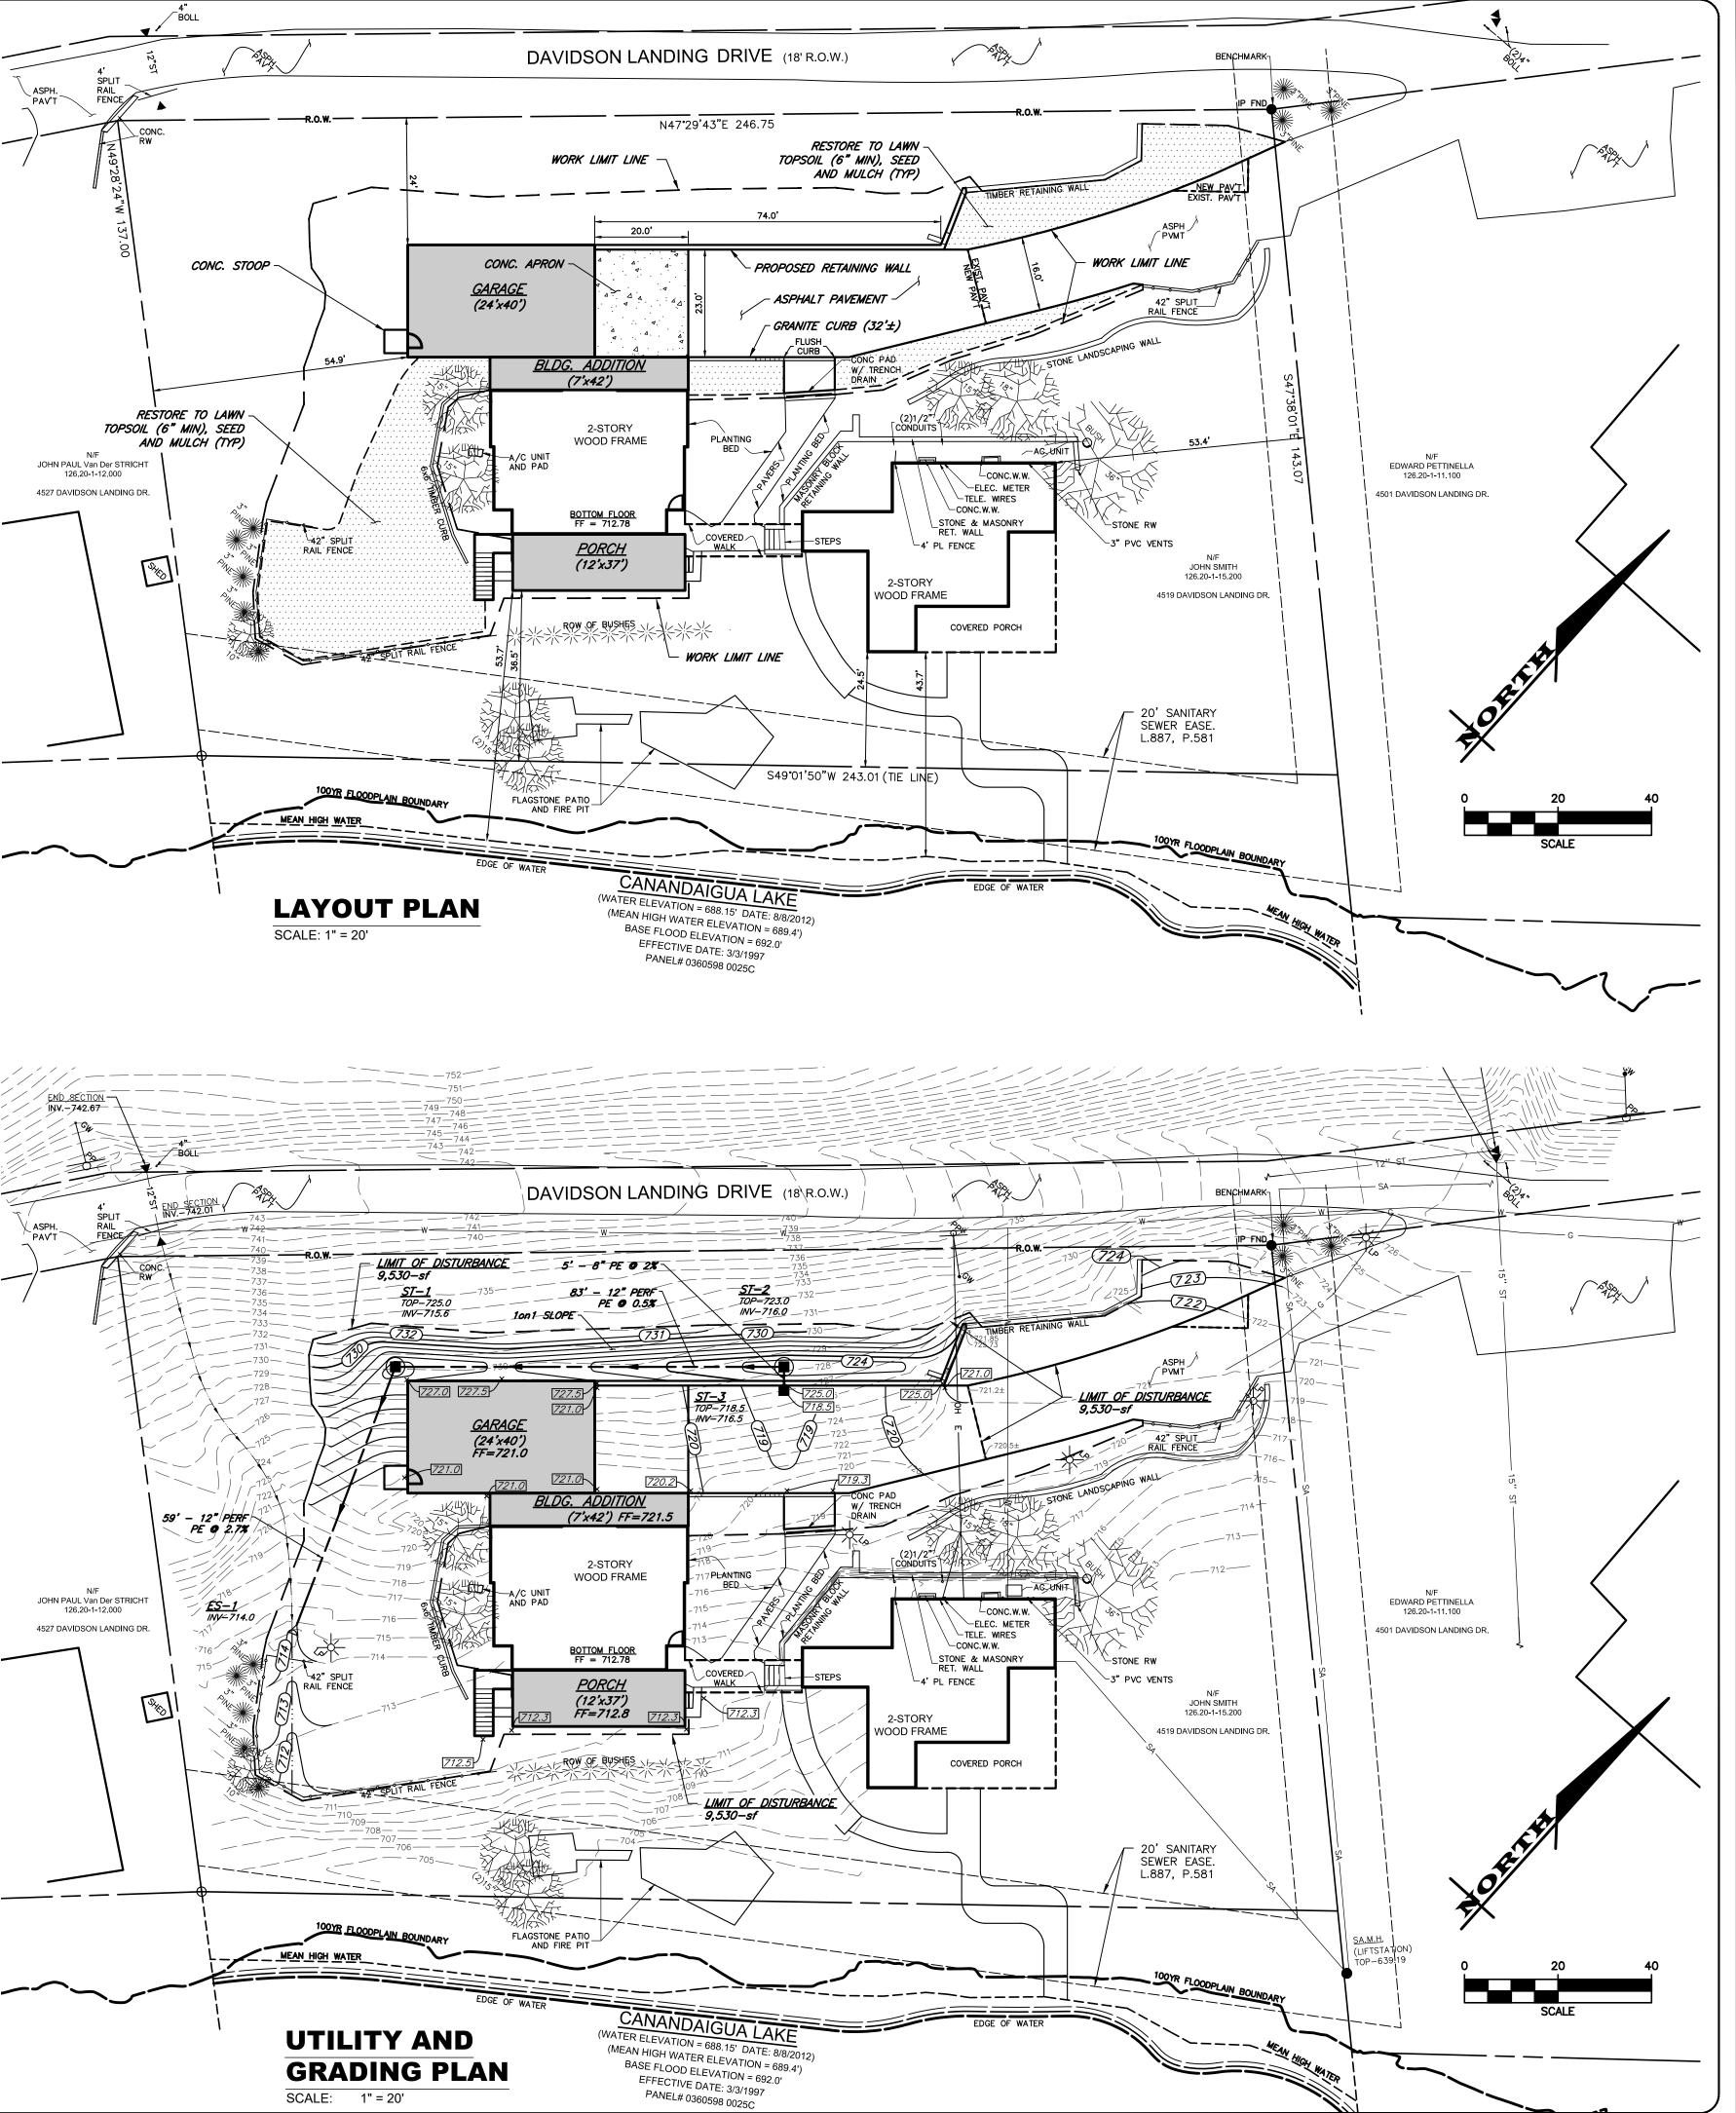

**ENGINEERING** 

ROCHESTER LOCATION

39 CASCADE DRIVE ROCHESTER, NY 14614

5 8 5 - 4 5 8 - 7 7 7 0 ITHACA LOCATION

840 HANSHAW RD, STE 12

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JOB NO:

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10/18/18 PG PRC COMMENTS

12/11/18 LB TOWN COMMENTS

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ROBERT P. BRINGLEY

DRAWING No:

DRAWING TITLE:

**NOTES** 

SHEET No:

0437-18


SITE PLAN &

### CONSTRUCTION SPECIFICATIONS

LENGTH OF 3 FEET.

- 1. FILTER FABRIC SHALL HAVE AN EOS OF 40-85. BURLAP MAY BE USED FOR SHORT
- TERM APPLICATIONS. 2. CUT FABRIC FROM A CONTINUOUS ROLL TO ELIMINATE JOINTS. IF JOINTS ARE
- NEEDED THEY WILL BE OVERLAPPED TO THE NEXT STAKE. 3. STAKE MATERIALS WILL BE STANDARD 2" x 4" WOOD OR EQUIVALENT METAL WITH A MINIMUM
- 4. SPACE STAKES EVENLY AROUND INLET 3 FEET APART AND DRIVE A MINIMUM OF 18 INCHES DEEP. SPANS GREATER THAN 3 FEET MAY BE BRIDGED WITH THE USE OF WIRE MESH BEHIND THE FILTER FABRIC FOR SUPPORT.
- 5. FABRIC SHALL BE EMBEDDED 1 FOOT MINIMUM BELOW GROUND AND BACKFILLED. IT SHALL
- BE SECURELY FASTENED TO THE STAKES AND FRAME. 6. A 2" x 4" WOOD FRAME SHALL BE COMPLETED AROUND THE CREST OF THE FABRIC FOR OVER




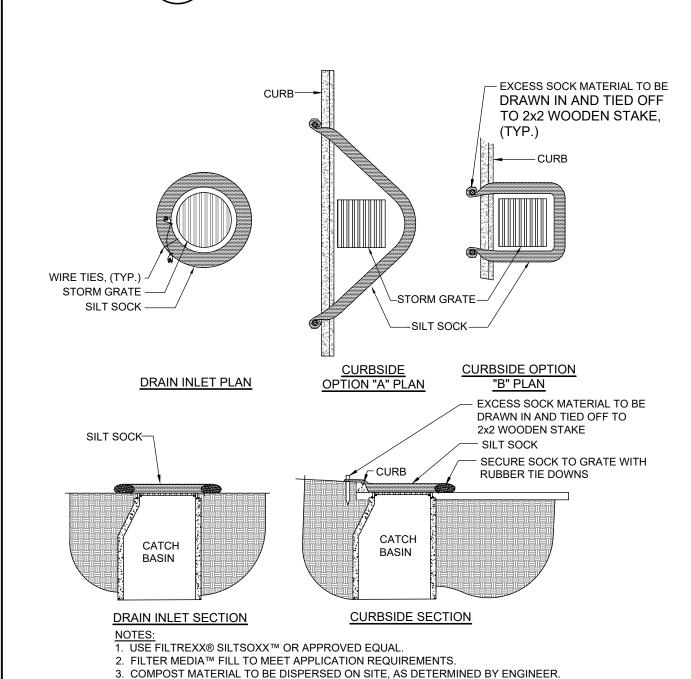

# SILT SOCK

### 1) EROSION CONTROL NOTES:

- 1. INSPECTION EROSION CONTROL (EC) MEASURES INSTALLED AND MAINTAINED BY THE SITE WORK CONTRACTOR ARE SUBJECT TO THE REVIEW AND APPROVAL OF THE: MUNICIPALITY, DESIGN ENGINEER, AND OWNER'S REPRESENTATIVE. IMMEDIATE ACTION BY THE CONTRACTOR SHALL BE TAKEN IF ADDITIONAL OR CORRECTIVE MEASURES ARE REQUIRED BY ANY ONE OF THESE CITED REVIEWERS.
- 2. PRE-CONSTRUCTION THE APPROPRIATE EROSION CONTROL MEASURES AS DEFINED BY THE CONSTRUCTION DOCUMENTS SHALL BE INSTALLED PRIOR TO THE START OF ANY CONSTRUCTION ACTIVITIES.
- 3. TOPSOIL UPON COMPLETION OF THE STOCKPILE STRIPPING OPERATION, STOCKPILES SHALL BE STABILIZED IN ACCORDANCE TO NYSDEC REGULATIONS.
- 4. SLOPES UPON COMPLETION OF GRADING, SLOPES WITH A GRADIENT OF ONE FOOT VERTICAL TO THREE FEET HORIZONTAL (1 ON 3) OR LESS SHALL BE: TOPSOILED, SEEDED, FERTILIZED AND STRAW MULCHED. ANY SLOPE GREATER THAN 1 ON 3 SHALL BE STABILIZED WITH JUTE MESH IMMEDIATELY UPON COMPLETION OF
- 5. OPERATION & MAINTENANCE THROUGHOUT THE PERIOD OF CONSTRUCTION AND PRIOR TO ESTABLISHING FINAL GROUND COVER THE SITE CONTRACTOR IS RESPONSIBLE FOR THE OPERATION AND MAINTENANCE OF THE TEMPORARY EROSION CONTROL MEASURES.
- 6. WORK STOPPAGE ALL DISTURBED AREAS NOT TO BE WORKED WITHIN 14 DAYS MUST BE SEEDED WITHIN 14 DAYS FROM THE LAST CONSTRUCTION ACTIVITY IN THAT AREA.
- 7. STORM INLET PROVIDE INLET PROTECTION FOR ALL STORM INLETS.
  - DETAIL #8 FOR ST-1.0 DETAIL #9 FOR ST-2.0 AND ST-3.0

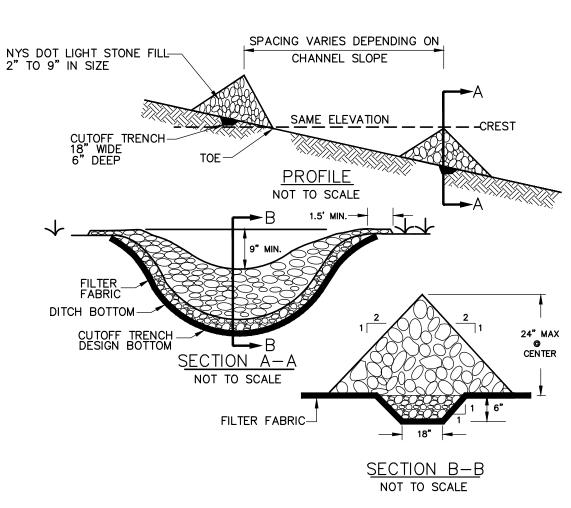

### CONSTRUCTION SPECIFICATIONS

TEMPORARY SEDIMENTATION FACILITY -

RECEIVING DRAINAGE CHANNEL

OUTFALL CHANNEL

RIP—RAP LINING FOR BED AND BANKS AT ENTRY POINT OF OUTFALL CHANNEL TO MINIMIZE SCOUR POTENTIAL.

1. PROVIDE ADEQUATE PROTECTION TO OUTFALL

OUTFALL CHANNEL AND SEDIMENTATION FACILITIES SHOULD BE CONSTRUCTED PRIOR TO BEGINNING MASS EARTHWORK

SCALE: N.T.S

1. MATERIAL - CRUSHED ROCK OR GRAVEL

3. THICKNESS - NOT LESS THAN SIX (6).

SCALE: N.T.S

APPROVED BY:

TOWN ENGINEER

THEN LENGTH IS TO THE BUILDING FACE)

CHANNEL TO PREVENT EROSION.

PROVIDE A MINIMUM STORAGE VOLUME OF 3,600 C.F. PER ACRE OF DRAINAGE AREA.
 LENGTH TO WIDTH RATIO SHOULD BE 2:1

SEDIMENTATION FACILITY SHALL BE FILLED AND RE-GRADED UPON PROJECT COMPLETION,

EXCEPT WHERE SEDIMENTATION FACILITY IS DESIGNED AS PERMANENT DETENTION FACILITY.

- 1. STONE WILL BE PLACED ON A FILTER FABRIC FOUNDATION TO THE LINES, GRADES AND LOCATION SHOWN ON IN THE PLAN
- 2. SET SPACING OF CHECK DAMS TO ASSUME THAT THE ELEVATIONS OF THE CREST OF THE DOWNSTREAM DAM IS AT THE SAME ELEVATION OF THE UPSTREAM DAM.
- 3. EXTEND THE STONE A MINIMUM OF 1.5 FEET BEYOND THE DITCH BANKS TO PREVENT CUTTING AROUND THE DAM,
- 4. PROTECT THE CHANNEL DOWNSTREAM OF THE LOWEST CHECK DAM FROM SCOUR AND EROSION WITH STONE OR LINER AS APPROPRIATE.
- 5. ENSURE THAT CHANNEL APPURTENANCES SUCH AS CULVERT ENTRANCES BELOW CHECK DAMS ARE NOT SUBJECT TO DAMAGE OF BLOCKAGE FROM DISPLACED STONES. MAXIMUM DRAINAGE AREA - 2 ACRES


. UNDERCUT SEDIMENTATION FACILITY A MINIMUM OF 3 FEET.

THE CONTRACTOR SHALL CLEAN ACCUMULATED SEDIMENT FROM FACILITY WHEN SEDIMENT DEPTH REACHES 1/2 OF THE VOLUME OR AS

DIRECTED BY THE MUNICIPAL REPRESENTATIVE


EXISTING GROUND SURFACE



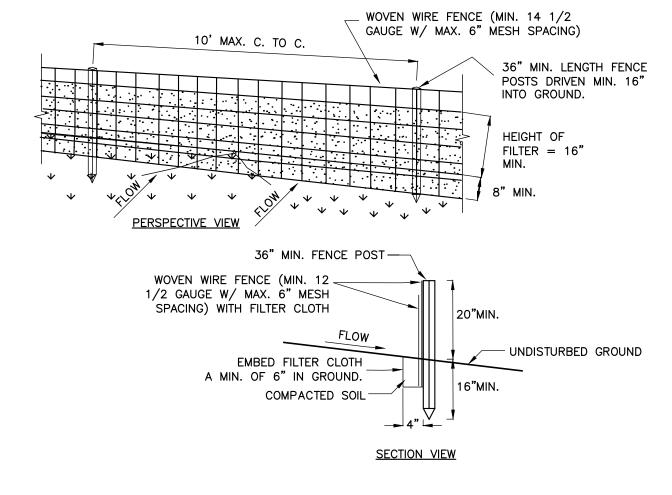


## **CONSTRUCTION SPECIFICATIONS**

- 1. WOVEN WIRE FENCE TO BE FASTENED SECURELY TO FENCE POSTS WITH WIRE TIES OR STAPLES, POSTS SHALL BE STEEL "T" OF "U" TYPE OF HARDWOOD.
- 2. FILTER CLOTH TO BE FASTENED SECURELY TO WOVEN WIRE FENCE WITH TIES SPACED EVERY 24" AT TOP AND MID SECTION. FENCE SHALL BE WOVEN WIRE, 12 1/2 GAUGE, 6" MAXIMUM MESH
- . WHEN TWO SECTIONS OF FILTER CLOTH ADJOIN EACH OTHER THEY SHALL BE OVERLAPPED BY SIX INCHES AND FOLDED. FILTER CLOTH SHALL BE EITHER FILTER X, MIRAFI 100X, STABLINKKA T140N, OR APPROVED EQUIVALENT.
- 4. PREFABRICATED UNITS SHALL BE GEOFAB, ENVIROFENCE, OR APPROVED EQUIVALENT. 5. MAINTENANCE SHALL BE PERFORMED AS NEEDED AND MATERIAL REMOVED WHEN "BULGES"
- DEVELOP IN THE SILT FENCE.

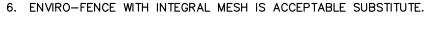




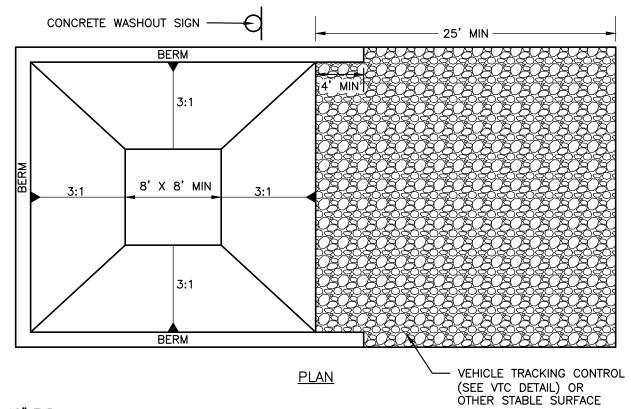

COMPACTED BERM AROUND THE PERIMETER → 2% SLOPE UNDISTURBED OR COMPACTED SOIL VEHICLE TRACKING CONTROL (SEE VTC DETAIL)

- 1. CONTRACTOR TO VERIFY SIZE REQUIREMENTS BASED ON ANTICIPATED VOLUMES OF CONCRETE WASHOUT.
- CONCRETE WASHOUT SHOULD BE PLACED TO NOT ACCEPT SURFACE RUNOFF. 3. IF WATER DOES NOT EVAPORATE AND IS GREATER THAN 75% FULL CONTRACTOR SHALL REMOVE
- LIQUIDS AS REQUIRED BY THE LOCAL AUTHORITY (SAN SEALER OF VAC TRUCK) 4. PROVIDE MINIMUM AGGREGATE OF 10 MIL PLASTIC AS LINER. SECURE LINER TO PREVENT INFILTRATION & REPLACE AS NECESSARY FOR TEARS.



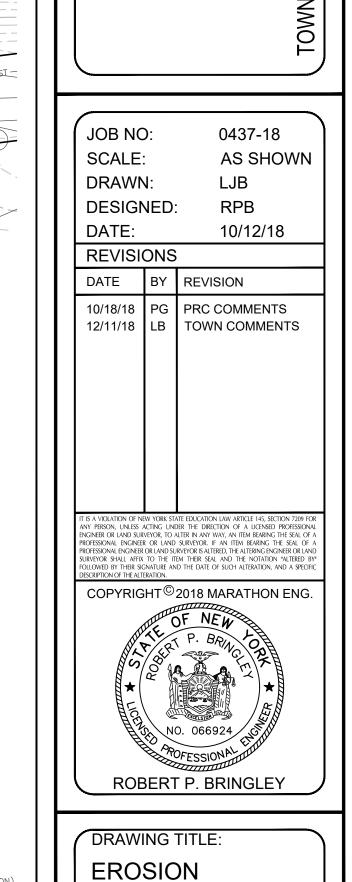

**CONTROL PLAN** 

DRAWING No:

4 of 6

SHEET No:

0437-18 JOB No:

**ENGINEERING** 

39 CASCADE DRIVE

ROCHESTER, NY 14614 5 8 5 - 4 5 8 - 7 7 7 0


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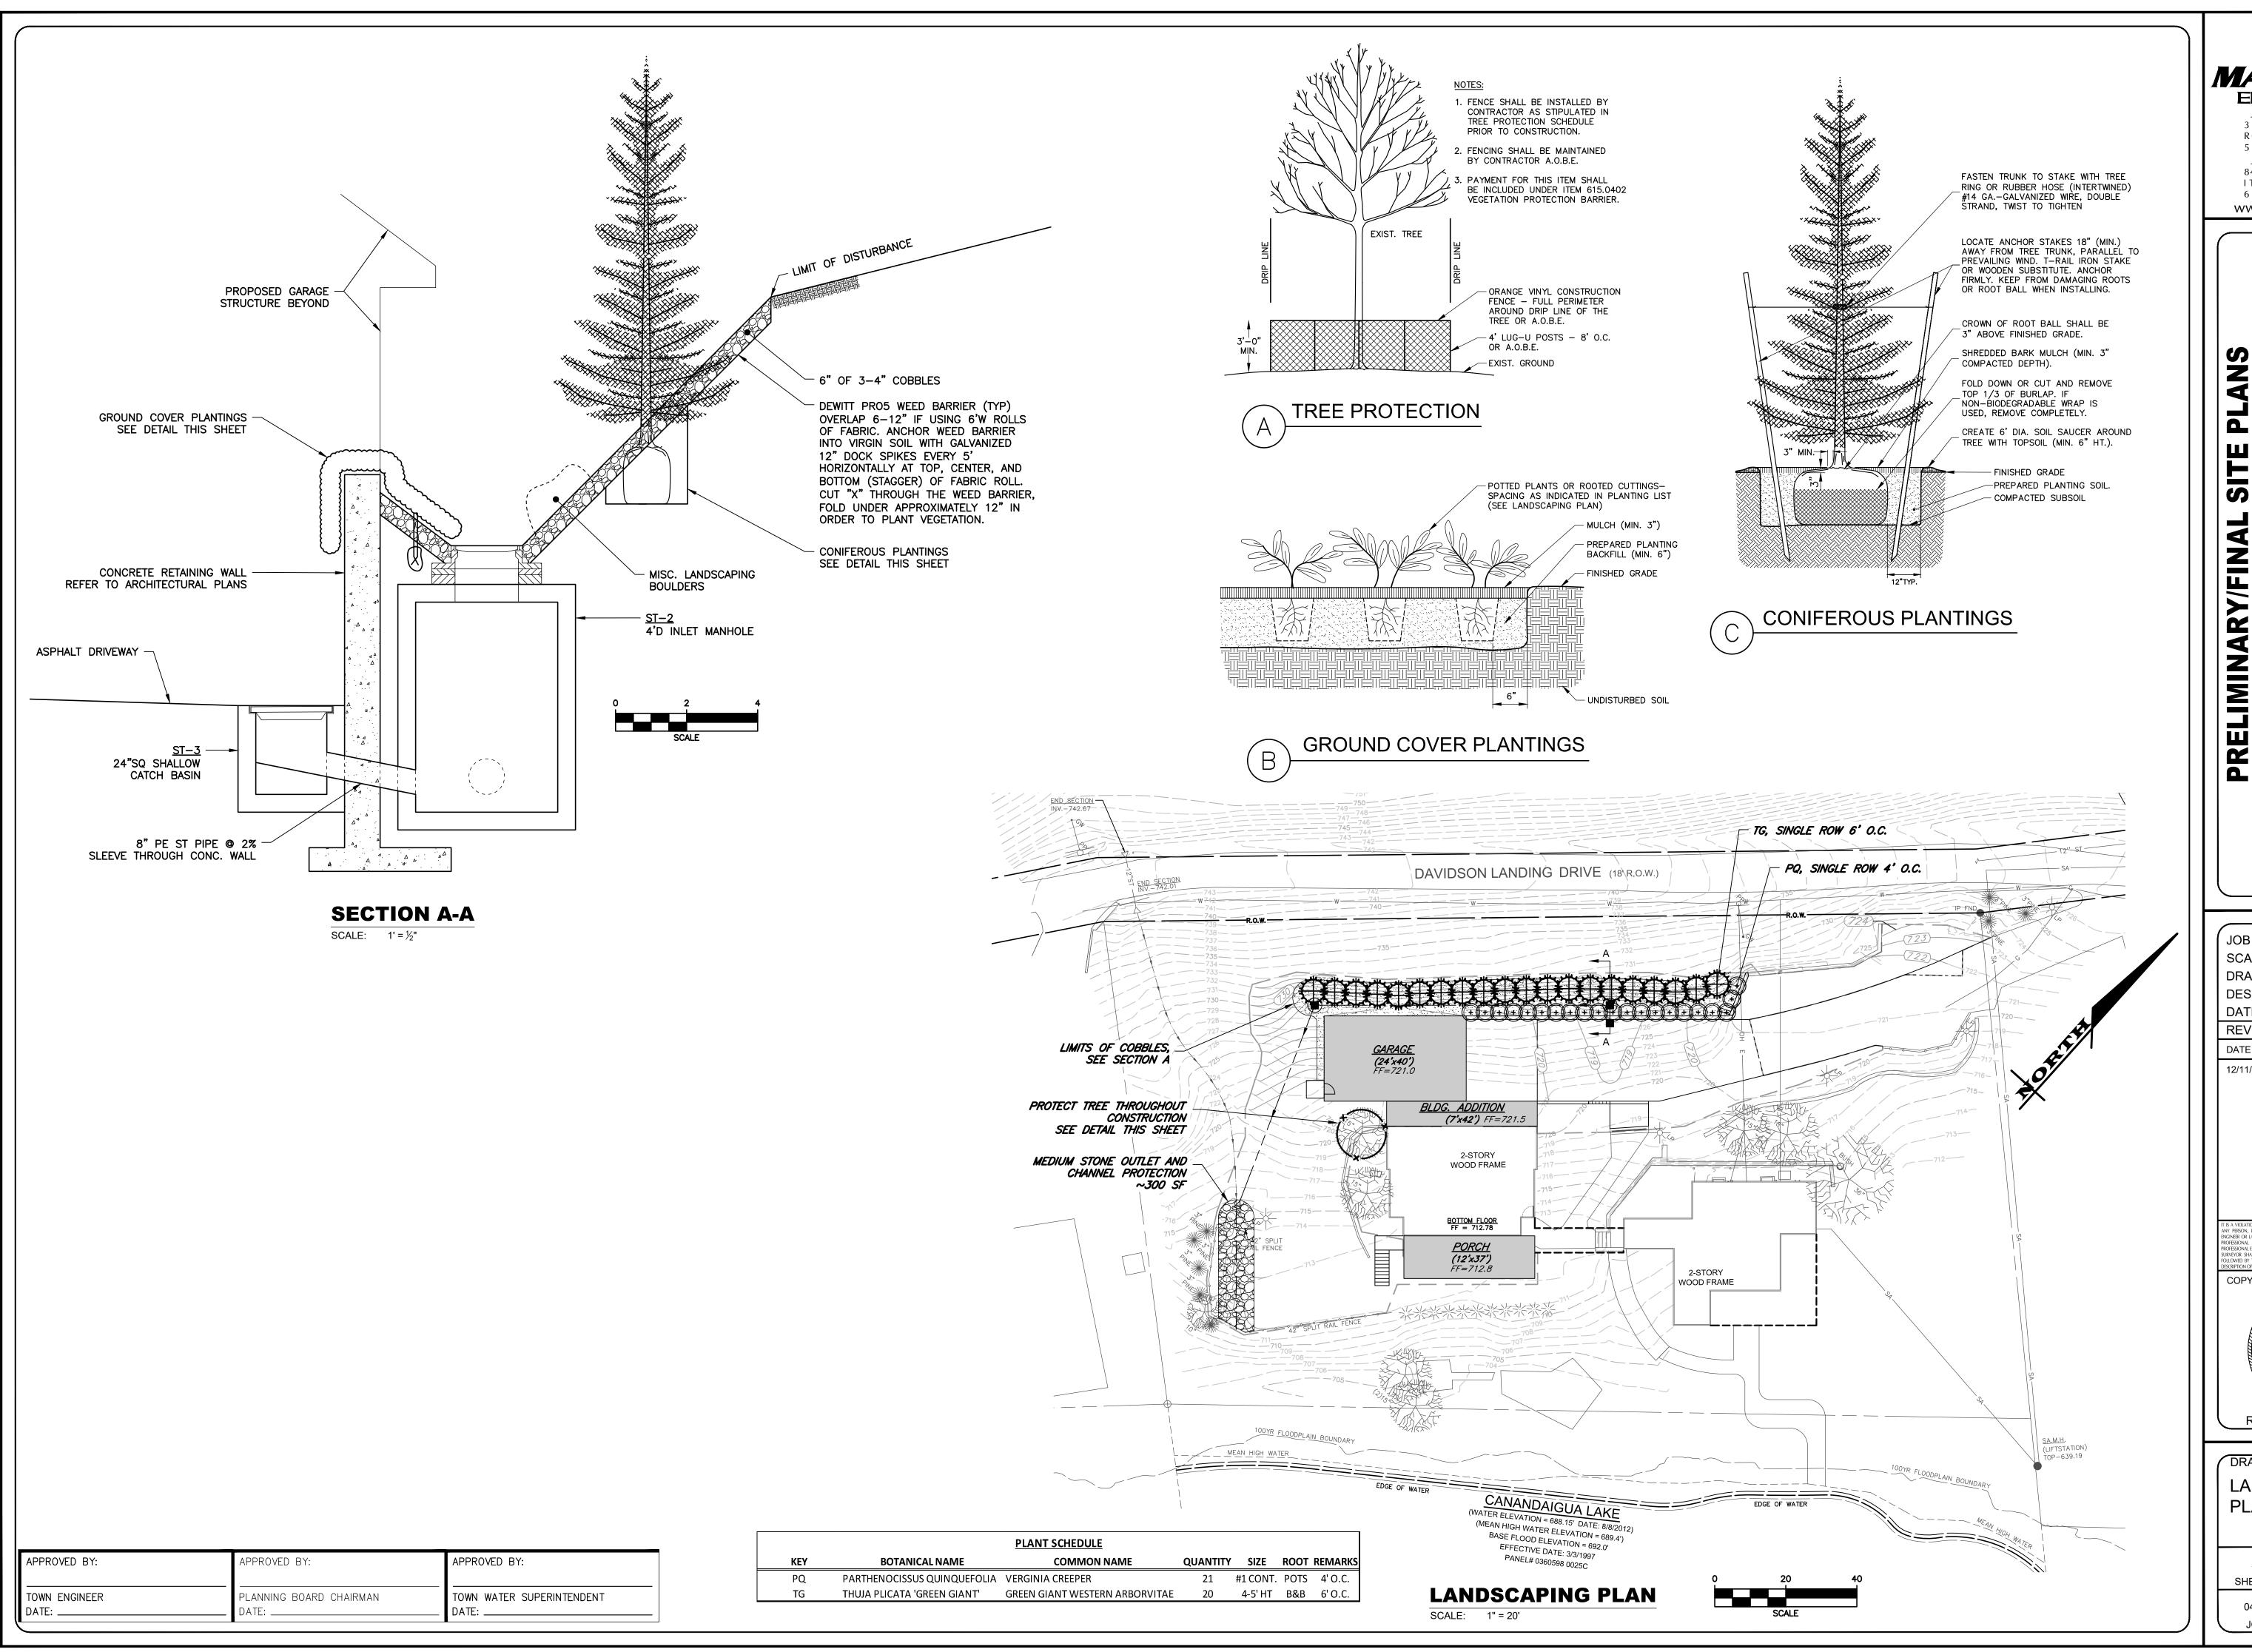
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ROCHESTER LOCATION





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> N SMITH ING DRIVE

RS. JOHN SON LANDI

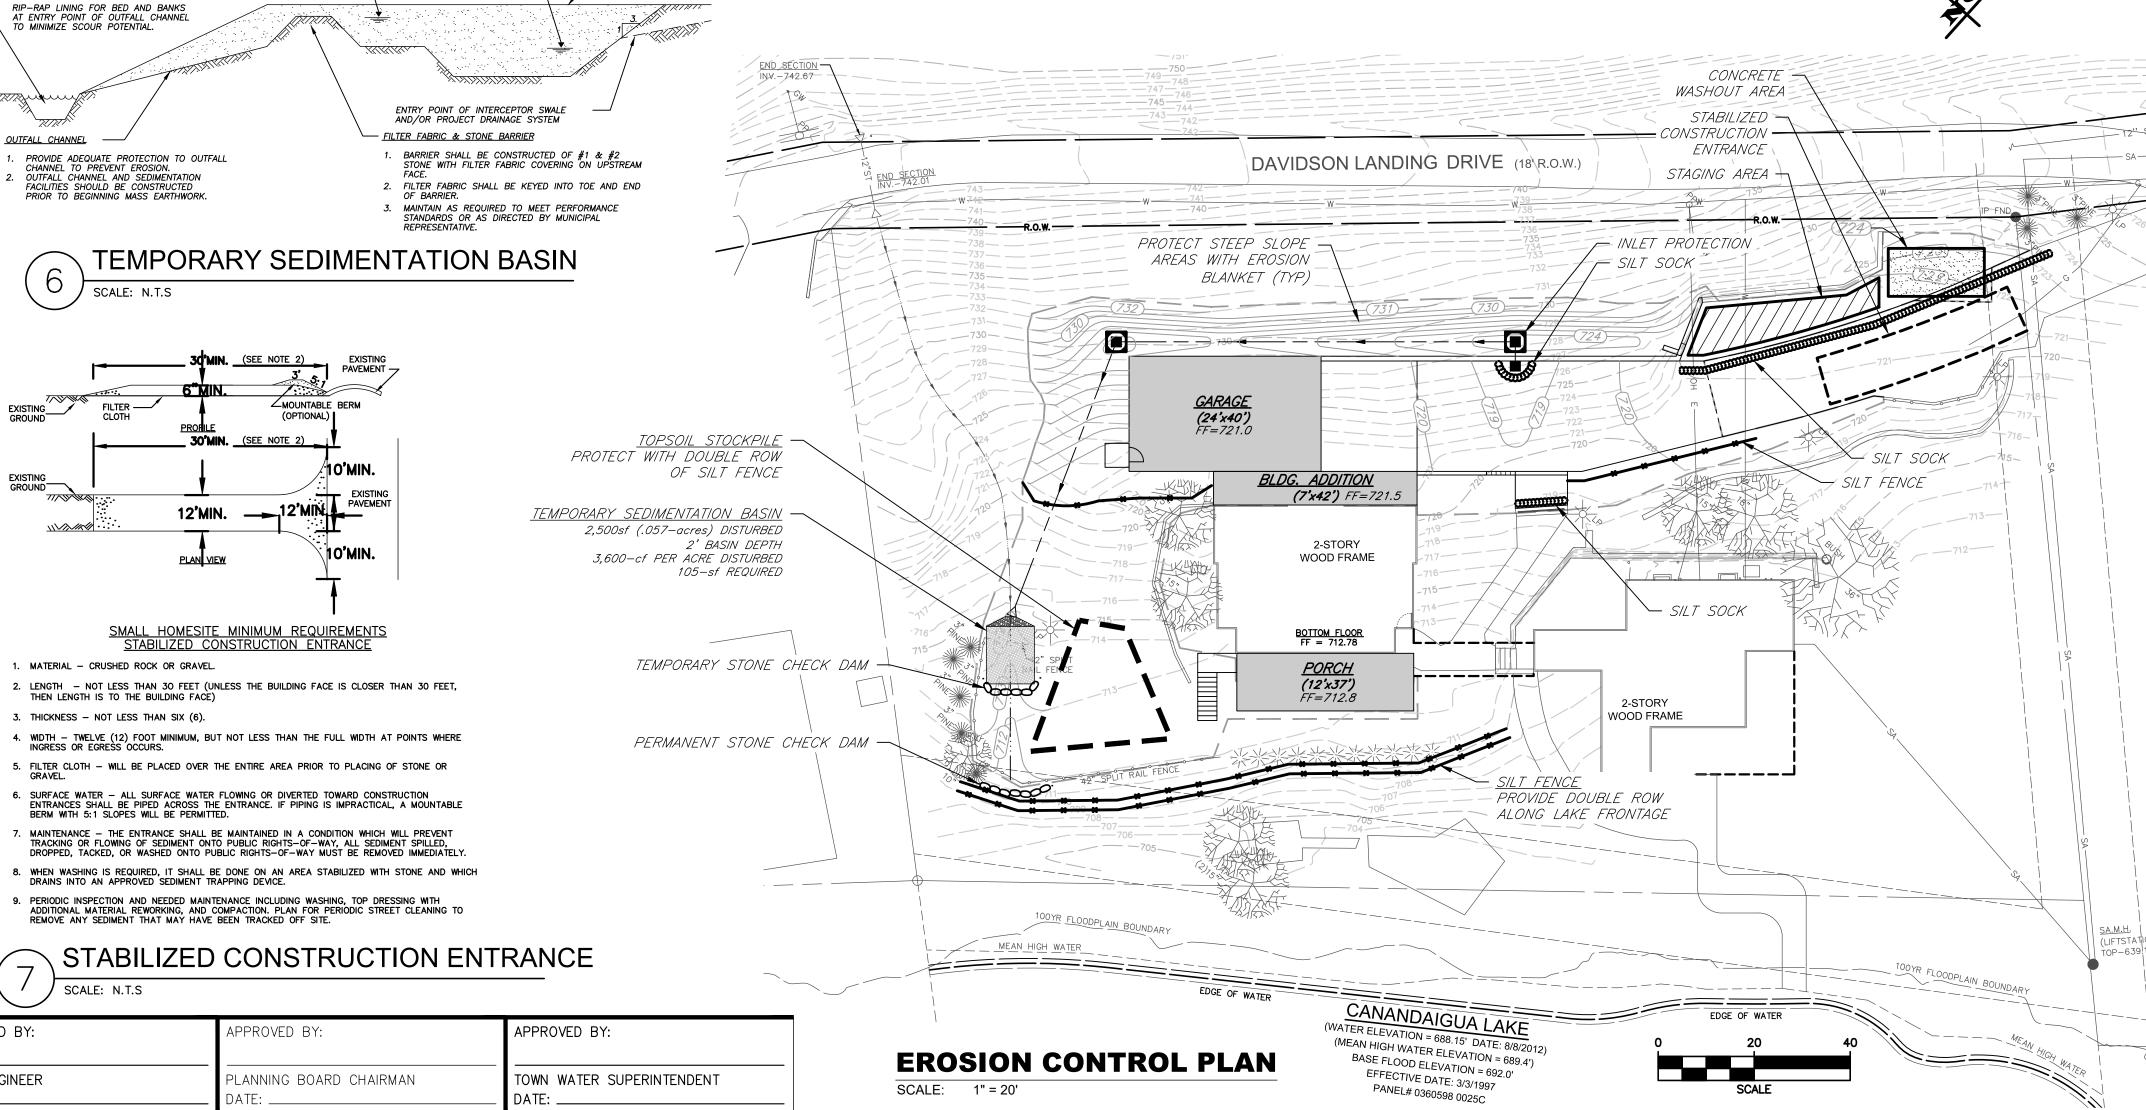Ξ

4519 DAVIDSON F CANANDAIGUA

JOB NO: 0437-18

SCALE: AS SHOWN

DRAWN: LJB

DESIGNED: RPB

DATE: 10/12/18

REVISIONS

DATE BY REVISION

12/11/18 LB ADDED TO SHEET SET

IT IS A VIOLATION OF NEW YORK STATE EDUCATION LAW ARTICLE 145, SECTION 7209 FOR ANY PERSON, UNLESS ACTING UNDER THE DIRECTION OF A LICENSED PROFESSIONAL ENGINEER OR LAND SURVEYOR. IF AN ITEM BEARING THE SEAL OF A PROFESSIONAL ENGINEER OR LAND SURVEYOR. IF AN ITEM BEARING THE SEAL OF A PROFESSIONAL ENGINEER OR LAND SURVEYOR. IF AN ITEM BEARING THE SEAL OF A PROFESSIONAL ENGINEER OR LAND SURVEYOR. IF AN ITEM BEARING THE SEAL OF A PROFESSIONAL ENGINEER OR LAND SURVEYOR. IF AN ITEM BEARING THE SEAL OF A PROFESSIONAL ENGINEER OR LAND SURVEYOR. IF AN ITEM BEARING THE SEAL OF A PROFESSIONAL ENGINEER OR LAND SURVEYOR SHALL AFIR TO THE ITEM THEIR SEAL AND THE NOTATION "ALTERED BY FOLLOWED BY THER SICNATURE AND THE DATE OF SUCH ALTERATION, AND A SPECIFIC DESCRIPTION OF THE ALTERATION.

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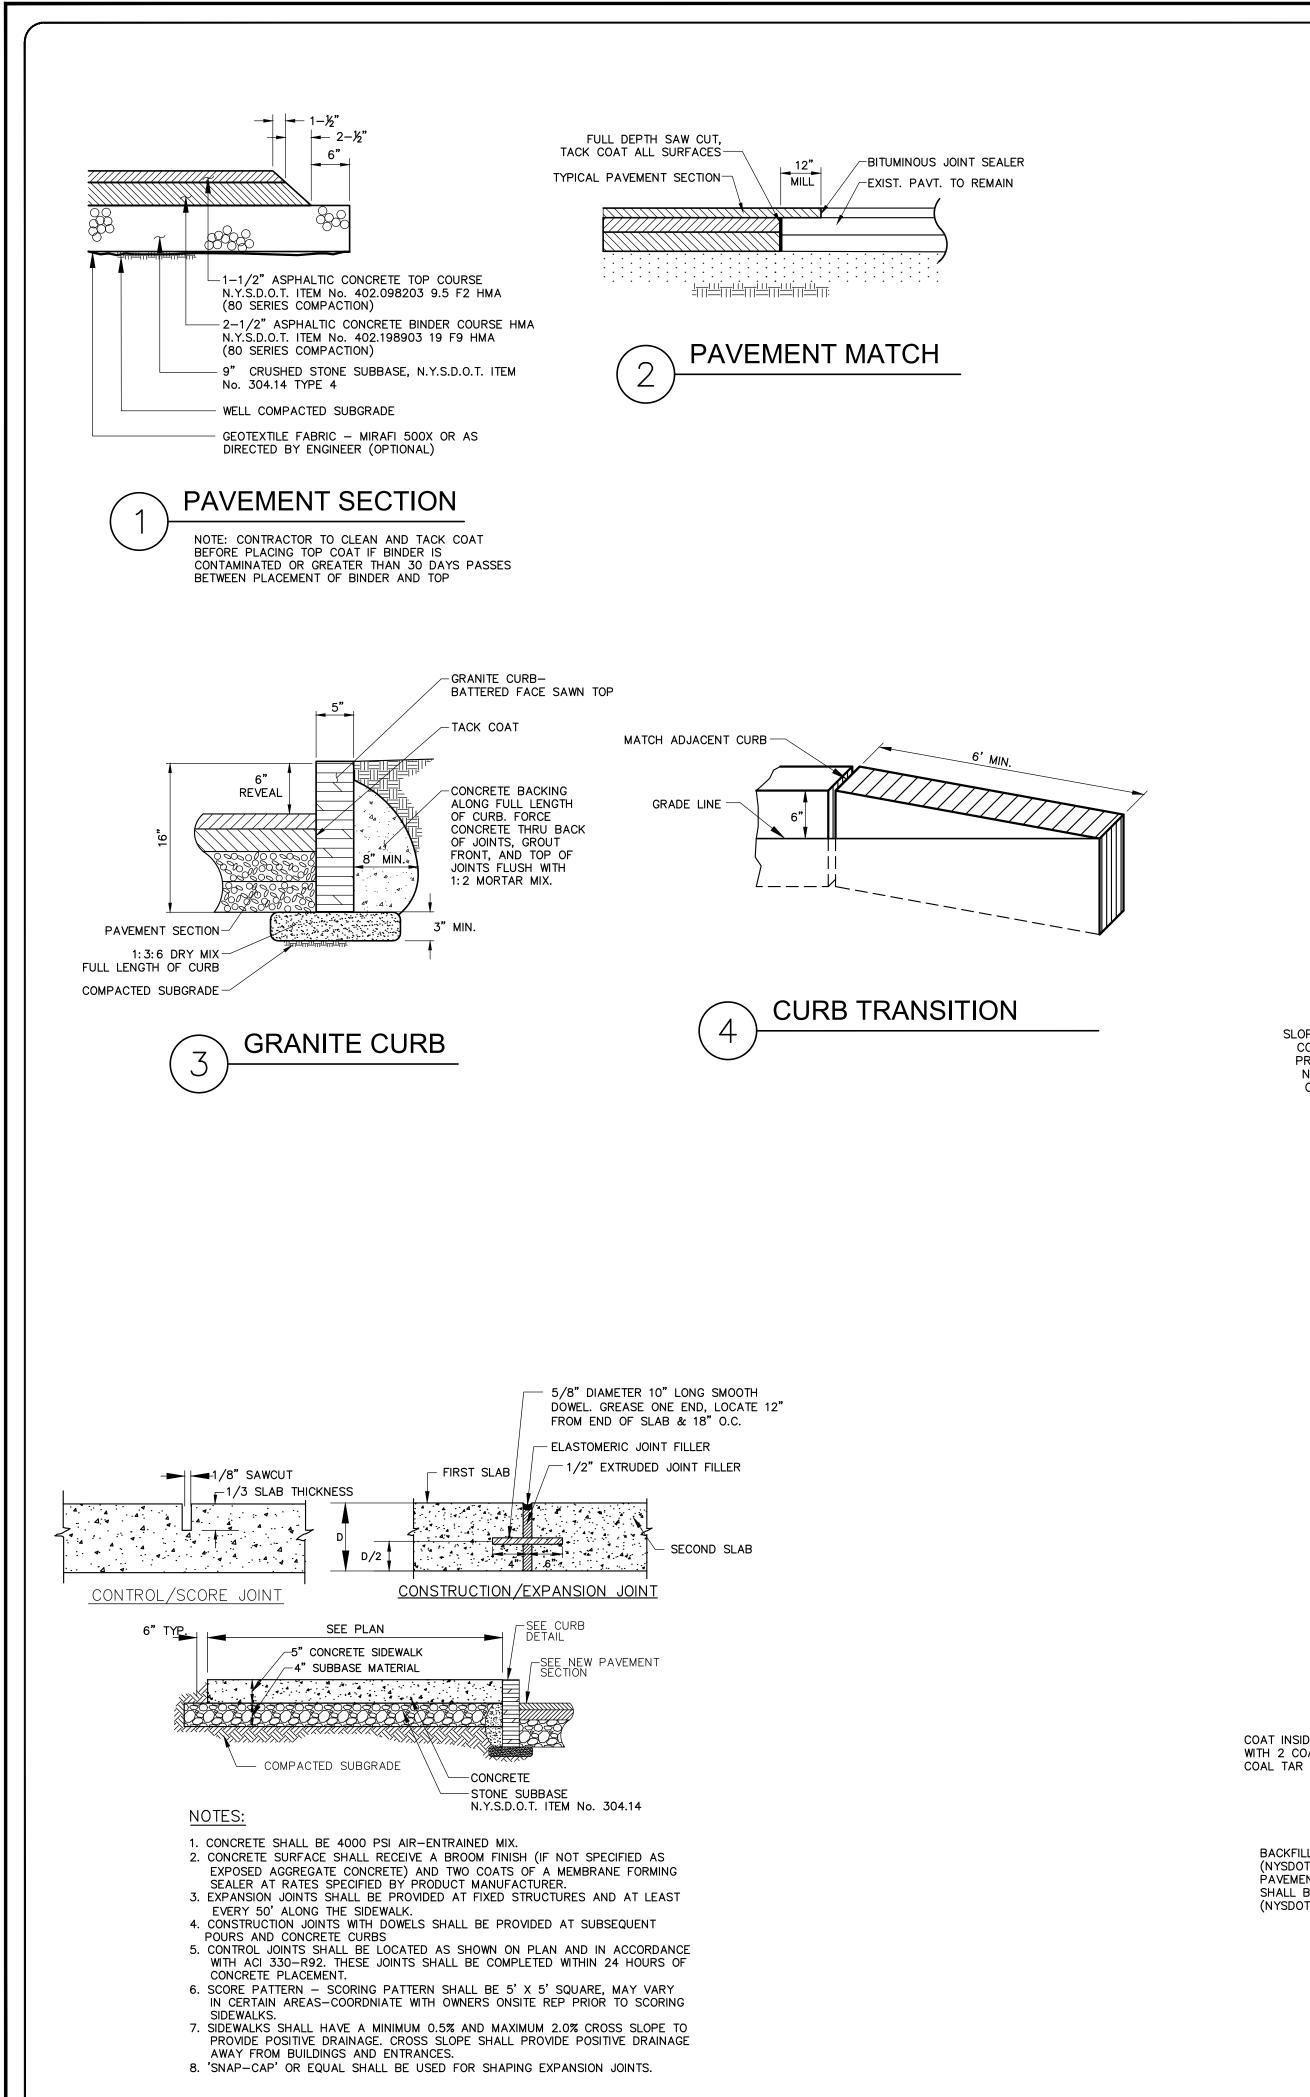
DRAWING TITLE:
LANDSCAPING
PLAN

5 of 6
SHEET No:


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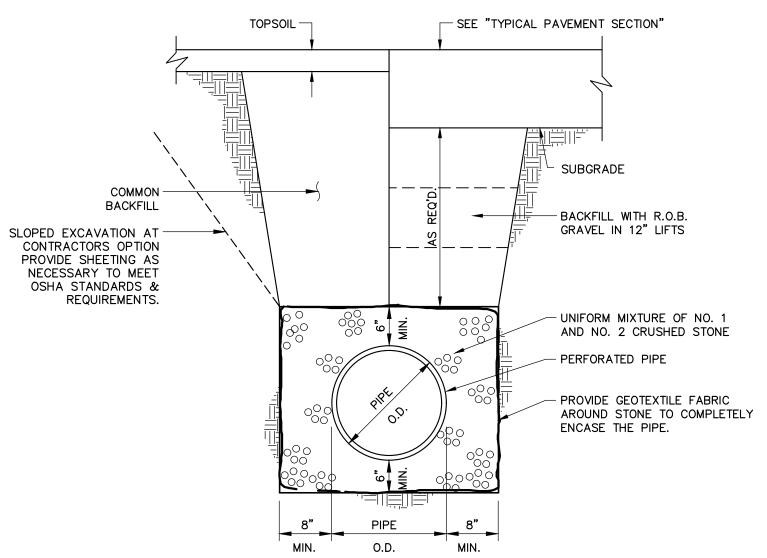
ROBERT P. BRINGLEY




**CONCRETE SIDEWALK** 



6 SOLID PIPE

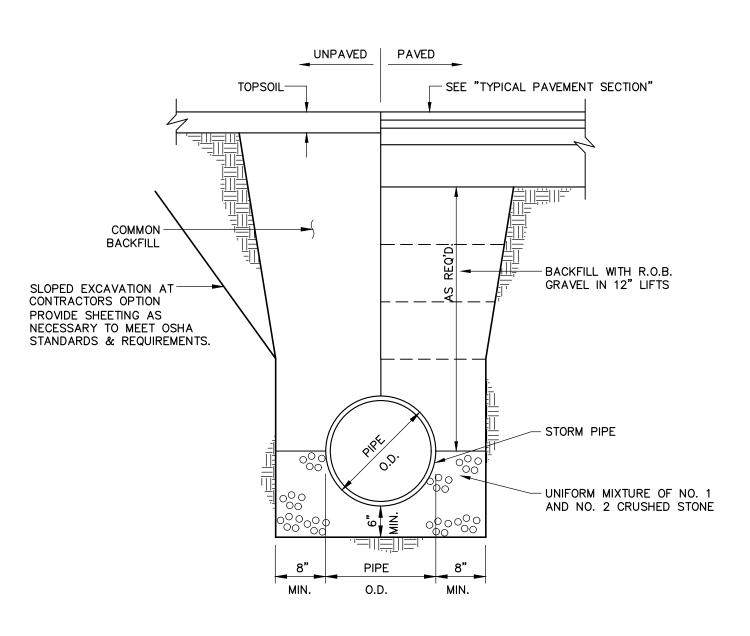


7 STORM TRENCH PERFORATED PIPE

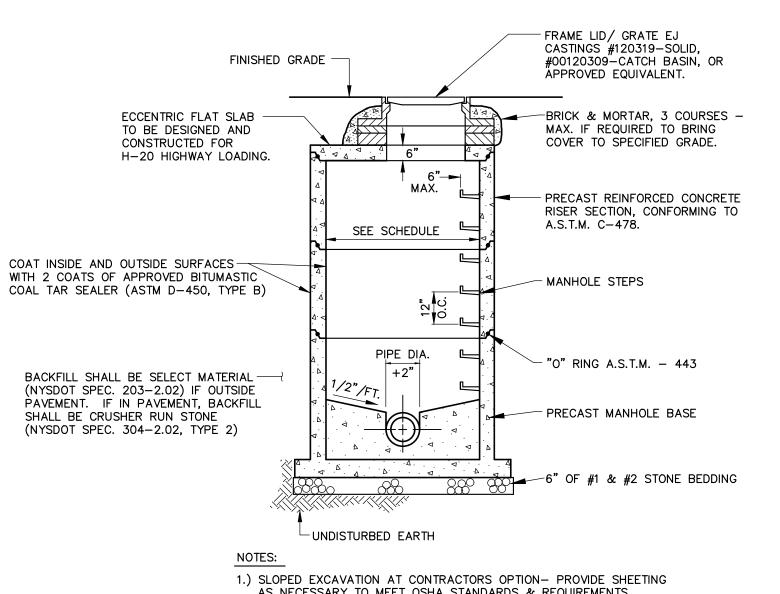

AS NECESSARY TO MEET OSHA STANDARDS & REQUIREMENTS.

STORM MANHOLE

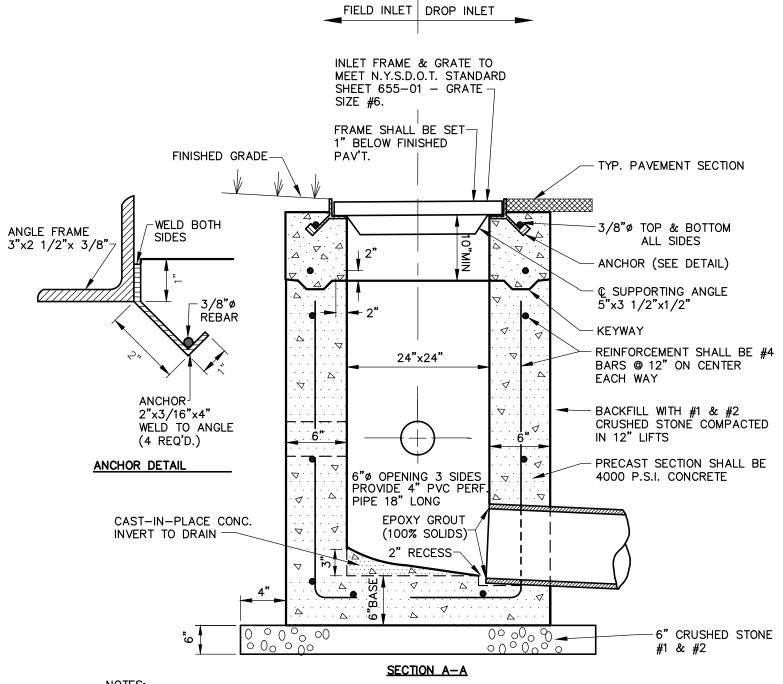

NOTES:

1.) PRE-CAST INLET SECTIONS SHALL BE MANUFACTURED BY KISTNER, MODEL No. CB-24 (WITH KEYWAY) OR APPROVED EQUIVALENT.

2.) THE INSIDE & OUTSIDE WALLS OF INLET SHALL BE COATED WITH BITUMASTIC

9 DROP/ FIELD INLET



> SMITH IG DRIVE

MINARY/FINAL SITE PLANA, MRS. JOHN SMI AVIDSON LANDING DR

JOB NO: 0437-18
SCALE: AS SHOWN
DRAWN: LJB
DESIGNED: RPB
DATE: 10/12/18
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OLATION OF NEW YORK STATE EDUCATION LAW ARTICLE 145, SECTION 7205 SON, UNLESS ACTING UNDER THE DIRECTION OF A LICENSED PROFESSI I OR LAND SURVEYOR, TO ALTER IN ANY WAY, AN ITEM BEARING THE SEAL DNAL ENGINEER OR LAND SURVEYOR IF AN ITEM BEARING THE SEAL DNAL ENGINEER OR LAND SURVEYOR IS ALTERED, THE ALTERING ENGINEER OR SHALL AFFIX TO THE ITEM THER SEAL AND THE NOTATION "ALTERED

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OF NEW

P. BRILLO

NO. 066924

DRAWING TITLE:

CONSTRUCTION
DETAILS

ROBERT P. BRINGLEY

6 of 6
SHEET No:

0437-18

JOB No: DRAWING No:

APPROVED BY:

TOWN WATER SUPERINTENDENT
DATE:

APPROVED BY:

TOWN ENGINEER
DATE:

APPROVED BY:

PLANNING BOARD CHAIRMAN