

LOCATION MAP

NOT TO SCALE

SITE	E ZONING DATA		
	REQUIRED	PROPOSED	
ZONING/USE - PRINCIPAL	RR-3	RR-3	
ZONING/USE — ACCESSORY	NA	NA	
PRINCIPAL BUILDING SQUARE FOOTAGE	MIN 1200SF	3100	
FRONT SETBACK	60'	167.96'	
SIDE SETBACK	40'	143.22'	
REAR SETBACK	40'	207.79' 28'	
BUILDING HEIGHT	35'		
BLDG LOT COVERAGE	15.00%	5%	

TOWN OF CANANDAIGUA NOTES:

- ALL IMPROVEMENTS SHALL BE IN ACCORDANCE WITH THE MOST RECENT STANDARDS AND SPECIFICATIONS OF THE TOWN OF CANANDAIGUA AND THE APPROPRIATE WATER/SEWER AGENCIES, UNLESS OTHERWISE NOTED.
- 2. A STORM WATER POLLUTION PREVENTION PLAN (SWPPP) MAY BE REQUIRED TO CONFORM WITH THE LATEST NYSDEC GENERAL PERMIT AND TO THE TOWN REQUIREMENTS REGARDING MAINTENANCE AND AND CONTROL OF STORM WATER QUALITY AND QUANTITY.
- ALL SWPPP'S ARE REQUIRED TO BE REVIEWED AND APPROVED BY THE TOWN CEO AND TOWN ENGINEER. THE TOWN MS4 SWPPP ACCEPTANCE FORM IS TO BE SIGNED AND INSERTED INTO THE PROJECT SWPPP PRIOR TO CONSTRUCTION.
- . THE OWNER IS RESPONSIBLE FOR IMPLEMENTING THE REQUIRED SWPPP, INCLUDING FILING OF THE "NOTICE OF INTENT" (NOI). A COPY OF THE NYSDEC ACKNOWLEDGEMENT LETTER IS TO BE PROVIDED TO THE TOWN DEVELOPMENT OFFICE AND TOWN ENGINEER PRIOR TO CONSTRUCTION.
- 6. A COPY OF THE PROJECT SWPPP IS TO BE PROVIDED TO THE TOWN DEVELOPMENT OFFICE, TOWN ENGINEER, AND A COPY IS TO REMAIN ONSITE DURING CONSTRUCTION AT ALL TIMES IN A MARKED AND . ANY MODIFICATIONS OR DEVIATIONS FROM THE APPROVED PLANS, CONSTRUCTION SEQUENCE, AND/OR
- SWPPP, INCLUDING IMPLEMENTATION OF EROSION CONTROL MEASURES AND STORM WATER MANAGEMENT AREAS, SHALL BE APPROVED BY THE TOWN OF CANANDAIGUA AND DOCUMENTED WITHIN THE PROJECT 7. THE OWNER IS REQUIRED TO PROVIDE DAILY ONSITE OBSERVATION BY A LICENSE PROFESSIONAL OR A CERTIFIED PROFESSIONAL IN EROSION AND SEDIMENT CONTROL (CPESC). ALL SWPPP INSPECTIONS ARE
- TO BE IN A FORM ACCEPTABLE BY THE TOWN OF CANANDAIGUA AND FORWARDED TO OWNER. THE TOWN CEO, TOWN ENGINEER, AND A COPY PLACED WITHIN THE ONSITE PROJECT SWPPP. 3. THE OWNER IS RESPONSIBLE FOR PROVIDING ONSITE SWPPP INSPECTIONS BY A LICENSE PROFESSIONAL OR A CERTIFIED PROFESSIONAL IN EROSION AND SEDIMENT CONTROL (CPESC) DURING CONSTRUCTION ONCE PER WEEK (EVERY 7 DAYS) IF UNDER 5-ACRES OF DISTURBANCE AND TWICE PER WEEK (EVERY
- 7 DAYS) IF 5-ACRES OR MORE WITH RECEIPT OF A 5-ACRE WAIVER FROM THE TOWN OF CANANDAIGUA (MS4). DEVELOPMENT IN THE CANANDAIGUA LAKE WATERSHED DISTURBING MORE THAN 5-ACRES AT ONE TIME, IS REQUIRED TO COORDINATE THE REGULAR SWPPP OBSERVATIONS REQUIRED BY THE LATEST GENERAL PERMIT WITH THE CANANDAIGUA LAKE WATERSHED INSPECTOR, THE WATERSHED PROGRAM MANAGER
- AND THE TOWN CODE ENFORCEMENT OFFICER. 0. CONSTRUCTION SEQUENCE - ALL PLANS ARE TO BE PROVIDED WITH A DETAILED CONSTRUCTION SEQUENCE. THE CONTRACTOR SHALL COMPLETE CONSTRUCTION AND INSTALL EROSION CONTROL MEASURES IN ACCORDANCE WITH THE APPROVED CONSTRUCTION SEQUENCE UNLESS SPECIFIED
- OTHERWISE ON THE APPROVED DESIGN PLANS OR AT THE PRE -CONSTRUCTION MEETING. 11. DUST SHALL BE CONTROLLED DURING CONSTRUCTION BY THE CONTRACTOR TO MINIMIZE EFFECT ON THE ADJACENT PROPERTIES. THE CONTRACTOR SHALL IMPLEMENT DUST CONTROL MEASURES AS NEEDED AND/OR AS DIRECTED BY THE TOWN OF CANANDAIGUA.
- 12. THE OWNER'S CONTRACTOR SHALL BE RESPONSIBLE FOR THE ESTABLISHMENT, MAINTENANCE, CLEANING, REPAIR AND REPLACEMENT OF EROSION CONTROL MEASURES DURING SITE CONSTRUCTION AND UNTIL THE SITE IS FULLY STABILIZED, INSPECTED BY THE TOWN OF CANANDAIGUA, AND ISSUANCE OF THE NOTICE OF TERMINATION (NOT) HAS BEEN PROVIDED TO NYSDEC.
- 14. ROOF LEADERS SHOULD BE CONNECTED TO STORM SEWERS WHERE POSSIBLE, UNLESS OTHERWISE SPECIFIED ON THE APPROVED PLANS AND WITHIN THE PROJECT SWPPP.
- 15. NO SITE PREPARATION SHALL COMMENCE UNTIL A VISUAL INSPECTION BY THE TOWN OF CANANDAIGUA, CONFIRMS THE INSTALLATION OF PERIMETER SEDIMENT CONTROLS AND THE STABILIZED CONSTRUCTION
- 16. UPON COMPLETION OF CONSTRUCTION AND ESTABLISHMENT OF VEGETATION, THE STORM WATER MANAGEMENT FACILITIES SHALL BE CLEANED OF ACCUMULATED SILT.

WASTEWATER TREATMENT BASIS OF DESIGN (PER NYS APPENDIX 75-A): NUMBER OF BED ROOMS DESIGNED FOR..... (NO GARBAGE DISPOSAL)

TABLE 1 DESIGN FLOW RATE.

TABLE 2-SEPARATION DISTANCES .. . ALL MINIMUMS MET ...NEW 1250 GAL TANK TABLE 5-SEPTIC TANK ..

PROPOSED TREATMENT METHOD:

STANDARD SUB SURFACE CONVENTIONAL ABSORPTION TRENCHES WITH ROOM FOR 50% EXPANSION.

References

- No abstract of title provided. This plan is subject to any easements
- or encumbrances that an updated search may reveal. Liber 1328, page 416 of deeds
- Survey of Peter E. & Linda J. Low property by Rocco A. Venezia, L.S. dated October 14, 2014, job no. 14249

I certify that this plan was prepared April 13, 2018 from notes of an instrument survey completed April 5, 2018 and from materials referenced

David M. Parrinello NYSPLS 049724

1. THE CONTRACTOR SHALL MAINTAIN ALL UTILITIES AND PROPERTY MARKERS. IT IS THE NYS LAW TO CALL NYS DIG SAFE FOR UFPO (811) PRIOR TO ANY EXCAVATION. 2. THE CONSTRUCTION SITE IS NOT WITHIN 100' OF A WETLAND AS DELINEATED BY NYS DEC. THERE ARE NOT NYS DEC DELINEATED OR APPARENT WETLANDS ON THE PROPERTY AS SHOWN.

4. WATER SUPPLY: PRIVATE WELL

3. PLACE SILT FENCE FOR STOCKPILE AREA

5. CONSTRUCT BUILDING AND INSTALL UTILITIES

PROPERTY LINES AND TOPOGRAPHY ARE BASED ON SURVEY PROVIDED BY MARKS ENGINEERING DATED 04/05/2018

NYS SPDES PERMIT IS NOT REQUIRED FOR THESE CONSTRUCTION ACTIVITIES, DISTURBANCE SHALL BE LESS THAN ONE ACRE. IF THE CONTRACTOR OR OWNER AT ANY TIME PLAN DISTURB GREATER THAN AN ACRE THE ENGINEER SHALL BE NOTIFIED.

1. INSTALL TEMPORARY EROSION CONTROL MEASURES INCLUDING BUT NOT LIMITED TO: SILT FENCE, STABILIZED ENTRANCES, ETC.

2. THE CONTRACTOR SHALL SELECTIVELY REMOVE VEGETATION AND ROOTS AS

MAINTAIN EROSION CONTROL PRACTICES AS NECESSARY. IF ADDITIONAL MEASURE ARE REQUIRED THESE SHALL BE PROVIDED AT THE EXPENSE OF THE OWNER OR CONTRACTOR.

7. IN THE EVENT THERE IS A SEDIMENT DISCHARGE OR FAILURE THE CONTRACTOR OR OWNER SHALL BE RESPONSIBLE FOR RESTORATION.

9. INSTALL RAIN GARDEN AND SWALE AFTER AREAS CONTRIBUTING DRAINAGE ARE

10. REMOVE TEMPORARY EROSION CONTROLS AFTER AREAS ARE STABILIZED WITH VEGETATION, STONE OR ASPHALT.

8. FINAL GRADE SEED AND MULCH DISTURBED AREAS AS SOON AS POSSIBLE.

6. TOTAL PROPERTY AREA: 4.97+/— ACRES. PROPERTY ZONED AS RURAL RESIDENTIAL/ENVIRONMENTAL OVERLAY DISTRICT.

8. CONTACT HIGHWAY SUPERVISOR PRIOR TO START OF CONSTRUCTION.

- THE ROADWAY SHALL BE KEPT FREE OF DEBRIS DURING CONSTRUCTION. 3. THE CONSTRUCTION SITE IS NOT WITHIN A 100 YEAR FLOODPLAIN AS DELINEATED BY 3. THE CONTRACTOR IS RESPONSIBLE FOR SAFETY CONTROL DEVICES. SUCH DEVICES (BARRICADES,
 - FENCING, ETC.) SHALL BE IMPLEMENTED TO MINIMIZE RISK OF INJURY TO PEDESTRIANS AND WORKERS. CONSTRUCTION ACTIVITY SHALL BE CONDUCTED WITHIN COMPLIANCE WITH OSHA
 - 4. PLANS ARE GRAPHIC REPRESENTATIONS OF WORK TO BE PERFORMED. THESE PLANS ARE TO INTENDED TO CONVEY ENGINEERING INFORMATION ONLY.
 - . CONTRACTOR TO VERIFY ALL PROPERTY LINES, LOCATIONS, GRADES AND INVERTS AND NOTIFY ENGINEER OF ANY DISCREPANCIES PRIOR TO THE START OF WORK.
 - ALL SPECIFIED MATERIALS ARE TO BE INSTALLED AS PER MANUFACTURES RECOMMENDATIONS OR . ENGINEER DOES NOT HOLD ANY LIABILITY FOR SYSTEM FAILURE. ANY SYSTEM MODIFICATIONS OR DEVIATIONS FROM THE APPROVED PLANS, NYS BUILDING CODES, AND/OR LOCAL REGULATIONS REQUIRED BY SITE CONSTRAINTS, UNFORESEEN CONDITIONS OR GOVERNING AUTHORITIES WILL BE DONE AT THE RISK OF THE CLIENT.
 - 8. ALL CONSTRUCTION SHALL COMPLY WITH CURRENT NYS AND LOCAL BUILDING CODES AS WELL AS NATIONAL ELECTRIC CODE. 9. ELEVATIONS ARE BASED ON NAVD 88 DATUM AND COORDINATES SYSTEM IS BASED ON NAD 83
 - NO PHOSPHOROUS SHALL BE USED FOR FERTILIZER, SOIL AUGMENTATION, ETC. UNLESS SOIL TESTS BY A HORTICULTURAL LABORATORY SPECIFICALLY INDICATE A PHOSPHOROUS DEFICIENCY THAT IS HARMFUL OR WILL PREVENT NEW LAWNS AND PLANTING FROM ESTABLISHING PROPERLY.
 - 2. IF SOIL TESTS INDICATED A PHOSPHORUS DEFICIENCY IT SHALL BE APPLIED AT THE MINIMUM LEVELS RECOMMENDED BY SOIL TEST FOLLOWING NYSDEC
- THIS PROPERTY IS LOCATED WITHIN AN ESTABLISHED AGRICULTURAL DISTRICT CONTAINING A FARM OPERATION AND A RIGHT—TO—FARM ORDINANCE. RESIDENTS SHOULD BE AWARE THAT SUCH FARM OPERATIONS MAY GENERATE DUST, ODOR, SMOKE, NOISE VIBRATION AND OTHER ACTIVITIES WHICH MAY NOT BE COMPATIBLE WITH RESIDENTIAL USE OF THIS PROPERTY.

-40' SETBACK LINE-

NEW ELEC & 1" HDPE 160#

MIN 48" DEPTH

THE CONTRACTOR IS RESPONSIBLE FOR THE CONTROL OF EROSION AND SEDIMENTATION DURING

SOIL DISTURBANCES SHALL BE STABILIZED IMMEDIATELY, DISTURBED SOIL THAT WILL REMAIN LONGER THAN 14 DAYS SHALL BE TEMPORARILY STABILIZED WITHIN 7 DAYS. SOIL SHALL BE STABILIZED WITH NORTHERN GRASS SEED MIXTURE OR APPROPRIATE SEED MIXTURE FOR CONDITIONS. GRASS SEED SHALL BE

INSTALLED PER MANUFACTURES SPECIFICATIONS. MULCH STRAW APPLIED AT A RATE OF 2 BALES / 1000 SQFT OR SEED MIXTURE TO PROTECT SITE UNTIL SEED GERMINATES. HYDRO—SEED MAY BE INSTALLED AS AN ALTERNATE.

3. CONTRACTOR SHALL INSPECT THE SITE DAILY FOR SIGNS OF EROSION. IF ANY EROSION OR SEDIMENTATION OCCUR CONTRACTOR SHALL IMMEDIATELY PROVIDE PROPER CONTROLS TO STABILIZE THE SITE. ENGINEER WILL RECOMMEND CONTROLS IF REQUIRED.

ALL EROSION AND SEDIMENTATION CONTROL MEASURES SHALL BE IN STALLED IN ACCORDANCE WITH NYS STANDARDS AND SPECIFICATIONS FOR EROSION AND SEDIMENTATION CONTROLS.

THE SITE SHALL BE COMPLETELY STABILIZED FOLLOWING CONSTRUCTION ACTIVITIES AND ALL TEMPORARY EROSION CONTROL DEVICES SHALL BE REMOVED AND DISPOSED OF PROPERLY.

N08°19'51"E 456.37'

Sarah Frank, LLC L.1328 P.416 AREA = 4.97 ACRES

- EXISTING WELL TEST FOR POTABILITY

(NAD83 DATÚM)

BENCHMARK (TOP) = 1008.81

NEW FOUNDATION & GUTTER DRAIN TO DAYLIGHT W/ (2) SDR-35 PVC PIPES AND ANIMAL PROTECTION

~ NEW 1250 GAL 2 COMPARTMENT

PRECAST CONC OR HDPE SEPTIC

NEW 4" SCH 40 PVC @ MIN 1/4" PER FT

S05°28'39"W 440.05'

DEUEL ROAD (49.5' RIGHT OF WAY)

SLOPE GREATER THAN 4 ON 1 SHALL BE STABILIZED WITH JUTE FABRIC INSTALLED AS PER MANUFACTURES SPECIFICATIONS AS REQUIRED.

3. INSTALL AND MAINTAIN TEMPORARY DIVERSION SWALES AS NEEDED TO CONTROL RUNOFF DURING CONSTRUCTION.

CONSTRUCTION. SILT FENCE SHALL BE INSTALLED AND MAINTAINED AS NEEDED.

- SAFETY BACKFILL WITH CLEAN EXCAVATED SOIL. ENCASE IN 12" OF SAND IN SOIL
- CONTAINING SIGNIFICANT STONES OR BEDROCK.

 2. ALL WATER LINES SHALL BE INSTALLED AT A MIN OF 60" OR OTHERWISE
- ALL WALES LINES SAILL BE INSTALLED AT A MIN OF 80 OR OTHERWISE PROTECTED FROM FROST.

 3. ALL UTILITY INSTALLATION AND CONNECTIONS SHALL BE COORDINATED WITH APPROPRIATE UTILITY COMPANY.

 4. PROVIDE TRACER WIRES AND CAUTION TAPE AS REQUIRED.

 5. CONTRACTOR SHALL TRIANGULATE FINAL UTILITY LOCATIONS OFF PROPERTY LINES OR HOUSE CORNERS AND PROVIDE TO OWNER.

SANITARY PIPE SHALL BE 4" SDR-21 PVC OR EQUAL INSTALLED W/ MIN 1" PER FOOT SLOPE GRADING NOTES:

Matthew D. & Heidi J. Colf L.916 P.271

- UNLESS OTHERWISE NOTED CUT AND FILL SLOPE SHALL NOT EXCEED 3 ON 1. SPECIFIED CUT AND FILL SLOPES EXCEEDING 3 ON 1 SHALL BE STABILIZED WITH SEED, STRAW MULCH AND JUTE MESH FABRIC OR OTHER MEANS OF STABILIZATION.
 CONSTRUCTION SHALL CONFORM TO THE TOWN OF JERUSALEM AND NYS CODES AND STANDARDS 3. SITE SHALL BE GRADED SUCH THAT THERE IS POSITIVE DRAINAGE AT A MINIMUM OF 2% AWAY FROM ANY BUILDINGS, STRUCTURES, DRIVEWAYS, AND SEPTIC SYSTEM.
 TOPSOIL SHALL BE STRIPED OF AREAS PLANNED FOR CONSTRUCTION AND REAPPLIED AFTER GRADING IS FINISHED. ANY UNUSED TOPSOIL SHALL BE HAULED OFF SITE.

EX POND

+ NEW PRECAST DROP BOX (TYP OF E

DRAINAGE SWALE TO ROAD W//

CHECK DAMS/@ 20' O.C. —

NEW SEPTIC SYSTEM PROVIDE

(5) 60° LINE ØF INFILTRATOR / CHAMBERS QUICK 4 24HD ØR ÉQUAL. INSTALL W/ MAX/ /32" PER FOOT FINAL WATERSHED INSPECTOR.

- INSTALL AND MAINTAIN SILT FENCE DURING CONSTRUCTION

—— — — — Drainage Light pole ____ *Contour Line* TEST DEEP HOLE CO -CLEAN OUT TYP-TYPICAL **ABBREVIATIONS** PERF-PERFORATED EX-EXISTING MIN-MINIMUM R-RADIUS MAX-MAXIMUM
BC-BOTTOM OF CURB
TC-TOP OF CURB
TW-TOP OF WALL
BW-BOTTOM OF WALL
BS-BOTTOM OF STAIRS

MAX-MAXIMUM
MAX-MAXIMUM
DI-DRAINAGE INLET CPP-CORRUGATED POLYETHYLENE PIPE R-RADIUS SICPP-SMOOTH INTERIOR CORRUGATED POLYETHYLENE PIPE

EXISTING

Iron pin or pipe found

(/) Utility pole

Hydrant

LEGEND

PROPOSED

— — — — — e/ec — — E/T — Utility Lines

_____ _ _ _ _ _ _ _ _ Centerline

____ _ _ _ _ _ _ _ _ _ _ _ _ _ R.O.W. line

Kevin M. & Kimberly K. Landrigan L.1111 P.875

- NEW 30' PAVED ENTRANCE OF DRIVEWAY

- LIMITS OF DISTURBANCE =

0.02 ACRES

PLANNING BOARD DATE

gir

SULLIVAN

DRAWN BY: DESIGNED BY: CHECKED BY: 1"=30' 18-014 04/20/2018 DATE: TAX MAP#: 125.00-1-30.1

centerline roadline-

centerline pavement


Lucas Road

utility easement to RG&E and RTC-

L.427 P.475 and L.467 P. 256


DRAWING TITLE: **PRELIMINARY** SITE PLAN

C100

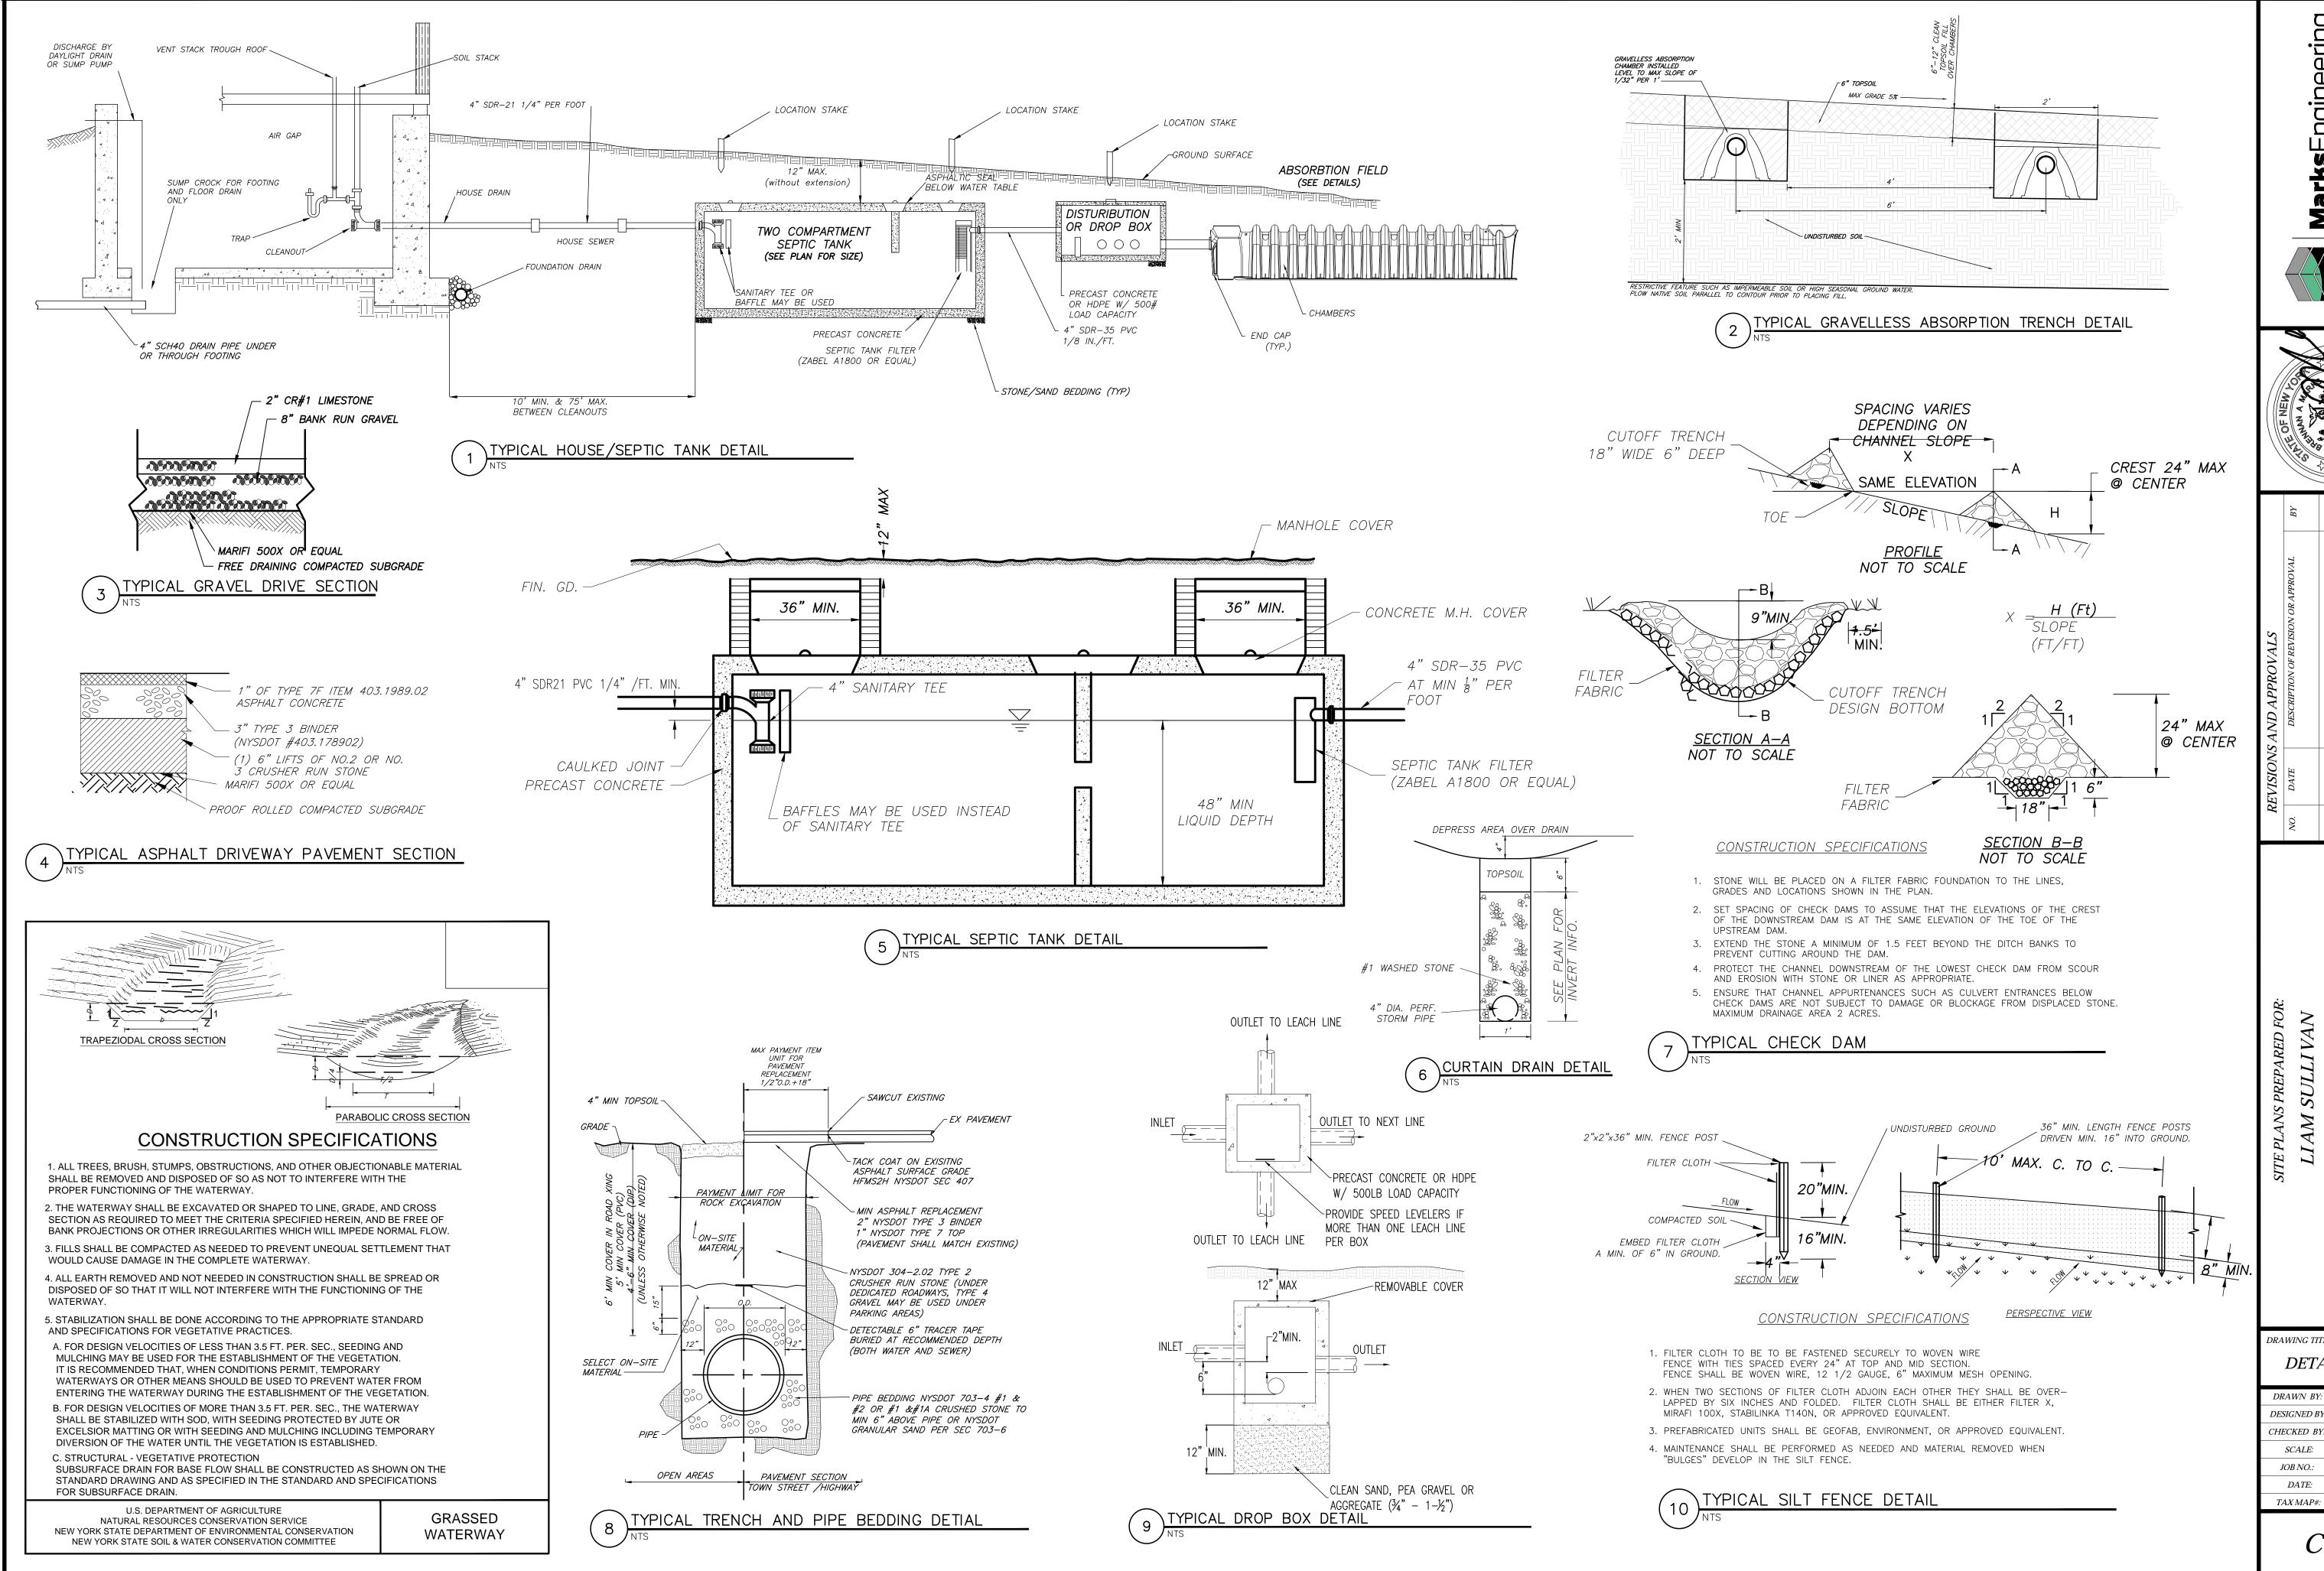

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SULLIVAN


LIAM

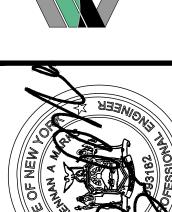
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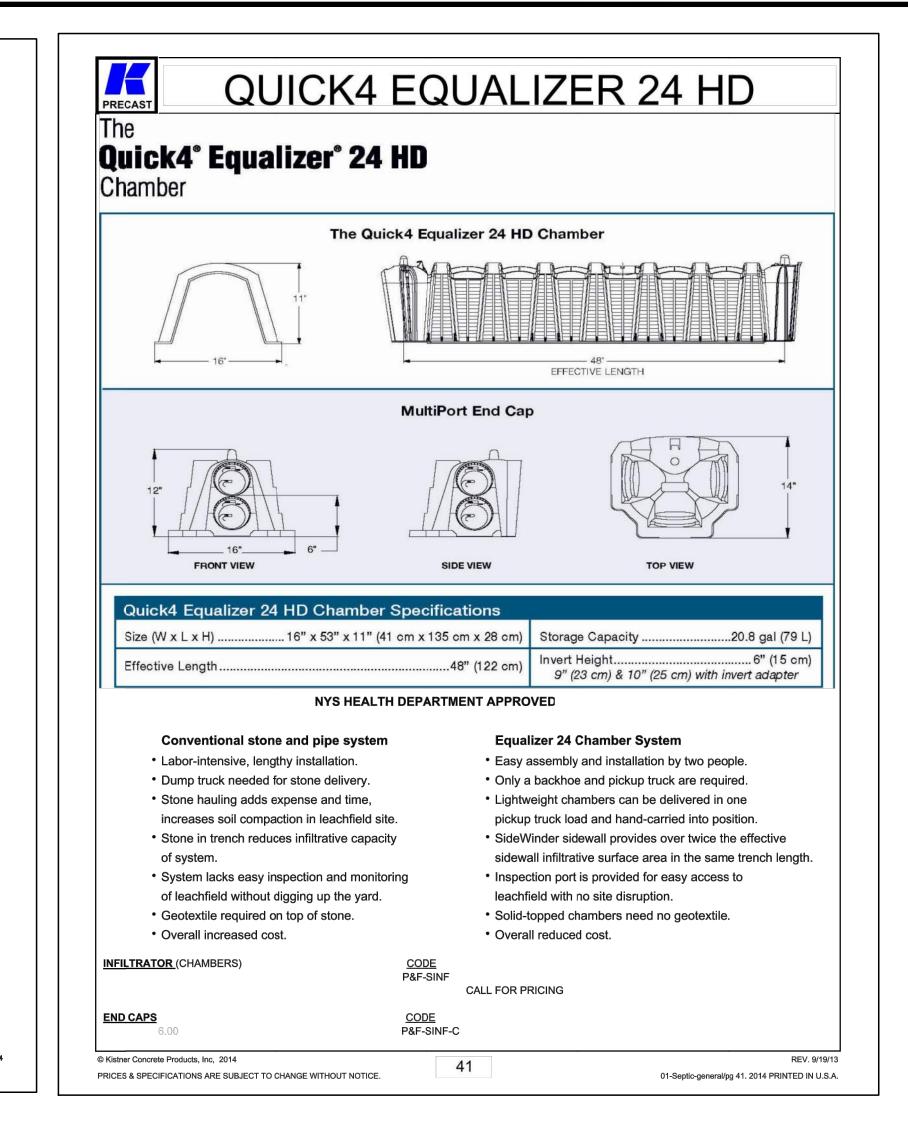
DETAILS

MCFDESIGNED BY: CHECKED BY. 1"=30' 18-014 04/20/2018 TAX MAP#: 125.00-1-30.120

C500




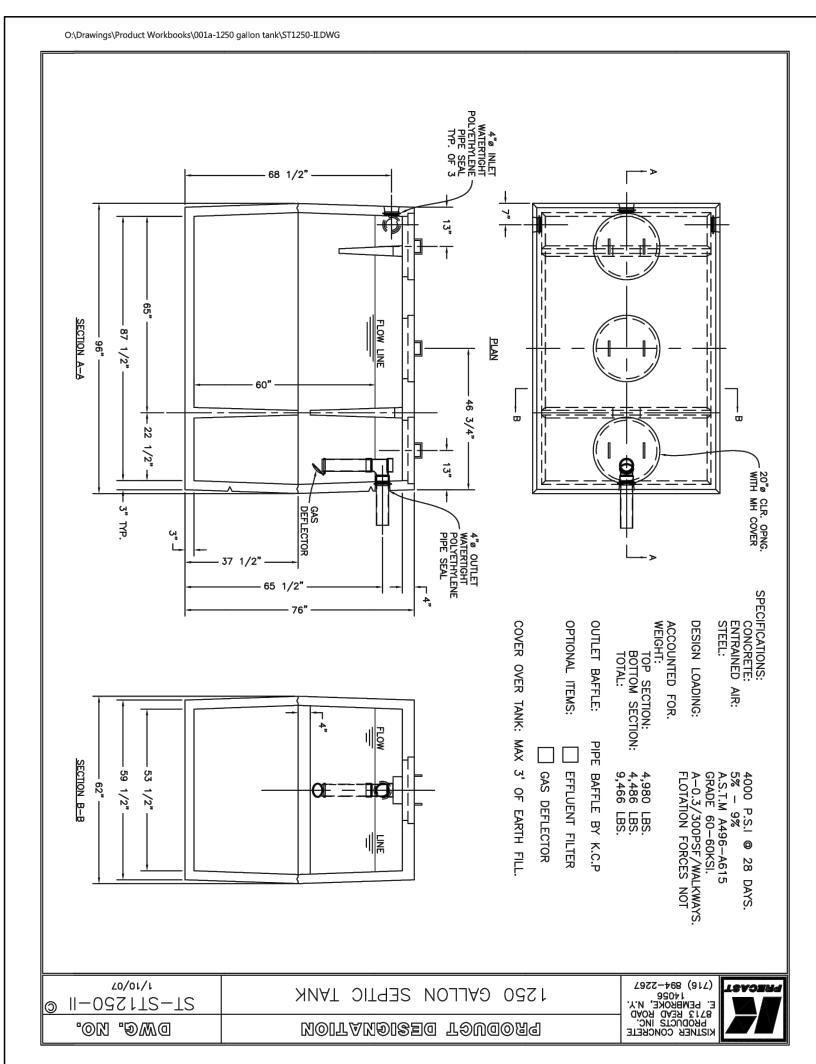

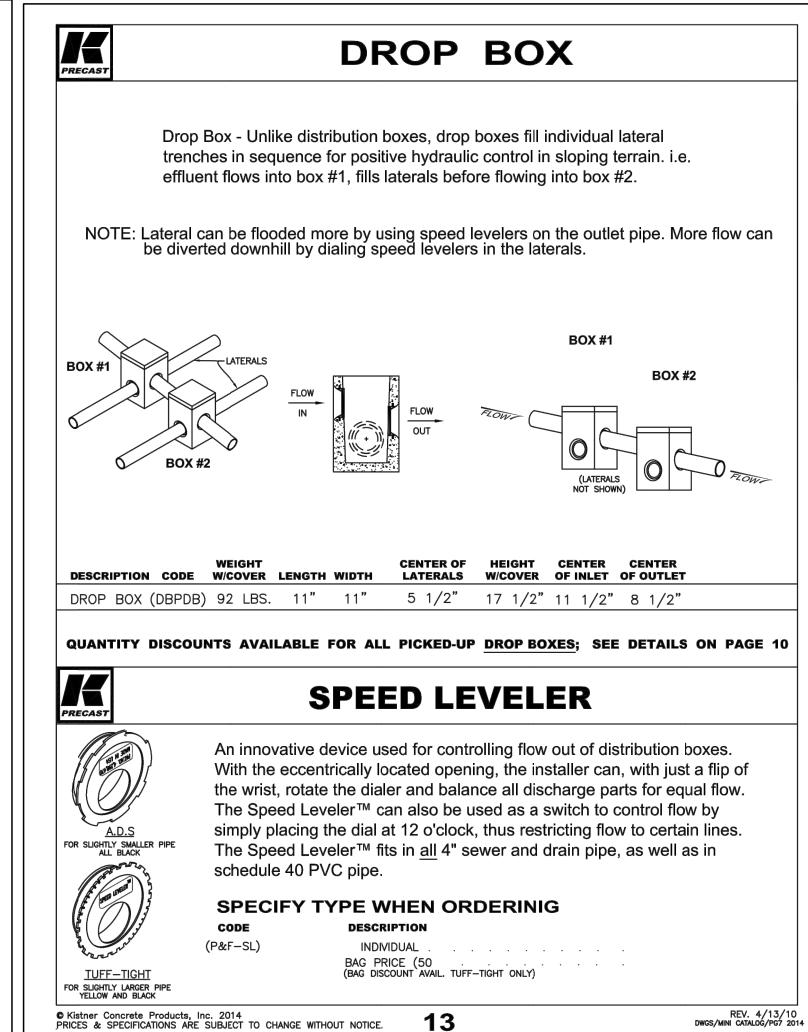

rksEngineering



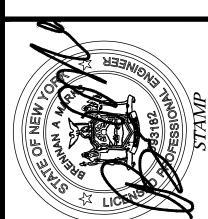

	21 LICEC								
	BY	MCF							
REVISIONS AND APPROVALS	DESCRIPTION OF REVISION OR APPROVAL	PER PRC REVIEW							
EVISION	DATE	04/20/18							
R	NO.	I							

IGUA

SITE PLANS PREPARED FOR:

LIAM SULLIVAN
SHOWING LAND IN:
4536 DEUEL ROAD
TOWN OF CANANDAIGUA

DETAILS

 DRAWN BY:
 MCF

 DESIGNED BY:
 BAM

 CHECKED BY:
 BAM

 SCALE:
 1"=30'

 JOB NO.:
 18-014

 DATE:
 04/20/2018

 TAX MAP#:
 125.00-1-30.120

C501