
PERMITTING SITE PLAN SET FOR PARKING AREA RECONFIGURATION CANANDAIGUA COUNTRY CLUB TOWN OF CANANDAIGUA ONTARIO COUNTY -- STATE OF NEW YORK



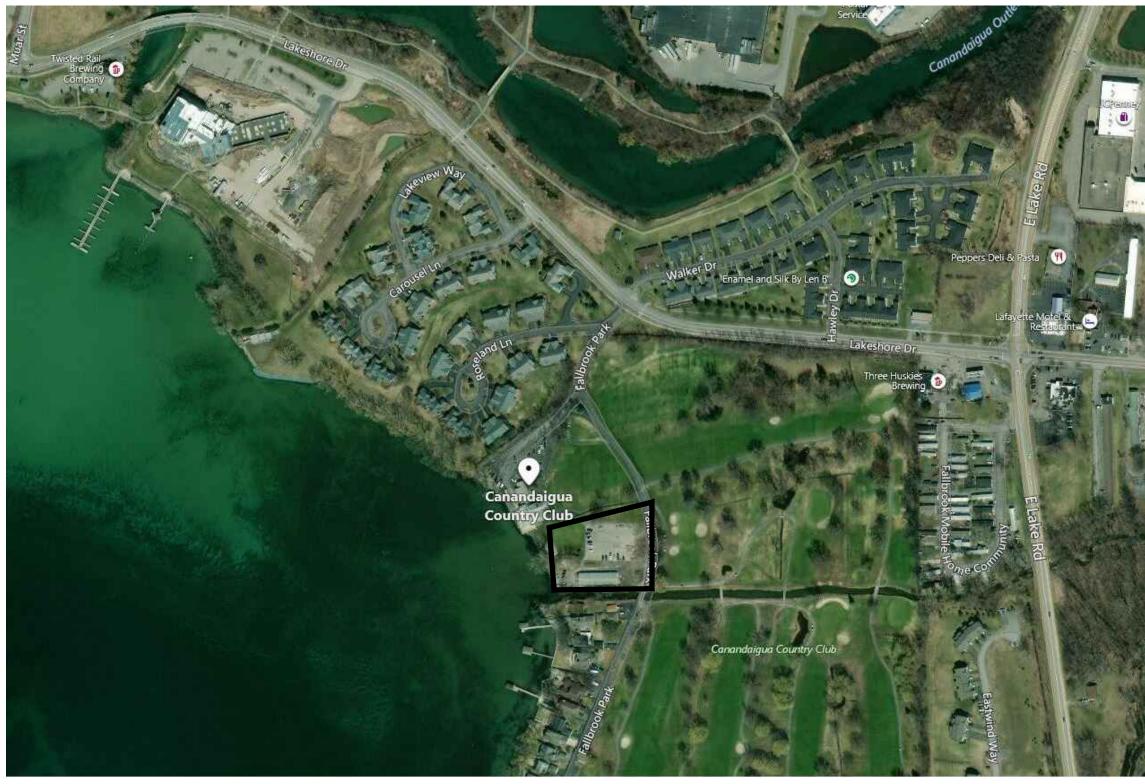

AERIAL LOCUS NOT TO SCALE

FOR PERMITTING ONLY



PER SECTION 7209 OF ARTICLE 145 OF THE NEW YORK STATE EDUCATION LAW IT IS A VIOLATION FOR ANY PERSON TO ALTER ANY DOCUMENT THAT BEARS THE SEAL OF A PROFESSIONAL ENGINEER, UNLESS THE PERSON IS ACTING UNDER THE DIRECTION OF A LICENSED PROFESSIONAL ENGINEER. IF A DOCUMENT BEARING THE SEAL OF AN ENGINEER IS ALTERED. THE ALTERING ENGINEER SHALL AFFIX TO THE DOCUMENT THEIR SEAL AND THE NOTATION "ALTERED BY" FOLLOWED BY THEIR SIGNATURE AND THE DATE OF SUCH ALTERATION, AND A SPECIFIC DESCRIPTION OF THE ALTERATION.



" Copyright 2019" Venezia & Associates. All rights reserved unauthorized duplication is a violation of all applicable laws"

GENERAL NOTES

- PROPERTY LINE INFORMATION SHOWN ON THIS PLAN IS BASED ON AVAILABLE RECORD INFORMATION AND A FIELD INSTRUMENT SURVEY. TOPOGRAPHICAL INFORMATION SHOWN ON THIS PLAN IS BASED ON FIELD SURVEY COMPLETED BY VENEZIA AND ASSOCIATES AND IS REFERENCED TO NAVD 1988
- UTILITIES SHOWN ON THIS PLAN ARE APPROXIMATE. ACTUAL LOCATION SHALL BE FIELD VERIFIED PRIOR TO CONSTRUCTION. THE CONTRACTOR SHALL PROTECT AND MAINTAIN ALL EXISTING UTILITY SERVICES THROUGHOUT CONSTRUCTION. CONTACT U.F.P.O. AT 1-800-962-7962 AT LEAST 72 HOURS PRIOR TO CONSTRUCTION.
- THE UPLAND PORTION OF THE SITE IS IN NOT LOCATED IN A FLOOD ZONE PER C.P. #360598 0020C MAP REVISED MARCH 3, 1997. PORTIONS OF THE LAKESIDE AND STREAMSIDE AREAS THAT ARE LOCATED WITHIN THE 100-YEAR FLOODPLAIN ARE SHOWN ON THE ENCLOSED MAPPING.
- 4. NO CHANGES ARE TO BE MADE TO THIS DESIGN WITHOUT PRIOR APPROVAL OF THE DESIGN ENGINEER.
- ALL IMPROVEMENTS SHALL BE IN ACCORDANCE WITH THE MOST RECENT STANDARDS AND SPECIFICATIONS OF THE TOWN OF CANANDAIGUA, UNLESS OTHERWISE NOTED.
- THE CONTRACTOR SHALL LOCATE, MARK, SAFEGUARD AND PRESERVE ALL SURVEY CONTROL MONUMENTS AND RIGHT-OF-WAY MONUMENTS IN THE AREAS OF CONSTRUCTION.
- PROPOSED LIGHTING TO BE COORDINATED WITH THE OWNER. LIGHTING SHALL BE DARK SKY COMPLIANT 8. ALL EXISTING UNDERGROUND UTILITIES SHALL BE MAINTAINED AND PROTECTED UNLESS OTHERWISE
- 9. ALL SITE DRAINAGE RUNOFF PRODUCED BY THE PROPOSED ONSITE IMPROVEMENTS WILL NOT BE DIRECTED TOWARDS THE NEIGHBORING PARCELS OR BUILDING FOUNDATIONS.
- 10. ALL AREAS WHERE SOIL DISTURBANCE ACTIVITY HAS BEEN TEMPORARILY OR PERMANENTLY CEASED. TEMPORARY AND/OR PERMANENT SOIL STABILIZATION MEASURES SHALL BE INSTALLED AND/OR IMPLEMENTED WITHIN SEVEN (7) DAYS FROM THE DATE THE SOIL DISTURBANCE ACTIVITY CEASED
- 11. ALL FIRE LANES TO BE KEPT OPEN AND UNOBSTRUCTED AT ALL TIMES DURING CONSTRUCTION. 12. THE HORIZONTAL DATUM IS NAD83. THE VERTICAL DATUM IS NAVD88.

Professional Engineer	<u> </u>	Revisions	S		NYS Land Surveyor	Site Plan Drawings Prepared For:
ATEUFNEW	NO.	Date	Description	Ву		
S Han Day 10, 9						CANAN
A A A A A A						
VIERME						
PPOCETEA ENG						
ESSIONAL 3.13					J	

www.veneziasurvey.com

SHEET INDEX:

CVR
EX-1
C-1
C-2

COVER SHEET EXISTING CONDITIONS PLAN SITE PLAN SITE DETAILS

TOWN OF CANANDAIGUA STANDARD NOTES

1. ALL IMPROVEMENTS SHALL BE IN ACCORDANCE WITH THE MOST RECENT STANDARDS AND SPECIFICATIONS OF THE TOWN OF CANANDAIGUA AND THE APPROPRIATE WATER / SEWER AGENCIES, UNLESS OTHERWISE NOTED.

2. SEQUENCE - THE CONTRACTOR SHALL INSTALL EROSION CONTROL MEASURES IN THE FOLLOWING SEQUENCE UNLESS AUTHORIZED OTHERWISE AT THE PRE- CONSTRUCTION MEETING: • INSTALL PERIMETER SEDIMENT CONTROLS, (I.E. EROSION FENCING).

• INSTALL STABILIZED CONSTRUCTION ENTRANCE. • PROTECT VEGETATION TO REMAIN.

• COMPLETE CLEARING AND GRUBBING OPERATION.

• PLACE EROSION CONTROL MEASURES AROUND TOPSOIL STOCKPILES AND STRIP TOPSOIL LOCATIONS. • CONSTRUCT SWALES AND SILTATION DEVICES AS EARTHWORK OPERATIONS PROGRESS.

• MAINTAIN EROSION CONTROL MEASURES AND PLACE ADDITIONAL MEASURES AS EARTHWORK AND UNDERGROUND UTILITIES ARE CONSTRUCTED. • RESTORE AREAS AS DEFINED BY CONTRACT DOCUMENTS.

• REMOVE EROSION CONTROL MEASURES AS AREAS ARE REESTABLISHED WITH GROUND COVER. • IF SITE PREPARATIONS OCCUR BETWEEN SEPTEMBER 1 AND MARCH 31, ADDITIONAL EROSION CONTROLS MUST BE TAKEN INCLUDING REDUCING THE SIZE OF DISTURBANCE AREA AND PLACING HEAVY STRAW MULCH WHERE PRACTICAL.

3. PLANS SHOULD INCLUDE RE-SEEDING INSTRUCTIONS INCLUDING MATERIALS AND A TIMETABLE FOR VARIOUS SEEDING

• SEED ALL CUT AND FILL, TOPSOIL PILES AND PONDS WITHIN SEVEN (7) DAYS AFTER COMPLETION. • TEMPORARY SEEDING OF DISTURBED AREAS SHALL BE PROVIDED AS FOLLOWS:

THE SURFACE TWO INCHES OF SOIL SHOULD BE LOOSENED BY DISKING, RAKING, OR BACK-BLADING WITH A BULLDOZER. IMMEDIATELY FERTILIZE. IMMEDIATELY SEED WITH THE FOLLOWING MIX: LBS/ACRE LBS/1,000 SQ. ACRES SPRING/SUMMER/EARLY FALL

ANNUAL RYE GRASS	30	0.7
PERENNIAL RYEGRASS	30	0.7
ATE FALL/EARLY WINTER		
CEREAL RYE	100	2.5

* NO PHOSPHOROUS SHALL BE USED AT PLANTING TIME UNLESS SOIL TESTING HAS BEEN COMPLETED AND TESTED BY A HORTICULTURAL TESTING LAB AND THE SOIL TESTS SPECIFICALLY INDICATE A PHOSPHOROUS DEFICIENCY THAT IS HARMFUL, OR WILL PREVENT NEW LAWNS AND PLANTINGS FROM ESTABLISHING PROPERLY. * IF SOIL TESTS INDICATE A PHOSPHOROUS DEFICIENCY THAT WILL IMPACT PLANT AND LAWN ESTABLISHMENT, PHOSPHOROUS SHALL BE APPLIED AT THE MINIMUM RECOMMENDED LEVEL PRESCRIBED IN THE SOIL TEST FOLLOWING ALL NYS DEC REGULATIONS.

SEED SHOULD HAVE A GERMINATION RATE OF AT LEAST 85 PERCENT AND MINIMAL INERT MATERIAL. DISTURBED AREAS SHALL BE STABILIZED

	LBS/ACRE	LBS/1,000 SQ. ACR
BIRDSFOOT TREFOIL OR COMMON WHITE CLOVER	8 OR 8	0.20 OR 0.20
TALL FESCUE	20	0.45
REDTOP OR RYEGRASS (PERENNIAL)	2 OR 5	0.05 OR 0.10

USING PERMANENT LAWN SEEDING MIX UPON COMPLETION OF GRADING AND CONSTRUCTION:

SEEDING RATE: 6.0 POUNDS PER 1.000 SQUARE FEET MULCH: STRAW OR WOOD FIBER MULCH USED WITH HYRDO SEEDING METHOD AT TWO TONS PER ACRE WITH TRACKIFIER.

STARTING FERTILIZER: 5:10:10 AT 20 POUNDS PER 1,000 SQUARE FEET. • FOR FALL OR EARLY WINTER, SEED WITH CERTIFIED □AROOSTOCK□WINTER RYE (CEREAL RYE) AT 100 POUNDS PER ACRE. • PERMANENT STABILIZATION FOR STEEP SLOPES GREATER THAN 3:1 SHALL INCLUDE JUTE MESH BLANKET AND CROWN VETCH SEED WITH PERENNIAL RYEGRASS.

4. THE CONTRACTOR SHALL LOCATE, MARK, SAFEGUARD AND PRESERVE ALL SURVEY CONTROL MONUMENTS AND RIGHT-OF-WAY MONUMENT IN THE AREAS OF CONSTRUCTION.

5. EXISTING UNDERGROUND UTILITIES SHOWN HEREIN WERE PLOTTED FROM FIELD LOCATIONS AND /OR UTILITY COMPANY RECORD PLANS. PRIOR TO ANY CONSTRUCTION, THE CONTRACTOR SHALL CALL THE DIG SAFELY NEW YORK (UFPO) HOTLINE AT 1-800-962-7962 FOR STAKEOUT OF EXISTING UTILITIES. THE CONTRACTOR SHALL DETERMINE EXACT LOCATION AND EVALUATION OF UNDERGROUND UTILITIES BEFORE COMMENCING CONSTRUCTION. CONTRACTOR SHALL MAKE EXPLORATION EXCAVATIONS TO LOCATE EXISTING UNDERGROUND FACILITIES SUFFICIENTLY AHEAD OF CONSTRUCTION TO PERMIT REVISIONS AS REQUIRED TO MEET THE EXISTING CONDITIONS.

6.DUST SHALL BE CONTROLLED DURING CONSTRUCTION BY THE CONTRACTOR TO MINIMIZE EFFECT ON THE ADJACENT PROPERTIES. THE CONTRACTOR SHALL IMPLEMENT DUST CONTROL MEASURES AS NEEDED AND/ OR DIRECTED BY THE TOWN OF CANANDAIGUA.

7. THE OWNER'S CONTRACTOR SHALL BE RESPONSIBLE FOR THE ESTABLISHMENT, MAINTENANCE, CLEANING, REPAIR AND REPLACEMENT OF EROSION CONTROL MEASURES DURING SITE CONSTRUCTION.

8.ROOF LEADERS SHALL BE CONNECTED TO STORM SEWERS, UNLESS OTHERWISE NOTED.

9.NO SITE PREPARATION SHALL COMMENCE UNTIL A VISUAL INSPECTION BY THE TOWN OF CANANDAIGUA CONFIRMS THE INSTALLATION OF PERIMETER SEDIMENT CONTROLS.

10. ANY ADDITIONAL EROSION OR SEDIMENT CONTROL DEEMED NECESSARY BY THE TOWN OR A REPRESENTATIVE THEREOF SHALL BE PROVIDED BY THE OWNER.

11. SEDIMENT CONTROL MEASURES ARE TO BE ESTABLISHED PRIOR TO COMMENCING EARTHWORK. SEDIMENT CONTROL MEASURES ARE TO BE MAINTAINED BY THE CONTRACTOR UNTIL UPSTREAM GROUND COVER HAS BEEN ESTABLISHED AND REMOVAL IS APPROVED BY THE TOWN OF CANANDAIGUA.

12. THE CONTRACTOR IS RESPONSIBLE FOR MAINTAINING, REPLACING AND SUBSEQUENTLY REMOVING TEMPORARY EROSION & SEDIMENT CONTROL DEVICES.

13. THE CONTRACTOR SHALL BE RESPONSIBLE FOR CLEANING ADJOINING PROPERTIES, ROADWAYS, DRAINAGE WAYS AND SINKS OF SILT ACCUMULATION AS NEEDED AND AS DETERMINED/ REQUESTED BY THE TOWN OF CANANDAIGUA.

14. ANY FINAL GRADE DEVIATIONS OF HOUSE PAD ELEVATIONS MORE THAN 12 INCHES SHALL BE APPROVED BY THE PLANNING BOARD.

15. INCIDENTAL DISTURBANCES OUTSIDE THE PROPERTY FOOTPRINT WILL BE STABILIZED AND RESTORED TO ORIGINAL OR BETTER CONDITION.

SITE PLAN APPROVAL

PLANNING BOARD CHAIRPERSON

DATE

TOWN ENGINEER

DATE


IDAIGUA COUNTRY CLUB, LLC

Showing Land at 2380 FALLBROOK PARK TOWN OF CANANDAIGUA State of New York County of Ontario - (585)396-3267 - Fax. No. (585) 396-0131 - Fax. No. (585) File# 17116 Scale: N.T.S. T.m. # 98.00-1-39.111 Date: 03/15/19


Sheet:


CVR

E-mail erin@veneziasurvey.com

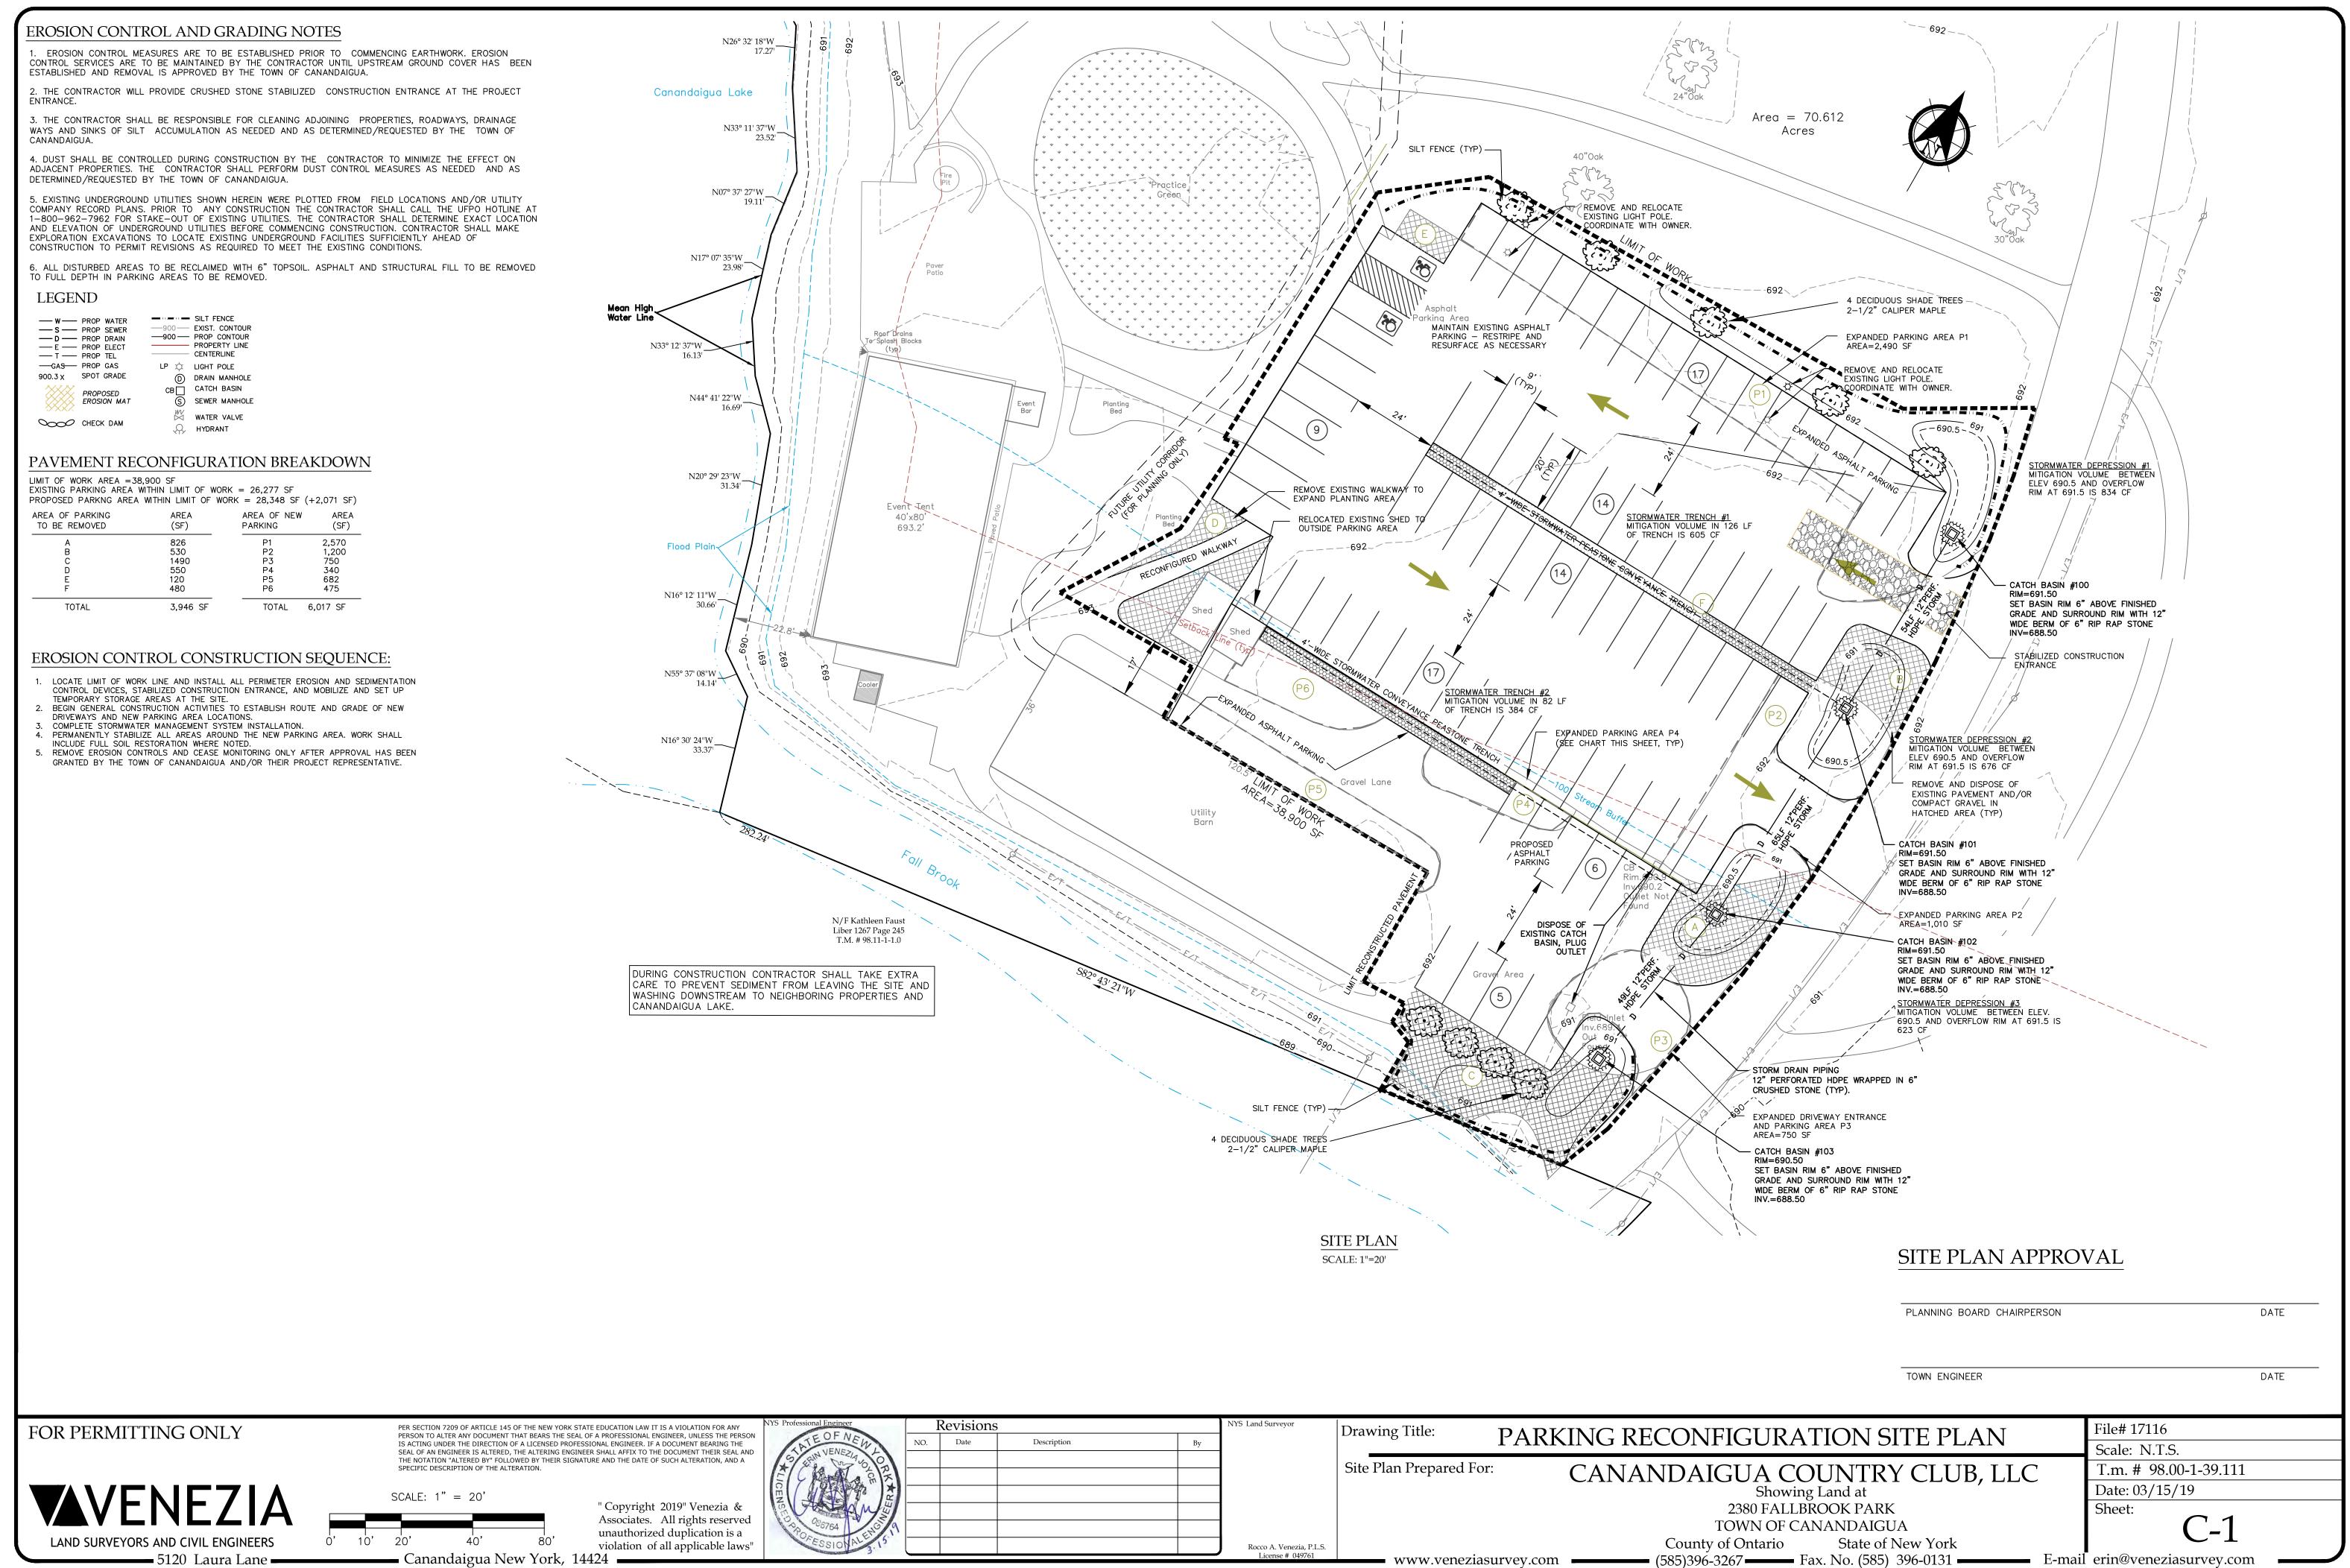

Professional Engineer	I	Revisions	3		NYS Land Surveyor	Drawing Title:		
THEOFNEW	NO.	Date	Description	Ву			PARKING RECO	
2 48 4 5 T 12 P					-	Site Plan Prepared For	" CANANI	
17 Jack Man A						1	CANAINL	
ALEMME					-			
Pp 086764								
ESSIONALE 15					Rocco A. Venezia, P.L.S.		C	
					License # 049761	www.venezias	survey.com (585	

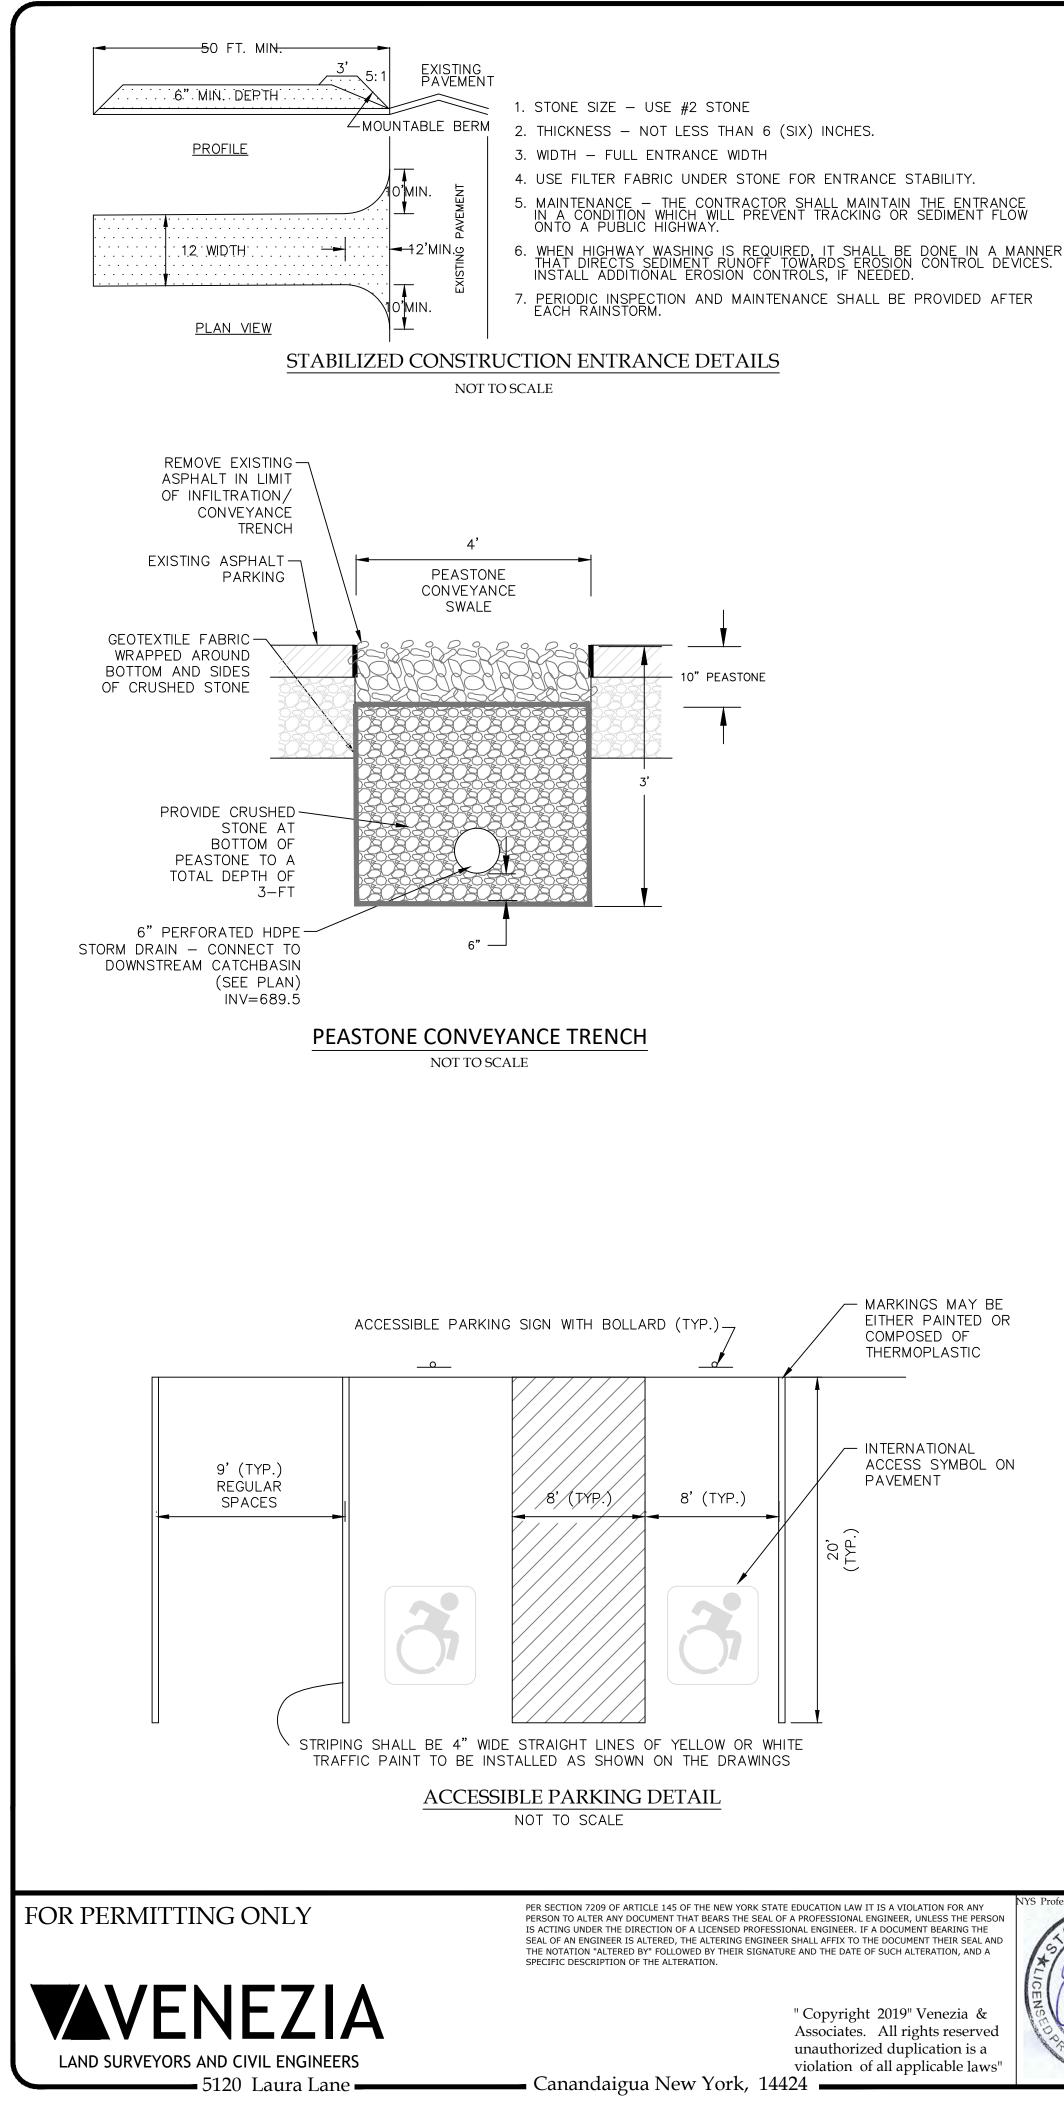

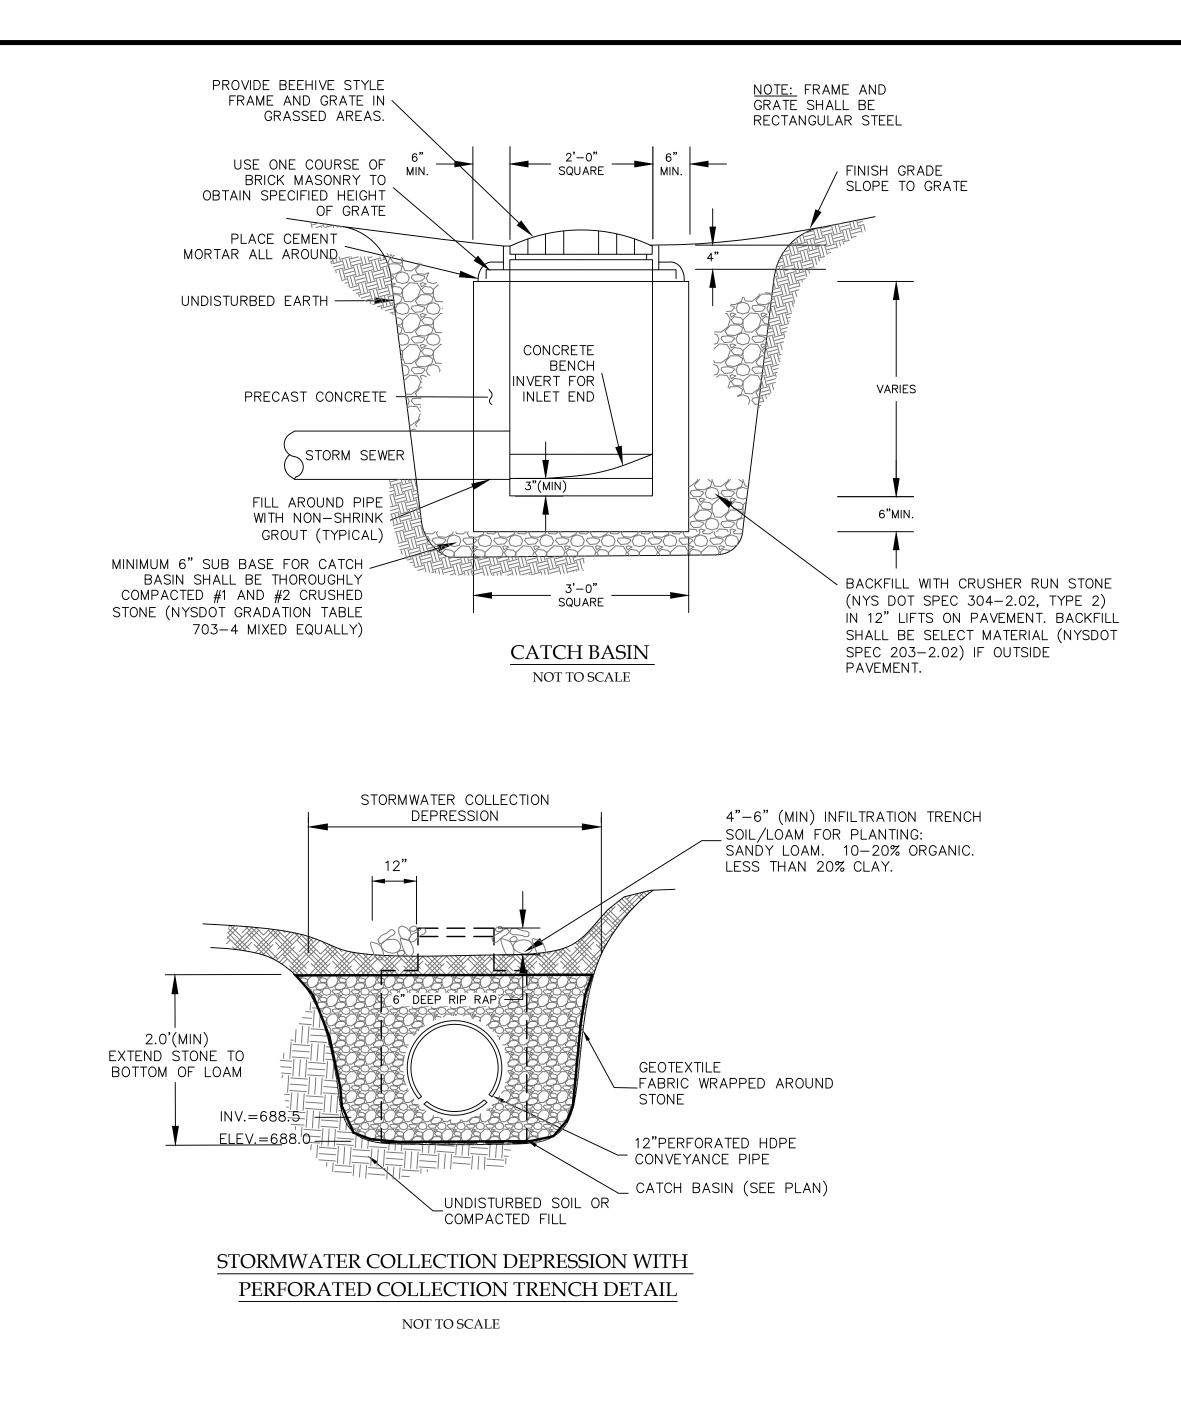

fessional Engineer]	Revisions	3		NYS Land Surveyor	Drawing Title:	
ATEOFNEWL	NO.	Date	Description	By			3
C C C C C C C C C C C C C C C C C C C						Site Plan Prepared For:	CANANE
Addin							
POFESSION ALENS							Co
3.1-					Rocco A. Venezia, P.L.S. License # 049761	www.veneziasurvey.co	/

