
# ONE STAGE(PRELIMINARY/FINAL) SITE PLAN SET FOR THE VIOLAS FAMILY TRUST 3320 FALLBROOK PARK TOWN OF CANANDAIGUA

ONTARIO COUNTY -- STATE OF NEW YORK



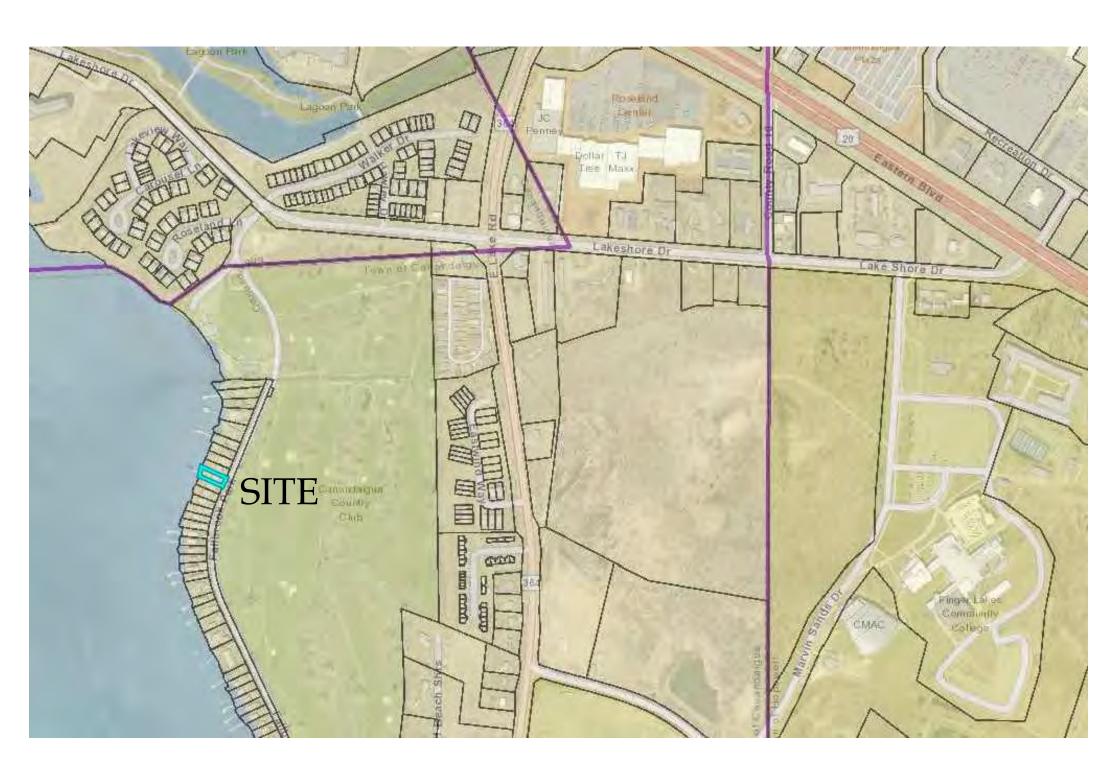

AERIAL LOCUS NOT TO SCALE

## GENERAL NOTES

1. PROPERTY LINE INFORMATION SHOWN ON THIS PLAN IS BASED ON AVAILABLE RECORD

2. UTILITIES SHOWN ON THIS PLAN ARE APPROXIMATE. ACTUAL LOCATION SHALL BE FIELD VERIFIED PRIOR TO CONSTRUCTION. THE CONTRACTOR SHALL PROTECT AND MAINTAIN ALL EXISTING UTILITY SERVICES THROUGHOUT CONSTRUCTION. CONTACT U.F.P.O. AT 1-800-962-7962 AT LEAST 72 HOURS

ZONES, THE LAKE FRONTAGE IS LOCATED IN ZONE AE, PER C.P. #3605980020C MAP REVISED MARCH

4. NO CHANGES ARE TO BE MADE TO THIS DESIGN WITHOUT PRIOR APPROVAL OF THE DESIGN

5. ALL IMPROVEMENTS SHALL BE IN ACCORDANCE WITH THE MOST RECENT STANDARDS AND SPECIFICATIONS OF THE TOWN OF CANANDAIGUA AND THE APPROPRIATE WATER/SEWER AGENCIES, UNLESS OTHERWISE NOTED.

6. THE CONTRACTOR SHALL LOCATE, MARK, SAFEGUARD AND PRESERVE ALL SURVEY CONTROL MONUMENTS AND RIGHT-OF-WAY MONUMENTS IN THE AREAS OF CONSTRUCTION.

- 7. PROPOSED LIGHTING SHALL BE DARK SKY COMPLIANT (PER CHAPTER 220, SECTION 77).
- 8. ELEVATIONS REFERENCE NAVD88 DATUM.

## SHEET INDEX:

- **COVER SHEET** 
  - EXISTING CONDITIONS PLAN
- SITE PREPARATION & EROSION CONTROL PLAN
- SITE LAYOUT AND UTILITY PLAN
- SITE AND UTILITY DETAILS

## **ZONING CHART**

TOWN OF CANANDAIGUA ZONING DISTRICT: RESIDENTIAL LAKE DISTRICT (RLD)

ONING DISTRICT: RESIDEN		,	
	REQUIRED	EXISTING	PROVIDED
MIN LOT AREA (AREA TO ROW)	20,000 SF	6,945 SF*	6,945 SF*
MIN LOT WIDTH	125'	50'*	50'*
MIN FRONT YARD SETBACK	50'	14.3'*	16.7'**
MIN SIDE YARD SETBACK	8'	6.6'*	9.5'
MIN REAR YARD SETBACK	30'	53.2'	44.85'
MAX BUILDING HEIGHT	25 FT	<25 FT	25.0 FT
MAX BUILDING COVERAGE	25%	25.8%*	29.1%***
MAX LOT COVERAGE	40%	47.4%*	45.9%**
SITE DISTURBANCE		6,560 SF	•

#### PRE-EXISTING NON-CONFORMING \*\* CLOSER TO CONFORMING THAN EXISTING, NON-CONFORMING, VARIANCE REQUIRED

Lot Coverage Calculati	ons: Sa Ft	Proposed Lot Coverage Calculations:	Sa
House		House	
Garage	•	Front Porch	
Asphalt Driveway		Porous Asphalt Driveway	
Paver Patio		Rear Paver/Walk	
Concrete Walk	·	Sidewalk	
Break Wall		Break Wall	85

Total Coverage	3,289.0
Total Site Area	
Building Coverage	25.8%
Total Lot Coverage	

Total Coverage	3,189
Total Site Area	6,945
Building Coverage	29.1%
Total Lot Coverage	45.9%
Lot Coverage Excluding Porous Dri	

## ONE STAGE SITE PLAN APPROVAL

PLANNING BOARD CHAIRPERSON DATE TOWN WATER SUPERINTENDENT DATE TOWN ENGINEER DATE

NO BUILDING PERMIT MAY BE ISSUED UNTIL FINAL SITE PLAN APPROVAL HAS BEEN GRANTED AND THE FINAL SITE PLAN SIGNED BY THE PLANNING BOARD CHAIRPERSON.

File# 19024

FOR PERMITTING ONLY



**–** 5120 Laura Lane **– – – –** 

PER SECTION 7209 OF ARTICLE 145 OF THE NEW YORK STATE EDUCATION LAW IT IS A VIOLATION FOR ANY PERSON TO ALTER ANY DOCUMENT THAT BEARS THE SEAL OF A PROFESSIONAL ENGINEER, UNLESS THE PERSON SEAL OF AN ENGINEER IS ALTERED, THE ALTERING ENGINEER SHALL AFFIX TO THE DOCUMENT THEIR SEAL AND



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Site Plan Drawings Prepared For:

## Violas Family Trust


3320 Fallbrook Park Town of Canandaigua County of Ontario State of New York

Scale: NTS T.m. # 98.11-1-10.00 Date: 06/21/19 Sheet:

— Canandaigua New York, 14424

www.veneziasurvey.com (585)396-3267 Fax. No. (585) 396-0131

E-mail erin@veneziasurvey.com

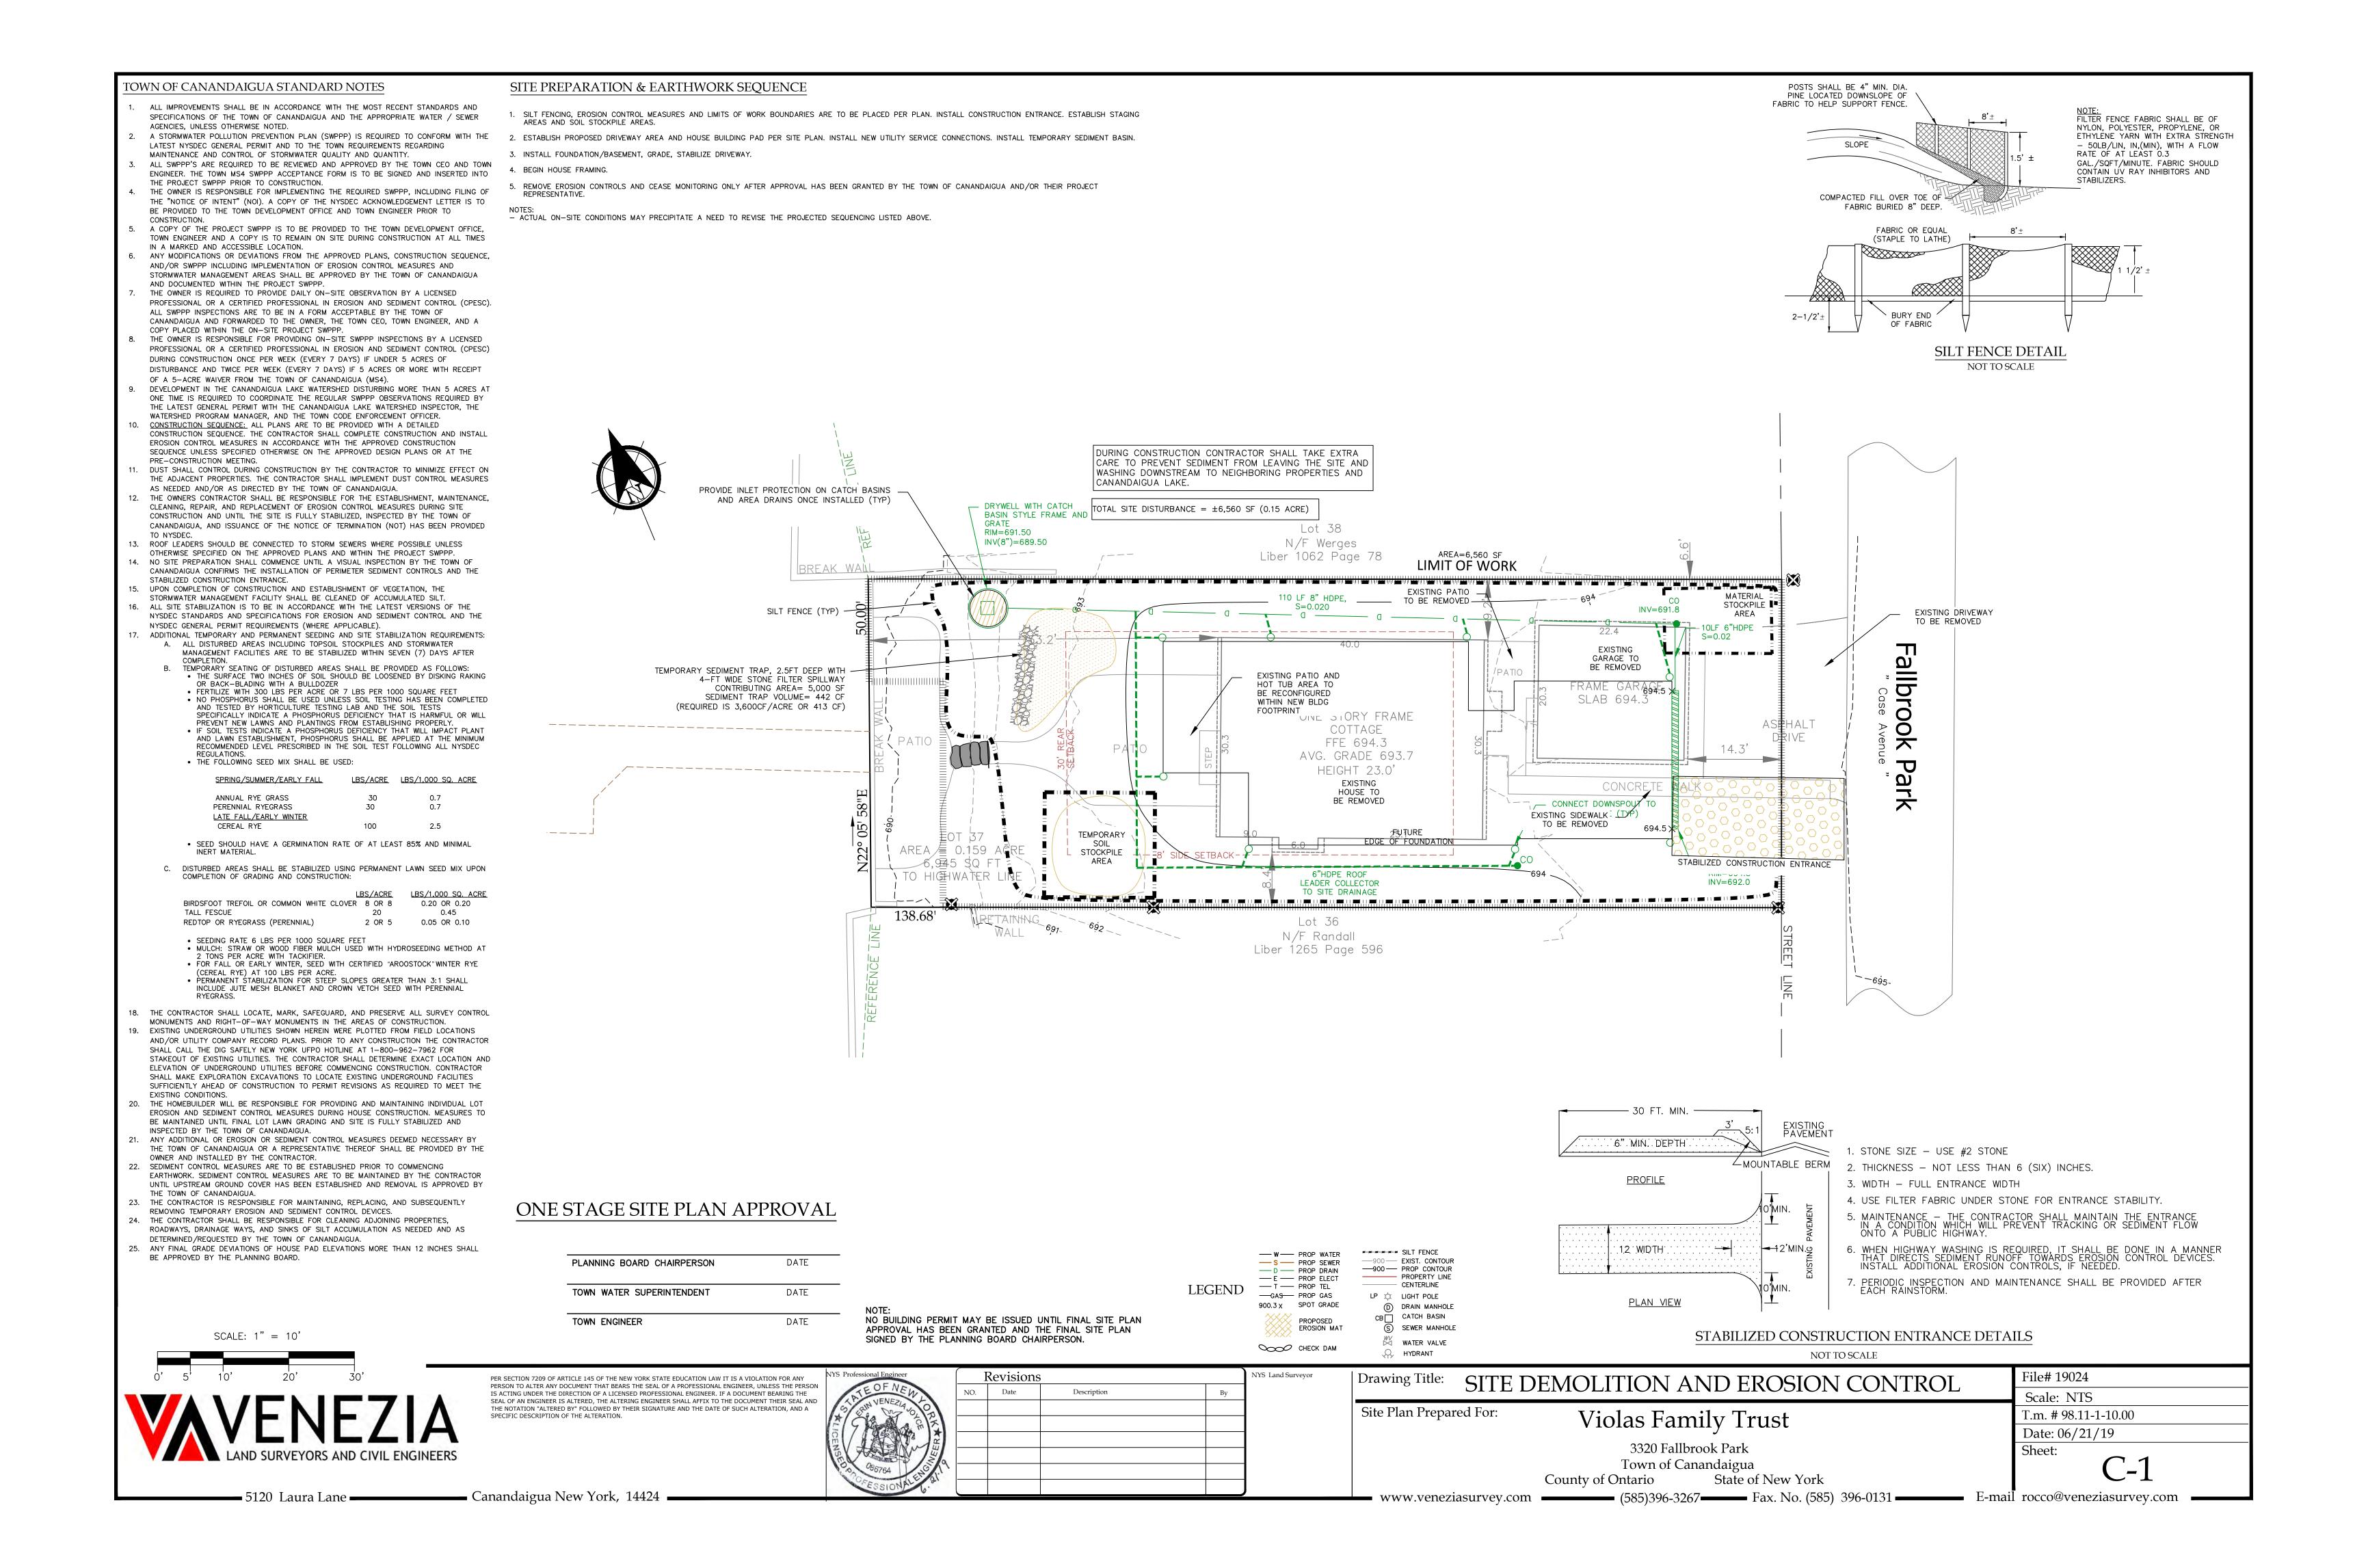

#### WATER SYSTEM NOTES

1. WATERMAINS AND APPURTENANCES SHALL BE CONSTRUCTED IN COMPLIANCE WITH THE MOST RECENT STANDARDS AND SPECIFICATIONS OF THE TOWN OF CANANDAIGUA AND NEW YORK STATE DEPARTMENT OF HEALTH.

2. PROVIDE 10' MINIMUM SEPARATION BETWEEN THE WATERMAIN AND SEWER MAINS. VERTICAL SEPARATION BETWEEN WATERMAINS SHALL BE MAINTAINED IN ACCORDANCE WITH THE WATERMAIN/SEWER CROSSING DETAIL. WHERE A WATERMAIN CROSSES UNDER A SEWER, ADEQUATE STRUCTURAL SUPPORT (COMPACT SELECT FILL) SHALL BE PROVIDED FOR THE SEWERS TO PREVENT EXCESSIVE DEFLECTION OF JOINTS AND SETTLING AND POSSIBLY BREAKING THE WATERMAINS.

3. WATERMAIN SHALL BE PVC PIPE, AWWA C-900 AND SHALL HAVE A MINIMUM OF 5-FEET OF COVER FROM FINISHED GRADE.

4. THE WATERMAIN SHALL BE FLUSHED PRIOR TO TESTING AND DISINFECTION WITH A MINIMUM FLUSHING VELOCITY OF 2.5 FEET PER SECOND.

5. THE WATERMAIN, INCLUDING FITTINGS AND VALVES, SHALL COMPLY WITH AWWA C-600 SECTION 2 SPECIFICATIONS AND SHALL BE PRESSURE AND LEAKAGE TESTED IN ACCORDANCE WITH AWWA C605

SECTION AND THE LATEST SPECIFICATIONS OF THE NYSDOH.

6. DISINFECTION SHALL BE ACCOMPLISHED AFTER THE PIPE HAS PASSED THE HYDROSTATIC TESTS AND SHALL BE IN CONFORMANCE WITH AWWA C-651, LATEST REVISION, BY USING THE CONTINUOUS FEED METHOD. FOLLOWING FLUSHING, SAMPLES OF THE WATER SHALL BE COLLECTED FROM THE MAIN. FIRE HYDRANTS ARE NOT ACCEPTABLE SAMPLING POINTS. WATER SAMPLE COLLECTION SHALL BE THE RESPONSIBILITY OF THE CONTRACTOR AND ANALYSIS OF THE SAMPLES SHALL BE PERFORMED BY A NYS DEPARTMENT OF HEALTH APPROVED LABORATORY. THE WATERMAIN SHALL NOT BE PLACED IN SERVICE UNTIL A "COMPLETED WORKS APPROVAL" CERTIFICATE HAS BEEN ISSUED BY THE NYS DEPT.

#### SANITARY LATERAL NOTES:

POSSIBLE FROM THE WATER MAIN JOINTS.

- 1. ALL SANITARY SEWER CONSTRUCTION AND/OR IMPROVEMENTS SHALL BE IN ACCORDANCE WITH THE MOST RECENT STANDARDS AND SPECIFICATIONS OF THE CANANDAIGUA LAKE COUNTY SEWER DISTRICT, N.Y.S. DEPARTMENT OF ENVIRONMENTAL CONSERVATION, N.Y.S. DEPARTMENT OF HEALTH, THE LATEST EDITION OF RECOMMENDED STANDARDS FOR WASTEWATER FACILITIES AND ANY OTHER AGENCIES HAVING JURISDICTION.
- 2. NO SANITARY SEWER-RELATED WORK MAY BE PERFORMED WITHOUT FIRST OBTAINING A WRITTEN PERMIT FORM THE CANANDAIGUA LAKE COUNTY SEWER DISTRICT.
- 3. DISTRICT PERSONNEL SHALL BE NOTIFIED A MINIMUM OF 48 HOURS PRIOR TO BEGINNING ANY SANITARY SEWER-RELATED WORK.
- 4. THE CONTRACTOR SHALL LOCATE, MARK AND PRESERVE ANY RIGHT OF WAY MONUMENTS OR SURVEY CONTROL IN THE AREA OF CONSTRUCTION. UTILITY LOCATIONS SHOWN ARE APPROXIMATE ONLY. THE CONTRACTOR SHALL DETERMINE THE EXACT LOCATION OF UTILITIES, EXCAVATING TO EXPOSE THE UTILITY, IF
- NECESSARY IN THE AREA OF CONSTRUCTION, BEFORE COMMENCING CONSTRUCTION. CONTACT U.F.P.O AT 1-800-962-7962 AT LEAST 72 HOURS PRIOR TO
- 6. LATERALS SHALL BE A MIN. 4" DIA. SDR-21 WITH ELASTOMERIC JOINTS; FOR COMMERCIAL ESTABLISHMENTS, LATERALS ARE TO BE 6" DIA. SDR-21. MINIMUM DEPTH OF BURIAL IS FOUR FEET. CLEANOUTS SHALL BE INSTALLED WITHIN 30 INCHES OF THE OUTSIDE FACE OF BUILDINGS, AT ALL CHANGES IN HORIZONTAL ALIGNMENT, AT THE RIGHT OF WAY OR EASEMENT LINE, AND AT SPACING NOT TO EXCEED 90 FEET.

SEPARATION SHALL BE 18" (MEASURED OUT-TO-OUT). THE CROSSING SHALL BE ARRANGED SO THAT THE SEWER JOINTS WILL BE EQUIDISTANT AND AS FAR AS


- 7. SANITARY SEWER MAINS AND LATERALS SHALL BE LOCATED A MINIMUM HORIZONTAL DISTANCE OF 10' FROM ANY EXISTING OR PROPOSED WATER MAIN (AS MEASURED FROM THE OUTSIDE OF THE SEWER TO THE OUTSIDE OF THE WATER MAIN). IN CASES WHERE THE SANITARY SEWER CROSSES A WATER MAIN, THE MINIMUM VERTICAL
- 8. THE CONTRACTOR SHALL PROVIDE THE DISTRICT WITH SHOP DRAWINGS AND MATERIAL SPECIFICATIONS THAT HAVE BEEN PRE-APPROVED BY THE DESIGN ENGINEER BEFORE A PERMIT WILL BE ISSUED.
- 9. THE CONTRACTOR IS RESPONSIBLE FOR COMPLIANCE WITH OSHA REQUIREMENTS IN ALL ASPECTS OF CONSTRUCTION.
- 10. THE CONTRACTOR SHALL BE RESPONSIBLE FOR MAINTAINING SANITARY FLOWS AT ALL TIMES BY METHODS ACCEPTABLE TO THE DEVELOPER'S ENGINEER AND THE
- 11. FLOOR DRAINS IN THE BASEMENT OR GARAGE ARE TO BE CONNECTED TO THE SANITARY SEWER. FLOOR DRAINS DO NOT INCLUDE FOUNDATION OR FOOTER DRAINS INSTALLED TO INTERCEPT UNCONTAMINATED GROUND WATER. ALL DISCHARGES TO THE SANITARY SEWER MUST COMPLY WITH EFFLUENT LIMITS OF THE ONTARIO COUNTY SEWER USE LAW. FOUNDATION AND FOOTER DRAINS SHALL BE CONSTRUCTED IN A MANNER THAT WILL PROHIBIT GROUNDWATER FROM DRAINING INTO THE SANITARY SEWER PIPE CRADLE.

- 12. LATERAL CONNECTIONS REQUIRING OPENINGS IN ASBESTOS CEMENT PIPE WILL BE DESIGNED, INSPECTED AND CERTIFIED BY THE DESIGN ENGINEER OR REPRESENTATIVE
- 13. ANY EXCAVATION NOT BACKFILLED BY THE END OF THE WORKDAY SHALL BE FENCED, BARRICADED AND LIGHTED FOR SAFETY AND PROTECTION OF THE PUBLIC.
- 14. THE CONTRACTOR SHALL BE RESPONSIBLE FOR THE REMOVAL OF EXISTING SANITARY MAINS, STRUCTURES AND APPURTENANCES, IF ANY, NEEDED TO COMPLETE THE


#### RENOVATION PROJECTS ONLY

ACCORDANCE WITH DISTRICT REQUIREMENTS.

- 15. EXISTING LATERALS TO BE DISCONNECTED MUST BE PERMANENTLY PLUGGED OR CAPPED AT THE EASEMENT OR RIGHT OF WAY LINE UNDER THE DIRECTION OF THE CANANDAIGUA LAKE COUNTY SEWER DISTRICT SUPERVISOR. THE CONTRACTOR IS REQUIRED TO OBTAIN A PERMIT PRIOR TO PERFORMING THE WORK. THE LOCATION OF THE PLUG OR CAP SHALL BE RECORDED FOR AS-BUILT DRAWING PURPOSES.
- 16. PRIOR TO DEMOLISHING AN EXISTING BUILDING, THE CONTRACTOR SHALL EXCAVATE, DISCONNECT AND ABANDON THE LATERAL FROM THE BUILDING TO THE POINT OF DISCONNECTION (APPROXIMATELY 30' FROM THE EXISTING BUILDING) PER DISTRICT STANDARDS. A TEMPORARY PLUG SHALL BE INSTALLED IN THE REMAINING PORTION OF THE EXISTING SANITARY LATERAL UNTIL IT IS TESTED AND TELÉVISED.
- 17. IN ORDER TO DETERMINE WHETHER AN EXISTING SANITARY LATERAL IS ACCEPTABLE FOR CONNECTION TO A NEW BUILDING, THE LATERAL SHALL BE TELEVISED IN THE PRESENCE OF DISTRICT PERSONNEL AT THE OWNER'S EXPENSE.
- 18. IF AN EXISTING LATERAL IS FOUND TO BE ACCEPTABLE AND MEET THE MINIMUM DISTRICT REQUIREMENTS, IT SHALL BE TEMPORARILY RE-PLUGGED AND BACKFILLED WITH A WITNESS STAKE IN PLACE, UNTIL CONNECTION TO THE NEW BUILDING CAN TAKE PLACE.
- 19. IF A NEW SANITARY LATERAL IS REQUIRED, THE EXISTING LATERAL MUST BE EXCAVATED, REMOVED, AND CAPPED AT THE EASEMENT RIGHT OF WAY LINE IN
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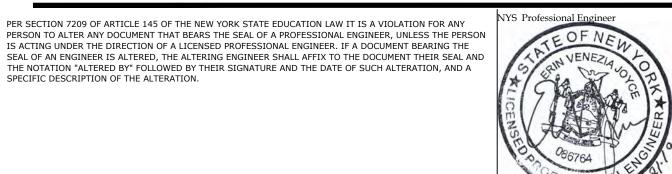

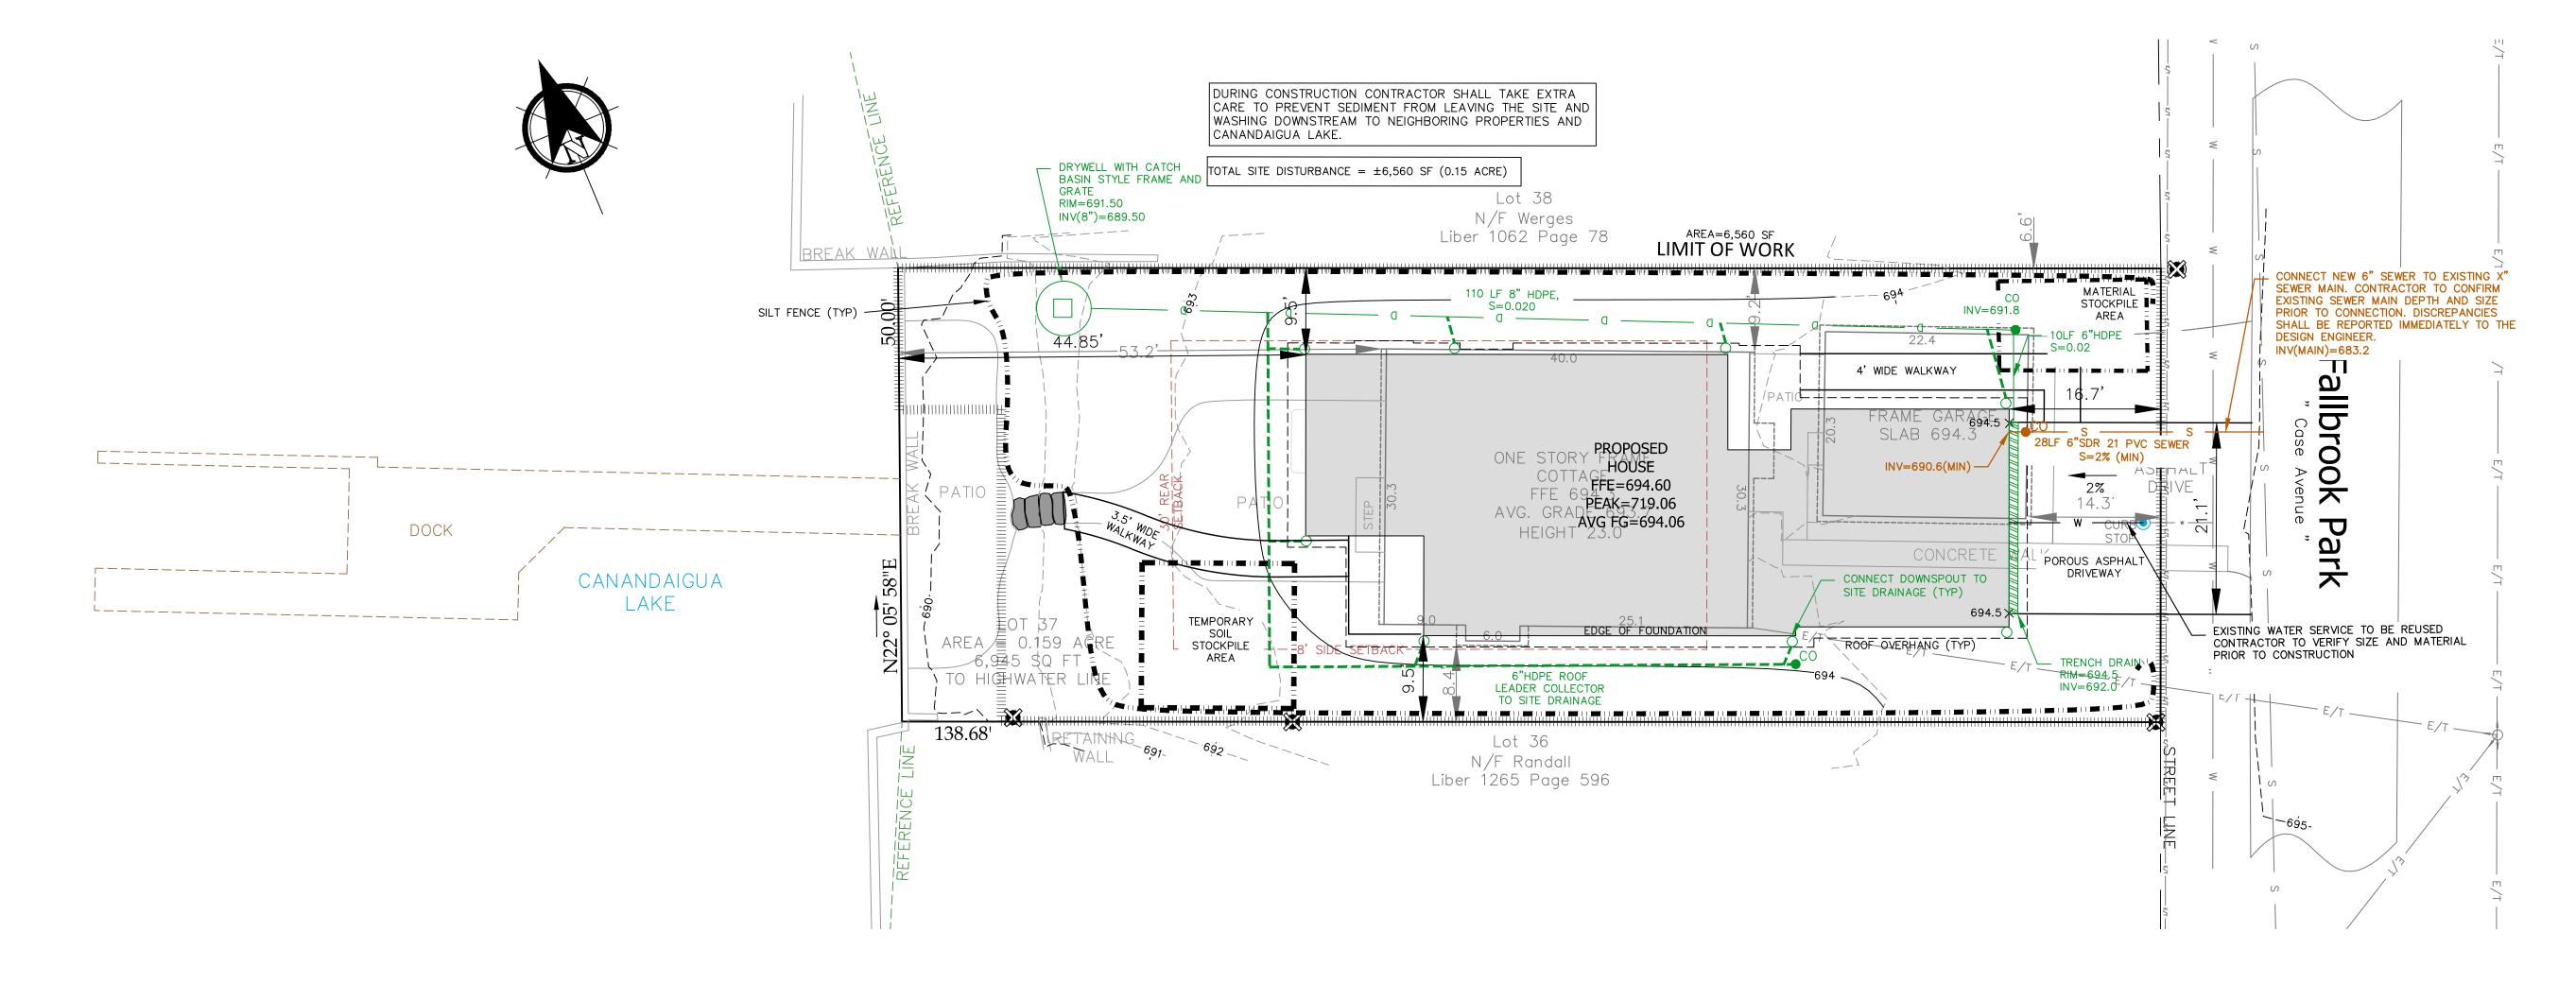
## ONE STAGE SITE PLAN APPROVAL

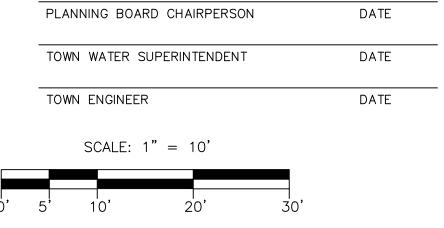

**—** 5120 Laura Lane **———** 

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- E - PROP ELECT — T — PROP TEL

—GAS— PROP GAS

CHECK DAM

PROPOSED

EROSION MAT

LP 🌣 LIGHT POLE D DRAIN MANHOLE CB CATCH BASIN

SEWER MANHOLE

WATER VALVE

HYDRANT

NYS Land Surveyor Revisions Date Description

Drawing Title: Site Plan Prepared For:

SITE GRADING AND UTILITY PLAN

Violas Family Trust 3320 Fallbrook Park Town of Canandaigua

Sheet:

— Canandaigua New York, 14424

SPECIFIC DESCRIPTION OF THE ALTERATION.

County of Ontario State of New York **—** www.veneziasurvey.com **————** (585)396-3267**———** Fax. No. (585) 396-0131 **———** E-mail rocco@veneziasurvey.com


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### SANITARY LATERAL NOTES:


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#### RENOVATION PROJECTS ONLY

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MINIMUM ASPHALT REPLACEMENT:

SEE PAVEMENT CROSS SECTION DETAILS

MINIMUM ASHPALT REPLACEMENT FOR

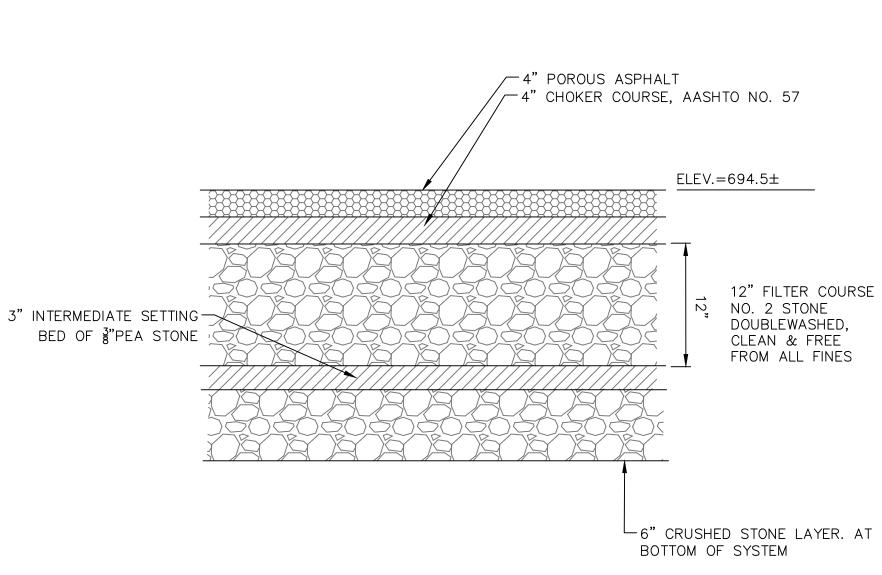DRIVEWAYS AND PARKING AREAS: 1" TOP (NYSDOT 402.098103)

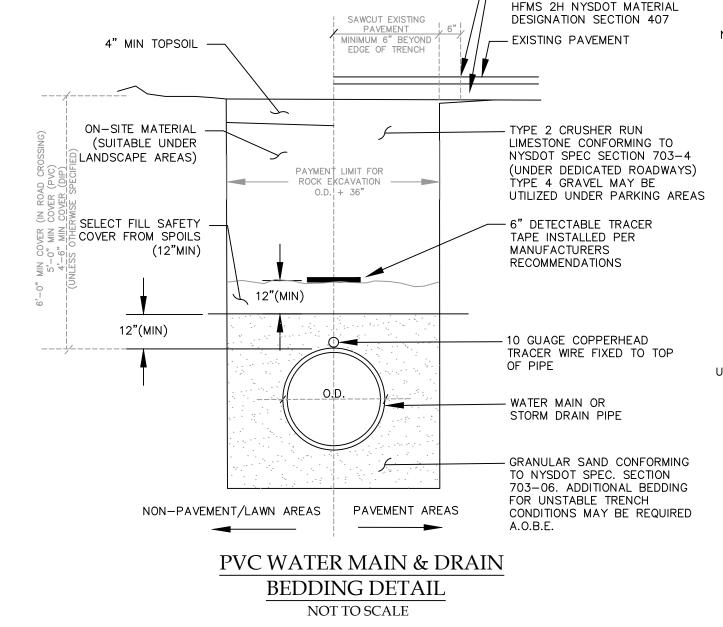2" BINDER (NYSDOT 402.258903)

(PAVEMENT THICKNESS TO MATCH EXISTING)

— SAWCUT EXISTING

- TACK COAT ON EXISTING

ASPHALT SURFACE GRADE

PAVEMENT

PLACED & COMPACTED IN LIFTS -- PLACED & COMPACTED IN LIFTS NO GREATER THAN 6" TO SAFETY NOT TO EXCEED 6", REMAINING DEPTH OF TRENCH. FINISHED GRADE — SEWER SAFETY WARNING TAPE SHALL BE INSTALLED DIRECTLY ON SAFETY COVER CENTERED ABOVE PIPE, TRACER WIRE OR DETECTABLE WARNING TAPE IS CRÜSHËD REQUIRED OVER FORCEMAIN. STONE BEDDING INSTALL PER MANUFACTURER'S PER NYSDOT INSTRUCTIONS. SPECIFICATION 703-02, HAND TAMPED TO SPRING LINE. √6" MIN- UNDISTURBED EARTH UNDISTURBED EARTH ~ \_4" MIN. — ROCK #3 CRUSHED STONE FOUNDATION FOR UNSTABLE SOIL CONDITIONS OR OVER-EXCAVATION, DEPTH AS REQUIRED. MAX. TRENCH WIDTH . MINIMUM DEPTH OF COVER FOR PIPE OD + 3' SEWER MAINS AND LATERALS IS 4 2. MINIMUM PIPE DIAMETER REQUIRED FOR DEDICATION IS 8". SANITARY SEWER MAIN & LATERAL TRENCH BEDDING

PAVEMENT AREAS

SELECT GRANULAR FILL PER

NYSDOT SPECIFICATION 203-2.02.

NON-PAVEMENT/LAWN AREAS

SUITABLE EXCAVATED MATERIAL

(NO STONES LARGER THAN 6"),

DETAIL NOT TO SCALE

CLEANOUTS LOCATED IN

CONSIDERED UNDESIRABLE,

AND SHOULD BE AVOIDED


COUNTERSUNK PLUG FLUSH WITH

WHENEVER POSSIBLE. IN UNPAVED AREAS USE


PAVED AREAS ARE

SYRACUSE CASTING #4155 OR

EQUAL FRAME & COVER INSTALLED

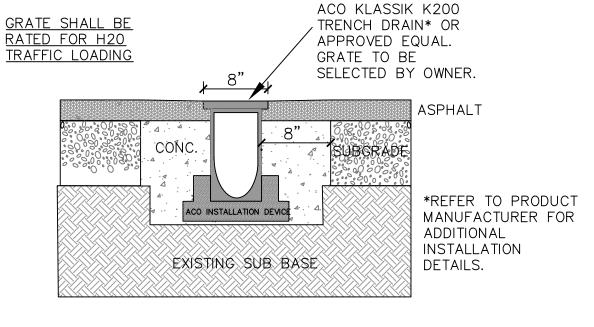

TRENCH DRAIN DETAIL NOT TO SCALE

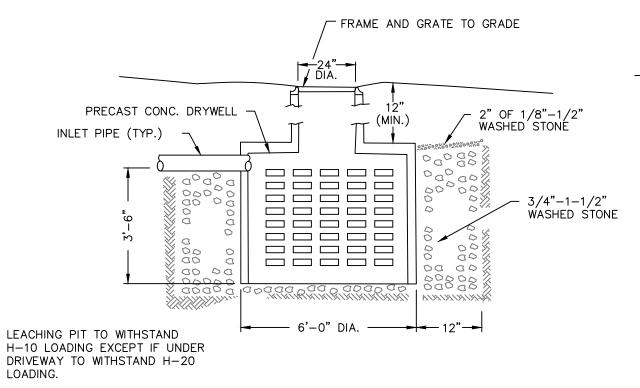



DRY WELL DETAIL

NOT TO SCALE

NEW LATERAL CONNECTION TO EXISTING SEWER MAIN NOT TO SCALE

www.veneziasurvey.com

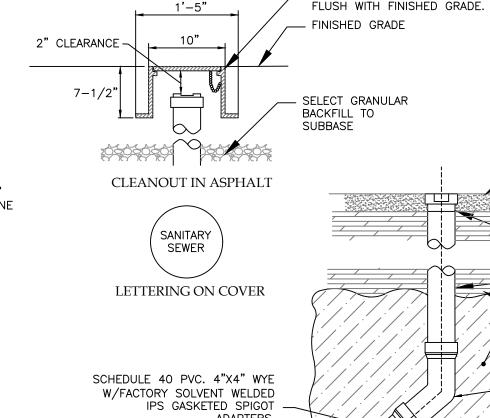

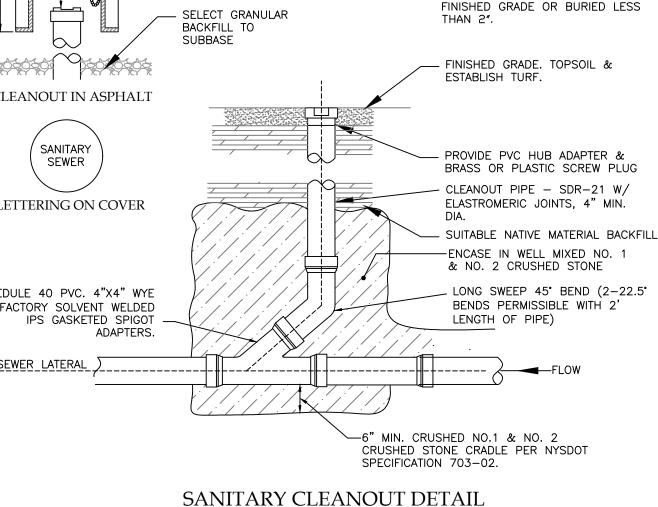

NOT TO SCALE

—— (585)396-3267——— Fax. No. (585) 396-0131 ———— E-mail rocco@veneziasurvey.com

PLANNING BOARD CHAIRPERSON	DATE
TOWN WATER SUPERINTENDENT	DATE
TOWN ENGINEER	DATE
NOTF:	

NO BUILDING PERMIT MAY BE ISSUED UNTIL FINAL SITE PLAN APPROVAL HAS BEEN GRANTED AND THE FINAL SITE PLAN SIGNED BY THE PLANNING BOARD CHAIRPERSON.

File# 19024

Scale: NTS

ONE STAGE SITE PLAN APPROVAL

FOR PERMITTING ONLY



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NYS Land Surveyor Drawing Title: Site Plan Prepared For:

Rocco A. Venezia, P.L.S.

INSERTA TEE LATERAL SERVICE CONNECTION ASSEMBLY WITH -

SDR-21 PVC BELL HUB

RUBBER SLEEVE

SITE AND UTILITY DETAILS Violas Family Trust

SDR-21 45° BEND

- SDR-21 PVC BELL HUB

STAINLESS STEEL STRAP

EXISTING SEWER MAIN

(8" AC PIPE)

- SDR-21 LATERAL

(GASKET/SPIGOT)

3320 Fallbrook Park Town of Canandaigua State of New York County of Ontario

T.m. # 98.11-1-10.00 Date: 06/21/19 Sheet: C-3