
# ONE STAGE(PRELIMINARY/FINAL) SITE PLAN SET FOR THE LUPTON FAMILY

## 3459 LAKEVIEW LANE

## TOWN OF CANANDAIGUA ONTARIO COUNTY -- STATE OF NEW YORK



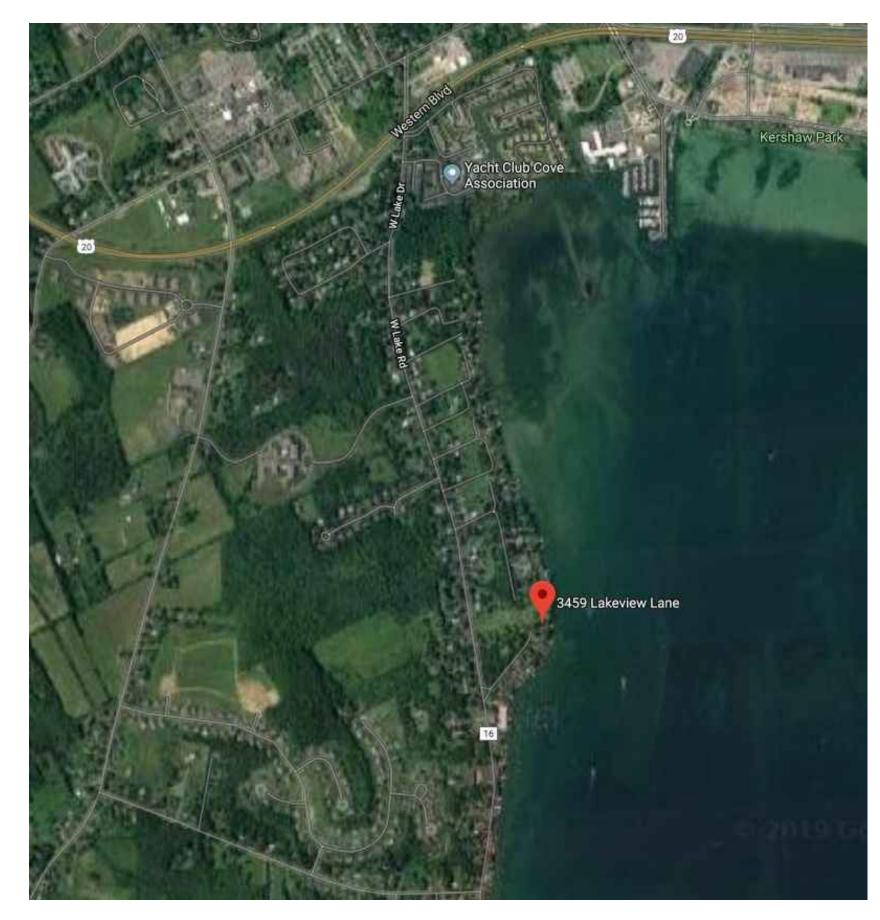

AERIAL LOCUS NOT TO SCALE

### GENERAL NOTES

1. PROPERTY LINE INFORMATION SHOWN ON THIS PLAN IS BASED ON AVAILABLE RECORD

TILITIES SHOWN ON THIS PLAN ARE APPROXIMATE. ACTUAL LOCATION SHALL BE FIELD VERIFIED PRIOR TO CONSTRUCTION. THE CONTRACTOR SHALL PROTECT AND MAINTAIN ALL EXISTING UTILITY SERVICES THROUGHOUT CONSTRUCTION. CONTACT U.F.P.O. AT 1-800-962-7962 AT LEAST 72 HOURS

3. THIS UPLAND PORTION OF THE SITE DOES NOT FALL WITHIN ANY FEMA SPECIAL FLOOD HAZARD ZONES, THE LAKE FRONTAGE IS LOCATED IN ZONE AE, PER C.P. #3605980020C MAP REVISED MARCH

4. NO CHANGES ARE TO BE MADE TO THIS DESIGN WITHOUT PRIOR APPROVAL OF THE DESIGN

5. ALL IMPROVEMENTS SHALL BE IN ACCORDANCE WITH THE MOST RECENT STANDARDS AND SPECIFICATIONS OF THE TOWN OF CANANDAIGUA AND THE APPROPRIATE WATER/SEWER AGENCIES,

6. THE CONTRACTOR SHALL LOCATE, MARK, SAFEGUARD AND PRESERVE ALL SURVEY CONTROL MONUMENTS AND RIGHT-OF-WAY MONUMENTS IN THE AREAS OF CONSTRUCTION. 7. PROPOSED LIGHTING TO BE COORDINATED WITH THE LANDSCAPE ARCHITECT AND OWNER. LIGHTING SHALL BE DARK SKY COMPLIANT (PER CHAPTER 220, SECTION 77).

8. ELEVATIONS REFERENCE NAVD88 DATUM.

## SHEET INDEX:

**COVER SHEET** 

EXISTING CONDITIONS PLAN

SITE PREPARATION & EROSION CONTROL PLAN

SITE LAYOUT AND UTILITY PLAN SITE AND UTILITY DETAILS

LANDSCAPE PLAN

#### **ZONING CHART**

TOWN OF CANANDAIGUA

ZONING DISTRICT: RESIDENTIAL LAKE DISTRICT (RLD)

	(***	/		
	REQUIRED	EXISTING	PROVIDED	
MIN LOT AREA (AREA TO ROW)	20,000 SF	20,647 SF	20,647 SF	
MIN LOT WIDTH	125'	112'*	112'*	
MIN FRONT YARD SETBACK	60'	74.35'	34.15'	VARIANCE REQUESTED GRANTED 2/18/2020
MIN SIDE YARD SETBACK	12'	19.2'	12.00'	
MIN REAR YARD SETBACK	60'	36.14'	40.41'	VARIANCE REQUESTED GRANTED 2/18/2020
MAX BUILDING HEIGHT	25 FT	<25 FT	24.85 FT	
MAX BUILDING COVERAGE	15%	9.1%	20.8% -	VARIANCE REQUESTED GRANTED 2/18/2020
MAX LOT COVERAGE	25%	16.8%	29.9% -	VARIANCE REQUESTED GRANTED 2/18/2020
SITE DISTURBANCE		19,250 SF		
* PRF_FXISTING NON_	CONFORMING			_

\* PRE-EXISTING NON-CONFORMING

Building Coverage......

Total Lot Coverage......

Proposed Lot Coverage Calculations: Sq.F Asphalt Driveway. Asphalt Driveway... Lake Walls... Lake Walls. Site Walls/Steps..... Walkway.. Patio/Hot Tub/Wall...... 492 Building Coverage...... 1,870 Total Coverage... Building Coverage...... 4,302 Total Site Area..... 20,647 Total Coverage......

....16.8%

### ONE STAGE SITE PLAN APPROVAL

PLANNING BOARD CHAIRPERSON DATE

Total Site Area......

Building Coverage.....

Total Lot Coverage.....

.....20.8%

TOWN HIGHWAY & WATER SUPERINTENDENT

TOWN ENGINEER

NO BUILDING PERMIT MAY BE ISSUED UNTIL FINAL SITE PLAN APPROVAL HAS BEEN GRANTED AND THE FINAL SITE PLAN SIGNED BY THE PLANNING BOARD CHAIRPERSON.

File# 19263

Scale: 1"=10'

T.m. # 98.13-1-18.110

FOR PERMITTING ONLY



**–** 5120 Laura Lane **–** 

PER SECTION 7209 OF ARTICLE 145 OF THE NEW YORK STATE EDUCATION LAW IT IS A VIOLATION FOR ANY PERSON TO ALTER ANY DOCUMENT THAT BEARS THE SEAL OF A PROFESSIONAL ENGINEER, UNLESS THE PERSON IS ACTING UNDER THE DIRECTION OF A LICENSED PROFESSIONAL ENGINEER. IF A DOCUMENT BEARING THE SEAL OF AN ENGINEER IS ALTERED, THE ALTERING ENGINEER SHALL AFFIX TO THE DOCUMENT THEIR SEAL AND THE NOTATION "ALTERED BY" FOLLOWED BY THEIR SIGNATURE AND THE DATE OF SUCH ALTERATION, AND A SPECIFIC DESCRIPTION OF THE ALTERATION.



N		Revisions			N
6/2	NO.	Date	Description	Ву	
8 PM	1	1/17/2020	PRC REVIEW	EVJ	
ER.	2	2/06/2020	LANDSCAPE COORDINATION	EVJ	
S S S	3	3/13/2020	TOWN COMMENTS	EVJ	
THE STATE OF					
JAL 31					

Site Plan Drawings Prepared For:

## Al Lupton II

3459 Lakeview Lane Town of Canandaigua State of New York County of Ontario


Date: 01/09/2020 Sheet:


DATE


— Canandaigua New York, 14424


Rocco A. Venezia, P.L.S.

**—** www.veneziasurvey.com ————— (585)396-3267——— Fax. No. (585) 396-0131 ———— E-mail erin@veneziasurvey.com

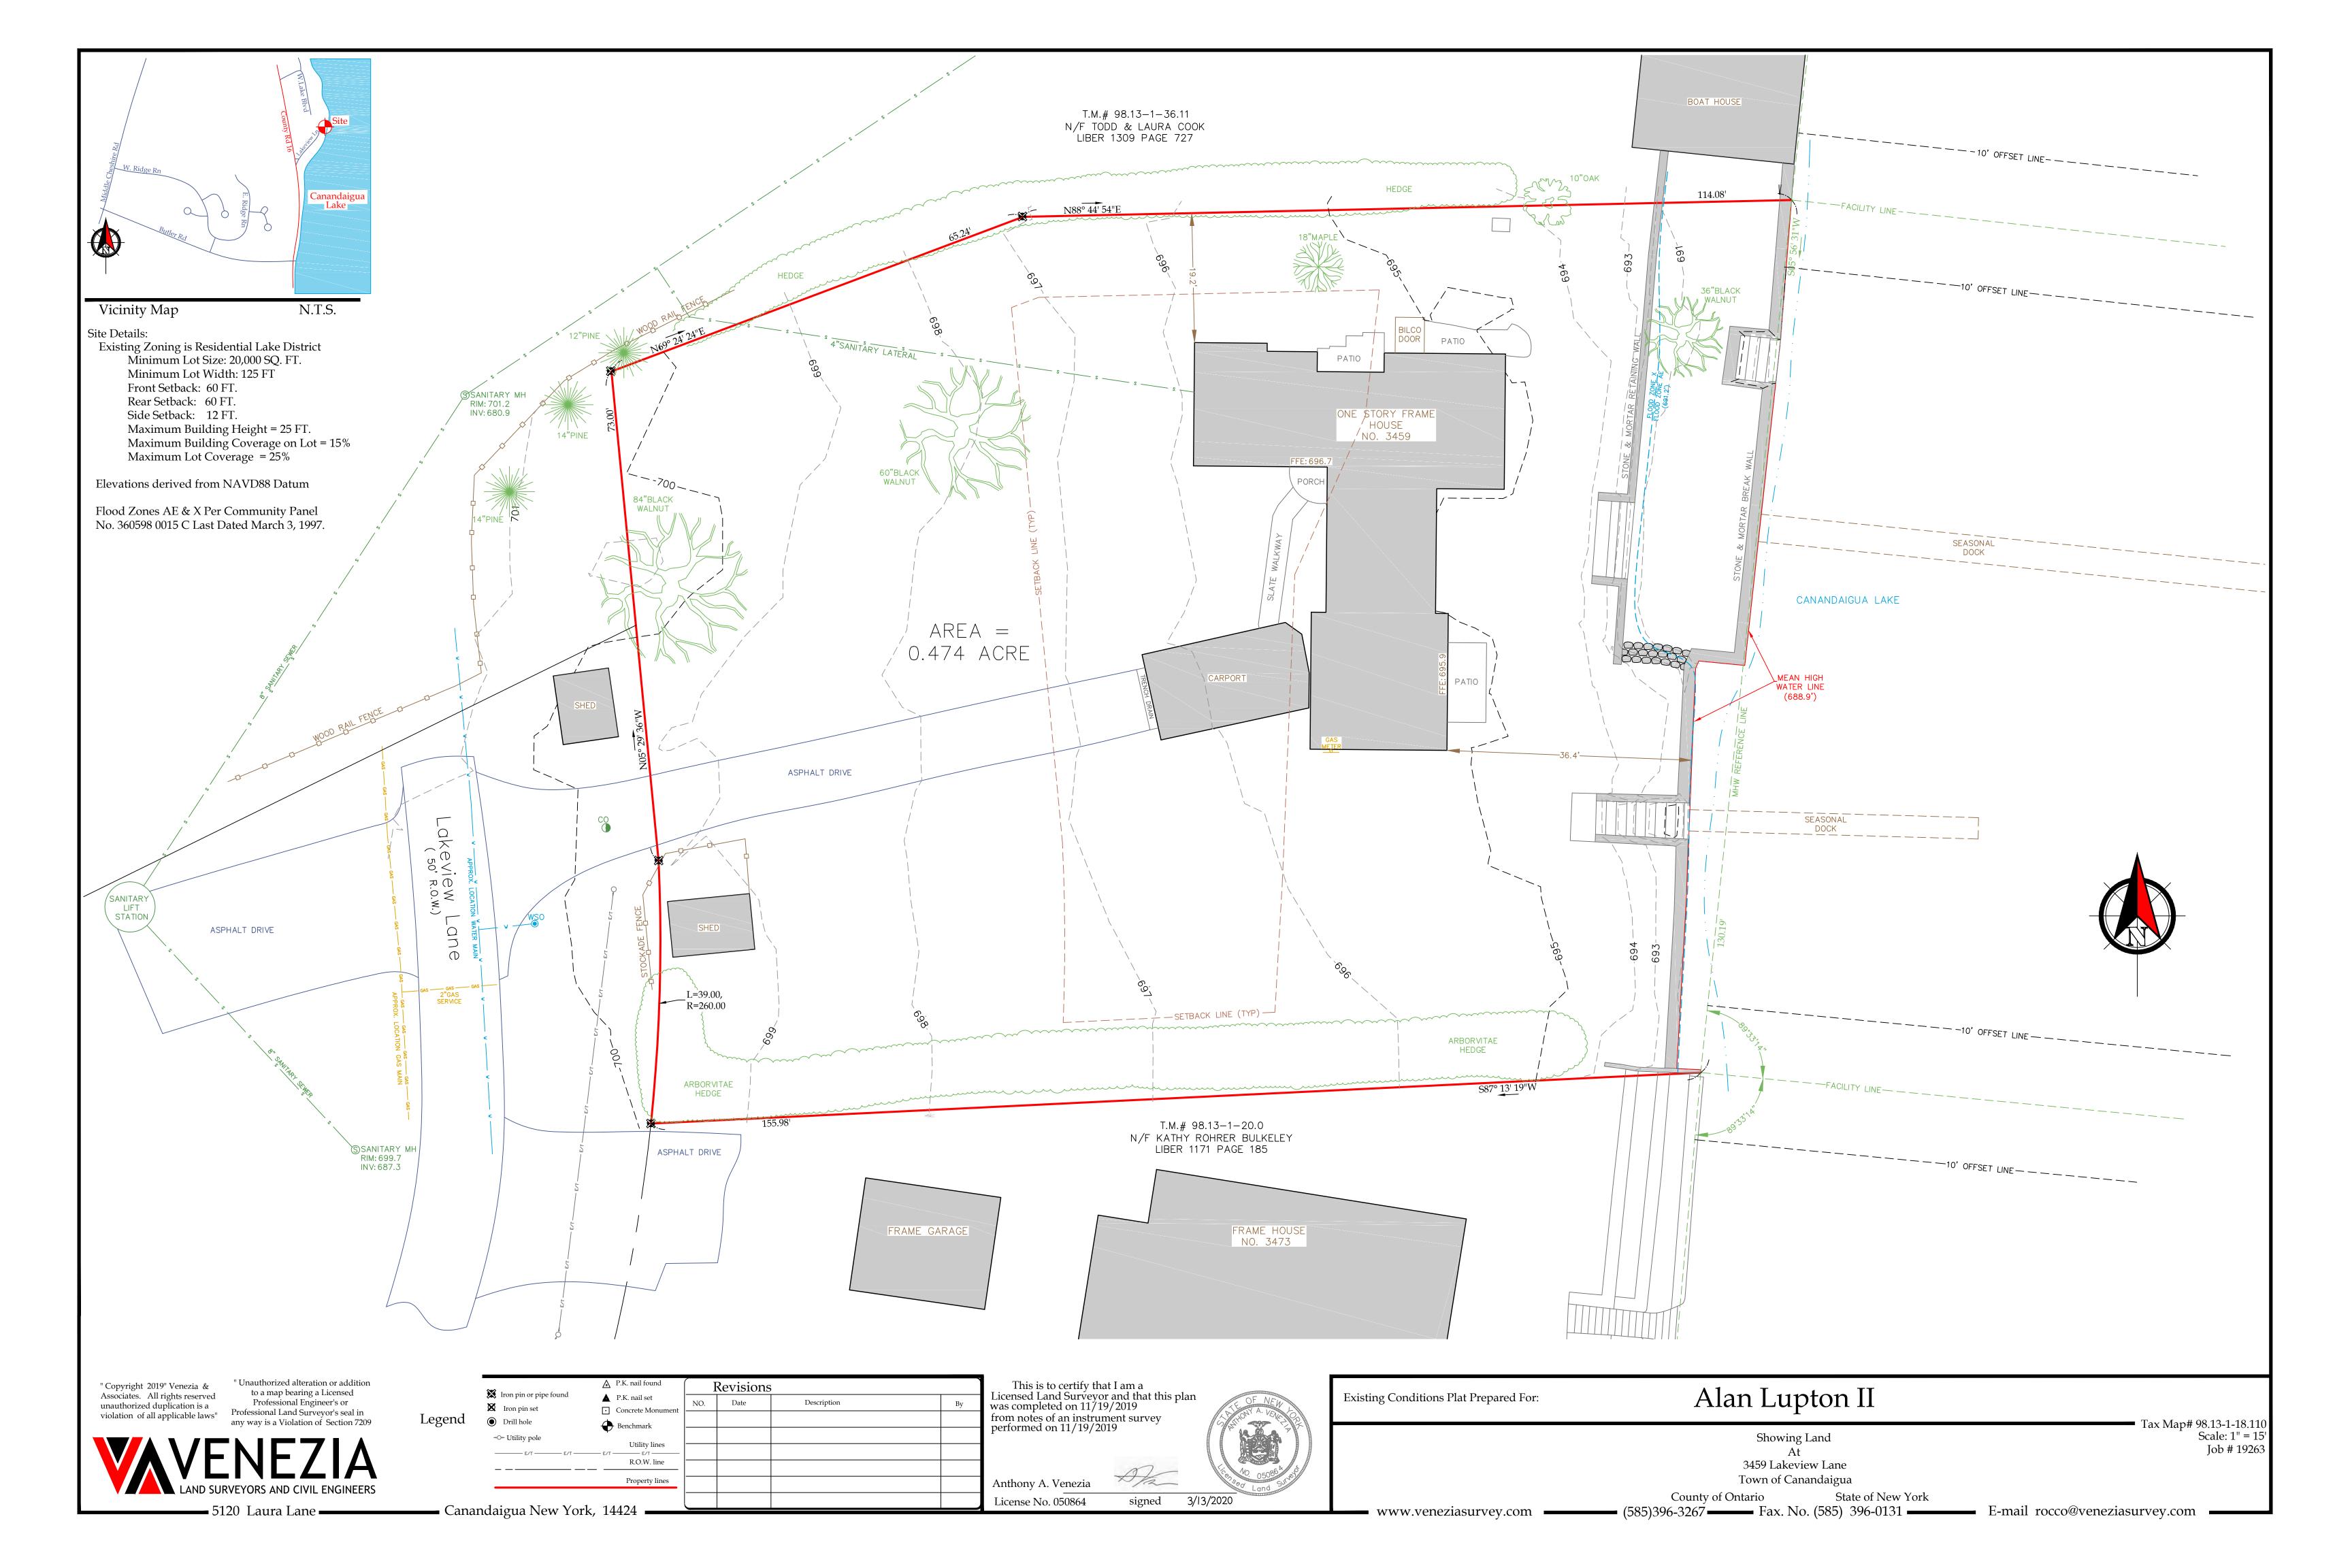

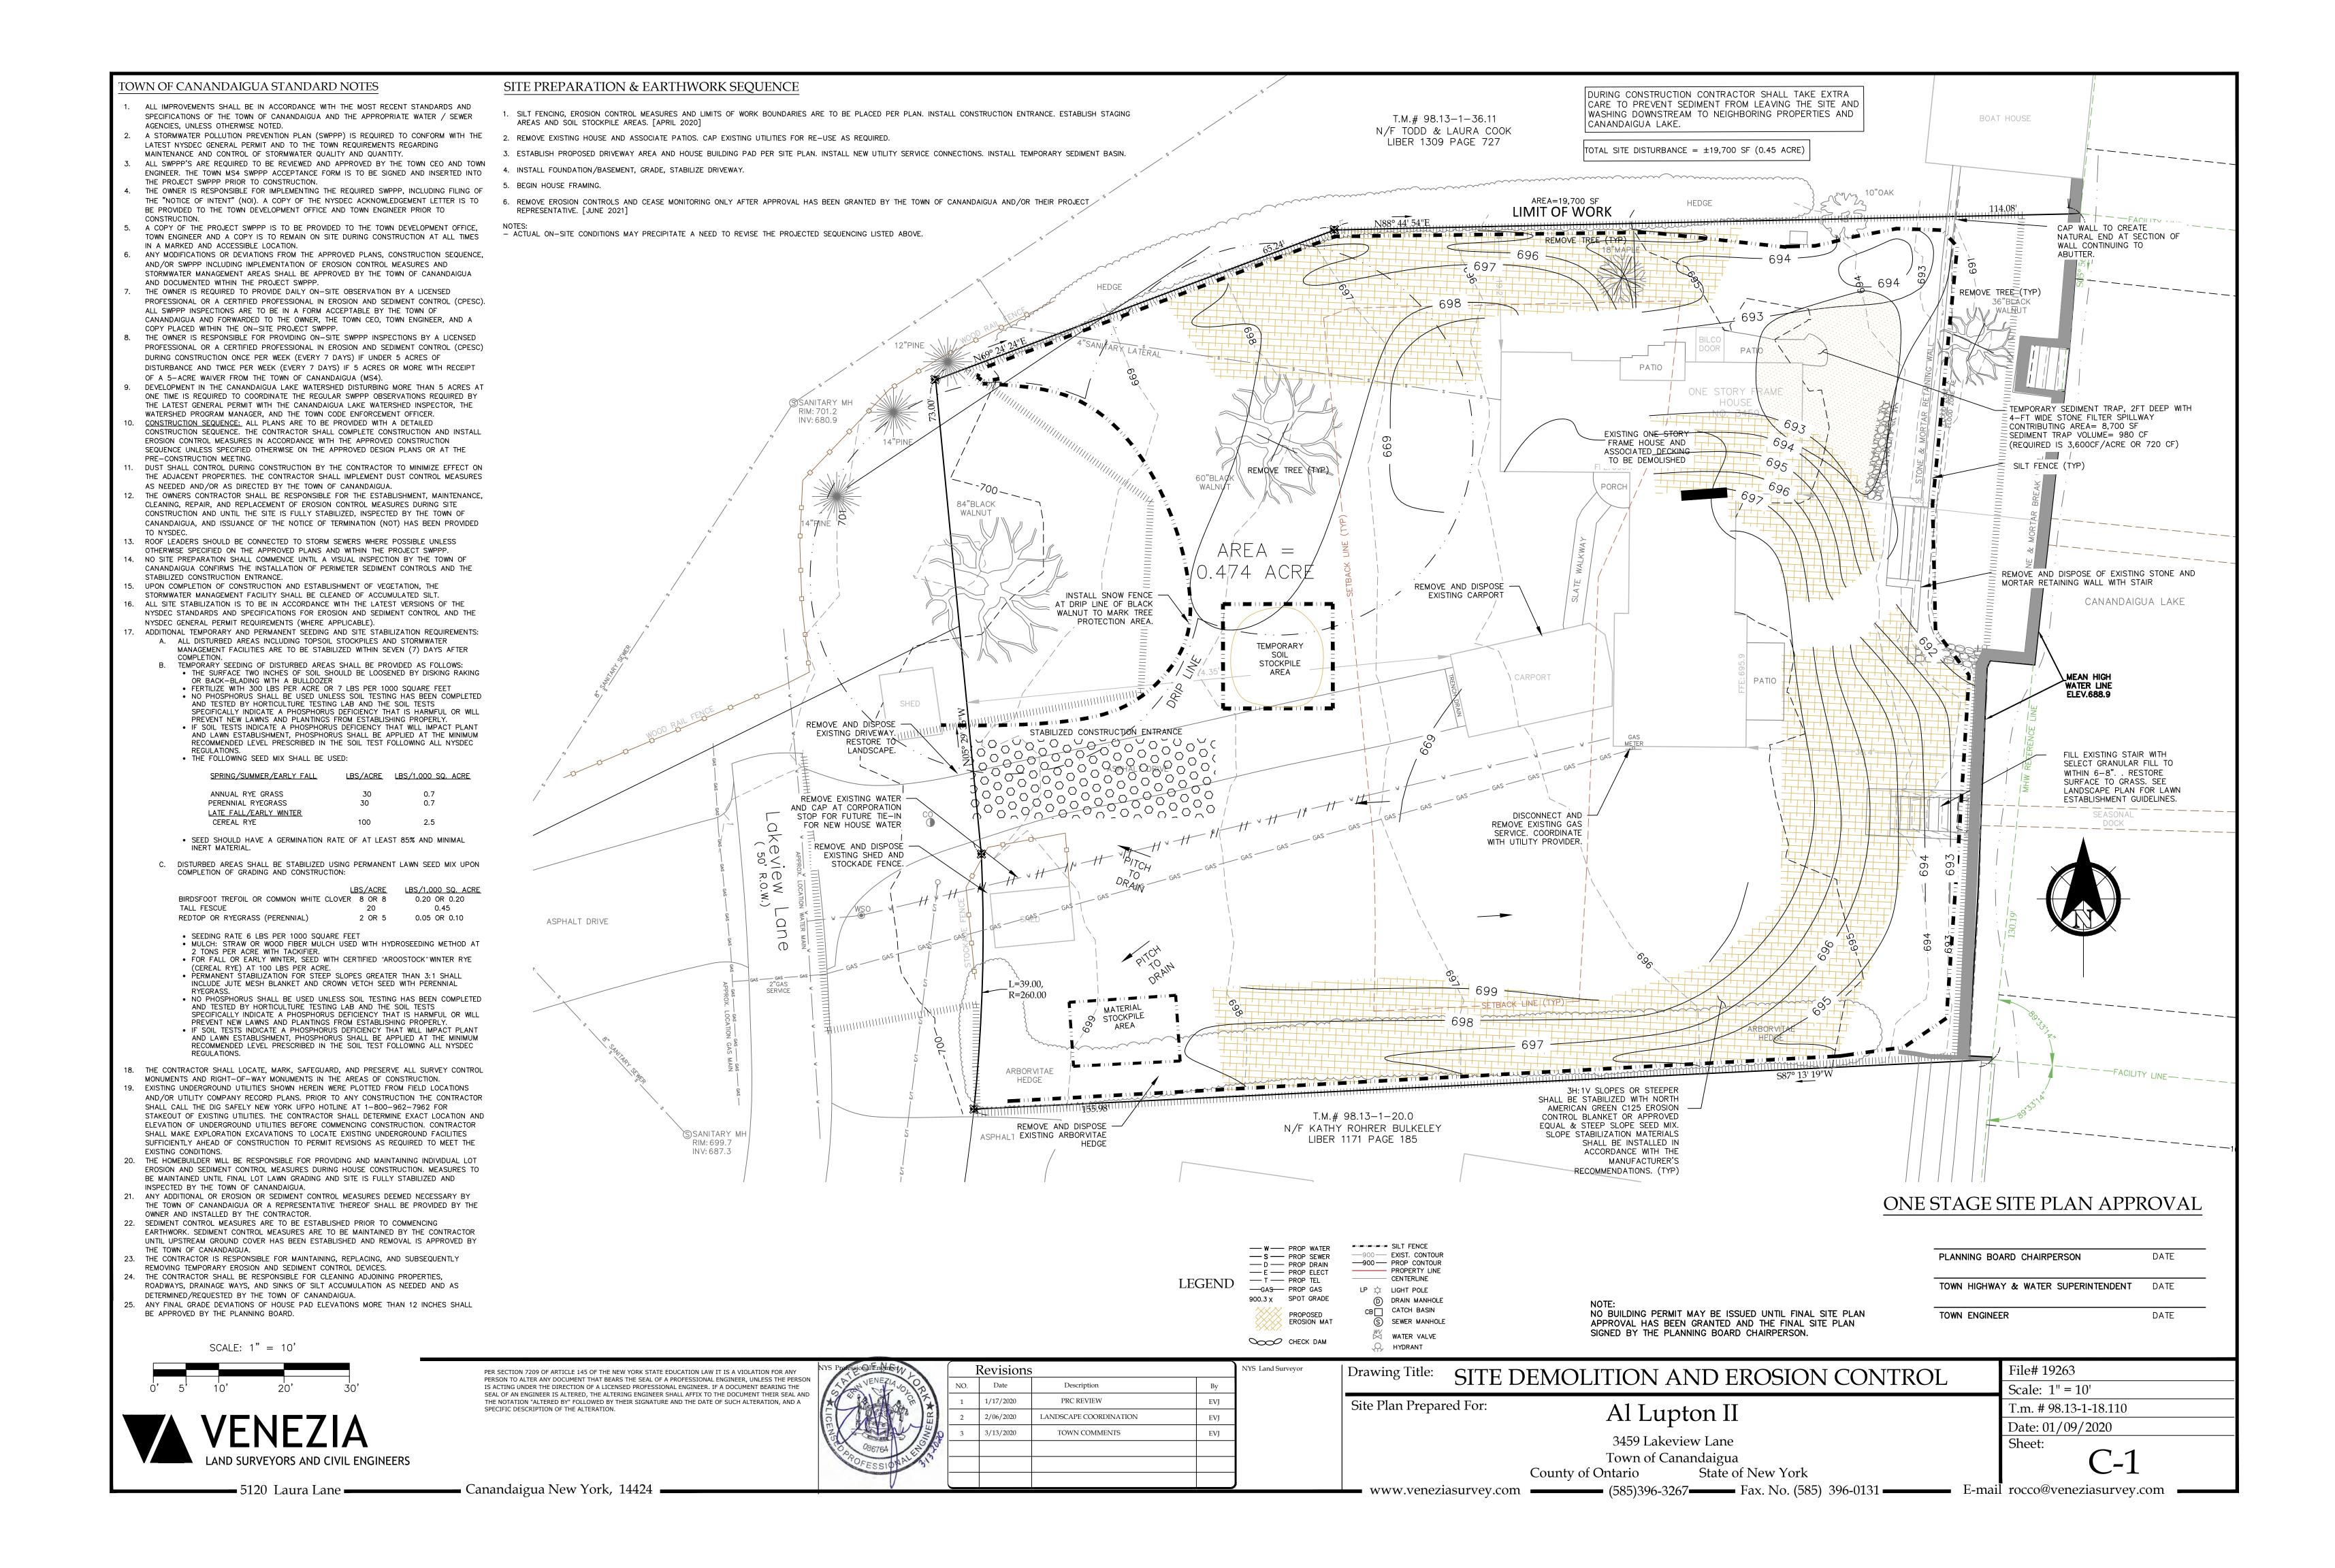

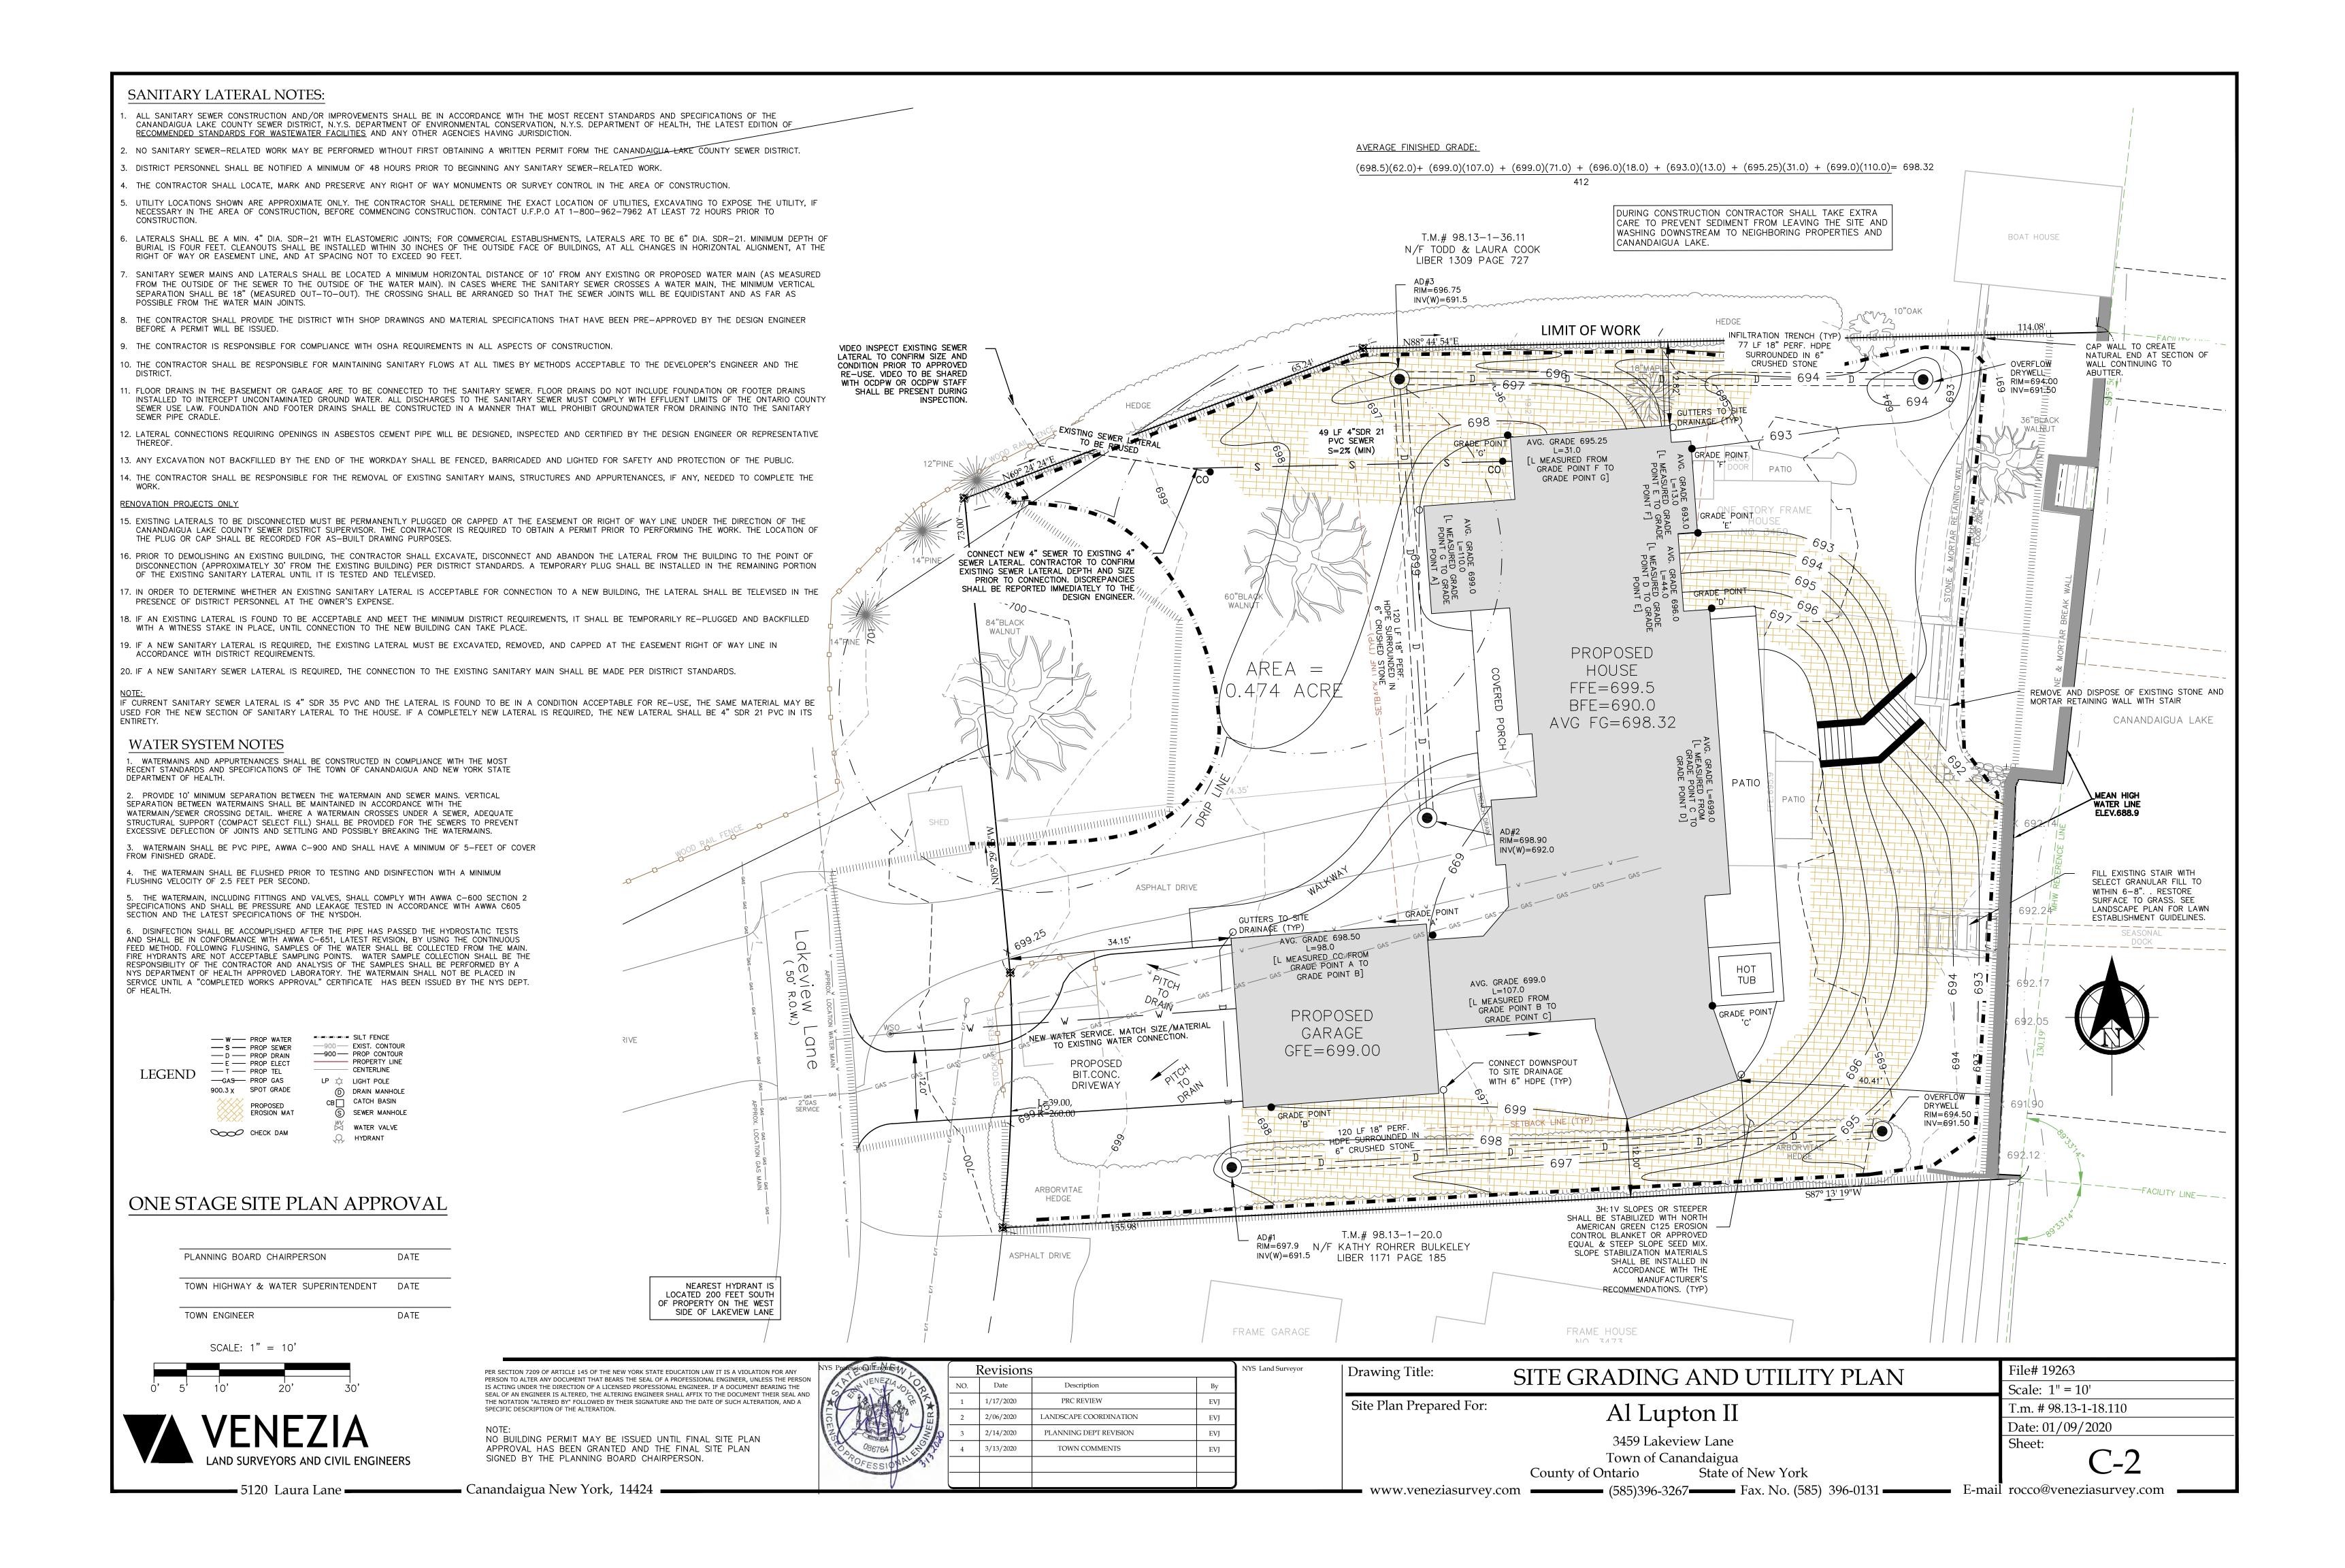

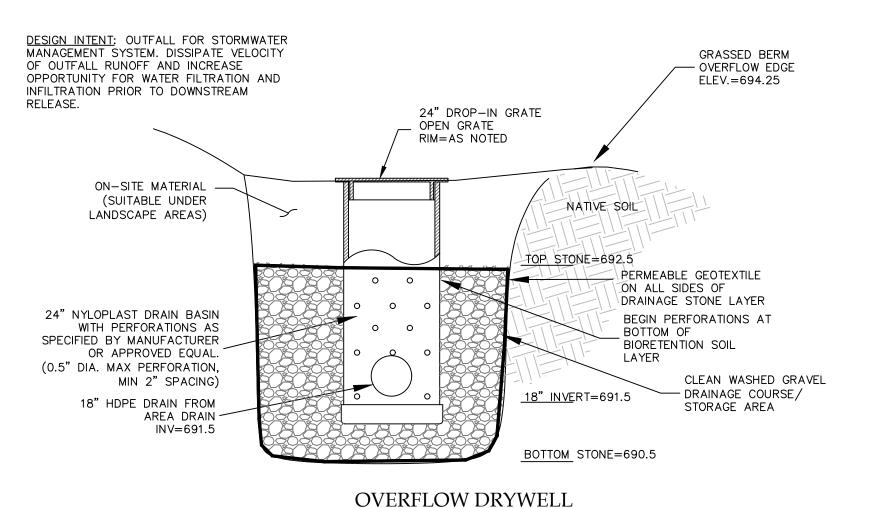

NOT TO SCALE

#### STORMWATER SYSTEM SIZING

REQUIRED VOLUME FOR AREA REDUCTION:

THE STORMWATER INFILTRATION SYSTEM HAS BEEN SIZED TO CONTAIN A 2" RAIN EVENT BEFORE OVERFLOW. DUE TO THE FACT THAT THE PROJECT IS A SINGLE-FAMILY HOME AND THE PROJECT IS NOT SIGNIFICANTLY INCREASING IMPERVIOUS COVER (+2,723 SF) A FULL STORMWATER QUANTITY ANALYSIS HAS NOT BEEN PERFORMED, BUT CONTAINMENT OF THE 2" STORM WILL HAVE REDUCTION OF RUNOFF AMOUNTS ACROSS ALL STORMS. ADDITIONALLY THE 2-INCH RUNOFF CONTAINMENT BEFORE OVERFLOW PROVIDES STORMWATER QUALITY CONTROL FOR ENHANCED PHOSPHOROUS REMOVAL DUE TO THE PROJECT BEING LOCATED IN THE CANANDAIGUA LAKE WATERSHED.

THE PROPOSED VOLUME OF RUNOFF, ASSUMING 100% RUNOFF FROM 2" OF RAIN, OVER THE IMPERVIOUS COVER DRAINAGE AREA (PROPOSED ROOF, PAVEMENT, DECK, ETC) IS:

IMPERVIOUS AREA X 2" = 6,182 SF X 0.16 FT = 989 CF

IN ORDER TO PROVIDE DETENTION FOR THIS VOLUME, INFILTRATION TRENCHES ARE PROPOSED AROUND THE HOUSE THAT STORE A COMBINED VOLUME OF 1,128 CF BEFORE OVERFLOW.

VOLUME PROVIDED IN INFILTRATION SYSTEM:


STONE TRENCH: 317' BASE LENGTH STONE 2' BASE WIDTH STONE

VOLUME OF STONE = 317' X 2.5' X 2.5' = 1,981 CF - PIPE VOLUME = 1,420 CF X 40% VOID = 568 CF


PIPE VOLUME (EMBEDDED IN STONE): 317' LF 18" PIPE


VOLUME OF 18" PIPE =  $3.14 \times (9''/12)^2 \times 317' = 560 \text{ CF}$ 

TOTAL VOLUME OF SYSTEM: VOLUME OF STONE + VOLUME OF PIPE = 568 CF + 560 CF = 1,128 CF

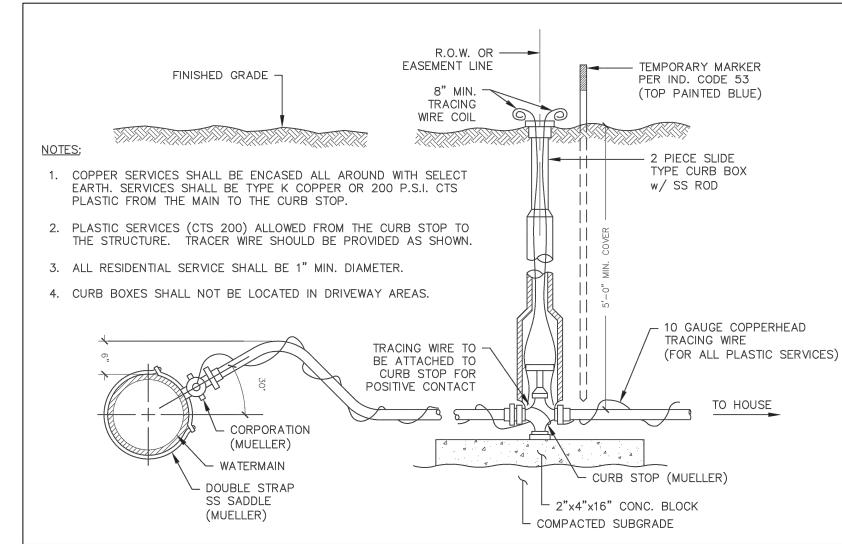

WATER SERVICE CONNECTION DETAIL NOT TO SCALE

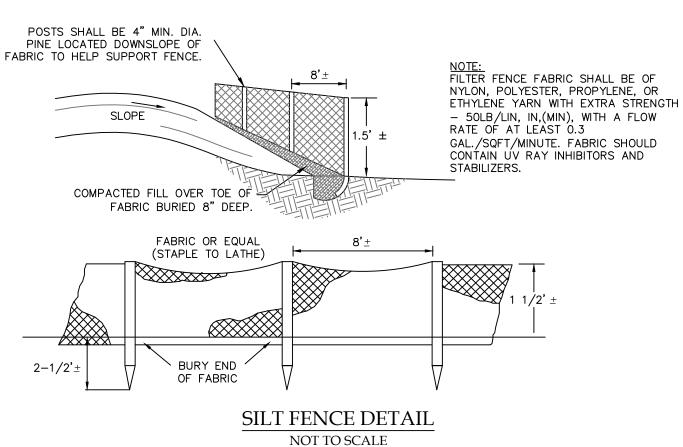

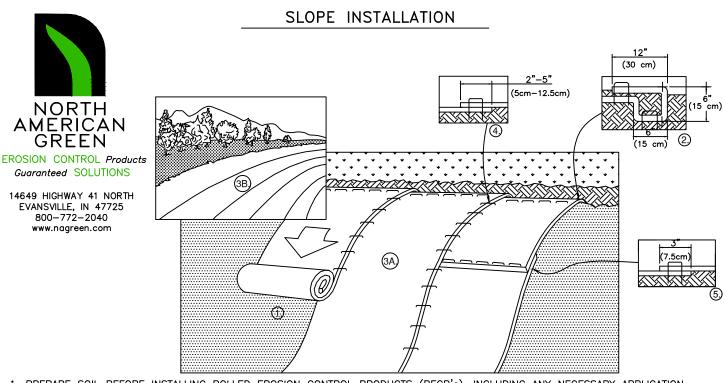

- I. PREPARE SOIL BEFORE INSTALLING ROLLED EROSION CONTROL PRODUCTS (RECP's), INCLUDING ANY NECESSARY APPLICATION OF LIME, FERTILIZER, AND SEED.
- NOTE: WHEN USING CELL-O-SEED DO NOT SEED PREPARED AREA. CELL-O-SEED MUST BE INSTALLED WITH PAPER SIDE DOWN. 2. BEGIN AT THE TOP OF THE SLOPE BY ANCHORING THE RECP's IN A 6" (15 CM) DEEP X 6" (15 CM) WIDE TRENCH WITH APPROXIMATELY 12" (30cm) OF RECP'S EXTENDED BEYOND THE UP-SLOPE PORTION OF THE TRENCH. ANCHOR THE RECP's WITH A ROW OF STAPLES/STAKES APPROXIMATELY 12" (30 CM) APART IN THE BOTTOM OF THE TRENCH.

  BACKFILL AND COMPACT THE TRENCH AFTER STAPLING. APPLY SEED TO COMPACTED SOIL AND FOLD REMAINING 12" (30 CM)

  PORTION OF RECP'S BACK OVER SEED AND COMPACTED SOIL. SECURE RECP'S OVER COMPACTED SOIL WITH A ROW OF

  STAPLES/STAKES SPACED APPROXIMATELY 12" (30 CM) APART ACROSS THE WIDTH OF THE RECP'S.
- 3. ROLL THE RECP's (A.) DOWN OR (B.) HORIZONTALLY ACROSS THE SLOPE. RECP's WILL UNROLL WITH APPROPRIATE SIDE AGAINST THE SOIL SURFACE. ALL RECP'S MUST BE SECURELY FASTENED TO SOIL SURFACE BY PLACING STAPLES/STAKES IN APPROPRIATE LOCATIONS AS SHOWN IN THE STAPLE PATTERN GUIDE. WHEN USING THE DOT SYSTEM, STAPLES/STAKES SHOULD BE PLACED THROUGH EACH OF THE COLORED DOTS CORRESPONDING TO THE APPROPRIATE STAPLE PATTERN. . THE EDGES OF PARALLEL RECP'S MUST BE STAPLED WITH APPROXIMATELY 2" - 5" (5 CM - 12.5 CM) OVERLAP DEPENDING
- ON RECP's TYPE. CONSECUTIVE RECP'S SPLICED DOWN THE SLOPE MUST BE PLACED END OVER END (SHINGLE STYLE) WITH AN APPROXIMATE 3" (7.5 CM) OVERLAP. STAPLE THROUGH OVERLAPPED AREA, APPROXIMATELY 12" (30 CM) APART ACROSS ENTIRE
- \*IN LOOSE SOIL CONDITIONS, THE USE OF STAPLE OR STAKE LENGTHS GREATER THAN 6" (15 CM) MAY BE NECESSARY TO PROPERLY SECURE THE RECP'S.


- 1-1/2" ASPHALT TOP COURSE 2" ASPHALT BASE COURSE

- 12" NO. 2 OR NO. 3 CRUSHER RUN STONE


COMPACTED SUBSOIL

BITUMINOUS CONCRETE PAVEMENT

NOT TO SCALE

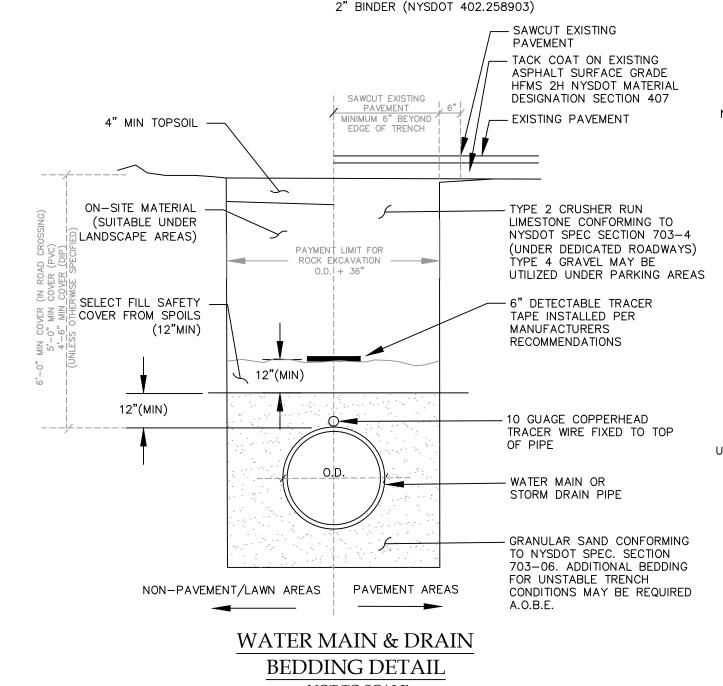


SEE PAVEMENT CROSS SECTION DETAILS (PAVEMENT THICKNESS TO MATCH EXISTING) MINIMUM ASHPALT REPLACEMENT FOR DRIVEWAYS AND PARKING AREAS: 1" TOP (NYSDOT 402.098103)

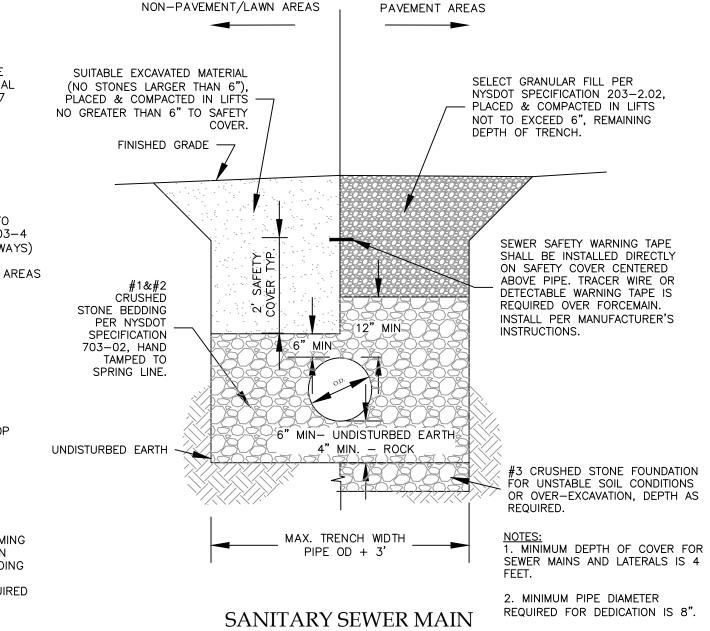


& LATERAL TRENCH BEDDING

DETAIL

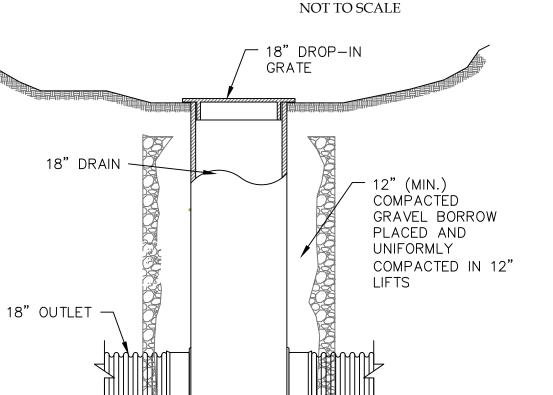


AREA DRAIN DETAIL (18" DRAIN BASIN) NOT TO SCALE

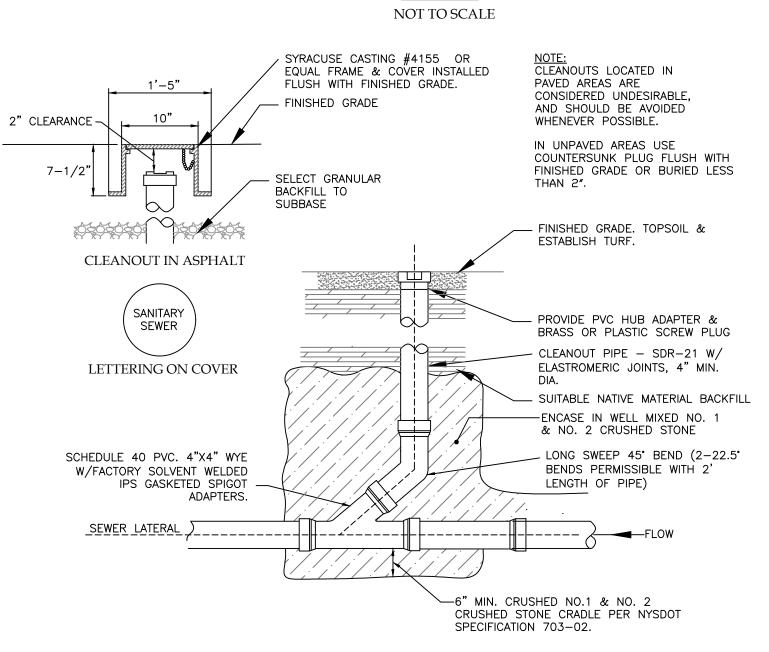

SANITARY CLEANOUT DETAIL

NOT TO SCALE

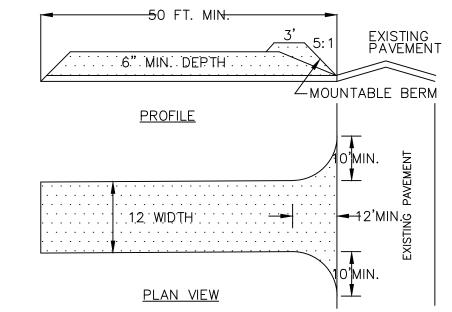

1. STONE SIZE - USE #2 STONE

- 2. THICKNESS NOT LESS THAN 6 (SIX) INCHES.
- 3. WIDTH FULL ENTRANCE WIDTH
- 4. USE FILTER FABRIC UNDER STONE FOR ENTRANCE STABILITY.
- 5. MAINTENANCE THE CONTRACTOR SHALL MAINTAIN THE ENTRANCE IN A CONDITION WHICH WILL PREVENT TRACKING OR SEDIMENT FLOW ONTO A PUBLIC HIGHWAY.
- WHEN HIGHWAY WASHING IS REQUIRED, IT SHALL BE DONE IN A MANNER THAT DIRECTS SEDIMENT RUNOFF TOWARDS EROSION CONTROL DEVICES. INSTALL ADDITIONAL EROSION CONTROLS, IF NEEDED. PERIODIC INSPECTION AND MAINTENANCE SHALL BE PROVIDED AFTER EACH RAINSTORM.

## STABILIZED CONSTRUCTION ENTRANCE DETAILS

NOT TO SCALE

#### ONE STAGE SITE PLAN APPROVAL

PLANNING BOARD CHAIRPERSON	DATE
TOWN HIGHWAY & WATER SUPERINTENDENT	DATE
TOWN ENGINEER	DATE

NO BUILDING PERMIT MAY BE ISSUED UNTIL FINAL SITE PLAN APPROVAL HAS BEEN GRANTED AND THE FINAL SITE PLAN SIGNED BY THE PLANNING BOARD CHAIRPERSON.

File# 19263

#### FOR PERMITTING ONLY



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VENEZIA VO. OR	NO.	Date	Description	Ву
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086764				
POFESSIONAL				

NYS Land Surveyor	Drawir
	Diawii
	Site Pla
	Site I i

Rocco A. Venezia, P.L.S.

Drawing Title:
Site Plan Prepared For:

## SITE AND UTILITY DETAILS

Al Lupton II 3459 Lakeview Lane Town of Canandaigua State of New York

Scale: AS NOTED T.m. # 98.13-1-18.110 Date: 01/09/2020 Sheet:

🗕 5120 Laura Lane — **—** Canandaigua New York, 14424

County of Ontario **www.veneziasurvey.com** (585)396-3267 Fax. No. (585) 396-0131 E-mail rocco@veneziasurvey.com

#### LEGEND

#### PROPERTY BOUNDARY —————— PROPOSED FENCE

R.O.W. line

♣ Iron pin or pipe found △ P.K. nail found

P.K. nail set 🔉 Iron pin set Drill hole Benchmark -≎- Utility pole

SHRUB / PERENNIAL

GROUNDCOVER

PAVER WALKWAY, MATERIAL AS SELECTED BY OWNER

	l
, SEE NOTE 11	K
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PLANT SCHEDULE

KEY BOTANICAL NAME

GR Geranium x 'Rozanne'

TC Tiarella cordifolia

Nepeta x faassenii 'Walker's Low

KEY BOTANICAL NAME MATURE HT. MATURE SPRD. COND.

COMMON NAME

Rozanne Cranesbill

Foamflower

Walker's Low Catmint

AA	Amelachier x arborea 'Autumn Brilliance'	Autumn Brilliance Serviceberry	15-25'	15-25'	B&B, multistem	7' Ht
CK	Cornus kousa	Kousa Dogwood	15-30'	15-30'	B&B, multistem	7' Ht
QR	Quesrcus rubra	Red Oak	50-75'	50-75'	B&B	8' Ht.
LT	Liriodendron tulipifera	Tulip Tree	60-90'	30-50'	B&B	8' Ht.
		DECIDUOUS SHRUBS				
KEY	BOTANICAL NAME	COMMON NAME	MATURE HT.	MATURE SPRD.	COND.	NOTES
AM	Aronia melanocarpa 'Ground Hog'	Chokeberry	14"	2-3'	No 2 Cont.	
CA	Clethra alnifolia 'Hummingbird'	Sweet peperbush	2-4'	3-5'	No 3 Cont.	
CR	Cornus racemosa ' Huron'	Huron Grey dogwood	4-5'	4-5'	No 5 Cont.	
CS	Cornus sericea 'Isanti'	Redtwig Dogwood	4-5'	4-5'	No 5 Cont.	
FG	Fothergilla gardenia	Dwarf Fothergilla	2-3'	2-4'	No 3 Cont.	
ΗP	Hydrangea paniculata 'limelight'	Limelight Hydrangea	6-8'	6-8'	No 7 Cont / B&B	
HQ	Hydrangea quercifolia 'Alice'	Alice Oakleaf Hydrangea	5-8'	5-8'	No 7 Cont / B&B	
RA	Rhus aromatica 'grow low'	Grow Low Sumac	1.5-2'	4-5'	No 2 Cont.	
RP	Rosa x Snow Pavement	Snow Pavement Rose	2-3'	3-5'	No 2 Cont.	
SJ	Spiraea japonica 'Double Play Blue Kazoo'	Double Play Series Spiraea	2-3'	2-3'	No 2 Cont.	
SP	Syringa patula 'Mss Kim'	Dwarf Lilac	3-5'	3-5'	No 3 Cont.	
VΡ	Viburnum plic. var. tomen. 'Summer Snowflake'	Summer Snowflake Doublefile Viburnum	5-8'	8-10'	B&B	

12-24"

12-18"

8-12"

No 2 Cont.

No 2 Cont.

ALL DISTURBED AREAS SHALL RECEIVE 4" TOPSOIL AND SEED SCHEDULE PROTECT EXISTING TREE TO REMAIN PROPOSED HOUSE FFE=699./50 BFE = 690.0AVG FG=699.15 CANANDAIGUA LAKE AREAS SHALL RECEIVE 4" TOPSOIL AND SEED SCHEDULE (SEE NOTE 11), TYP. MEAN HIGH WATER LINE PROPOSED GFE=699.00 ALL DISTURBED AREAS SHALL RECEIVE 4" TOPSOIL AND SEED SCHEDULE

#### **GENERAL NOTES**

NOTE: PLANTING PLAN SHALL BE REVIEWED PRIOR TO

OF CONSTRUCTION.

CONSTRUCTION TO CONFIRM PLANT AVAILABILITY AT TIME

- 1. EXISTING CONDITIONS INFORMATION IS TAKEN FROM THE PROPERTY SURVEY PREPARED BY VENEZIA & ASSOCIATES, EXISTING CONDITIONS PLAT PREPARED FOR THE AL LUPTON II AT 3459 LAKEVIEW LANE, TOWN OF CANANDAIGUA DATED NOVEMBER 19, 2019.
- 2. CONTOURS DERIVED FROM NAVD88 DATUM
- 3. SURVEY REFERENCE GPS

RANGE OF 5.0 TO 7.0.

#### **PLANTING NOTES**

- 1. CONTRACTOR SHALL VERIFY ACTUAL GRADE ELEVATIONS, SERVICE AND UTILITY LOCATIONS, AND DIMENSIONS OF PLANTINGS AND CONSTRUCTION CONTIGUOUS WITH NEW PLANTINGS BY FIELD MEASUREMENTS BEFORE PROCEEDING WITH PLANTING WORK.
- 2. ALL PLANTING BEDS SHALL BE PREPARED TO A DEPTH OF 18" AS
- 2.1. 12" DEPTH SHALL BE A PLANTING MEDIUM CONSISTING OF A MIX OF THREE PARTS EXISTING TOPSOIL AND ONE PART APPROVED ORGANIC COMPOST. THE PLANTING SOIL MIX SHALL HAVE A PH
- 2.2. THE SUBSOIL SHALL BE SCARIFIED TO A DEPTH OF 6" BENEATH PLANTING MEDIUM.PLANT TREES, SHRUBS, AND OTHER PLANTS AFTER FINISH GRADES ARE ESTABLISHED AND BEFORE PLANTING
- 3. TOPSOIL AND ORGANIC MATERIAL SOURCES MUST BE APPROVED BY THE OWNER'S REPRESENTATIVE.
- 4. NO PHOSPHORUS SHALL BE USED AT PLANTING TIME UNLESS SOIL TESTING HAS BEEN COMPLETED AND TESTED BY A HORTICULTURAL TESTING LAB AND THE SOIL TESTS SPECIFICALLY INDICATE A PHOSPHOROUS DEFICIENCY THAT IS HARMFUL, OR WILL PREVENT NEW LAWNS AND PLANTINGS FROM ESTABLISHING PROPERLY.
- 5. IF SOIL TESTS INDICATE A PHOSPHOROUS DEFICIENCY THAT WILL IMPACT PLANT AND LAWN ESTABLISHMENT, PHOSPHOROUS SHALL BE APPLIED AT THE MINIMUM RECOMMENDED LEVEL PRESCRIBED IN THE SOIL TEST FOLLOWING ALL NYS DEC REGULATIONS.
- 6. CONTRACTOR SHALL LAYOUT INDIVIDUAL TREE AND SHRUB LOCATIONS AND PLANTING AREAS . PLANT LOCATIONS MAY BE MODIFIED BASED ON ACTUAL SITE CONDITIONS AT THE TIME OF CONSTRUCTION AND MUST BE APPROVED BY THE OWNER'S REPRESENTATIVE BEFORE EXCAVATING OR PLANTING. CONTRACTOR SHALL ADJUST THE PLANT LOCATIONS IF DEEMED NECESSARY BY THE OWNER'S REPRESENTATIVE.
- 7. ALL PLANTS MUST MEET OR EXCEED THE STANDARDS OUTLINED IN THE CURRENT EDITION OF ANSI Z260.1, THE AMERICAN STANDARD FOR
- 8. ALL PLANTS MUST BE APPROVED BY THE OWNER'S REPRESENTATIVE PRIOR TO DELIVERY TO THE SITE.
- 9. PROTECT PLANTS FROM DAMAGE DUE TO TRANSPORTATION, LANDSCAPE OPERATIONS AND OPERATIONS OF OTHER CONTRACTORS AND TRADES. MAINTAIN PROTECTION DURING INSTALLATION PERIODS. TREAT, REPAIR, OR REPLACE DAMAGED PLANTINGS.
- 10. ALL PLANTING BEDS SHALL RECEIVE 3" OF DOUBLE GROUND SHREDDED HARDWOOD BARK MULCH.
- 11. ALL PLANTS SHALL BE GUARANTEED FOR A PERIOD OF ONE YEAR FROM THE DATE OF ACCEPTANCE BY THE OWNER.
- 12. ALL EXISTING LAWN AREAS DISTURBED BY THIS CONSTRUCTION PROJECT SHALL RECEIVE 4" TOPSOIL MINIMUM AND SHALL BE FINE

OR APPROVED EQUAL AT A MINIMUM RATE OF 5 LBS / 1000 SF.

HEALTHY GRASS THAT IS FREE OF WEEDS.

13. SEEDING TO BE DONE AT COMPLETION OF SITE GRADING. SEEDING

GRADED AND SEEDED WITH PREFERRED SEED'S "TRIO SUPREME MIX"

## Sue Steele Landscape Architecture

9 Summit Street, Fairport, New York 14450 (585) 747-9996

IT IS VIOLATION OF THE LAW (NEW YORK STATE EDUCATION LAW TITLE 8, ARTICLE 148 AND SUBPART 79-1 OF THE REGULATIONS OF THE COMMISSIONER OF EDUCATION) FOR ANY PERSON, UNLESS ACTING UNDER THE DIRECTION OF A LICENSED LANDSCAPE ARCHITECT TO ALTER ANY ITEM ON A PLAN, SPECIFICATION, OR REPORT TO WHICH THE SEAL OF THE LANDSCAPE ARCHITECT HAS BEEN APPLIED. IF AN ITEM BEARING THE SEAL OF THE LANDSCAPE ARCHITECT IS ALTERED, THE ALTERING LANDSCAPE ARCHITECT SHALL AFFIX TO THIS ITEM THE SEAL AND THE NOTATION 'ALTERED BY' FOLLOWING BY HIS SIGNATURE AND THE DATE OF SUCH ALTERATION, AND A SPECIFIC DESCRIPTION OF THE ALTERATION.

Project Name and Address

### Lupton Residence

3459 Lakeview Lane Town of Canandaigua, New York

FEBRUARY 6, 2020

Revision 3/17/20 ENG. COMMENTS

Drawing Title

Date

MUNICIPAL **REVIEW PLANS** LANDSCAPE PLAN

Planning Board Chairperson

LANDSCAPE PLAN