
SHEET INDEX			F	PROJECT SUMMARY	۲ ۲ ۲
NO. DESCRIPTION	<b>▲</b> /		SITE NAME:	RGE- ROCHESTER GAS & ELECTRIC	Design Build. Deliver NY 122
T1 TITLE SHEET			SITE ADDRESS:	5850 MONKS ROAD CANANDAIQUA, NY 14424	
C1 SITE SURVEY			<u>S/B/L:</u>	153.00/1/35.00	
C1A GENERAL NOTES C2 OVERALL SITE PLAN			ZONING DISTRICT:	RR-3	
C3 DETAILED SITE PLAN			SUBJECT PARCEL SIZE:	233'x200' (±1.06 ACRES)	
C4 ELEVATION VIEW			COUNTY:	ONTARIO COUNTY	
C5 DETAILS	D	G&E	SITE COORDINATES: LATITUDE:	42° 45' 54.22" (NAD 83)	
C6 DETAILS		JAE	LONGITUDE:	$-77^{\circ} 20^{\circ} 28.39^{\circ}$ (NAD 83)	L wat
C7 SHELTER DETAILS C8 FOUNDATION PLAN			GROUND ELEV .:	±1197' (AMSL)	1033 <b>—</b>
E1 ELECTRIC & TELCO LAYOUT			JURISDICTION:	TBD	
E2 GROUNDING LAYOUT			PROPERTY OWNER:	RG&E – ROCHESTER GAS & ELECTRIC 89 EAST AVE	
E3 ELECTRIC & TELCO NOTES		CATIONS TOWER		ROCHESTER, NY 14604	
E4 GROUNDING DETAILS			APPLICANT:	RG&E – ROCHESTER GAS & ELECTRIC 89 EAST AVE	
	i			ROCHESTER, NY 14604	
DRIVING DIRECTIONS	SITE	NAME	PROJECT MANAGER:	RG&E – ROCHESTER GAS & ELECTRIC 89 EAST AVE ROCHESTER, NY 14604	
DIRECTIONS FROM NEAREST MAJOR CITY (UTICA, NY) 1. HEAD EAST TOWARD ST PAUL ST	BGE – BOCHESTE	R GAS & ELECTRIC	CONTACT:	PETE STRITZINGER (585) 590-0724	IT IS A VIOLATION OF ARTICLE 145 OF THE NYS
2. USE THE LEFT 2 LANES TO TURN LEFT AT THE 1ST CROSS STREET ONTO ST PAUL ST 3. TURN LEFT AT THE 1ST CROSS STREET AT CUMBERLAND ST			ENGINEER:	INFINIGY 1033 WATERVLIET SHAKER ROAD	EDUCATION LAW FOR ANY PERSON UNLESS THEY ARE ACTING UNDER THE DIRECTION OF A LICENSED PROFESSIONAL ENGINEER FROM INFINIGY, TO ALTER THIS DOCUMENT.
4. TAKE THE INNER LOOP W RAMP		ADDRESS		ALBANY, NY 12205 MIKE LANE	6 REVISED PER COMMENT MAP 3/9/17 5 REVISED PER COMMENT MAP 3/9/17
5. TAKE I-490 E TO NY-332 S IN FARMINGTON. TAKE EXIT 44 FROM I-90 E 6. MERGE ONTO INNER LOOP			CONTACT:	(518) 690-0790	4 REVISED PER COMMENT MAP 3/9/17 3 REVISED PER COMMENT MAP 3/9/17 3 REVISED PER COMMENT MAP 3/7/17
<ol> <li>USE THE LEFT LANE TO MERGE ONTO I-490 E TOWARD INNER LOOP</li> <li>TAKE THE EXIT ON THE LEFT ONTO I-90 E</li> </ol>		NKS ROAD	LEGAL COUNSEL:	THE MURRAY LAW FIRM	2 REVISED PER COMMENT MAP 3/6/17 1 REVISED PER COMMENT SKB 3/1/17
<ol> <li>USE THE RIGHT 2 LANES TO TAKE EXIT 44 FOR NY-332 TOWARD CANANDAIGUA</li> <li>CONTINUE ON NY-332 S. TAKE NEW MICHIGAN RD, COOLEY RD, HICKOX RD, NY-21 S AND SENECA POINT RD TO MONKS RD IN CANANDAIGUA</li> </ol>	CANANDAIG	GUA, NY 14424		10 MAXWELL DRIVE CLIFTON PARK, NY 12065	0 ISSUED FOR REVIEW SKB 12/13/1 No. Submittal / Revision App'd Date
S AND SENECA POINT RD TO MONKS RD IN CANANDAIGUA 11. CONTINUE ONTO NY-332 S			CONTACT:	JACQUELINE PHILLIPS MURRAY, ESQ. (518) 688–0755	Drawn: <u>SKB</u> Date: <u>12/13/16</u>
12. TURN LEFT ONTO NEW MICHIGAN RD 13. TURN LEFT ONTO N BLOOMFIELD RD	STRUCT	TURE TYPE	BUILDING CODE:	NY BUILDING CODE	Designed: <u>MSL</u> Date: <u>12/13/16</u> Checked: <u>MSL</u> Date: <u>12/13/16</u>
14. TURN RIGHT ONTO COOLEY RD 15. CONTINUE ONTO HICKOX RD	MONOPC	DLE TOWER	DOILDING CODE.	UNIFORM BUILDING CODE BUILDING OFFICIALS & CODE ADMINISTRATORS	Project Number
16. TURN RIGHT ONTO NY-21 S 17. TURN LEFT ONTO SENECA POINT RD				UNIFORM MECHANICAL CODE UNIFORM PLUMBING CODE	<u>308-038</u>
18. TURN RIGHT ONTO MONKS RD 19. DESTINATION WILL BE ON THE RIGHT				LOCAL BUILDING CODE CITY/COUNTY ORDINANCES	Project Title
13. DESTINATION WILL DE ON THE RIGHT			ELECTRICAL CODE:	NATIONAL ELECTRICAL CODE	RGE – ROCHESTER GAS & ELECTRIC
		CALL TOLL FREE 1-800-962-7962	F	NGINEER'S LICENSE	
		THREE WORKING DAYS BEFORE YOU DI			5850 MONKS ROAD CANANDAIQUA, NY 14424
LOCATION MAP	PROJEC	CT TEAM	LER TIFICATION ST	T THESE DOCUMENTS WERE PREPARED OR APPROVED BY DULY LICENSED PROFESSIONAL ENGINEER UNDER THE	Prepared For
20			LICENSED ENGINEER -		
				APPROVALS	000
Grange A		INFINIGY Build. Build. Deliver.		AFFRUVALS	DCCL
Landing		1033 Watervliet Shaker Road   Albany, NY 12205	PLANNING BOARD CHAIR	DATE	RG&E
Canandaigua 16	RG&E	Phone: 518-690-0790   Fax: 518-690-0793 www.infinigy.com	HIGHWAY SUPERINTENDENT	DATE	
SITE	i		BUILDING	DATE	Drawing Scale: AS NOTED
Dugway Rd Monks Rd	PROJECT MANAGER	ENGINEER		DAIE	Date:
Dugway (C 21)	SCOPE OF WORK: • HANDICAP ACCESS REQUIREMENTS ARE NOT REQUIRED		TOWN ENGINEER	DATE	3/9/17 Drawing Title
Canandaigua	FACILITY IS UNMANNED AND NOT FOR HUMAN HABITATION	INSTALLATION OF NEW COMMUNICATIONS TOWER     INSTALLATION OF NEW EQUIPMENT SHELTER ON GRADE	PROPERTY:	DATE	TITLE SHEET
d Lune	FACILITY HAS NO PLUMBING OR REFRIGERANTS     THIS FACILITY SHALL MEET OR EXCEED ALL FAA AND ECC.	AND ASSOCIATED COAXIAL CABLING TO PROPOSED ANTENNAS	RF:	DATE	
at Lake	THIS FACILITY SHALL MEET OR EXCEED ALL FAA AND FCC REGULATORY REQUIREMENTS	CIVIL SITE WORK	CONSTRUCTION:	DATE	Drawing Number
Hicks Rd	ALL NEW MATERIAL SHALL BE FURNISHED AND INSTALLED BY CONTRACTOR UNLESS OTHERWISE NOTED. EQUIPMENT FURNISHED BY OWNER AND INSTALLED BY CONTRACTOR		SITE OWNER:	DATE	T1
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FURNISHED	BY OWNER	AND INSTA	LLED BY	CONTRACT

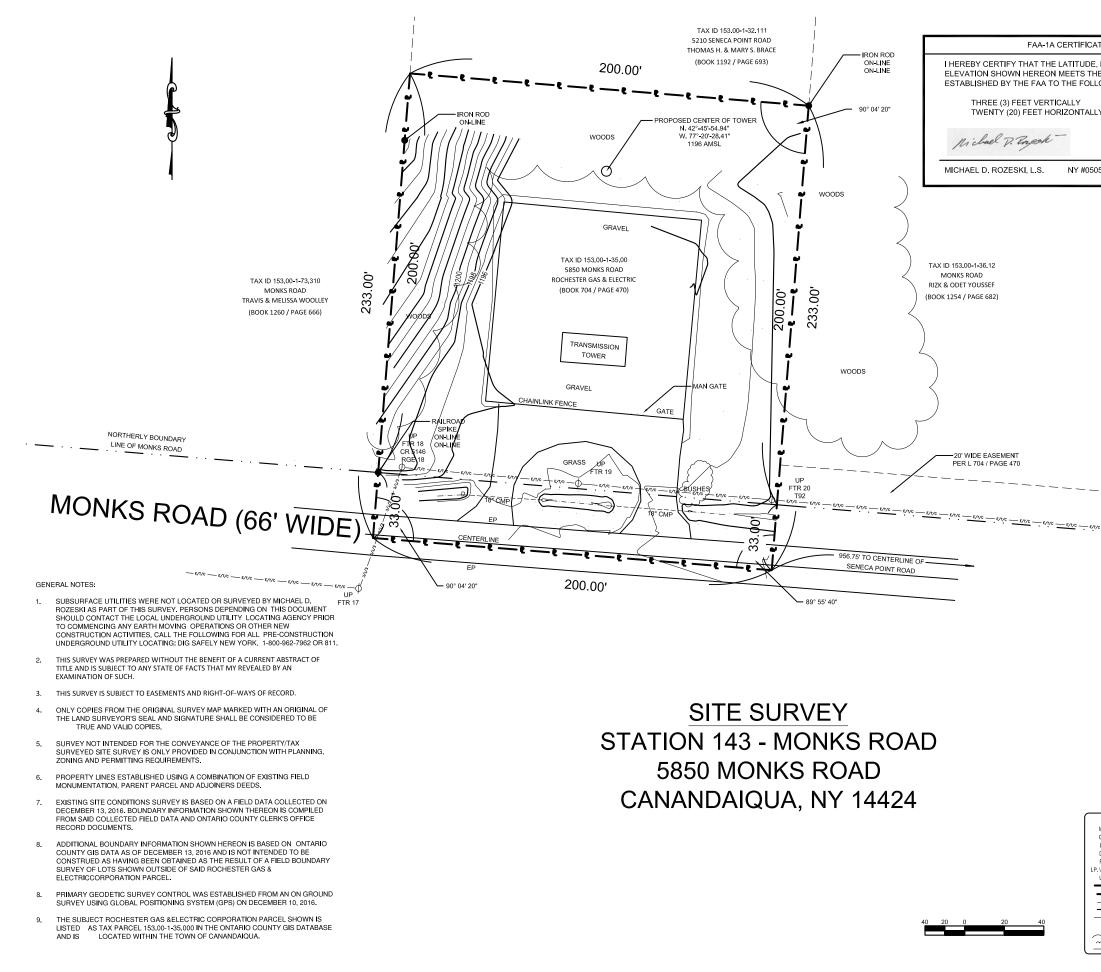

	PLANS PREPARED FOR:	
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E, LONGITUDE AND GROUND HE REQUIREMENTS AS LOWING TOLERANCES:	RG&E	
LY	PLANS PREPARED BY:	
01/16/2017	INFINIGY	Design. Build. Deliver.
0523 DATE	1033 Watervliet Shaker I Albany, NY 12205 Office # (518) 690-0790	Rd
	Fax # (518) 690-0793 JOB NUMBER XXX-XXX	
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	REVISIONS:	
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	SITE NAME:	
	STATION 143 - MONKS	S ROAD
LEGEND MH & MANHOLE GM O GAS METER	SITE ADDRESS: 5850 MONKS RO.	
LP 🕱 LIGHT STANDARD DS 🔲 DRAINAGE STRUCT. FH 🏹 FIRE HYDRANT	CANANDAIQUA, NY ONTARIO COUN	
P. I.MON.         ●         EXISTING IRON PIPE           UP         ↔         UTILITY POLE           ■         ■         PROPERTY LINE           ■         ■         ■	- SHEET DESCRIPTION:	
	SITE SURVEY	
EDGE OF WOODS		
OVERHEAD UTILITIES	C-1	

#### GENERAL NOTES

- 1. ALL DIMENSIONS TO, OF, AND ON EXISTING BUILDINGS, DRAINAGE STRUCTURES, AND SITE IMPROVEMENTS SHALL BE VERIFIED IN FIELD BY CONTRACTOR WITH ALL DISCREPANCIES REPORTED TO THE ENGINEER.
- 2. DO NOT CHANGE SIZE NOR SPACING OF STRUCTURAL ELEMENTS.
- 3. DETAILS SHOWN ARE TYPICAL; SIMILAR DETAILS APPLY TO SIMILAR CONDITIONS UNLESS OTHERWISE NOTED.
- 4. THESE DRAWINGS DO NOT INCLUDE NECESSARY COMPONENTS FOR CONSTRUCTION SAFETY 5. BRACE STRUCTURES UNTIL ALL STRUCTURAL ELEMENTS NEEDED FOR STABILITY ARE
- INSTALLED. THESE ELEMENTS ARE AS FOLLOWS: LATERAL BRACING, ANCHOR BOLTS, ETC.
- 6. DETERMINE EXACT LOCATION OF EXISTING UTILITIES, GROUNDS DRAINS, DRAIN PIPES, VENTS, ETC. BEFORE COMMENCING WORK.
- 7. INCORRECTLY FABRICATED, DAMAGED, OR OTHERWISE MISFITTING OR NONCONFORMING MATERIALS OR CONDITIONS SHALL BE REPORTED TO THE OWNER PRIOR TO REMEDIAL OR CORRECTIVE ACTION. ANY SUCH ACTION SHALL REQUIRE APPROVAL
- 8. EACH CONTRACTOR SHALL COOPERATE WITH THE OWNER'S REPRESENTATIVE, AND COORDINATE HIS WORK WITH THE WORK OF OTHERS.
- 9. IT IS THE CONTRACTOR'S RESPONSIBILITY TO EXAMINE ALL PLAN SHEETS AND SPECIFICATIONS AND COORDINATE HIS WORK WITH THE WORK OF ALL OTHER CONTRACTORS TO ENSURE THAT WORK PROGRESSION IS NOT
- 10. THE CONTRACTOR IS RESPONSIBLE FOR MAINTAINING A NEAT AND ORDERLY SITE, YARD AND GROUNDS. REMOVE AND DISPOSE OFF SITE ALL RUBBISH, WASTE MATERIALS, LITTER, AND ALL FOREIGN SUBSTANCES. REMOVE PETRO-CHEMICAL SPILLS, STAINS AND OTHER FOREIGN DEPOSITS. RAKE GROUNDS TO A SMOOTH EVEN-TEXTURED SURFACE.
- 1. THE PLANS SHOW SOME KNOWN SUBSURFACE STRUCTURES. ABOVE-THE PLANS SHOW SOME KNOWN SUBSURFACE STRUCTURES, ABOVE GROUND STRUCTURES AND/OR UTILITIES BELEVED TO EXIST IN THE WORKING AREA, EXACT LOCATION OF WHICH MAY VARY FROM THE LOCATIONS INDICATED. IN PARTICULAR, THE CONTRACTOR IS WARNED THAT THE EXACT OR EVEN APPROXIMATE LOCATION OF SUCH PIPELINES, SUBSURFACE STRUCTURES AND/OR UTILITIES IN THE AREA MAY BE SHOWN OR MAY NOT BE SHOWN; AND IT SHALL BE HIS RESPONSIBILITY TO PROCEED WITH GREAT CARE IN EXECUTING ANY WORK. (3) WORKING DAYS BEFORE YOU DIG, DRILL OR BLAST, CALL 1-800-922-4455
- 12. THE OWNER OR OWNER'S REPRESENTATIVE SHALL BE NOTIFIED IN WRITING OF ANY CONDITIONS THAT VARY FROM THOSE SHOWN ON THE PLANS. THE CONTRACTOR'S WORK SHALL NOT VARY FROM THE PLANS WITHOUT THE EXPRESSED APPROVAL OF THE OWNER OR OWNER'S REPRESENTATIVE.
- 13. THE CONTRACTOR IS INSTRUCTED TO COOPERATE WITH ANY AND ALL OTHER CONTRACTORS PERFORMING WORK ON THIS JOB SITE DURING THE PERFORMANCE OF THIS CONTRACT.
- 14. THE CONTRACTOR SHALL RESTORE ALL PUBLIC OR PRIVATE PROPERTY DAMAGED OR REMOVED TO AT LEAST AS GOOD OF CONDITION AS BEFORE DISTURBED AS DETERMINED BY THE OWNER OR OWNER'S REPRESENTATIVE.
- 15. THE CONTRACTOR SHALL COMPLY WITH ALL REQUIRED PERMITS.
- 16. THE CONTRACTOR SHALL BE RESPONSIBLE FOR OBTAINING, AND INCURRING THE COST OF ALL REQUIRED PERMITS, INCLUDING, BUT NOT LIMITED TO, THE BUILDING PERMIT, INSPECTIONS, CERTIFICATES. ETC.
- 17. THE CONTRACTOR SHALL PROTECT EXISTING PROPERTY LINE MONUMENTATION. ANY MONUMENTATION DISTURBED OR DESTROYED, AS JUDGED BY THE OWNER OR OWNER'S REPRESENTATIVE REPLACED AT THE CONTRACTOR'S EXPENSE UNDER THE SHALL BE SUPERVISION OF A LICENSED LAND SURVEYOR.
- 18. ALL TRENCH EXCAVATION AND ANY REQUIRED SHEETING AND SHORING SHALL BE DONE IN ACCORDANCE OSHA REGULATIONS FOR CONSTRUCTION.
- CONTRACTOR SHALL BE RESPONSIBLE FOR DEWATERING AND THE MAINTENANCE OF SURFACE DRAINAGE DURING THE COURSE OF WORK.
- 20. ALL UTILITY WORK INVOLVING CONNECTIONS TO EXISTING SYSTEMS SHALL BE COORDINATED WITH THE OWNER OR OWNER'S REPRESENTATIVE AND THE UTILITY OWNER. NOTIFY THE OWNER OR OWNER'S REPRESENTATIVE AND THE UTILITY OWNER BEFORE EACH AND EVERY CONNECTION TO EXISTING SYSTEMS IS MADE.
- 21. MAINTAIN FLOW FOR ALL EXISTING UTILITIES.
- 22. ALL SITE FILL SHALL MEET SELECTED FILL STANDARDS AS DEFINED BY THE OWNER OR OWNER'S REPRESENTATIVE ON THE DRAWINGS.
- 23. CONTRACTOR SHALL GRADE ALL AREAS ON THE SITE TO PROVIDE POSITIVE DRAINAGE AWAY FROM THE EQUIPMENT PAD AND THE TOWER.
- 24. ALL IMPROVEMENTS TO CONFORM WITH LOCAL JURISDICTION CONSTRUCTION STANDARDS AND SPECIFICATIONS, LATEST EDITION.

## STRUCTURAL STEEL NOTES

- 1. STRUCTURAL STEEL SHALL CONFORM TO THE LATEST EDITION OF THE AISC "SPECIFICATION FOR THE DESIGN, FABRICATION AND ERECTION OF STRUCTURAL STEEL FOR BUILDINGS"
- 2. ALL INTERIOR STRUCTURAL STEEL USED SHALL BE, WHEN DELIVERED, FINISHED WITH ONE COAT FABRICATOR'S NON-LEAD, RED OXIDE PRIMER. PRIMING SHALL BE PERFORMED AFTER SHOP FABRICATION TO THE GREATEST EXTENT POSSIBLE. ALL DINGS, SCRAPES, MARS, AND WELDS IN THE PRIMED AREAS SHALL BE REPAIRED BY FIELD TOUCH-UP PRIOR TO COMPLETION OF THE WORK.
- 3. ALL EXTERIOR STEEL WORK SHALL BE GALVANIZED IN ACCORDANCE WITH SPECIFICATION ASTM A36 UNLESS OTHERWISE NOTED. GALVANIZING SHALL BE PERFORMED AFTER SHOP FABRICATION TO THE GREATEST EXTENT POSSIBLE. ALL DINGS, SCRAPES, MARS, AND WELDS IN THE GALVANIZED AREAS SHALL BE REPAIRED BY FIELD TOUCH-UP PRIOR TO COMPLETION OF THE WORK.
- 4. DO NOT PLACE HOLES THROUGH STRUCTURAL STEEL MEMBERS EXCEPT AS SHOWN AND DETAILED ON STRUCTURAL DRAWINGS.
- 5. CONNECTIONS:
- A. ALL WELDING SHALL BE DONE USING E70XX ELECTRODES AND WELDING SHALL CONFORM TO AISC AND AWS D1.1. WHERE FILLET WELD SIZES ARE NOT SHOWN, PROVIDE THE MINIMUM SIZE PER TABLE J2.4 IN THE AISC "MANUAL OF STEEL CONSTRUCTION ", 9TH EDITION. AT THE COMPLETION OF WELDING, ALL DAMAGE TO GALVANIZED COATING SHALL BE REPAIRED.
- B. BOLTED CONNECTIONS SHALL USE BEARING TYPE GALVANIZED ASTM A325 BOLTS (3/4" DIA) AND SHALL HAVE MINIMUM OF TWO BOLTS UNLESS NOTED OTHERWISE.
- C. NON-STRUCTURAL CONNECTIONS FOR STEEL GRATING MAY USE 5/8" DIA. GALVANIZED ASTM A 307 BOLTS UNLESS NOTED OTHERWISE
- D. CONNECTION DESIGN BY FABRICATOR WILL BE SUBJECT TO REVIEW AND APPROVAL BY ENGINEER.

# IN ACCORDANCE WITH ACI 301 SECTION 4.2.4

- 10. INSTALLATION OF CONCRETE EXPANSION/WEDGE ANCHOR, SHALL BE PER APPROVAL WHEN DRILLING HOLES IN CONCRETE.
- 11. CURING COMPOUNDS SHALL CONFORM TO ASTM C-309. 12. ADMIXTURES SHALL CONFORM TO THE APPROPRIATE ASTM STANDARD AS REFERENCED
- IN ACI-301 13. DO NOT WELD OR TACKWELD REINFORCING STEEL. 14. ALL
- BEFORE START OF CONCRETE PLACEMENT.
- 17. PLACE CONCRETE IN A UNIFORM MANNER TO PREVENT THE FORMATION OF COLD JOINTS
- 18. DO NOT PLACE CONCRETE IN WATER, ICE, OR ON FROZEN GROUND.
- PERIOD, OR FOR A MINIMUM OF 14 DAYS AFTER PLACEMENT.
- FOR 7 DAYS MINIMUM.

EXISTING

OVERHEAD WIRES

120.5 OR x

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## CONCRETE NOTES

- 1. DESIGN AND CONSTRUCTION OF ALL CONCRETE ELEMENTS SHALL CONFORM TO THE LATEST EDITIONS OF THE FOLLOWING APPLICABLE CODES: ACI 301 "SPECIFICATIONS FOR STRUCTURAL CONCRETE FOR BUILDINGS"; ACI 318, "BUILDING CODE REQUIREMENTS FOR REINFORCED CONCRETE";
- 2. MIX DESIGN SHALL BE APPROVED BY OWNER'S REPRESENTATIVE PRIOR TO PLACING CONCRETE.
- CONCRETE SHALL BE NORMAL WEIGHT, 6% AIR ENTRAINED (±1.5%) WITH A MAXIMUM 4" SLUMP, AND HAVE A MINIMUM 28-DAY COMPRESSIVE STRENGTH OF 3000 PSI UNLESS OTHERWISE NOTED.
- 4. MAXIMUM AGGREGATE SIZE SHALL BE 1".

5. THE FOLLOWING MATERIALS SHALL BE USED:	
PORTLAND CEMENT: REINFORCEMENT:	ASTM C 150, TYPE I ASTM A 185
NORMAL WEIGHT AGGREGATE:	ASTM C 33
WATER:	DRINKABLE

- ADMIXTURES: NON-CHLORIDE CONTAINING 6. REINFORCING DETAILS SHALL BE IN ACCORDANCE WITH THE LATEST EDITION OF ACI 315.
- 7. REINFORCING STEEL SHALL CONFORM TO ASTM A 615, GRADE 60, DEFORMED UNLESS NOTED OTHERWISE. WELDED WIRE FABRIC SHALL CONFORM TO ASTM A 185 WELDED STEEL WIRE FABRIC UNLESS NOTED OTHERWISE. SPLICES SHALL BE CLASS "B" AND ALL HOOKS SHALL BE STANDARD, UNO.
- 8. THE FOLLOWING MINIMUM CONCRETE COVER SHALL BE PROVIDED FOR REINFORCING STEEL UNLESS SHOWN OTHERWISE ON DRAWINGS:

CONCRETE EXPOSED TO EARTH OR WEATHER: #6 AND LARGER ......2 IN.

#5 AND SMALLER & WWF .....1 1/2 IN.

CONCRETE NOT EXPOSED TO EARTH OR WEATHER OR NOT CAST AGAINST THE GROUND: SLAB AND WALL ..3/4 IN.

BEAMS AND COLUMNS  $.1 \ 1/2 \ IN$  FENCE

HIGHWAY


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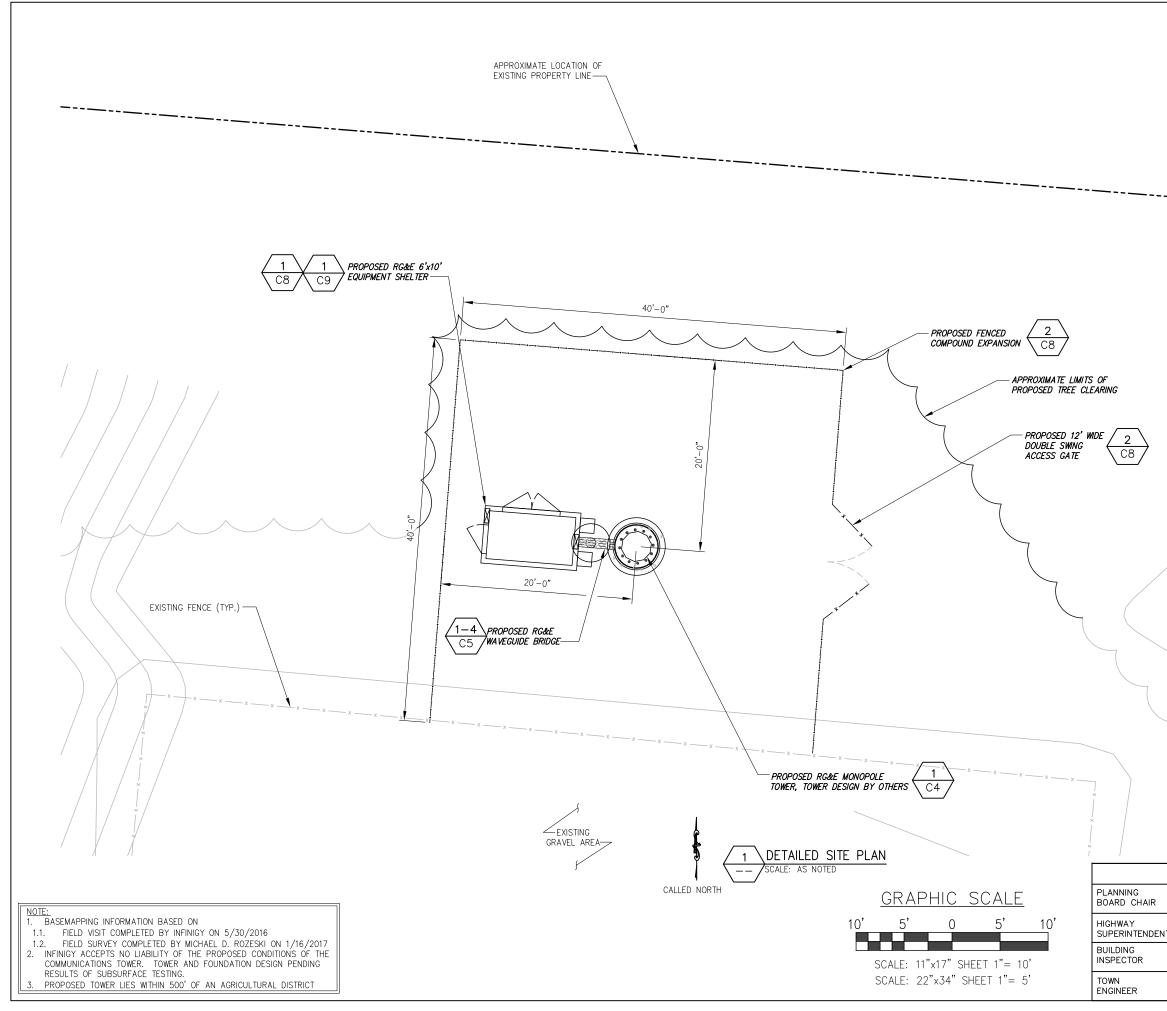
ENGINEER

INSPECTOR


CO >-Ú Ž 9. A CHAMFER 3/4" SHALL BE PROVIDED AT ALL EXPOSED EDGES OF CONCRETE, UNO, Ī rvliet 518-6 MANUFACTURES WRITTEN RECOMMENDED PROCEDURE. THE ANCHOR BOLT, DOWEL OR ROD SHALL CONFORM TO MANUFACTURER'S RECOMMENDATION FOR EMBEDMENT DEPTH Ζ 33 Water Phone: OR AS SHOWN ON THE DRAWINGS. NO REBAR SHALL BE CUT WITHOUT PRIOR ENGINEERING DOWELS, ANCHOR BOLTS, EMBEDDED STEEL, ELECTRICAL CONDUITS, PIPE SLEEVES, GROUNDS AND ALL OTHER EMBEDDED ITEMS AND FORMED DETAILS SHALL BE IN PLACE 15. LOCATE ADDITIONAL CONSTRUCTION JOINTS REQUIRED TO FACILITATE CONSTRUCTION AS ACCEPTABLE TO ENGINEER. PLACE REINFORCEMENT CONTINUOUSLY THROUGH JOINT. 16. REINFORCEMENT SHALL BE COLD BENT WHENEVER BENDING IS REQUIRED. AND OTHER PLANES OF WEAKNESS. VIBRATE THE CONCRETE TO FULLY EMBED REINFORCING. DO NOT USE VIBRATORS TO TRANSPORT CONCRETE THROUGH CHUTES OR FORMWORK. 19. DO NOT ALLOW CONCRETE SUBBASE TO FREEZE DURING CONCRETE CURING AND SETTING IS A VIOLATION OF ARTICLE 145 OF THE NY EDUCATION LAW FOR ANY PERSON UNLESS HEY ARE ACTING UNDER THE DIRECTION O LICENSED PROFESSIONAL ENGINEER FROI INFINIGY, TO ALTER THIS DOCUMENT. 20. FOR COLD-WEATHER AND HOT-WEATHER CONCRETE PLACEMENT, CONFORM TO APPLICABLE ACI CODES AND RECOMMENDATIONS. IN EITHER CASE, MATERIALS CONTAINING CHLORIDE, CALCIUM, SALTS, ETC. SHALL NOT BE USED. PROTECT FRESH CONCRETE FROM WEATHER REVISED PER COMMENT MAP 3/9/ 5 REVISED PER COMMENT MAP 3/9/ REVISED PER COMMENT MAP 3/9 REVISED PER COMMENT MAP 3/ REVISED PER COMMENT MAP 3/6/ REVISED PER COMMENT SKB 3/1 CIVIL LEGEND ISSUED FOR REVIEW SKB 12/13 Submittal / Revision App'd Date rawn: <u>SKB</u> Date: 12/13/16 PROPOSED Designed: MSL Date: 12/13/16 Checked: MSL Date: 12/13/16 UNDERGROUND ELECTRIC \_ \_ \_ \_ \_ \_ oject Numbe 308-038 roiect Title RGE – ROCHESTER -250-GAS & ELECTRIC \_\_\_\_\_\_ 120.5 OR x<sup>120.5</sup> PRIMARY PROPERTY OR R.O.W. 5850 MONKS ROAD \_\_\_\_ CANANDAIQUA, NY 14424 enared For Ø RG&E Drawing Scal AS NOTED REPRESENTS DETAIL NUMBER Date: 3/9/17 APPROVALS rawing Title GENERAL DATE NOTES DATE rawing Number DATE C1A DATE



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DETAIL PENDING FINAL RF DES/GN

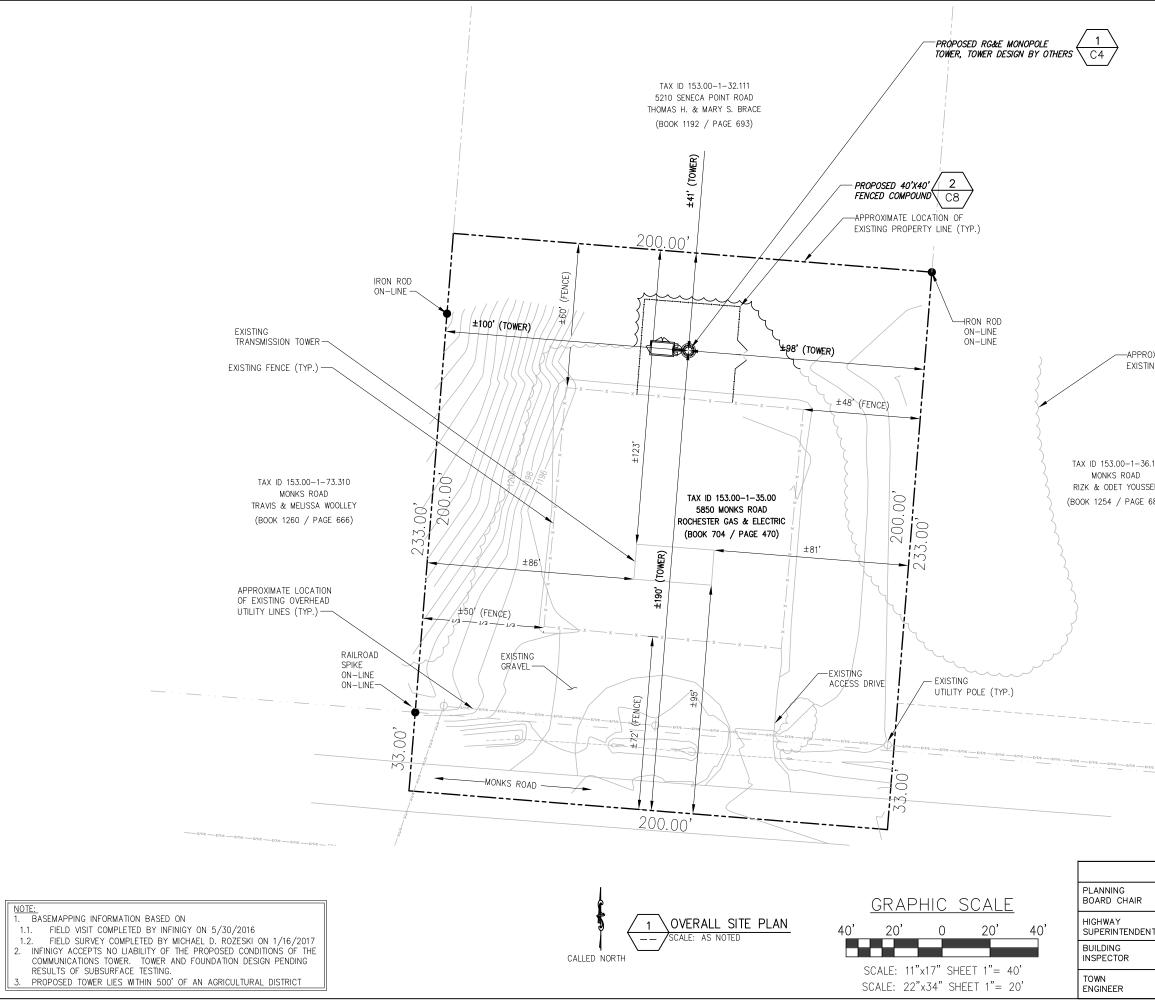

DETAIL PENDING FINAL RF DESIGN

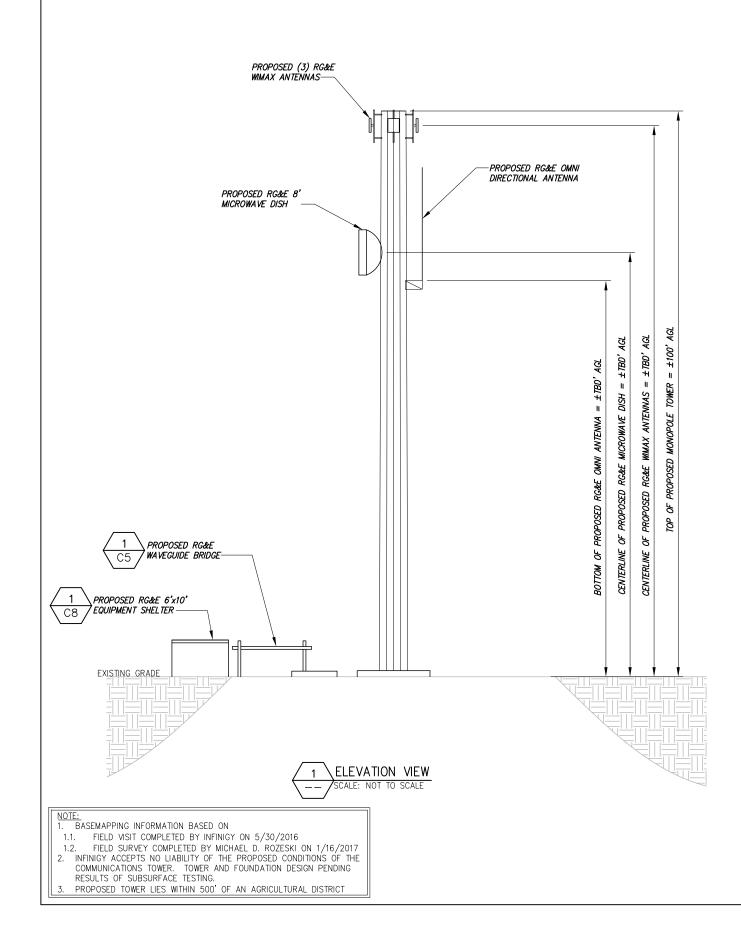

PLANNING BOARD CHAIR
HIGHWAY SUPERINTENDEN
BUILDING INSPECTOR
TOWN ENGINEER

APPROVALS


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5850 MONKS ROAD CANANDAIQUA, NY 14424 Prepared For RG&E		
Drawing Scale: <u>AS NOTED</u> Date: <u>3/9/17</u> Drawing Title ELEVATION VIEW		
Drawing Number C4		



## GRADING & EXCAVATING NOTES:

- 1. ALL EXCAVATIONS ON WHICH CONCRETE IS TO BE PLACED SHALL BE SUBSTANTIALLY HORIZONTAL ON UNDISTURBED AND UNFROZEN SOIL AND BE FREE FROM LOOSE MATERIAL AND EXCESS GROUNDWATER. DEWATERING FOR EXCESS GROUNDWATER SHALL BE PROVIDED IF REQUIRED.
- 2. CONCRETE FOUNDATIONS SHALL NOT BE PLACED ON ORGANIC MATERIAL. IF SOUND SOIL IS NOT REACHED AT THE DESIGNATED EXCAVATION DEPTH, THE UNSATISFACTORY SOIL SHALL BE EXCAVATED TO ITS FULL DEPTH AND EITHER BE REPLACED WITH MECHANICALLY COMPACTED GRANULAR MATERIAL OR THE EXCAVATION BE FILLED WITH CONCRETE OF THE SAME QUALITY SPECIFIED FOR THE FOUNDATION.
- ANY EXCAVATION OVER THE REQUIRED DEPTH SHALL BE FILLED WITH EITHER 3. MECHANICALLY COMPACTED GRANULAR MATERIAL OR CONCRETE OF THE SAME QUALITY SPECIFIED FOR THE FOUNDATION. CRUSHED STONE MAY BE USED TO STABILIZE THE BOTTOM OF THE EXCAVATION. STONE, IF USED, SHALL NOT BE USED AS COMPILING CONCRETE THICKNESS.
- AFTER COMPLETION OF THE FOUNDATION AND OTHER CONSTRUCTION BELOW GRADE, AND BEFORE BACKFILLING, ALL EXCAVATIONS SHALL BE CLEAN OF UNSUITABLE MATERIAL SUCH AS VEGETATION, TRASH, DEBRIS, AND SO FORTH FOR ANY FILLING OPERATION.
- REMOVE ALL VEGETATION, TOPSOIL, DEBRIS, WET AND UNSATISFACTORY SOIL 5. MATERIALS, OBSTRUCTIONS, AND DELETERIOUS MATERIALS FROM GROUND SURFACE PRIOR TO PLACING FILLS. PLOW, STRIP, OR BREAK UP SLOPED SURFACES STEEPER THAN THAN 1 VERTICAL TO 4 HORIZONTAL SO FILL MATERIAL WILL BOND WITH EXISTING SURFACE. WHEN SUBGRADE OR EXISTING GROUND SURFACE TO RECEIVE FILL HAS A DENSITY LESS THAN THAT REQUIRED FOR FILL, BREAK UP GROUND SURFACE TO DEPTH REQUIRED PULVERIZE, MOISTURE-CONDITION OR AFRATE SOIL AND RECOMPACT TO REQUIRED DENSITY
- 6. USE APPROVED MATERIALS CONSISTING OF EARTH, LOAM, SANDY CLAY, SAND -BE FREE FROM CLODS OR STONES OVER 2-1/2" MAXIMUM DIMENSIONS -BE PLACED IN 6" LAYERS AND COMPACTED TO 95% STANDARD PROCTOR EXCEPT IN GRASSED/LANDSCAPED AREAS, WHERE 90% STANDARD PROCTOR
- REPLACE EXISTING GRAVEL SURFACING ON AREAS FROM WHICH GRAVEL SURFACING IS 7. REMOVED DURING CONSTRUCTION OPERATIONS, GRAVEL SURFACING SHALL BE REPLACED TO MATCH EXISTING ADJACENT GRAVEL SURFACING AND SHALL BE OF THE SAME THICKNESS. SURFACES OF GRAVEL SURFACING SHALL BE FREE FROM CORRUGATIONS AND WAVES. EXISTING GRAVEL SURFACING MAY BE EXCAVATED SEPARATELY AND REUSED IF INJURIOUS AMOUNTS OF EARTH, ORGANIC MATTER, OR OTHER DELETERIOUS MATERIALS ARE REMOVED PRIOR TO REUSE. FURNISH ALL ADDITIONAL GRAVEL RESURFACING MATERIAL AS REQUIRED. BEFORE GRAVEL SURFACING IS REPLACED, SUBGRADE SHALL BE GRADED TO CONFORM TO REQUIRED SUBGRADE ELEVATIONS, AND LOOSE OR DISTURBED MATERIALS SHALL BE THOROUGHLY COMPACTED. DEPRESSIONS IN THE SUBGRADE SHALL BE FILLED AND COMPACTED WITH APPROVED SELECTED MATERIAL. GRAVEL SURFACING MATERIAL MAY BE USED FOR FILLING DEPRESSIONS IN THE SUBGRADE, SUBJECT TO ENGINEER'S APPROVAL.
- 8. DAMAGE TO EXISTING STRUCTURES AND UTILITIES RESULTING FROM CONTRACTOR'S NEGLIGENCE SHALL BE REPAIRED/REPLACED TO OWNER'S SATISFACTION AT CONTRACTOR'S EXPENSE.
- CONTRACTOR SHALL COORDINATE THE CONSTRUCTION SCHEDULE WITH PROPERTY OWNER SO AS 9. TO AVOID INTERRUPTIONS TO PROPERTY OWNER'S OPERATIONS.
- 10. ENSURE POSITIVE DRAINAGE DURING AND AFTER COMPLETION OF CONSTRUCTION.
- 11. ALL CUT AND FILL SLOPES SHALL BE MAXIMUM 3 HORIZONTAL TO 1 VERTICAL.
- CONTRACTOR SHALL BE RESPONSIBLE FOR MONITORING SITE VEHICLE 12. TRAFFIC AS TO NOT ALLOW VEHICLES LEAVING THE SITE TO TRACK MUD ONTO PUBLIC STREETS. THE CONTRACTOR IS RESPONSIBLE FOR CLEANING PUBLIC STREETS DUE TO MUDDY VEHICLES LEAVING THE SITE.

## GENERAL EROSION & SEDIMENT CONTROL NOTES:

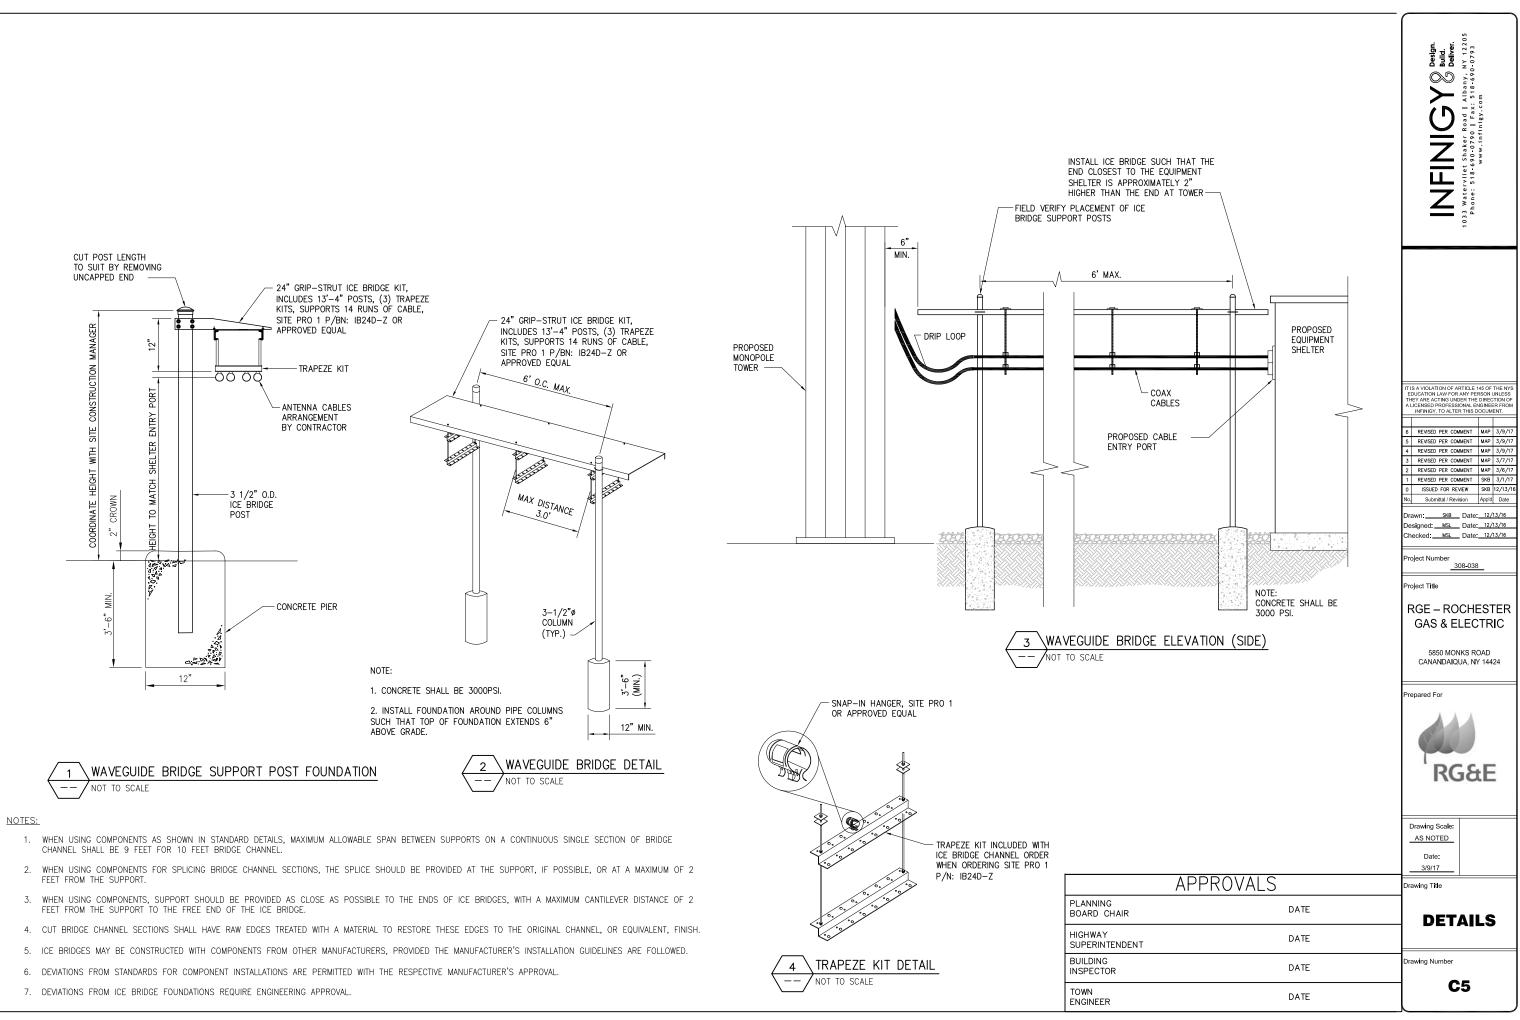- THE SOIL EROSION AND SEDIMENT CONTROL MEASURES AND DETAILS AS SHOWN HEREIN AND STIPULATED WITHIN STATE STANDARDS 1. SHALL BE FOLLOWED AND INSTALLED IN A MANNER SO AS TO MINIMIZE SEDIMENT LEAVING THE SITE.
- PRIOR TO COMMENCING LAND DISTURBANCE ACTIVITY, THE LIMITS OF LAND DISTURBANCE SHALL BE CLEARLY AND ACCURATELY DEMARCATED WITH STAKES, RIBBONS, OR OTHER APPROPRIATE MEANS.
- EROSION CONTROL DEVICES SHALL BE INSTALLED BEFORE GROUND DISTURBANCE OCCURS. THE LOCATION OF SOME OF THE EROSION CONTROL DEVICES MAY HAVE TO BE ALTERED FROM THOSE SHOWN ON THE APPROVED PLANS IF DRAINAGE PATTERNS DURING CONSTRUCTION ARE DIFFERENT FROM THE FINAL PROPOSED DRAINAGE PATTERNS. IT IS THE CONTRACTOR'S RESPONSIBILITY TO ACCOMPLISH EROSION CONTROL FOR ALL DRAINAGE PATTERNS CREATED AT VARIOUS STAGES DURING CONSTRUCTION. ANY DIFFICULTY IN CONTROLLING EROSION DURING ANY PHASE OF CONSTRUCTION SHALL BE REPORTED TO THE ENGINEER IMMEDIATELY.
- THE LOCATION OF SOME OF THE EROSION CONTROL DEVICES MAY HAVE TO BE ALTERED FROM THAT SHOWN ON THE PLANS IF DRAINAGE PATTERNS DURING CONSTRUCTION ARE DIFFERENT FROM THE FINAL PROPOSED DRAINAGE PATTERNS. ANY DIFFICULTY IN CONTROLLING EROSION DURING ANY PHASE OF CONSTRUCTION SHALL BE REPORTED TO THE ENGINEER IMMEDIATELY.
- CONTRACTOR SHALL MAINTAIN ALL EROSION CONTROL MEASURES UNTIL PERMANENT VEGETATION HAS BEEN ESTABLISHED. CONTRACTOR SHALL CLEAN OUT ALL SEDIMENT PONDS WHEN REQUIRED BY THE ENGINEER OR 5. THE LOCAL JURISDICTION INSPECTOR. CONTRACTOR SHALL INSPECT EROSION CONTROL MEASURES AT THE END OF EACH WORKING DAY TO ENSURE MEASURES ARE FUNCTIONING PROPERLY.
- 6. THE CONTRACTOR SHALL REMOVE ACCUMULATED SILT WHEN THE SILT IS WITHIN 12" OF THE TOP OF THE SILT FENCE.
- FAILURE TO INSTALL, OPERATE OR MAINTAIN ALL EROSION CONTROL MEASURES WILL RESULT IN ALL CONSTRUCTION BEING STOPPED ON THE JOB SITE UNTIL SUCH MEASURES ARE CORRECTED
- SILT BARRIERS TO BE PLACED AT DOWNSTREAM TOE OF ALL 8. CUT AND FILL SLOPES.
- 9. ALL CUT AND FILL SLOPES MUST BE SURFACED ROUGHENED AND VEGETATED WITHIN SEVEN (7) DAYS OF THEIR CONSTRUCTION.
- CONTRACTOR SHALL REMOVE ALL EROSION & SEDIMENT CONTROL MEASURES AFTER COMPLETION OF CONSTRUCTION AND ESTABLISHMENT OF PERMANENT GROUND COVER.
- THE ESCAPE OF SEDIMENT FROM THE SITE 11 SHALL BE PREVENTED BY THE INSTALLATION OF EROSION CONTROL MEASURES AND PRACTICES PRIOR TO, OR CONCURRENT WITH, LAND-DISTURBING ACTIVITIES.

r				
FERTILIZER MIX				
APPLICATION	N, #/ACRE	$P_2 O_5$ , #/ACRE	K₂O, #∕ACRE	N, TOP DRESSING
1st	60 - 90	120 - 180	120 - 180	50
2nd	60	120	120	-
NOTE:	•			•

- GRASS AND MULCH ALL DISTURBED AREAS

#### HYDRAULIC SEEDING EQUIPMENT

WHEN HYDRAULIC SEEDING AND FERTILIZING EQUIPMENT IS USED, NO GRADING AND SHAPING OR SEEDBED PREPARATION WILL BE REQUIRED. THE FERTILIZER, SEED AND WOOD CELLULOSE FIBER MULCH WILL BE MIXED WITH WATER AND APPLIED IN A SLURRY. ALL SLURRY INGREDIENTS MUST BE COMBINED TO FORM A HOMOGENEOUS MIXTURE, AND SPREAD UNIFORMLY OVER THE AREA WITHIN ONE HOUR AFTER MIXTURE IS MADE. STRAW OR HAY MULCH AND ASPHALT EMULSION WILL BE APPLIED WITH BLOWER-TYPE MULCH SPREADING EQUIPMENT WITHIN 24 HOURS AFTER SEEDING, THE MULCH WILL BE SPREAD UNIFORMLY OVER THE AREA, LEAVING ABOUT 25 PERCENT OF THE GROUND SURFACE EXPOSED.

#### CONVENTIONAL SEEDING EQUIPMENT

GRADE, SHAPE AND SMOOTH WHERE NEEDED TO PROVIDE FOR SAFE EQUIPMENT OPERATION AT SEEDING TIME AND FOR MAINTENANCE PURPOSES. THE LIME AND FERTILIZER IN DRY FORM WILL BE SPREAD UNIFORMLY OVER THE AREA IMMEDIATELY BEFORE SEEDBED PREPARATION. A SEEDBED WILL BE PREPARED BY SCARIFYING TO A DEPTH OF 1 TO 4 INCHES AS DETERMINED ON SITE. THE SEEDBED MUST BE WELL PULVERIZED, SMOOTHED AND FIRMED. SEEDING WILL BE DONE WITH CULTIPACKER-SEEDER, DRILL, ROTARY SEEDER OR OTHER MECHANICAL OR HAND SEEDER. SEED WILL BE DISTRIBUTED UNIFORMLY OVER A FRESHLY PREPARED SEEDBED AND COVERED LIGHTLY. WITHIN 24 HOURS AFTER SEEDING, STRAW OR HAY MULCH WILL BE SPREAD UNIFORMLY OVER THE AREA, LEADING ABOUT 25 PERCENT OF THE GROUND SURFACE EXPOSED. MULCH WILL BE SPREAD WITH BLOWER-TYPE MULCH EQUIPMENT OR BY HAND AND ANCHORED IMMEDIATELY AFTER IT IS SPREAD. A DISK HARROW WITH THE DISK SET STRAIGHT OR A SPECIAL PACKER DISK MAY BE USED TO PRESS THE MULCH INTO THE SOIL.

SUPERINTENDENT	
BUILDING INSPECTOR	

PLANNING

BOARD CHAIR HIGHWAY

APPROVALS

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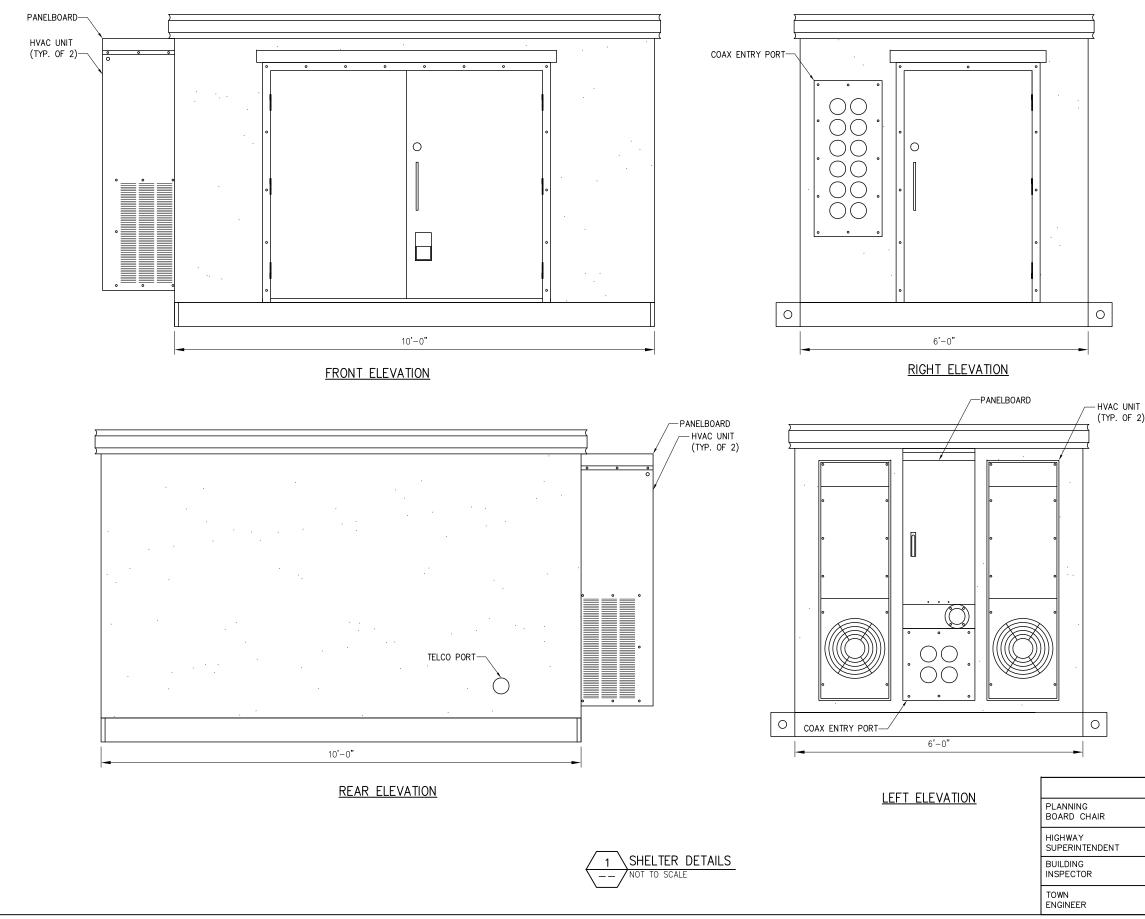
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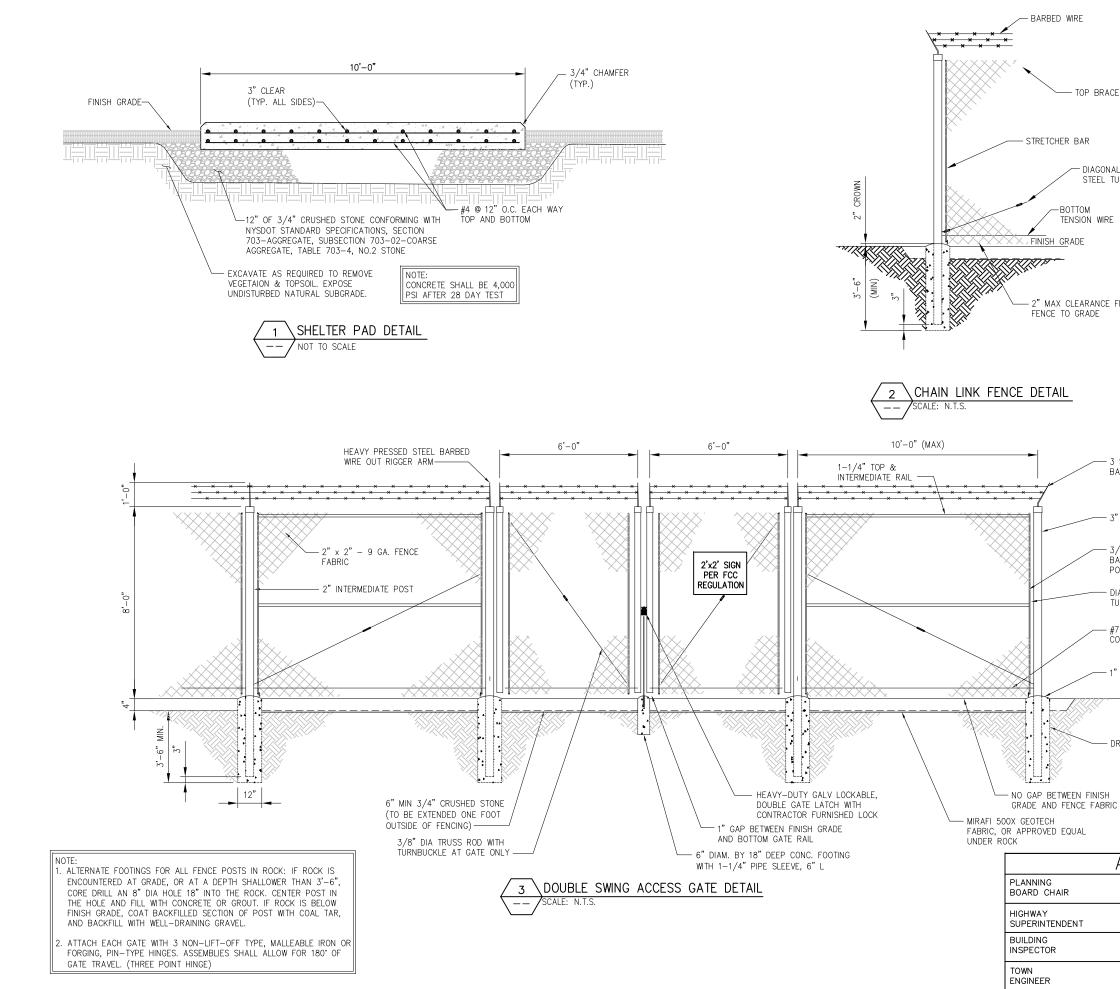
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Albany, NY 122( 518-690-0793 3m Design. Build. Deliver. CO  $\succ$ **NFINIG** TOP BRACE RAIL 33 Watervliet Shaker Road Phone: 518-690-0790 | Fa: www.infinigy. DIAGONAL ROD w/ STEEL TURNBUCKLE -BOTTOM TENSION WIRE 2" MAX CLEARANCE FROM IS A VIOLATION OF ARTICLE 145 OF THE NY EDUCATION LAW FOR ANY PERSON UNLESS HEY ARE ACTING UNDER THE DIRECTION O LICENSED PROFESSIONAL ENGINEER FROI REVISED PER COMMENT MAP 3/9 REVISED PER COMMENT MAP 3/9/1 REVISED PER COMMENT MAP 3/9 REVISED PER COMMENT MAP 3 REVISED PER COMMENT MAP 3/6/ 3 STRANDS OF 4-POINT REVISED PER COMMENT SKB 3/ ISSUED FOR REVIEW SKB 12/13 BARBED WIRE Submittal / Revision App'd Date rawn: \_\_\_\_\_\_\_\_\_\_SKB\_\_\_ Date: \_\_\_12/13/16 Designed: MSL Date: 12/13/16 Checked: MSL Date: 12/13/16 3" CORNER POST roject Number 308-038 3/16" x 3/4" STRETCHER BAR AT CORNER AND GATE roject Title POSTS RGE – ROCHESTER DIAGONAL ROD w/ STEEL GAS & ELECTRIC TURNBUCKLE #7 GA. TENSION WIRE, 5850 MONKS ROAD CONTINUOUS CANANDAIQUA, NY 14424 - 1" CROWN FOR DRAINAGE epared For - DRILLED PIER FOUNDATION **RG&E** Drawing Scale: AS NOTED Date: 3/9/17 APPROVALS Drawing Title DATE FOUNDATION PLAN DATE rawing Number DATE **C**8

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## INCOMING POWER AND TELEPHONE SERVICE NOTES:

- 1. CONNECTION TO EXISTING UTILITIES AND INCOMING POWER AND TELEPHONE SERVICES IS FOR CONCEPT ONLY. THE CONTRACTOR SHALL COORDINATE THE ACTUAL LOCATION WITH THE ELECTRIC AND TELEPHONE UTILITIES AND CARRIER.
- 2. THE CONTRACTOR IS RESPONSIBLE FOR MAKING ARRANGEMENTS WITH THE ELECTRIC AND TELEPHONE UTILITIES TO ENSURE TO A TIMELY INSTALLATION OF THE INCOMING POWER AND TELEPHONE SERVICES. THE CARRIER WILL OBTAIN AN ELECTRIC SERVICE ORDER (ESO) FOR THIS SITE PRIOR TO THE CONTRACTOR INITIATING ANY WORK ON-SITE
- 3. THE INCOMING ELECTRIC SERVICE SHALL BE INSPECTED BY THE AUTHORITY HAVING JURISDICTION AND A CERTIFICATE OF SUCH INSPECTION SHALL BE FURNISHED TO THE CARRIER WITH A COPY FORWARDED TO THAT UTILITY.
- 4. ANY UTILITY CHARGES ASSOCIATED WITH THIS SITE SHALL BE PAID BY THE CARRIER AND NO CHARGES, THEREFORE SHALL ACCRUE TO THE CONTRACTOR.
- 5. COORDINATE METER SOCKET REQUIREMENTS AND UTILITY METER ENCLOSURE WITH CARRIER. AND ELECTRIC UTILITY.
- 6. INCOMING ELECTRIC SERVICES SHALL BE IN CONFORMANCE WITH THE UTILITIES STANDARDS (LATEST EDITION).
- 7. INSTALL PULL ROPES IN ALL CONDUITS UNLESS NOTED OTHERWISE.
- 8. CONDUIT RUNS SHALL HAVE ONE 18"x18"x8" TRAFFIC RATED PULLBOX AFTER 270 DEGREES OF BEND.
- 9. CONDUIT RUNS SHALL HAVE A PULLBOX WITH A MAXIMUM SPACING OF 500 LINEAR FEET

## CODED DRAWING NOTES:

- COORDINATE EXACT LOCATION WITH UTILITY COMPANY. (1) STUB UP POWER AND TELEPHONE CONDUITS AS DIRECTED BY UTILITY COMPANY. REFER TO EQUIPMENT SPECIFICATIONS FOR ELECTRICAL REQUIREMENTS.
- (1) 4" SCH 40 PVC POWER CONDUIT WITH PULLWIRE FROM PROPOSED EQUIPMENT AREA TO EXISTING POWER SOURCE. EXACT ROUTING TO BE COORDINATED WITH UTILITY COMPANY AND CONTRACTOR TO FIELD COORDINATE CONDUIT STUB-UP LOCATION. STUB-UP 6" ABOVE GRADE AT EXISTING POWER SOURCE & EQUIPMENT AREA.
- (1) 4" SCH 40 PVC TELCO CONDUITS WITH PULL STRINGS (25  $\left\{ 3 \right\}$ PAIRS), CAT 5 RATED, ROUTED FROM PROPOSED EQUIPMENT AREA TO EXISTING TELCO SOURCE. EXACT ROUTING AND STUB-UP LOCATION TO BE FIELD COORDINATED WITH UTILITY COMPANY. STUB-UP 6" ABOVE GRADE AT TELCO DEMARC & EQUIPMENT AREA.
- (4) ALL TELCO CONDUITS SHALL USE LONG SWEEPS AT BENDS.

AMERICAN WIRE GAUGE

BARE TINNED STRANDED

DIESEL LOCOMOTIVE CABLE

EXTERIOR GROUND RING EXTERIOR ISOLATED GROUND BAR

INTERIOR GROUND RING

POLYVINYL CHLORIDE

RIGID GALVANIZED STEEL

MAIN ISOLATED GROUND BAR

MOBILE TELEPHONE SWITCHING OFFICE

10'

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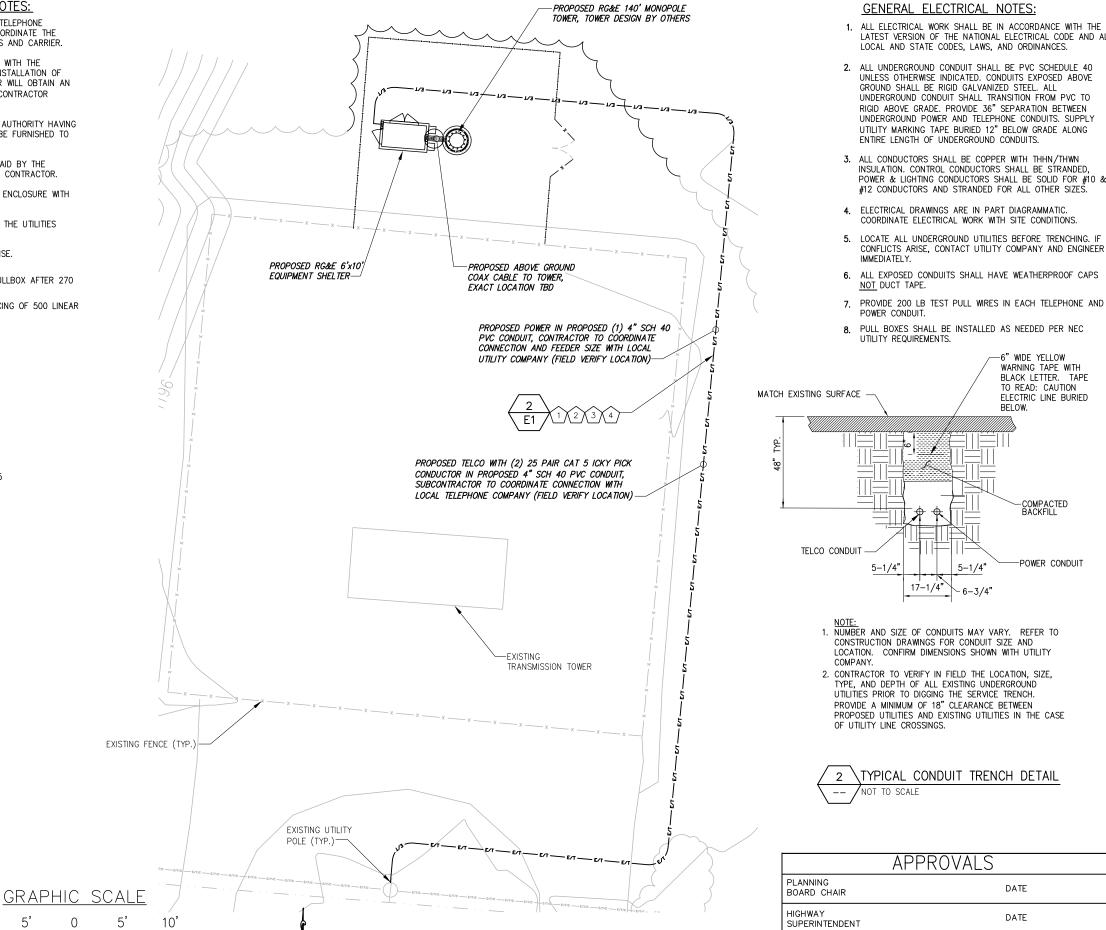
SCALE: 11"x17" SHEET 1"= 10'

SCALE: 22"x34" SHEET 1"= 5'

MULTI-GROUNDED NEUTRAL

MOBILE SWITCHING CENTER

BELOW FINISH GRADE



ELECTRIC & TELCO LAYOUT

SCALE: AS NOTED

1

CALLED NORTH

#### STAINLESS STEEL SST SELF SUPPORTING TOWER TGR TOWER GROUND RING

TYP. TYPICAL

ABBREVIATIONS

CONDUIT

CABINET

DRAWING

GROUND

AWG

BFG

BTS

CAB

DLO

DWG

EGR

EIGB

HALO

MIGB

MGN

MSC

MTSO

PVC

RGS

SS

G

С

LATEST VERSION OF THE NATIONAL ELECTRICAL CODE AND ALL

UNLESS OTHERWISE INDICATED. CONDUITS EXPOSED ABOVE UNDERGROUND CONDUIT SHALL TRANSITION FROM PVC TO RIGID ABOVE GRADE. PROVIDE 36" SEPARATION BETWEEN UNDERGROUND POWER AND TELEPHONE CONDUITS. SUPPLY UTILITY MARKING TAPE BURIED 12" BELOW GRADE ALONG

POWER & LIGHTING CONDUCTORS SHALL BE SOLID FOR #10 &

LOCATE ALL UNDERGROUND UTILITIES BEFORE TRENCHING. IF CONFLICTS ARISE, CONTACT UTILITY COMPANY AND ENGINEER

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## GROUNDING SYMBOLS


- $\otimes$ GROUND ROD
- $\square$ ACCESS WELL
- $\boxtimes$ GROUND ROD WITH ACCESS
- CADWELD TYPE CONNECTION
- COMPRESSION TYPE CONNECTION
- GROUND BAR
- #2/0 BTS COPPER CONDUCTOR BURIED GROUND CABLE 30" BELOW GRADE
- INDICATES CODED NOTE  $\langle \# \rangle$


## CODED DRAWING NOTES

- PROPOSED TOWER GROUND RING WITH #2/0 SOLID  $\left( 1 \right)$ TINNED BCW.
- $\binom{2}{2}$ BOND PROPOSED TOWER GROUND RING TO PROPOSED TOWER WITH #2/0 SOLID TINNED BCW.
- BOND PROPOSED SHELTER GROUND RING TO PROPOSED  $\langle 3 \rangle$ TOWER GROUND RING WITH #2/0 SOLID TINNED BCW (TYP. OF (2) PLACES).
- $\left(4\right)$ BOND PROPOSED SHELTER GROUND RING TO PROPOSED SHELTER WITH #2/0 SOLID TINNED BCW (TYP. OF (4) PLACES).
- PROPOSED #2/0 AWG GROUND TO ANTENNA GROUND BAR. (5) (NOT SHOWN FOR CLARITY)
- 6 BOND PROPOSED SHELTER GROUND BAR TO PROPOSED SHELTER WITH #2/0 SOLID TINNED BCW (TYP. OF (2) PLACES).
- (7) PROPOSED #2/0 AWG GROUND TO HVAC UNIT (TYP OF (2) PLACES).
- PROPOSED #2/0 AWG GROUND TO PANELBOARD. (8)
- PROPOSED #2/0 AWG GROUND TO ICE BRIDGE. (9)
- (10) PROPOSED COMPOUND GROUND RING WITH #2/0 SOLID
- BOND PROPOSED SHELTER GROUND RING TO EXISTING & PROPOSED (11)CHAIN LINK FENCE WITH #2/0 SOLID TINNED BCW
- BOND PROPOSED TOWER GROUND RING TO EXISTING & PROPOSED  $\left(12\right)$ CHAIN LINK FENCE WITH #2/0 SOLID TINNED BCW

- OR GROUND RING
- REQUIRED.

- 15'-0").
- ROD
- 250-30.

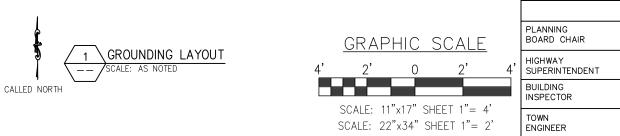

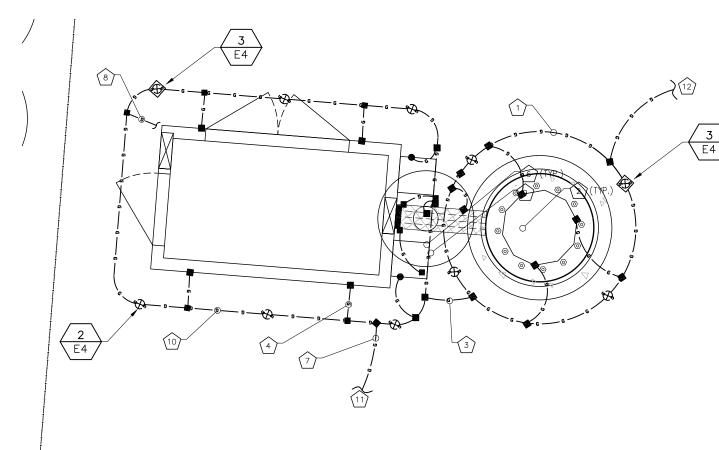

## GENERAL GROUNDING NOTES:

1. TO ENSURE PROPER BONDING, ALL CONNECTIONS SHALL BE AS FOLLOWS - #2/0 BARE TINNED SOLID COPPER CONDUCTOR: CADWELD TO RODS

- LUGS AND BUS BAR (UNLESS NOTED OTHERWISE): SANDED CLEAN, COATED WITH OXIDE INHIBITOR AND BOLTED FOR MAXIMUM SURFACE CONTACT. ALL LUGS SHALL BE COPPER (NO ALUMINUM SHALL BE PERMITTED). PROVIDE LOCK WASHERS FOR ALL MECHANICAL CONNECTIONS FOR GROUND CONDUCTORS. USE STAINLESS STEEL HARDWARE THROUGHOUT.

ALL GROUNDING CABLE IN CONCRETE OR THROUGH WALLS SHALL BE IN 2. 3/4" PVC CONDUIT. SEAL AROUND CONDUIT THROUGH WALLS. NO METALLIC CONDUIT SHALL BE USED FOR GROUNDING CONDUCTORS.

3. OWNER'S REPRESENTATIVE WILL INSPECT CADWELDS AND CONDUCT MEGGER TEST PRIOR TO BURIAL. MAXIMUM 5 OHMS RESISTANCE IS

4. DO NOT INSTALL GROUND RING OUTSIDE OF LEASED AREA.

5. MAKE ALL GROUND CONNECTIONS AS SHORT AND DIRECT AS POSSIBLE. AVOID SHARP BENDS. ALL BENDS SHALL BE A MINIMUM 8" RADIUS ANI NO GREATER THAN 90 DEGREES.

6. ALL CADWELDS TO BURIED GROUND RING SHALL BE THE PARALLEL TYPE EXCEPT FOR THE GROUND RODS WHICH SHALL BE THE TEE TYPE.

7. BOND SERVICE CONDUITS TO GROUND RING AS THEY CROSS. DO NOT EXOTHERMICALLY WELD TO CONDUITS.

8. THE CONTRACTOR SHALL NOTIFY THE CONSTRUCTION MANAGER WHEN THE GROUNDING SYSTEM IS COMPLETE. THE CONSTRUCTION MANAGER SHALL INSPECT THE GROUNDING SYSTEM PRIOR TO BACKFILLING.

9. THE MINIMUM SPACING BETWEEN GROUND RODS SHALL BE 10'-0" (MAX.

10. BOND CIGBE TO EXTERNAL GROUND RING WITH 2 RUNS OF #2 BARE, TINNED, SOLID COPPER CONDUCTOR IN PVC. CONNECT BAR END WITH HOLE LUG, AND "CADWELD" THE OTHER END TO THE EXTERNAL GROUND

11. THE PREFERRED LOCATION FOR COAX GROUNDING IS AT THE BASE OF THE TOWER PRIOR TO THE COAX BEND. BONDING IS SHOWN ON THE ICE BRIDGE DUE TO DIFFICULTY WITH WELDING OR ATTACHING TO TOWER LEGS. CONTRACTOR SHALL ADVISE CONSTRUCTION MANAGER PRIOR TO PLACING CIGBE ON ICE BRIDGE IF MOUNTING TO TOWER LEG IS POSSIBLE

12. BONDING OF THE GROUNDED CONDUCTOR (NEUTRAL) AND THE GROUNDING CONDUCTOR SHALL BE AT THE SERVICE DISCONNECTING MEANS. BONDING JUMPER SHALL BE INSTALLED PER N.E.C. ARTICLE

APPROVALS

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## **GENERAL NOTES:**

## 1. INSPECTIONS

- A. GENERAL: DURING AND UPON COMPLETION OF THE WORK, ARRANGE AND PAY ALL ASSOCIATED INSPECTIONS OF ALL ELECTRICAL WORK INSTALLED UNDER THIS CONTRACT IN ACCORDANCE WITH THE CONDITIONS OF THE CONTRACT. INSTALLATION SHALL COMPLY WITH APPLICABLE LAWS AND ORDINANCES, UTILITY COMPANY REQUIREMENTS, AND THE LATEST EDITION OF NEC, NFC, NEMA, OSHA, SBC, AND UL.
- B. INSPECTIONS REQUIRED: AS PER THE LAWS AND REGULATIONS OF THE LOCAL AND/OR STATE AGENCIES HAVING JURISDICTION AT THE PROJECT SITE.
- C. INSPECTION AGENCY: APPROVED BY THE LOCAL AND/OR STATE AGENCIES HAVING JURISDIC-TION AT THE PROJECT SITE.
- D. CERTIFICATES: SUBMIT ALL REQUIRED INSPECTION CERTIFICATES.

### 2. HANGERS AND SUPPORTS

- A. MATERIALS: ALL HANGERS, SUPPORTS, FASTENERS AND HARDWARE SHALL BE ZINC COATED OR OF EQUIVALENT CORROSION RESISTANCE BY TREATMENT OR INHERENT PROPERTY, AND SHALL BE MANUFACTURED PRODUCTS DESIGNED FOR THE APPLICATION. PRODUCTS FOR OUTDOOR USE SHALL BE HOT DIP GALVANIZED.
- B. TYPES: HANGERS, STRAPS, RISER SUPPORTS, CLAMPS, U-CHANNEL, THREADED RODS, ETC. AS INDICATED OR REQUIRED.
- C. INSTALLATION: RIGIDLY SUPPORT AND SECURE ALL MATERIALS, RACEWAY AND EQUIPMENT TO BUILDING STRUCTURE USING HANGERS, SUPPORTS AND FASTENERS SUITABLE FOR THE USE. MATERIALS AND LOADS ENCOUNTERED. PROVIDE ALL NECESSARY HARDWARE. PROVIDE CONDUIT SUPPORTS AT MAXIMUM 5 FT. O.C.
- D: STRUCTURAL MEMBERS: DO NOT CUT, DRILL, OR WELD ANY STRUCTURAL MEMBER EXCEPT AS SPECIFICALLY APPROVED BY THE ENGINEER.
- E. MISCELLANEOUS SUPPORTS: PROVIDE ANY ADDITIONAL STRUCTURAL SUPPORT STEEL BRACKETS, ANGLES, FASTENERS AND HARDWARE AS REQUIRED TO ADEQUATELY SUPPORT ALL ELECTRICAL MATERIALS AND EQUIPMENT.
- F. ONE HOLE STRAPS SHALL NOT BE USED FOR CONDUITS LARGER THAN 3/4 INCH.

#### 3. ENCLOSURES

- A. NEMA 3R
- 4. HOLES, SLEEVES AND OPENINGS

GENERAL: PROVIDE ALL HOLES, SLEEVES, AND OPENINGS REQUIRED FOR THE COMPLETION OF WORK AND RESTORE ALL SURFACES DAMAGED TO MATCH SURROUNDING SURFACES.

- 5. CUTTING AND PATCHING
- A. GENERAL: PROVIDE ALL CUTTING, DRILLING, FITTING AND PATCHING NECESSARY FOR ACCOMPLISHING THE WORK. THIS INCLUDES ANY AND ALL WORK NECESSARY TO: UNCOVER WORK TO PROVIDE FOR THE INSTALLATION OF ILL TIMED WORK, REMOVE AND REPLACE DEFEC-TIVE WORK AND WORK NOT CONFORMING TO THE REQUIREMENTS OF THE CONTRACT DOCUMENTS.
- B. REPAIRS: REPAIR ANY AND ALL DAMAGE TO WORK OF OTHER TRADES CAUSED BY CUTTING AND PATCHING OPERATIONS, USING SKILLED MECHANICS OF THE TRADES INVOLVED.
- 6. RACEWAY SYSTEMS
- A. FOR INITIAL ANCHOR TENANT: ALL CONDUIT AND ALL CONDUIT ELBOWS SHALL BE SCHEDULE 40 PVC UNLESS NOTED OTHERWISE.
- B. FOR FUTURE CARRIERS: ALL ABOVE GRADE CONDUIT AND ALL CONDUIT ELBOWS SHALL BE RIGID GALVANIZED STEEL UNLESS NOTED OTHERWISE. ALL BELOW GRADE CONDUIT (EXCEPT ELBOWS) SHALL BE SCHEDULE 40 PVC.
- C. TOWER LIGHT CIRCUIT FROM CONTROLLER TO LIGHTS SHALL BE SCHEDULE 40 PVC. RACEWAY BURIAL DEPTH SHALL BE AS PER NEC. USE CLEAN SAND BACKFILL FOR ALL BURIED RACEWAY SYSTEMS.

## 7. CONDUCTORS

USE 98% CONDUCTIVITY COPPER WITH TYPE XHHW-2 INSULATION, 600 VOLT, COLOR CODED. USE SOLID CONDUCTORS FOR WIRE UP TO AND INCLUDING NO. 8 AWG, STRANDED CONDUCTORS FOR WIRE LARGER THAN NO. 8. USE PRESSURE-TYPE INSULATED TWIST-ON CONNECTORS FOR NO. 10 AWG AND SMALLER, SOLDERLESS MECHANICAL TERMINAL LUGS FOR NO. 8 AWG AND LARGER.

## 8. ELECTRIC SERVICE

- A. GENERAL: COMPLY WITH AND COORDINATE ALL REQUIREMENTS OF THE UTILITY COMPANY.
- B. SHORT CIRCUIT RATINGS: PROVIDE EQUIPMENT WITH HIGHER FAULT CURRENT RATINGS AS NEEDED TO MATCH UTILITY COMPANY AVAILABLE FAULT CURRENT.

- 9. TELEPHONE SERVICE
- A. GENERAL: INSTALLATION SHALL BE IN ACCORDANCE WITH TELEPHONE U RULES AND REGULATIONS. UTILIZE LONG SWEEP BENDS IN ALL TELEPH

#### 10. GROUNDING SYSTEM

A. INSTALLATION: INSTALL AS INDICATED ON THE DRAWINGS AND AS REQU REPRESENTATIVE WILL INSPECT CADWELDS AND CONDUCT MEGGER TEST I MAXIMUM 5 OHMS RESISTANCE IS REQUIRED. USE CLEAN SAND AND CL. BURIED GROUND CONDUCTORS


#### 11. CHECKOUT, TESTING AND ADJUSTING

- A. CORRECTION/REPLACEMENT: AFTER TESTING BY CONTRACTOR, OWNER OF ANY DEFICIENCIES AND REPLACE MATERIALS AND EQUIPMENT SHOWN TO UNABLE TO PERFORM AT DESIGN OR RATED CAPACITY.
- B. POWER CONDUCTORS: CONTRACTOR SHALL CONDUCT A CONTINUITY & IN CONDUCTORS BETWEEN SERVICE DISCONNECT SWITCH & POWER CABINET.
- C. WHEN SITE POWER IS DERIVED FROM 3 PHASE SOURCE LOAD READINGS W RECORDED TO MAINTAIN A BALANCED LOAD AT THE PRIMARY SOURCE. TURNED TO THE OWNER'S REPRESENTATIVE.

## PLANNING BOARD CHAIR HIGHWAY SUPERINTENDER

BUILDING INSPECTOR

UTILITY COMPANY'S PHONE CONDUITS. DUIRED. OWNER'S PRIOR TO BURIAL. CLAY BACKFILL FOR OR ENGINEER, CORRECT		INPURATION OF MENTION Pesign Bellin. 1033 Watervitet Shaker Road I Albany, NY 12205 Phone: 518-690-0790 I Fax: 518-6690-0793 www.infinigy.com
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48" OR 6" BELOW FROSTLINE (WHICHEVER IS GREATER)

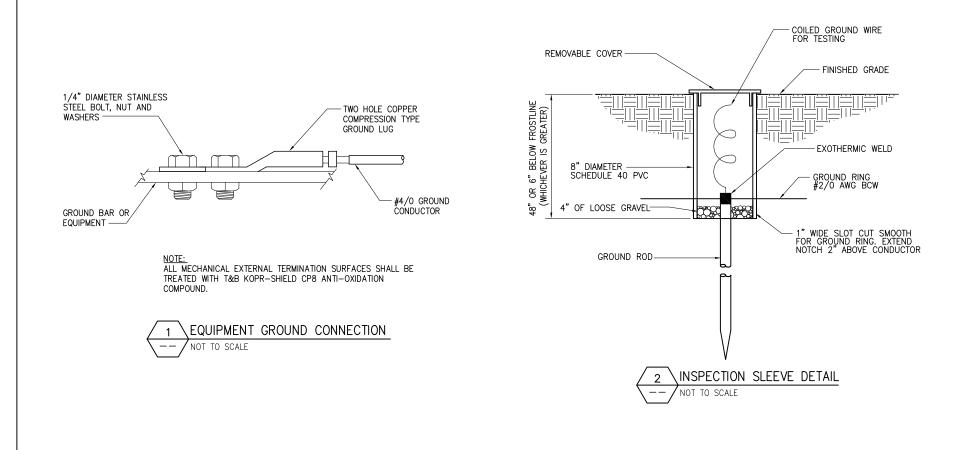

PLANNING BOARD CHAIR
HIGHWAY SUPERINTENDEN
BUILDING INSPECTOR
TOWN ENGINEER

		1033 Waterviet Shaker Road I Albany. NY 12205 Phone: 518-690-0790 I Fax: 518-690-0793 Www.infinigy.com
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