ONE STAGE(PRELIMINARY/FINAL) SITE PLAN SET FOR

LEASURE RESIDENCE 0000 MIDDLE CHESHIRE ROAD TOWN OF CANANDAIGUA ONTARIO COUNTY -- STATE OF NEW YORK



AERIAL LOCUS NOT TO SCALE

A P.K. nail found



COVER SHEET

EXISTING CONDITIONS PLAT

SITE PLAN

SITE DETAILS

ZONING CHART

AGRICULTURAL RURAL RESIDENTIAL 2 ACRE LOT

| | REQUIRED | EXISTING | PROVIDED |
|-------------------------------|----------|----------------|-----------|
| MIN LOT AREA (AREA TO ROW) | 2 ACRES | 7.781 ACRES | NO CHANGE |
| MIN LOT WIDTH | 200' | 40.0' FLAG LOT | NO CHANGE |
| MIN FRONT YARD SETBACK | 60' | N/A | 391' |
| MIN SIDE YARD SETBACK | 25' | N/A | 59.3' |
| MIN REAR YARD SETBACK | 40' | N/A | 84.2' |
| MAX BUILDING HEIGHT | 35 FT | N/A | MAX 35 FT |
| MAX BUILDING COVERAGE | 20% | N/A | 1% |
| SITE DISTURBANCE | | 41,500 SF | |



GENERAL NOTES

8. ELEVATIONS REFERENCE NAVD88 DATUM.

I. PROPERTY LINE INFORMATION SHOWN ON THIS PLAN IS BASED ON AVAILABLE RECORD

2. UTILITIES SHOWN ON THIS PLAN ARE APPROXIMATE. ACTUAL LOCATION SHALL BE FIELD VERIFIED PRIOR TO CONSTRUCTION. THE CONTRACTOR SHALL PROTECT AND MAINTAIN ALL EXISTING UTILITY SERVICES THROUGHOUT CONSTRUCTION. CONTACT U.F.P.O. AT 1-800-962-7962 AT LEAST 72 HOURS

3. THIS SITE DOES NOT FALL WITHIN ANY FEMA SPECIAL FLOOD HAZARD ZONES, THE SITE IS LOCATED IN ZONE X, PER C.P. #360598 0025 C MAP REVISED MARCH 3, 1997.

4. NO CHANGES ARE TO BE MADE TO THIS DESIGN WITHOUT PRIOR APPROVAL OF THE DESIGN

5. ALL IMPROVEMENTS SHALL BE IN ACCORDANCE WITH THE MOST RECENT STANDARDS AND SPECIFICATIONS OF THE TOWN OF CANANDAIGUA AND THE APPROPRIATE WATER/SEWER AGENCIES,

6. THE CONTRACTOR SHALL LOCATE, MARK, SAFEGUARD AND PRESERVE ALL SURVEY CONTROL MONUMENTS AND RIGHT-OF-WAY MONUMENTS IN THE AREAS OF CONSTRUCTION. 7. PROPOSED LIGHTING TO BE COORDINATED WITH THE ARCHITECT AND OWNER. LIGHTING SHALL BE DARK SKY COMPLIANT (PER CHAPTER 220, SECTION 77).

ONE STAGE SITE PLAN APPROVAL

| PLANNING BOARD CH | IAIRPERSON | DATE |
|--------------------|------------|------|
| | | |
| HIGHWAY SUPERINTEN | NDENT | DATE |

NO BUILDING PERMIT MAY BE ISSUED UNTIL FINAL SITE PLAN APPROVAL HAS BEEN GRANTED AND THE FINAL SITE PLAN SIGNED BY THE PLANNING BOARD CHAIRPERSON.

FOR PERMITTING ONLY

" Unauthorized alteration or addition to a map bearing a Licensed Professional Engineer's or Professional Land Surveyor's seal in any way is a Violation of Section 7209

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P.K. nail set X Iron pin set Concrete Monument Drill hole R.O.W. line

Iron pin or pipe found

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Drawing Title: SITE PLAN

Leasure Residence


0000 Middle Cheshire Road Town of Canandaigua State of New York County of Ontario


File# 18188 Scale N.T.S. T.m. # 126.00-1-44.111 Date: 11/14/2018 Sheet:

🗕 Canandaigua New York, 14424 📥 **–** 5120 Laura Lane **––**

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– (585)396-3267 **–––** Fax. No. (585) 396-0131 **–––** E-mail rocco@veneziasurvey.com



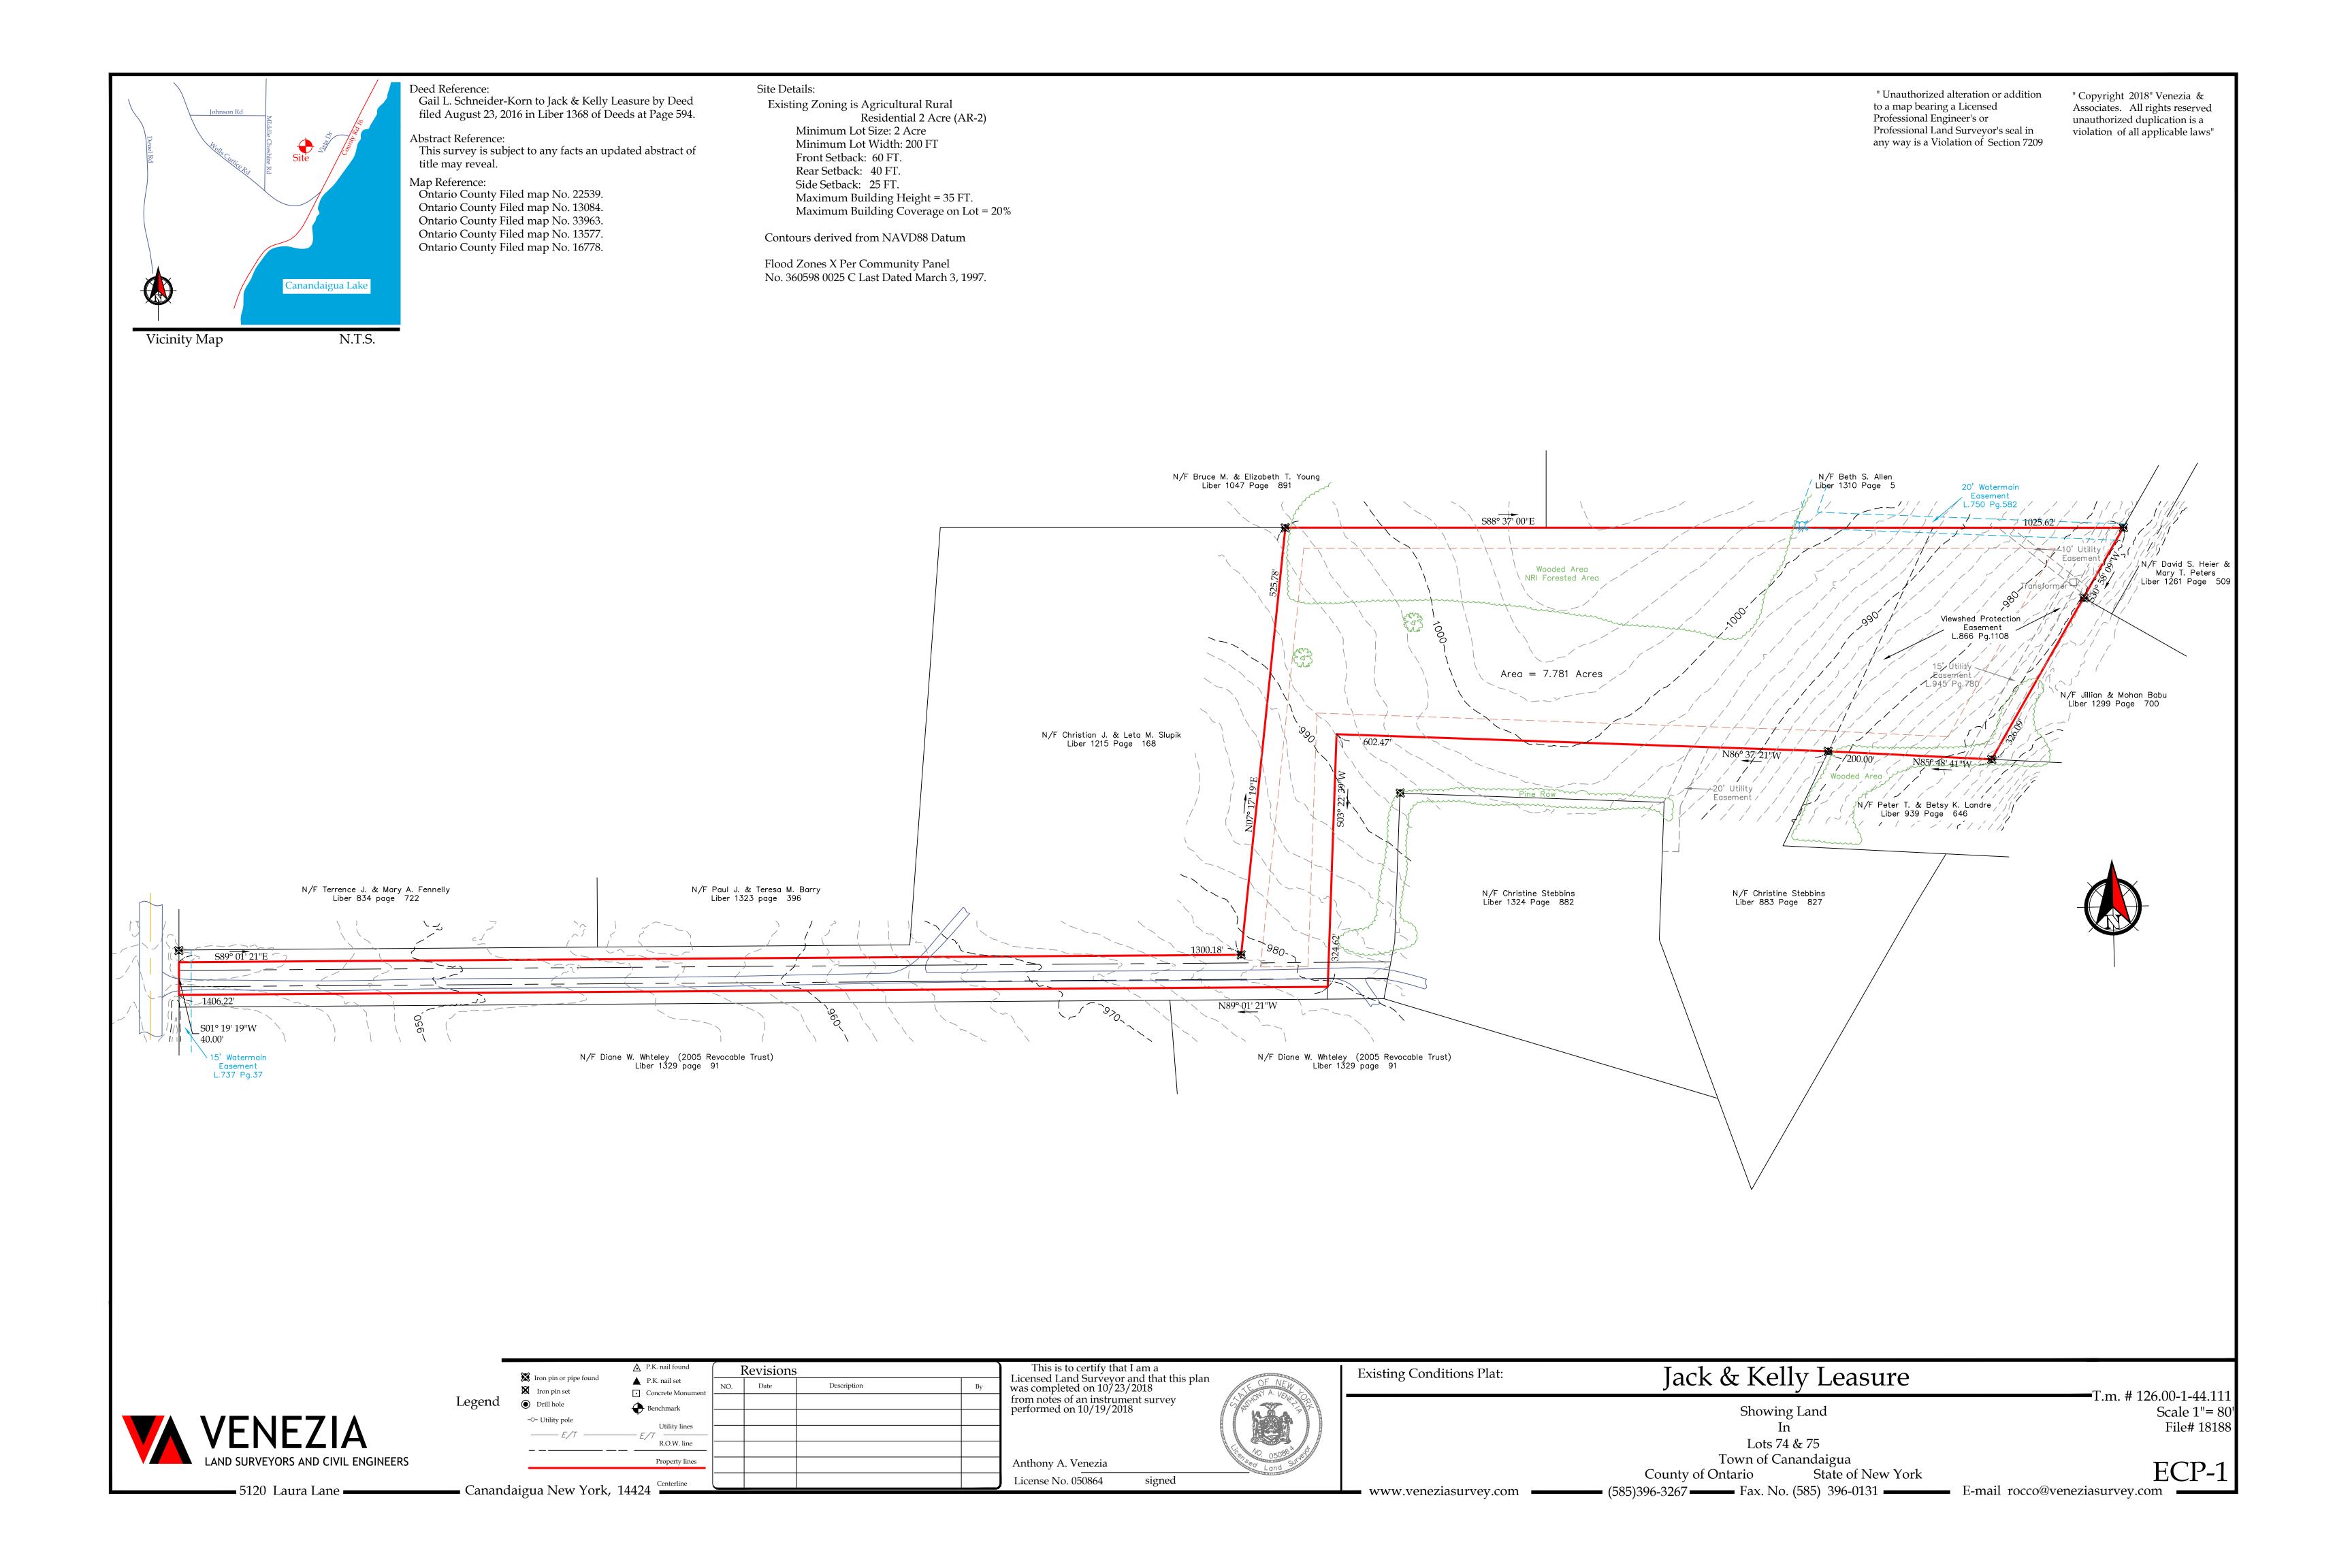

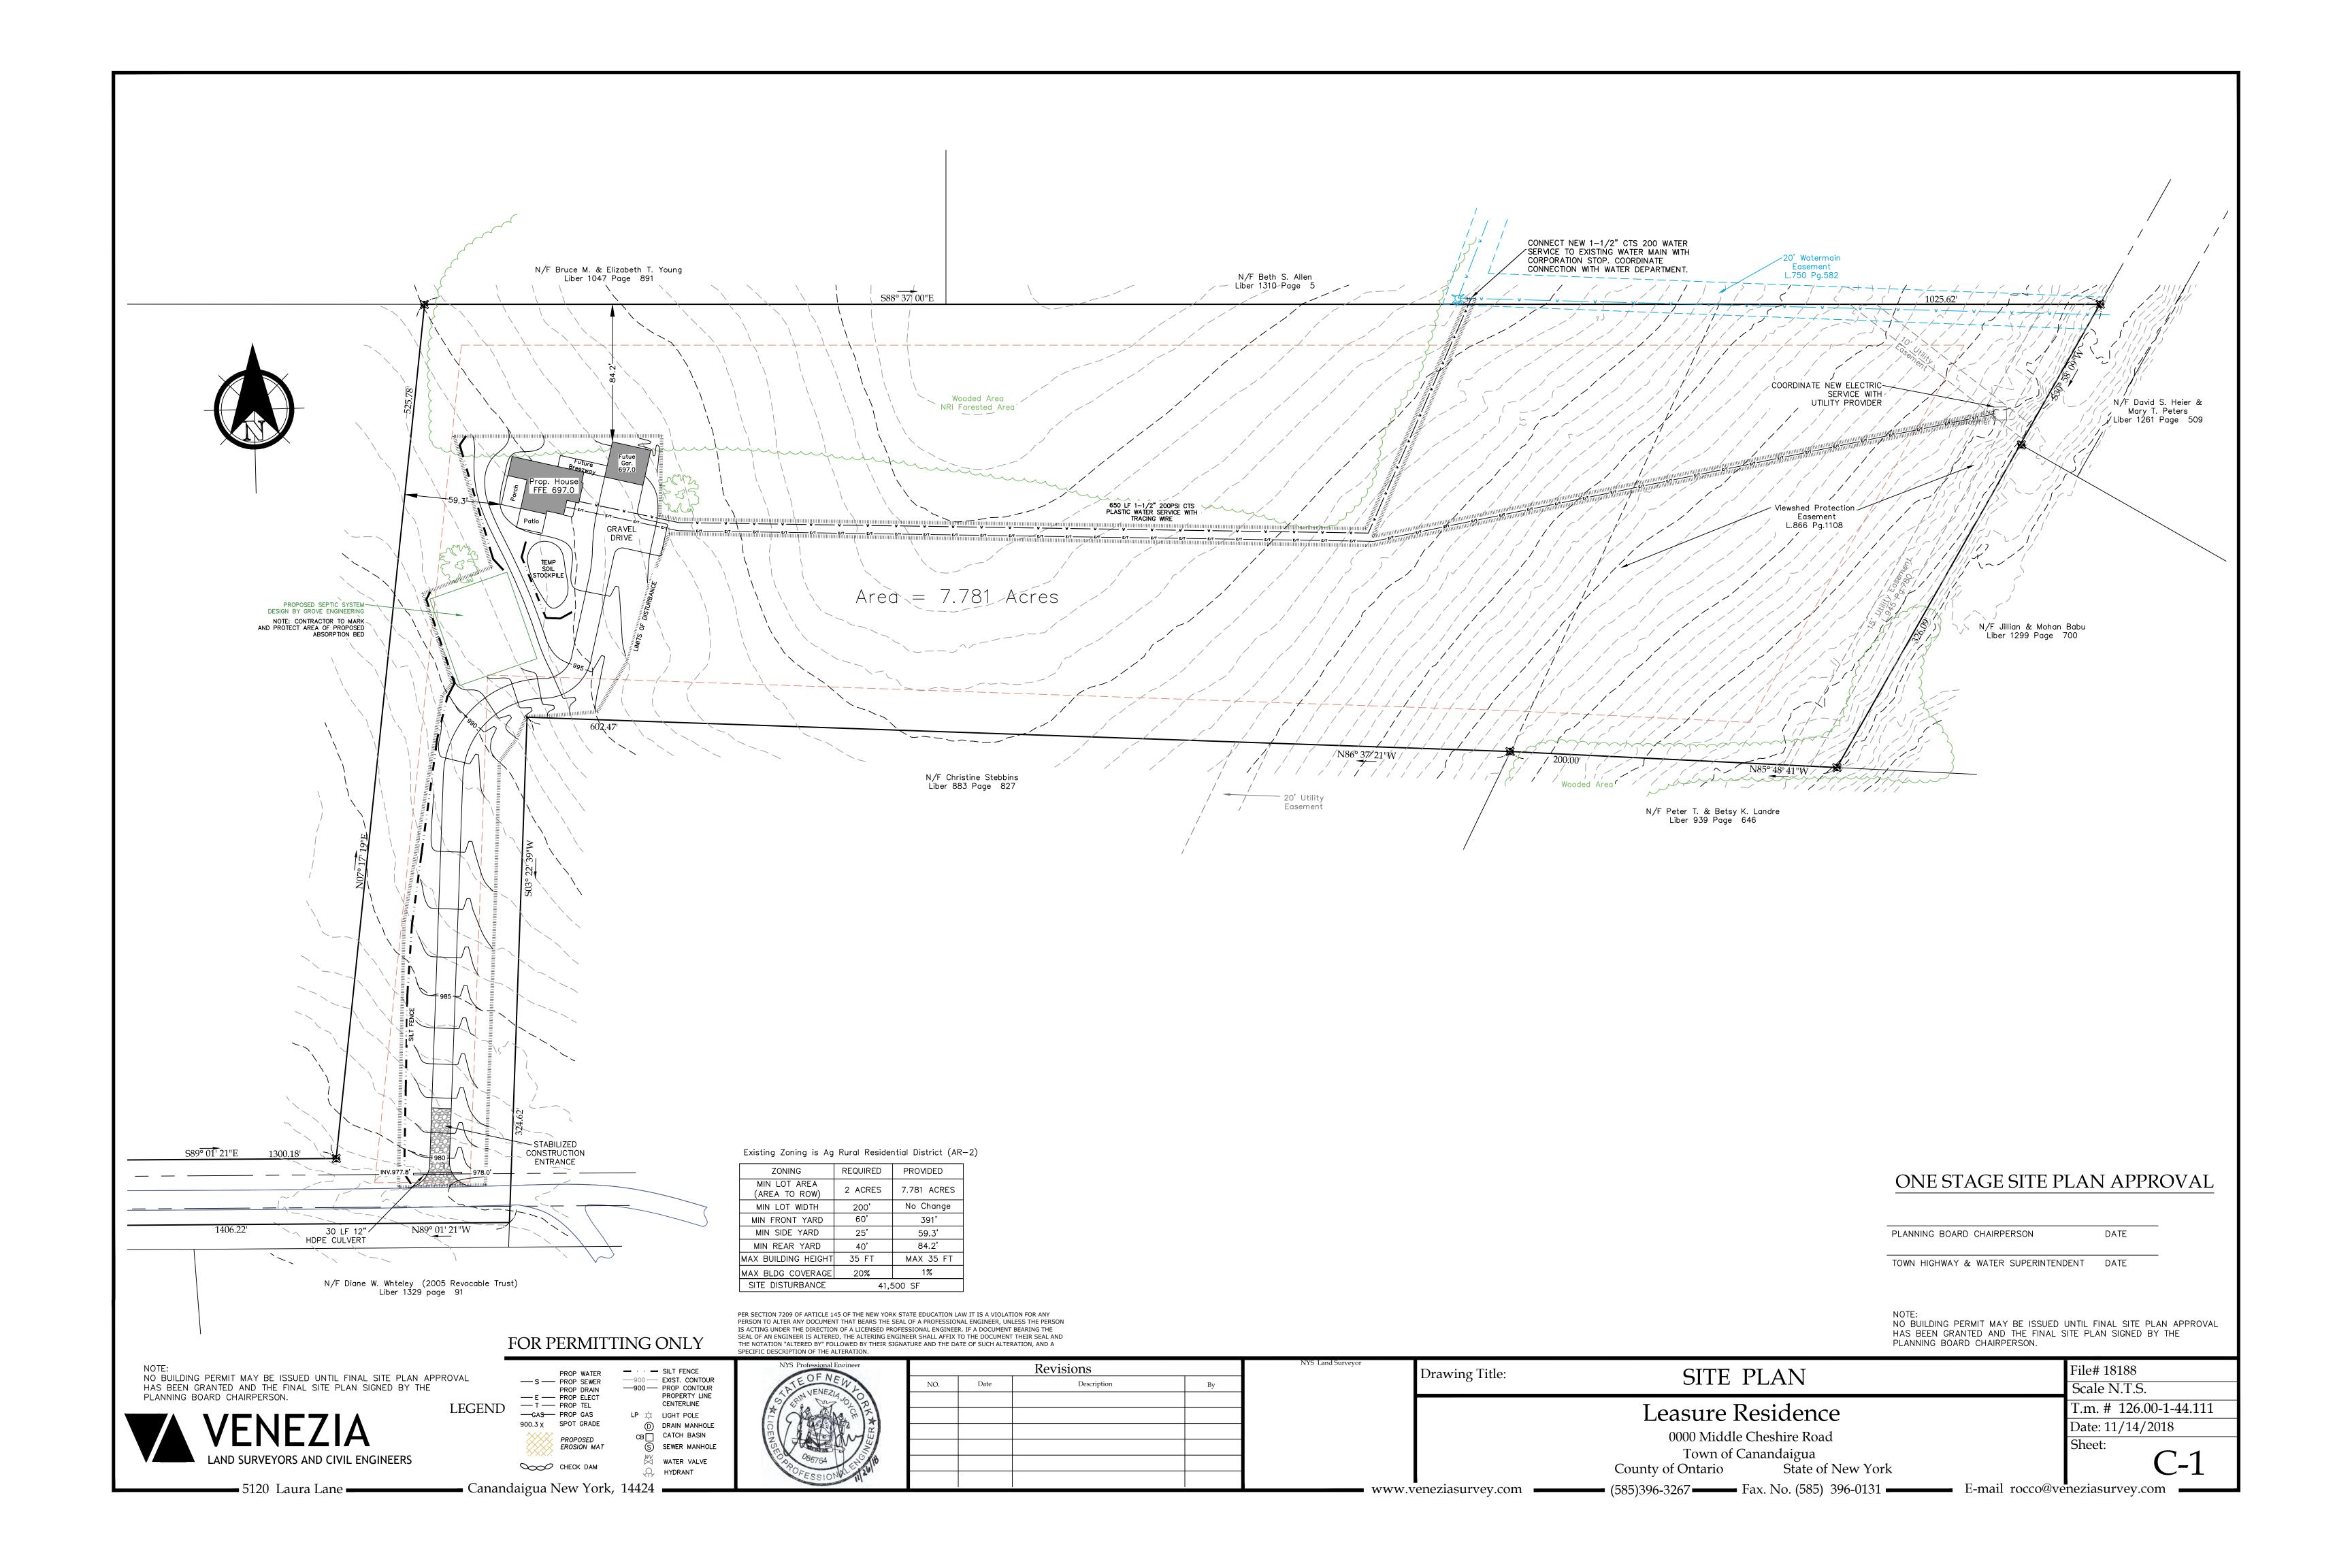FOWN OF CANANDAIGUA STANDARD NOTES

1. ALL IMPROVEMENTS SHALL BE IN ACCORDANCE WITH THE MOST RECENT STANDARDS AND SPECIFICATIONS OF THE TOWN OF CANANDAIGUA AND THE APPROPRIATE WATER / SEWER AGENCIES, UNLESS OTHERWISE NOTED.

2.SEQUENCE - THE CONTRACTOR SHALL INSTALL EROSION CONTROL MEASURES IN THE FOLLOWING SEQUENCE UNLESS AUTHORIZED OTHERWISE

- AT THE PRE- CONSTRUCTION MEETING: • INSTALL PERIMETER SEDIMENT CONTROLS, (I.E. EROSION FENCING).
- INSTALL STABILIZED CONSTRUCTION ENTRANCE.
- PROTECT VEGETATION TO REMAIN.

CEREAL RYE

PERENNIAL RYEGRASS.

THE AREAS OF CONSTRUCTION.

- COMPLETE CLEARING AND GRUBBING OPERATION.
- PLACE EROSION CONTROL MEASURES AROUND TOPSOIL STOCKPILES AND STRIP TOPSOIL LOCATIONS.
- CONSTRUCT SWALES AND SILTATION DEVICES AS EARTHWORK OPERATIONS PROGRESS. • MAINTAIN EROSION CONTROL MEASURES AND PLACE ADDITIONAL MEASURES AS EARTHWORK AND UNDERGROUND UTILITIES ARE
- CONSTRUCTED.
- RESTORE AREAS AS DEFINED BY CONTRACT DOCUMENTS. • REMOVE EROSION CONTROL MEASURES AS AREAS ARE REESTABLISHED WITH GROUND COVER.
- IF SITE PREPARATIONS OCCUR BETWEEN SEPTEMBER 1 AND MARCH 31, ADDITIONAL EROSION CONTROLS MUST BE TAKEN INCLUDING
- REDUCING THE SIZE OF DISTURBANCE AREA AND PLACING HEAVY STRAW MULCH WHERE PRACTICAL.
- 3. PLANS SHOULD INCLUDE RE-SEEDING INSTRUCTIONS INCLUDING MATERIALS AND A TIMETABLE FOR VARIOUS SEEDING
- SEED ALL CUT AND FILL, TOPSOIL PILES AND PONDS WITHIN SEVEN (7) DAYS AFTER COMPLETION. • TEMPORARY SEEDING OF DISTURBED AREAS SHALL BE PROVIDED AS FOLLOWS:

2.5

THE SURFACE TWO INCHES OF SOIL SHOULD BE LOOSENED BY DISKING, RAKING, OR BACK-BLADING WITH A BULLDOZER. IMMEDIATELY FERTILIZE. IMMEDIATELY SEED WITH THE FOLLOWING MIX:

LBS/ACRE LBS/1,000 SQ. ACRES SPRING/SUMMER/EARLY FALL ANNUAL RYE GRASS 0.7 30 0.7 PERENNIAL RYEGRASS LATE FALL/EARLY WINTER

- * NO PHOSPHOROUS SHALL BE USED AT PLANTING TIME UNLESS SOIL TESTING HAS BEEN COMPLETED AND TESTED BY A HORTICULTURAL TESTING LAB AND THE SOIL TESTS SPECIFICALLY INDICATE A PHOSPHOROUS DEFICIENCY THAT IS HARMFUL, OR WILL PREVENT NEW LAWNS AND PLANTINGS FROM ESTABLISHING PROPERLY.
- * IF SOIL TESTS INDICATE A PHOSPHOROUS DEFICIENCY THAT WILL IMPACT PLANT AND LAWN ESTABLISHMENT, PHOSPHOROUS SHALL BE APPLIED AT THE MINIMUM RECOMMENDED LEVEL PRESCRIBED IN THE SOIL TEST FOLLOWING ALL NYS DEC REGULATIONS.

SEED SHOULD HAVE A GERMINATION RATE OF AT LEAST 85 PERCENT AND MINIMAL INERT MATERIAL. DISTURBED AREAS SHALL BE STABILIZED USING PERMANENT LAWN SEEDING MIX UPON COMPLETION OF GRADING AND CONSTRUCTION:

| | LBS/ACRE | LBS/1,000 SQ. ACRE |
|--|----------|--------------------|
| BIRDSFOOT TREFOIL OR COMMON WHITE CLOVER | 8 OR 8 | 0.20 OR 0.20 |
| TALL FESCUE | 20 | 0.45 |
| REDTOP OR RYEGRASS (PERENNIAL) | 2 OR 5 | 0.05 OR 0.10 |

SEEDING RATE: 6.0 POUNDS PER 1,000 SQUARE FEET

- MULCH: STRAW OR WOOD FIBER MULCH USED WITH HYRDO SEEDING METHOD AT TWO TONS PER ACRE WITH TRACKIFIER.
- STARTING FERTILIZER: 5:10:10 AT 20 POUNDS PER 1,000 SQUARE FEET.
- FOR FALL OR EARLY WINTER, SEED WITH CERTIFIED □AROOSTOCK□WINTER RYE (CEREAL RYE) AT 100 POUNDS PER ACRE.
- PERMANENT STABILIZATION FOR STEEP SLOPES GREATER THAN 3:1 SHALL INCLUDE JUTE MESH BLANKET AND CROWN VETCH SEED WITH
- 4.THE CONTRACTOR SHALL LOCATE, MARK, SAFEGUARD AND PRESERVE ALL SURVEY CONTROL MONUMENTS AND RIGHT-OF-WAY MONUMENT IN
- 5.EXISTING UNDERGROUND UTILITIES SHOWN HEREIN WERE PLOTTED FROM FIELD LOCATIONS AND /OR UTILITY COMPANY RECORD PLANS. PRIOR TO ANY CONSTRUCTION, THE CONTRACTOR SHALL CALL THE DIG SAFELY NEW YORK (UFPO) HOTLINE AT 1-800-962-7962 FOR STAKEOUT OF EXISTING UTILITIES. THE CONTRACTOR SHALL DETERMINE EXACT LOCATION AND EVALUATION OF UNDERGROUND UTILITIES BEFORE COMMENCING CONSTRUCTION. CONTRACTOR SHALL MAKE EXPLORATION EXCAVATIONS TO LOCATE EXISTING UNDERGROUND FACILITIES SUFFICIENTLY AHEAD OF
- 6.DUST SHALL BE CONTROLLED DURING CONSTRUCTION BY THE CONTRACTOR TO MINIMIZE EFFECT ON THE ADJACENT PROPERTIES. THE CONTRACTOR SHALL IMPLEMENT DUST CONTROL MEASURES AS NEEDED AND / OR DIRECTED BY THE TOWN OF CANANDAIGUA.
- 7.THE OWNER'S CONTRACTOR SHALL BE RESPONSIBLE FOR THE ESTABLISHMENT, MAINTENANCE, CLEANING, REPAIR AND REPLACEMENT OF EROSION CONTROL MEASURES DURING SITE CONSTRUCTION.
- 8.ROOF LEADERS SHALL BE CONNECTED TO STORM SEWERS, UNLESS OTHERWISE NOTED.

CONSTRUCTION TO PERMIT REVISIONS AS REQUIRED TO MEET THE EXISTING CONDITIONS.

- 9.NO SITE PREPARATION SHALL COMMENCE UNTIL A VISUAL INSPECTION BY THE TOWN OF CANANDAIGUA CONFIRMS THE INSTALLATION OF PERIMETER SEDIMENT CONTROLS.
- 10. ANY ADDITIONAL EROSION OR SEDIMENT CONTROL DEEMED NECESSARY BY THE TOWN OR A REPRESENTATIVE THEREOF SHALL BE PROVIDED BY THE OWNER.
- 11. SEDIMENT CONTROL MEASURES ARE TO BE ESTABLISHED PRIOR TO COMMENCING EARTHWORK. SEDIMENT CONTROL MEASURES ARE TO BE MAINTAINED BY THE CONTRACTOR UNTIL UPSTREAM GROUND COVER HAS BEEN ESTABLISHED AND REMOVAL IS APPROVED BY THE TOWN OF CANANDAIGUA.
- 12. THE CONTRACTOR IS RESPONSIBLE FOR MAINTAINING, REPLACING AND SUBSEQUENTLY REMOVING TEMPORARY EROSION & SEDIMENT CONTROL DEVICES.
- 13. THE CONTRACTOR SHALL BE RESPONSIBLE FOR CLEANING ADJOINING PROPERTIES, ROADWAYS, DRAINAGE WAYS AND SINKS OF SILT ACCUMULATION AS NEEDED AND AS DETERMINED/ REQUESTED BY THE TOWN OF CANANDAIGUA.
- 14. ANY FINAL GRADE DEVIATIONS OF HOUSE PAD ELEVATIONS MORE THAN 12 INCHES SHALL BE APPROVED BY THE PLANNING BOARD.
- 15. INCIDENTAL DISTURBANCES OUTSIDE THE PROPERTY FOOTPRINT WILL BE STABILIZED AND RESTORED TO ORIGINAL OR BETTER CONDITION.

SITE PREPARATION & EARTHWORK SEQUENCE


- 1. SILT FENCING, EROSION CONTROL MEASURES AND LIMITS OF WORK BOUNDARIES ARE TO BE PLACED PER PLAN. INSTALL ABSORPTION BED PROTECTION. INSTALL CONSTRUCTION ENTRANCE. ESTABLISH STAGING AREAS AND SOIL STOCKPILE AREAS.
- 2. ESTABLISH PROPOSED DRIVEWAY AREA AND HOUSE BUILDING PAD PER SITE PLAN. INSTALL NEW UTILITY SERVICE CONNECTIONS.
- 3. INSTALL FOUNDATION/BASEMENT, GRADE, STABILIZE DRIVEWAY.
- 4. BEGIN HOUSE FRAMING.
- 5. REMOVE EROSION CONTROLS AND CEASE MONITORING ONLY AFTER APPROVAL HAS BEEN GRANTED BY THE TOWN OF CANANDAIGUA AND/OR THEIR PROJECT REPRESENTATIVE.

WATER SYSTEM NOTES


WATERMAINS AND APPURTENANCES SHALL BE CONSTRUCTED IN COMPLIANCE WITH THE MOST RECENT STANDARDS AND SPECIFICATIONS OF THE TOWN OF CANANDAIGUA AND NEW YORK STATE DEPARTMENT OF HEALTH.


2. PROVIDE 10' MINIMUM SEPARATION BETWEEN THE WATERMAIN AND SEWER MAINS. VERTICAL SEPARATION BETWEEN WATERMAINS SHALL BE MAINTAINED IN ACCORDANCE WITH THE WATERMAIN/SEWER CROSSING DETAIL. WHERE A WATERMAIN CROSSES UNDER A SEWER, ADEQUATE STRUCTURAL SUPPORT (COMPACT SELECT FILL) SHALL BE PROVIDED FOR THE SEWERS TO PREVENT EXCESSIVE DEFLECTION OF JOINTS AND SETTLING AND POSSIBLY BREAKING THE WATERMAINS.

- 3. WATERMAIN SHALL BE PVC PIPE, AWWA C-900 AND SHALL HAVE A MINIMUM OF 5-FEET OF COVER FROM FINISHED GRADE.
- 4. THE WATERMAIN SHALL BE FLUSHED PRIOR TO TESTING AND DISINFECTION WITH A MINIMUM FLUSHING VELOCITY OF 2.5 FEET PER SECOND.
- 5. THE WATERMAIN, INCLUDING FITTINGS AND VALVES, SHALL COMPLY WITH AWWA C-600 SECTION 2 SPECIFICATIONS AND SHALL BE PRESSURE AND LEAKAGE TESTED IN ACCORDANCE WITH AWWA C605 SECTION AND THE LATEST SPECIFICATIONS OF THE NYSDOH.
- 6. DISINFECTION SHALL BE ACCOMPLISHED AFTER THE PIPE HAS PASSED THE HYDROSTATIC TESTS AND SHALL BE IN CONFORMANCE WITH AWWA C-651, LATEST REVISION, BY USING THE CONTINUOUS FEED METHOD. FOLLOWING FLUSHING, SAMPLES OF THE WATER SHALL BE COLLECTED FROM THE MAIN. FIRE HYDRANTS ARE NOT ACCEPTABLE SAMPLING POINTS. WATER SAMPLE COLLECTION SHALL BE THE RESPONSIBILITY OF THE CONTRACTOR AND ANALYSIS OF THE SAMPLES SHALL BE PERFORMED BY A NYS DEPARTMENT OF HEALTH APPROVED LABORATORY. THE WATERMAIN SHALL NOT BE PLACED IN SERVICE UNTIL A "COMPLETED WORKS APPROVAL" CERTIFICATE HAS BEEN ISSUED BY THE NYS DEPT. OF

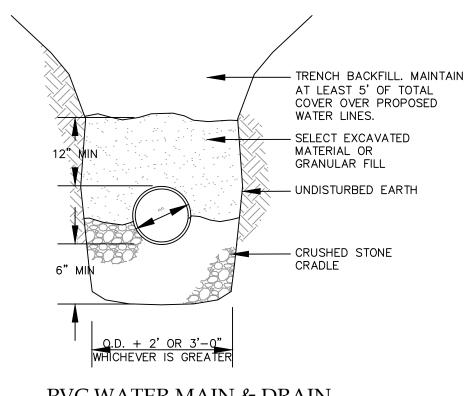

PVC WATER MAIN & DRAIN BEDDING DETAIL NOT TO SCALE

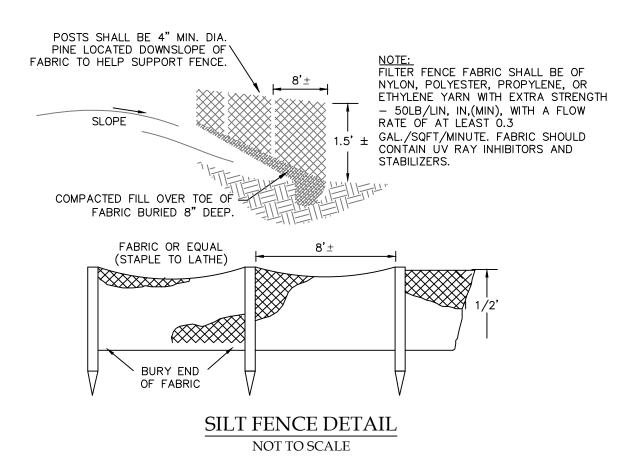

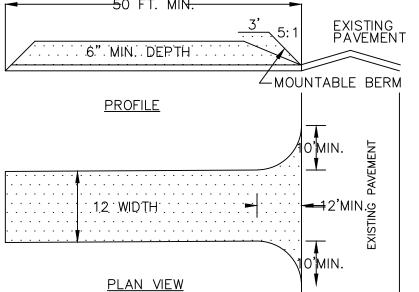


1. STONE SIZE - USE #2 STONE

- 2. THICKNESS NOT LESS THAN 6 (SIX) INCHES.
- 3. WIDTH FULL ENTRANCE WIDTH
- 4. USE FILTER FABRIC UNDER STONE FOR ENTRANCE STABILITY.
- 5. MAINTENANCE THE CONTRACTOR SHALL MAINTAIN THE ENTRANCE IN A CONDITION WHICH WILL PREVENT TRACKING OR SEDIMENT FLOW
- WHEN HIGHWAY WASHING IS REQUIRED, IT SHALL BE DONE IN A MANNER THAT DIRECTS SEDIMENT RUNOFF TOWARDS EROSION CONTROL DEVICES. INSTALL ADDITIONAL EROSION CONTROLS, IF NEEDED.
- '. PERIODIC INSPECTION AND MAINTENANCE SHALL BE PROVIDED AFTER EACH RAINSTORM.

STABILIZED CONSTRUCTION ENTRANCE DETAILS

NOT TO SCALE

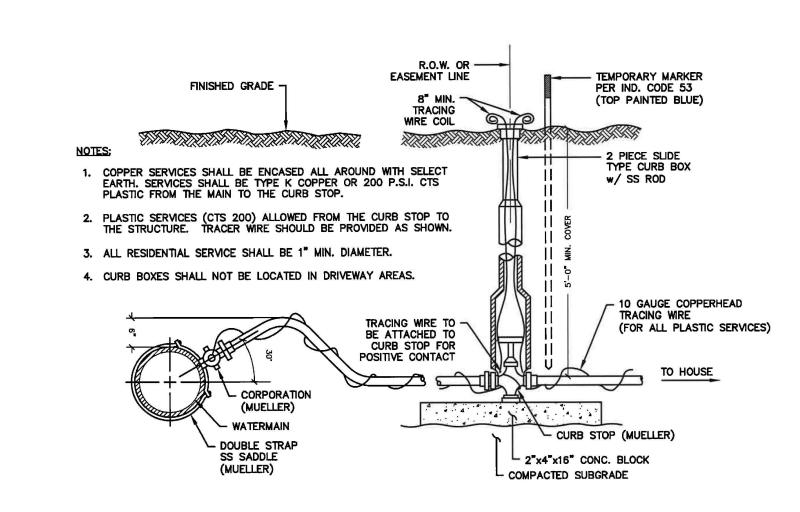

TYPICAL WATER SERVICE CONNECTION DETAIL NOT TO SCALE

ONE STAGE SITE PLAN APPROVAL

PLANNING BOARD CHAIRPERSON

DATE

File# 18188

Scale N.T.S.

Date: 11/14/2018

T.m. # 126.00-1-44.111

TOWN HIGHWAY & WATER SUPERINTENDENT

NO BUILDING PERMIT MAY BE ISSUED UNTIL FINAL SITE PLAN APPROVAL HAS BEEN GRANTED AND THE FINAL SITE PLAN SIGNED BY THE PLANNING BOARD CHAIRPERSON.

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PLANNING BOARD CHAIRPERSON.

- SILT FENCE PROP WATER ---900 --- EXIST, CONTOUR - S --- PROP SEWER -900 - PROP CONTOUR — E — PROP ELECT - T - PROP TEI LIGHT POLE 900.3 X SPOT GRADE D DRAIN MANHOLE CATCH BASIN PROPOSED SEWER MANHOLE EROSION MAT

PROPERTY LINE

CENTERLINE

WATER VALVE

SPECIFIC DESCRIPTION OF THE ALTERATION.

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Drawing Title:

Leasure Residence 0000 Middle Cheshire Road Town of Canandaigua

SITE AND UTILITY DETAILS

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CHECK DAM State of New York County of Ontario A HYDRANT **–** 5120 Laura Lane **––– —** Canandaigua New York, 14424 — (585)396-3267 — Fax. No. (585) 396-0131 — E-mail rocco@veneziasurvey.com = www.veneziasurvey.com