
## NEW GARAGE SITE PLAN PREPARED FOR:

# MARC LAJEUNESSE

MIDDLE CHESHIRE ROAD
TOWN OF CANANDAIGUA
COUNTY OF ONTARIO
STATE OF NEW YORK
AUGUST 8, 2019

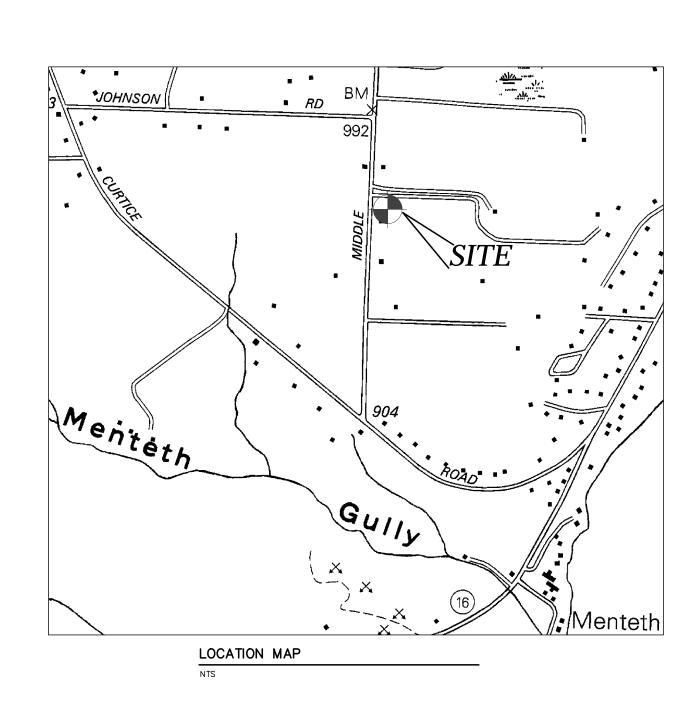



AERIAL MAP (ONCOR) - FOR REFERENCE ONLY

INDEX-

COVER

G001 - GENERAL NOTES

C100 - RESIDENTIAL SITE PLAN


C500 - GENERAL DETAILS

PREPARED FOR:

MARC LAJEUNESSE

PROPERTY OWNER:

PAUL J. & TERESA M. BARRY 4531 MIDDLE CHESHIRE ROAD CANANDAIGUA, NEW YORK

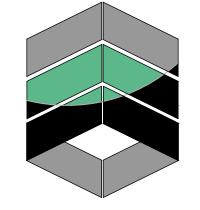

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#### SITE NOTES:

- THE CONSTRUCTION SITE IS NOT WITHIN 100' OF A WETLAND AS DELINEATED BY NYS DEC. THERE ARE NOT NYS DEC DELINEATED OR APPARENT WETLANDS ON THE PROPERTY AS SHOWN.
- 2. THE CONSTRUCTION SITE IS NOT WITHIN A 100 YEAR FLOODPLAIN AS DELINEATED BY FEMA MAP#361300B DATED FEBRUARY 27, 1984.
- 3. WATER SUPPLY: PUBLIC WATER TOWN OF CANANDAIGUA
- 4. NYS SPDES PERMIT IS NOT REQUIRED FOR THESE CONSTRUCTION ACTIVITIES, DISTURBANCE SHALL BE LESS THAN ONE ACRE. IF THE CONTRACTOR OR OWNER AT ANY TIME PLAN DISTURB GREATER THAN AN ACRE THE ENGINEER SHALL BE NOTIFIED.
- 5. ALL NEW OUTDOOR LIGHTING ON SHALL HAVE APPROPRIATE SHIELDS AND CUT-OFF TO LIMIT ILLUMINATION OF OTHER PROPERTIES. ALL LIGHTS SHALL BE DARK SKY COMPLIANT.
- 6. ELEVATION DATUM: NAVD 88 GEOID 12B

**EROSION AND SEDIMENT CONTROL NOTES:** 

#### DRIVEWAY, AND GRADING NOTES:

- DRIVEWAY SHALL NOT EXCEED 12% TRAVERSING SLOPE AND 2% CROSS SLOPE.
- DRIVEWAY SHALL BE MINIMUM 12 FEET IN WIDTH. 3. DRAINAGE SWALES SHALL HAVE A MINIMUM DEPTH OF 12" AND MINIMUM WIDTH OF 4'. SWALES SHALL HAVE A LINEAR SLOPE OF
- MINIMUM 2% (1' RISE PER 50' RUN) AND MAXIMUM SIDE SLOPE OF 1' RISE PER 3' RUN. 4. ALL WORK WITHIN RIGHT-OF-WAY SHALL BE PERMITTED BY NYS

### DOT AND COORDINATE W/ INSPECTOR.

- THE CONTRACTOR IS RESPONSIBLE FOR THE CONTROL OF EROSION AND SEDIMENTATION DURING CONSTRUCTION. SILT FENCE SHALL BE INSTALLED AND MAINTAINED AS NEEDED.
- SOIL DISTURBANCES SHALL BE STABILIZED IMMEDIATELY. DISTURBED SOIL THAT WILL REMAIN LONGER THAN 14 DAYS SHALL BE TEMPORARILY STABILIZED WITHIN 7 DAYS. SOIL SHALL BE STABILIZED WITH NORTHERN GRASS SEED MIXTURE OR APPROPRIATE SEED MIXTURE FOR CONDITIONS. GRASS SEED SHALL BE INSTALLED PER MANUFACTURES SPECIFICATIONS. MULCH STRAW APPLIED AT A RATE OF 2 BALES / 1000 SQFT OR SEED MIXTURE TO PROTECT SITE UNTIL SEED GERMINATES. HYDRO-SEED MAY BE INSTALLED AS AN ALTERNATE.
- 3. CONTRACTOR SHALL INSPECT THE SITE DAILY FOR SIGNS OF EROSION. IF ANY EROSION OR SEDIMENTATION OCCUR CONTRACTOR SHALL IMMEDIATELY PROVIDE PROPER CONTROLS TO STABILIZE THE SITE.
- ENGINEER WILL RECOMMEND CONTROLS IF REQUIRED. 4. SLOPE GREATER THAN 4 ON 1 SHALL BE STABILIZED WITH JUTE FABRIC INSTALLED AS PER MANUFACTURES SPECIFICATIONS AS
- ALL EROSION AND SEDIMENTATION CONTROL MEASURES SHALL BE IN STALLED IN ACCORDANCE WITH NYS STANDARDS AND SPECIFICATIONS FOR EROSION AND SEDIMENTATION CONTROLS. INSTALL AND MAINTAIN TEMPORARY DIVERSION SWALES AS NEEDED TO
- CONTROL RUNOFF DURING CONSTRUCTION. THE SITE SHALL BE COMPLETELY STABILIZED FOLLOWING CONSTRUCTION ACTIVITIES AND ALL TEMPORARY EROSION CONTROL DEVICES SHALL BE
- REMOVED AND DISPOSED OF PROPERLY.

#### **GENERAL NOTES:**

- THE CONTRACTOR SHALL MAINTAIN ALL UTILITIES AND PROPERTY MARKERS. IT IS THE NYS LAW TO CALL NYS DIG SAFE FOR UFPO (811) PRIOR TO ANY
- 2. THE ROADWAY SHALL BE KEPT FREE OF DEBRIS DURING CONSTRUCTION. 3. THE CONTRACTOR IS RESPONSIBLE FOR SAFETY CONTROL DEVICES. SUCH DEVICES (BARRICADES, FENCING, ETC.) SHALL BE IMPLEMENTED TO MINIMIZE RISK OF INJURY TO PEDESTRIANS AND WORKERS. CONSTRUCTION ACTIVITY
- SHALL BE CONDUCTED WITHIN COMPLIANCE WITH OSHA GUIDELINES. PLANS ARE GRAPHIC REPRESENTATIONS OF WORK TO BE PERFORMED. THESE
- PLANS ARE TO INTENDED TO CONVEY ENGINEERING INFORMATION ONLY. CONTRACTOR TO VERIFY ALL LOCATIONS, GRADES AND INVERTS AND NOTIFY
- ENGINEER OF ANY DISCREPANCIES PRIOR TO THE START OF WORK.
- ALL SPECIFIED MATERIALS ARE TO BE INSTALLED AS PER MANUFACTURES RECOMMENDATIONS OR INDUSTRY STANDARD.
- ANY SYSTEM MODIFICATIONS OR DEVIATIONS FROM THE APPROVED PLANS, NYS BUILDING CODES, AND/OR LOCAL REGULATIONS REQUIRED BY SITE CONSTRAINTS, UNFORESEEN CONDITIONS OR GOVERNING AUTHORITIES WILL BE DONE AT THE RISK OF THE CLIENT.

### LANDSCAPING PLAN NOTES:

- 1.ONE YEAR GUARANTEE TO BE PROVIDED BY THE CONTRACTOR ON ALL PLANT MATERIAL FROM DATE OF FINAL ACCEPTANCE.
- 2. ALL EXISTING PAVEMENT, BASE STONE AND UNSUITABLE SUBGRADE MATERIAL IN NEW PLANTING BEDS TO BE REMOVED TO PROVIDE DEPTH FOR SUITABLE PLANTING BACKFILL MATERIAL AS DIRECTED AND APPROVED BY THE ENGINEER.
- ALL PLANTS SHALL MEET OR EXCEED THE REQUIREMENTS SET FORTH IN THE LATEST EDITION OF THE AMERICAN STANDARD FOR NURSERY STOCK BY THE AMERICAN ASSOCIATION OF NURSERYMEN, ANSI Z60.1.
- PLANTING BACKFILL MIXTURE TO CONSIST OF 4 PARTS TOPSOIL AND 1 PART PEAT MOSS. PROVIDE 10 LBS. OF 5-10-5 FERTILIZER PER 1 CUBIC YARD OF PLANTING BACKFILL TO DEPTH OF 2'-0".
- 5. LANDSCAPING CONTRACTOR IS RESPONSIBLE FOR OBTAINING ALL NECESSARY PERMITS AND FOR ALL LANDSCAPING WORK IF REQUIRED BY THE TOWN OF CANANDAIGUA.
- LANDSCAPING CONTRACTOR WILL INFORM THE ENGINEER/LANDSCAPE ARCHITECT ABOUT ANY UNDERGROUND UTILITIES OR STRUCTURES NOT PREVIOUSLY IDENTIFIED OR FIELD
- . ALL SHRUB PLANTING BEDS TO RECEIVE 2" LAYER OF CLEAN, WASHED PEA GRAVEL MULCH PERMEABLE WEED BARRIER.
- . ALL PERMANENT LAWN AREAS ARE TO RECEIVE 6" OF TOPSOIL AND THE FOLLOWING LAWN 65% KENTUCKY BLUEGRASS AT 2.5 LBS PER 1,000 S.F. 20% PERENNIAL RYEGRASS AT 1.0 LBS PER 1,000 S.F.

15% FINE FESCUE AT 0.6 LBS PER 1,000 S.F.

0	Iron pin or pipe found	EXISTI:	NG — elec		PROPOSED	Utility Lines
7	Benchmark				· — ´— —	R.O.W. lin
Ø	Utility pole					Easement .
•	Hydrant				. <u> </u>	Centerline Drainage
•	Light pole					Fence Lin
PEI TE	DEEF			99		Contour
	ABBREVIATIONS: EX-EXISTING CPP-CORRUGATED POI O.CON CENTER SICPP-SMOOTH INTERI POLYETHYLENE PIPE UG-UNDERGROUND CONC-CONCRETE		CO -CLEAN TYP-TYPICAL R-RADIUS BC-BOTTOM TC-TOP OF TW-TOP OF BW-BOTTOM BS-BOTTOM	OF CURB CURB WALL OF WALL	PERF—PERFORATED MIN—MINIMUM MAX—MAXIMUM INV—INVERT CB—CATCH BASIN MH—MANHOLE DI—DRAINAGE INLET	

LEGEND

#### **SEPTIC TANK NOTES:**

- 1. A NEW 1250 GAL 2 COMPARTMENT CONCRETE AS MANUFACTURED BY KISTNER OR EQUAL SHALL BE INSTALLED ON MIN 12" OF COMPACTED CLEAN SAND OR 5" WASHED AGGREGATE 3/4-1 1/2". TANK SHALL BE INSTALLED PER MANUFACTURES RECOMMENDATIONS.
- 2. PROVIDE PRECAST 7-HOLE DISTRIBUTION BOX SET ON MIN 12" COMPACTED SAND.
- 3. PROVIDE RISER ON TANKS IF BURIED AT A DEPTH MORE THAN 12".
- 4. MAINTENANCE: SEPTIC TANK SHALL BE INSPECTED ANNUALLY TO DETERMINE SCUM AND SOLIDS ACCUMULATION. MOST TANKS SHOULD BE PUMPED OUT EVERY 2-3 YEARS. SEPTIC TANKS MUST BE PUMPED OUT WHENEVER THE BOTTOM OF THE SCUM LAYER IS WITHIN 3" OF THE BOTTOM OF THE OUTLET BAFFLE OR THE TOP OF THE SLUDGE IS WITHIN 10" OF THE BOTTOM OF THE OUTLET BAFFLE.

#### WASTEWATER TREATMENT SYSTEM NOTES:

- 1. THESE PLANS ARE PREPARED IN COMPLIANCE WITH THE PUBLIC HEALTH LAW, APPENDIX 75-A, OF PART 75, OF THE ADMINISTRATIVE RULES AND REGULATIONS CONTAINED IN CHAPTER 10, OF TITLE 10 (HEALTH) OF THE OFFICIAL COMPILATION OF CODES, RULES, AND REGULATIONS OF THE STATE OF NEW YORK.
- 2. ABSORPTION TRENCHES SHALL BE INSTALLED PARALLEL TO CONTOURS. CONTOURS SHOWN ARE GRAPHIC REPRESENTATIONS OF SITE. CONTRACTOR IS TO VERIFY GRADE AND LAYOUT OF ABSORPTION TRENCH PRIOR TO CONSTRUCTION.
- 3. AT NO TIME SHALL ANY MACHINERY OR VEHICLE DRIVE OVER TRENCHES. TRACKED EQUIPMENT CAN BE DRIVEN PERPENDICULAR TO TRENCHES AS REQUIRED TO BACKFILL BUT NOT IN EXCESS.
- 4. THE CONTRACTOR IS TO NOTIFY ENGINEER AFTER COMPLETION OF WORK, WHILE SYSTEM IS OPEN AND SCHEDULE
- FINAL INSPECTION. AFTER FINAL INSPECTION BY THE ENGINEER, THE SYSTEM MAY BE CLOSED. 5. THE SYSTEM SITE IS TO BE SEEDED, MULCHED, AND RETURNED TO THE VEGETATIVE STATE AS SOON AS POSSIBLE.
- 6. THE SYSTEM IS TO BE KEPT MOWED AT ALL TIMES, FREE OF TRAFFIC OR HEAVY WHEELED VEHICLES, AND FREE OF SHRUB OR TREE CANOPY FOR THE DURATION OF ITS USE.
- 7. DO NOT ATTEMPT TO INSTALL SYSTEM ON FROZEN GROUND, WET CONDITIONS OR LEAVE SYSTEM UNCOVERED FOR EXTENDED PERIODS OF TIME. 8. NO HOT TUBS, SAUNAS, ROOF DRAINS, WATER CONDITIONING BACKWASH SYSTEMS, SUMP CROCKS ETC. SHALL BE
- INCORPORATED INTO THIS SYSTEM UNLESS OTHERWISE SPECIFIED. 9. EXPANSION AREA SHALL REMAIN CLEAR OF ALL LANDSCAPING, SHRUBS, TREES, AND STRUCTURES. THE EXPANSION AREA SHALL BE MAINTAINED AS LAWN. FUTURE ACCESS TO THIS AREAS SHALL NOT BE LIMITED.
- 10. SOIL PIPE AND HOUSE SHALL BE VENTED THROUGH THE ROOF OF THE NEW DWELLING W/ AT LEAST ONE 3" VENT MAXIMUM OF 4' HORIZONTALLY AWAY FROM INSIDE OF FOUNDATION WALL. A 4" CLEAN-OUT SHALL BE PROVIDED AT
- A POINT JUST INSIDE THE FOUNDATION WALL. 11. A SYSTEM SHALL NOT BE BUILT IN UNSTABILIZED FILL MATERIAL. THE FILL MATERIAL SHALL BE ALLOWED TO SETTLE NATURALLY FOR A PERIOD OF AT LEAST SIX MONTHS TO INCLUDE ONE FREEZE-THAW CYCLE OR MAY BE STABILIZED BY MECHANICAL COMPACTION IN SHALLOW LIFTS IF A FILL MATERIAL CONSISTING OF ONLY A GRANULAR SAND OR
- 12. THE ABSORPTION TRENCHES SHALL BE CONSTRUCTED IN THE FILL MATERIAL.
- 13. THE ENTIRE SURFACE OF THE SYSTEM INCLUDING THE TAPERS SHALL BE COVERED WITH A MINIMUM OF SIX INCHES OF TOPSOIL, MOUNDED TO ENHANCE THE RUNOFF OF RAINWATER FROM THE SYSTEM AND SEEDED TO GRASS. 14. PERCOLATION TESTS SHALL BE CONDUCTED IN THE FILL MATERIAL AT THE BORROW PIT AND AFTER PLACEMENT AND
- SETTLING AT THE CONSTRUCTION SITE. THE SLOWER PERCOLATION RATE OF THESE TESTS SHALL BE USED FOR

- **UTILITY NOTES:** 1) CONTRACTOR SHALL VERIFY LOCATION OF EXISTING SERVICE
- AND COORDINATE ALL WORK W/ UTILITY PROVIDERS. RELOCATE WATER AND SANITARY PIPING AS REQUIRED.
- 2) ELEC SERVICE AND COMMUNICATION SHALL MEET CURRENT

#### **GRADING NOTES:**

- 1. CUT AND FILL SLOPES SHALL NOT EXCEED 3 ON 1.
- CONSTRUCTION SHALL CONFORM TO THE TOWN OF CANANDAIGUA AND NYS CODES AND STANDARDS
   SITE SHALL BE GRADED SUCH THAT THERE IS POSITIVE
- . SITE SHALL BE GRADED SUCH THAT THERE IS PUSITIVE DRAINAGE AT A MINIMUM OF 2% AWAY FROM ANY BUILDINGS, STRUCTURES, DRIVEWAYS, AND SEPTIC SYSTEM.

  TOPSOIL SHALL BE STRIPED OF AREAS PLANNED FOR CONSTRUCTION AND REAPPLIED AFTER GRADING IS FINISHED. ANY UNUSED TOPSOIL SHALL BE HAULED OFF SITE.

#### **CONSTRUCTION SEQUENCE:**

- 1. INSTALL TEMPORARY EROSION CONTROL MEASURES INCLUDING BUT NOT LIMITED TO: SILT FENCE, STABILIZED ENTRANCES, ETC.
- 2. THE CONTRACTOR SHALL SELECTIVELY REMOVE VEGETATION AND ROOTS AS
- 3. PLACE SILT FENCE FOR STOCKPILE AREA
- 4. STRIP TOPSOIL. 5. CONSTRUCT BUILDING AND INSTALL UTILITIES
- 6. MAINTAIN EROSION CONTROL PRACTICES AS NECESSARY. IF ADDITIONAL MEASURE ARE REQUIRED THESE SHALL BE PROVIDED AT THE EXPENSE OF THE OWNER OR
- 7. IN THE EVENT THERE IS A SEDIMENT DISCHARGE OR FAILURE THE CONTRACTOR
- OR OWNER SHALL BE RESPONSIBLE FOR RESTORATION. 8. FINAL GRADE SEED AND MULCH DISTURBED AREAS AS SOON AS POSSIBLE.
- 9. REMOVE TEMPORARY EROSION CONTROLS AFTER AREAS ARE STABILIZED WITH VEGETATION, STONE OR ASPHALT.


# Engineering rks Œ



	RE	REVISIONS AND APPROVALS	
NC	DATE	NO. DATE DESCRIPTION OF REVISION OR APPROVAL BY	BY
I	8/19/19	TOWN OF CANANDAIGUA	KRB

GENERAL NOTES DRAWN BY: DESIGNED BY: CHECKED BY: 1"=80' 19-126 08/09/2019 126.00-1-23.112 TAX MAP#:

G001

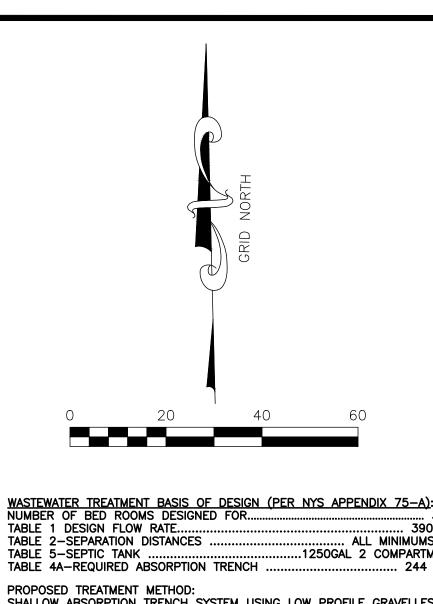

.... 390 GPD .....1250GAL 2 COMPARTMENT

PROPOSED TREATMENT METHOD: SHALLOW ABSORPTION TRENCH SYSTEM USING LOW PROFILE GRAVELLESS ABSORPTION CHAMBERS. ABSORPTION TRENCH LENGTH 280 FEET PROVIDED. EXPANSION AREA PROVIDED.

SOILS ANALYSIS DATA:
SOIL ANALYSIS DATA WAS COLLECTED IN THE SUMMER DURING DRY WEATHER.
SITE SOIL APPEARED TO BE WELL DRAINED BELOW TOPSOIL.

DEEP HOLE & PERC TEST DATA GATHERED BY BMARKS DATED 8/8/19

DEEP HOLE #1

HORIZON A 0"-12" ROOTED TOP SOIL HORIZON B 12-24" LIGHT BROWN CLAY LOAM HORIZON C 24"-48" LIGHT GRAY CLAY

HIGH SEASONAL GROUND WATER OBSERVED AT 27" DEPTH

PERC TEST

PT#1 - STABILIZED AT 13 MINS PT#2 - STABILIZED AT 13 MINS

AGRICULTURAL NOTE:

THIS PROPERTY IS LOCATED WITHIN AN ESTABLISHED AGRICULTURAL DISTRICT CONTAINING A FARM OPERATION. RESIDENTS SHOULD BE AWARE THAT SUCH FARM OPERATIONS MAY GENERATE DUST, ODOR, SMOKE, NOISE VIBRATION AND OTHER ACTIVITIES WHICH MAY BE COMPATIBLE WITH RESIDENTIAL USE OF THIS PROPERTY.

PIPE INVERTS & ELEVATION TABLE
SOIL PIPE @ FOUNDATION = 966.01
SEPTIC TANK INLET = 965.81
SEPTIC TANK OUTLET = 965.56 D-BOX INLET = 965.12D-BOX OUTET = 964.94 INLET TO LEACH LINES = 964.78
BOTTOM OF CHAMBERS = 964.50 FINISHED GRADE AT TOP OF CHAMBER = 965.67 HIGH GROUND WATER = 962.25

TOWN O	F CANANDAIGUA ZO	ANANDAIGUA ZONING		
	PROPOSED	REQUIRED		
ZONING/USE - PRINCIPAL	SINGLE FAMILY RESIDENCE	AR-2 AGRICULTURAL		
FRONT SETBACK	90.00'	60'		
SIDE SETBACK	52.00'	25'		
REAR SETBACK	176.99	40'		
MAX. BUILDING HEIGHT	30'	35'		
MAXIMUM LOT COVERAGE	0.5%	20%		

### MAP REFERENCE

WATER SUPERINTENDENT

MAP NO. 35455 FILED AT THE ONTARIO COUNTY CLERKS OFFICE
 ELEVATION DATUM OF NAVD 88 GEOID 12B
 HORIZONTAL DATUM OF NAD83 NEW YORK CENTRAL

PLANNING BOARD CHAIRMAN

LEGEND Iron pin or pipe found Benchmark Utility pole - Hydrant —— —— Drainage Light pole Fence Line PERC DEEP HOLE ————— Contour Line

PERF-PERFORATED ABBREVIATIONS:

EX = EXISTING

CPP - CORRUGATED POLYETHYLENE PIPE

O.C. - ON CENTER

SICPP - SMOOTH INTERIOR CORRUGATED

UG-UNDERGROUND

CONC - CONCRETE

CO - CLEAN OUT

TYP - TYPICAL

MIN-MINIMUM

MAX - MAXIMUM

MIN - MINIMUM

MAX - MAXIMUM

MIN - MINIMUM

MAX - MAXIMUM

MAX - MAXIMUM

DE - BOTTOM OF CURB

MH - MANHOLE

DI - DRAINAGE INLET

CONC - CONCRETE

BY - PERF - PERF - PERFORATED

TYP - TYPICAL

MIN - MINIMUM


MAX - MAXIMUM

MAX - MAXIMUM

DE - BOTTOM OF CURB

MH - MANHOLE

DI - DRAINAGE INLET (66' ROW)

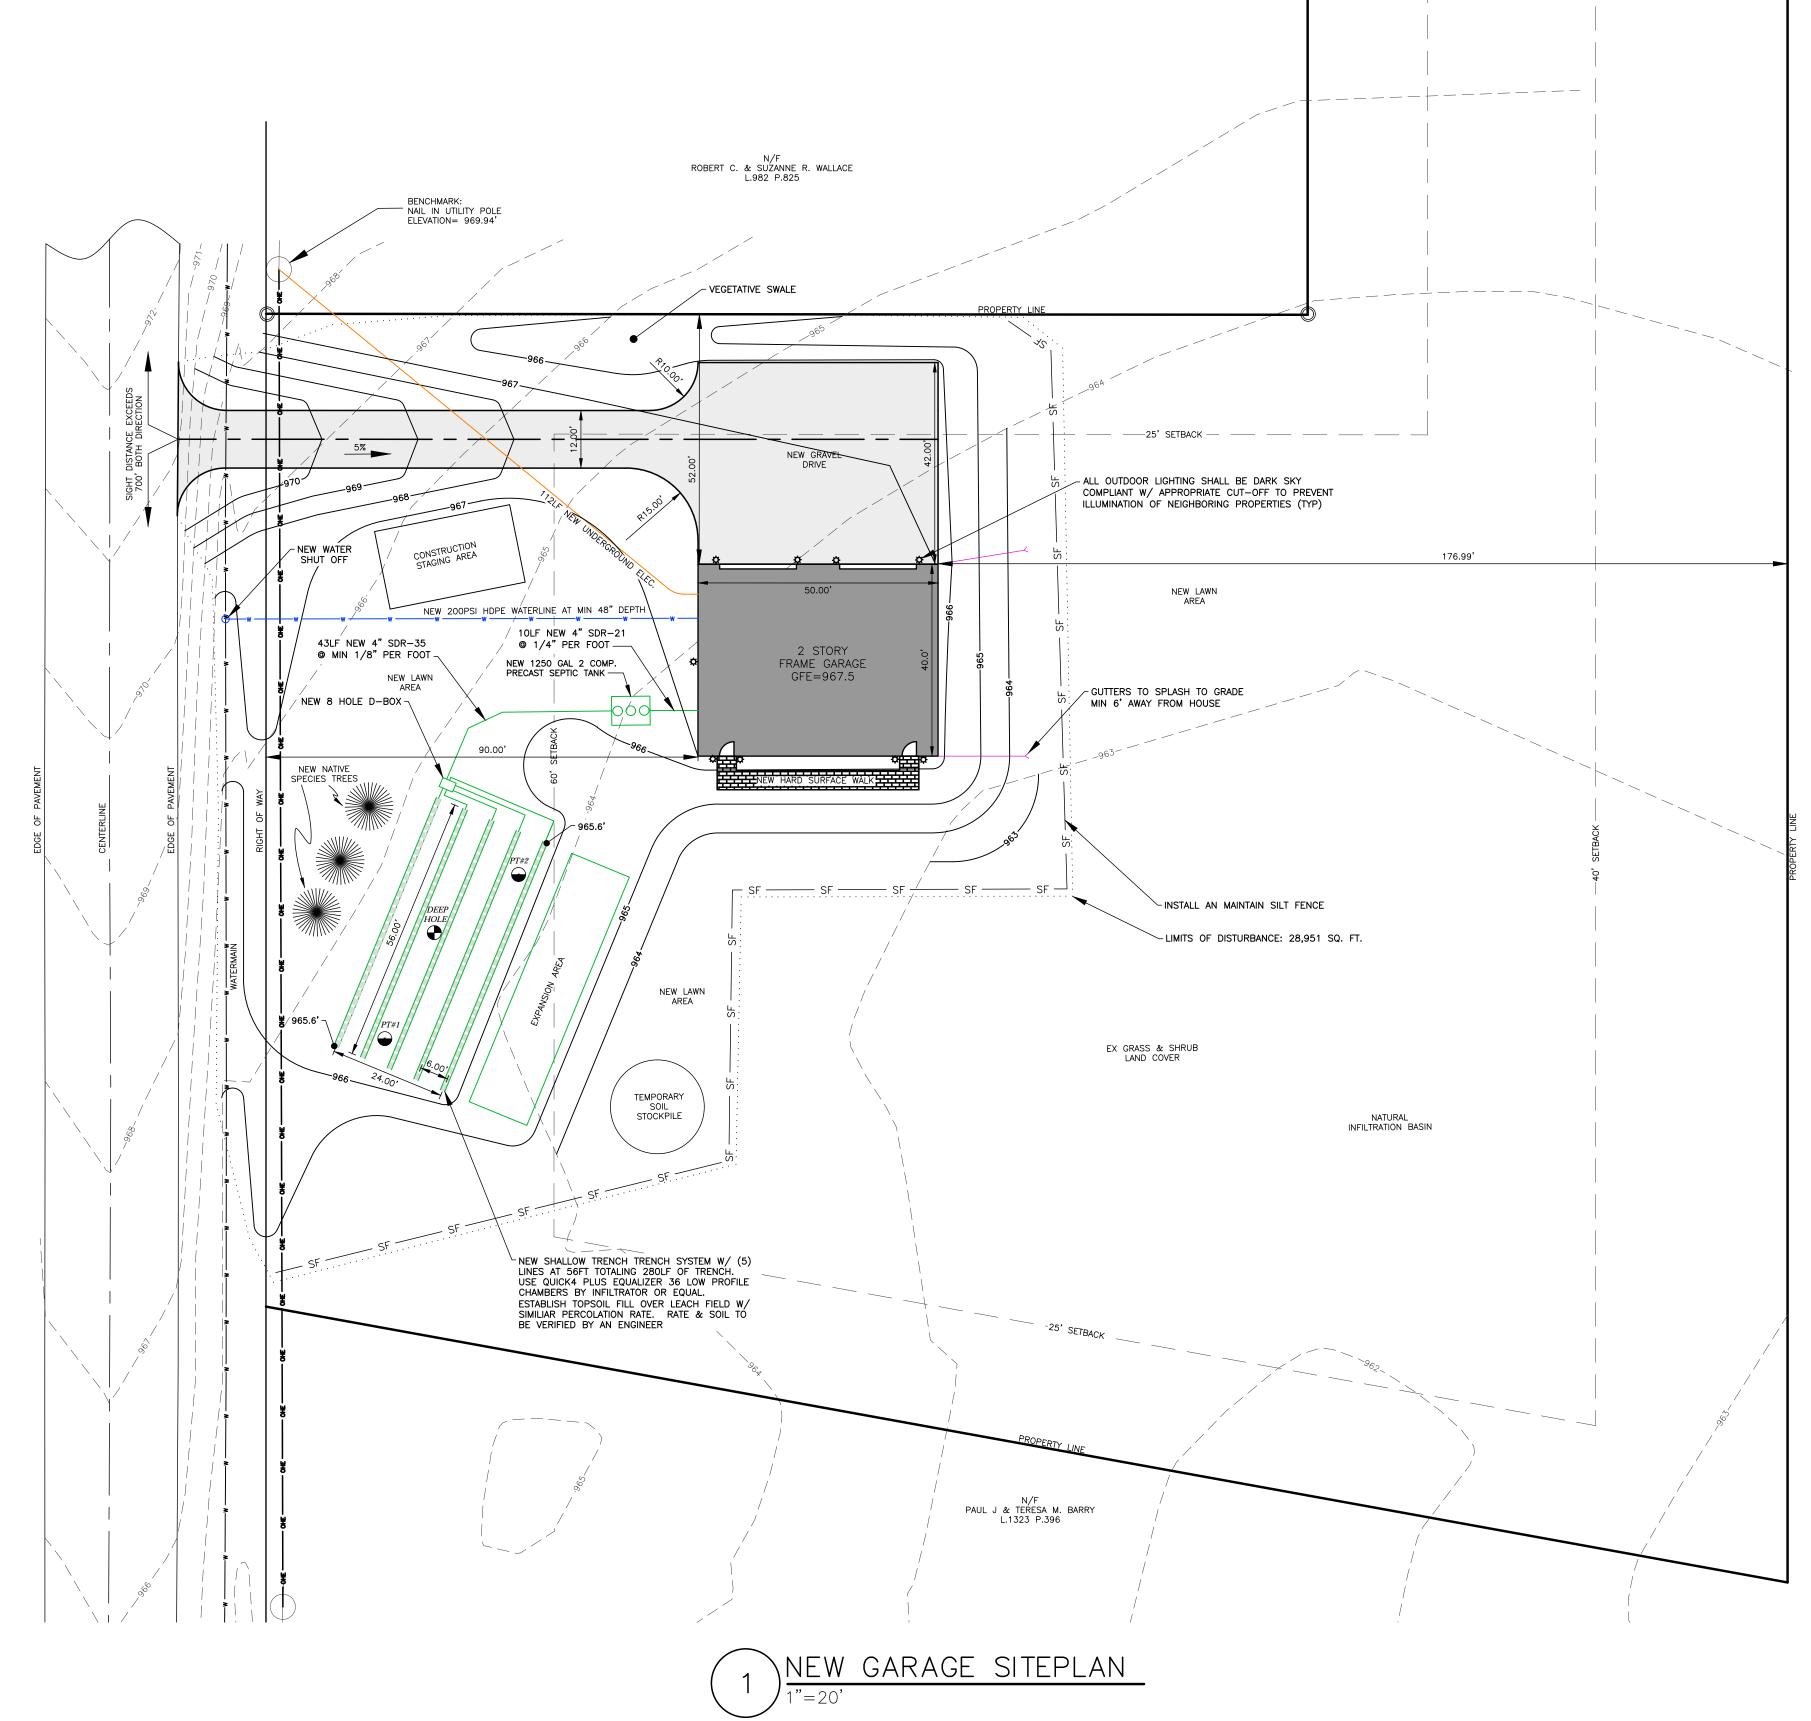

N/F WILLIAM & MARTHA M. DICICCO L.1010 P.21

MarksEngineering

NEW GARAGE SITE PLAN
MARC LAJEUNESSE
SHOWING LAND IN:
MIDDLE CHESHIRE ROAD
TOWN OF CANANDAIGUA

DRAWING TITLE:

DRAWN BY:

DESIGNED BY:

CHECKED BY:

JOB NO.:

DATE:

TAX MAP#:

*C100* 

SITE PLAN

KRB

KRB

BAM

NOTED

19-126

08/09/2019

126.00-1-23.112

