

REVISIONS

NO. DESCRIPTION DATE BY

PRC COMMENTS 06/19/19 GFT

OFT

APPROVED FOR


CONSTRUCTION

It is a violation of New York State Education Law Article 145 Section 7209 for any person, unless he or she is acting under the direction of a licensed professional engineer or land surveyor, to alter an item in any way. If an item bearing the seal of an engineer or land surveyor is altered, the altering engineer or land surveyor shall affix to the item his or her seal and the notation "altered by" followed by his or her signature and the date of such alteration, and a specific description of the alteration.

THORNTON

E N G I N E E R30 Assembly Drive, Suite 106 Mendon, New York 14506


Consultant Engineers

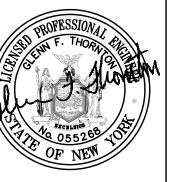

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PROJECT NAME:

Hallstead Dental
Office Parking Lot
Relocation

3240 Middle Cheshire Rd.
Town of Canandaigua
Ontario County, NY

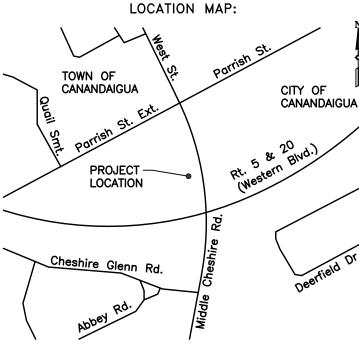DRAWING TITLE:

Site Plan

FILE NAME: SITEPLAN.DWG	DESIGNED BY: GFT
drawn by: HKT	CHECKED BY: GFT
APPROVED BY: GFT	DATE: JUNE 2019
SCALE: 1" = 30'	PROJECT NO.: 18-710
SHEET NO.:	DRAWING NO.:
1 of _5_	S-1

SOIL EROSION AND SEDIMENTATION CONTROL NOTES

- 1. Developer shall install erosion and siltation control measures during construction to prevent off-site transport and deposition of materials.
- 2. The temporary erosion/sedimentation control measures depicted on the site plan shall be supplemented with additional controls if found necessary during construction. Developer is responsible for establishing the controls during construction, and removing the controls following re—establishment of ground cover. Ground cover shall be established within 30 days of completion of final grading.
- 3. Straw bale sediment traps shall be placed as shown on the plan and as needed during construction.
- 4. All sedimentation control structures shall remain in effective operating condition.
- 5. All disturbed areas shall be stabilized immediately following removal of sediment control structures.
- 6. All points of construction ingress and egress shall be protected to prevent tracking of mud onto public ways.
- 7. Roof downspouts shall direct water away from the building.
- 8. In areas where soil disturbance activity has been temporarily or permanently ceased, temporary and/or permanent soil stabilization méasures shall be installed and/or implemented within sevén (7) days from the date the soil disturbance activity ceased. The soil stabilization measures selected shall be in conformance with the most current version of the technical standard, New York State Standards and Specifications for Erosion and Sediment Control.

9. Temporary Seed Mix (2# per 1,000 s.f.)
Annual Ryegrass 50% by weight (90% purity)
Tall Fescue 50% by weight (90% purity)

Permanent Seed Mix (5# per 1,000 s.f.)
Kentucky Bluegrass 45% by weight (85% purity)
Red Fescue 40% by weight (95% purity)
Common Ryegrass 15% by weight (95% purity)

Lawn Fertilizer (5# per 1,000 s.f.)

Straw Mulch (75% ground coverage)

CONSTRUCTION SEQUENCE

It is the site contractor's responsibility to provide stone or asphalt pavement surfaces throughout construction to satisfy staff and patient parking needs. Appropriately graded stone or pavement handicap accessible routes from the parking areas into the building shall also be continuously

- Step 1 Install the new driveway onto Middle Cheshire Road including stone base course material.
- Step 2 Install silt fence at the locations indicated on the plan.
- Step 3 Install stabilized construction entrance.
- Step 4 Remove asphalt pavement areas to be abandoned.
- Step 5 Strip topsoil and place it within the designated storage areas or remove it from the site.
- Step 6 Mass grade the development area.
- Step 7 Fine grade all pavement subgrade areas and place geotextile fabric and stone base course
- Step 9 Fine grade, topsoil, seed, and mulch all areas that will not require future disturbance.
- Step 10 Construct asphalt pavements, pavement overlays, and concrete sidewalks.
- Step 11 Following construction of pavements, topsoil, seed, and mulch all remaining disturbed areas.
- Step 12 Following establishment of a healthy growth of turf within all disturbed areas, remove the silt

CONSTRUCTION PRACTICES

- Litter and construction debris will be picked up on a daily basis and placed within covered trash receptacles.
- Construction materials that are temporarily stored in the work area will be secured with straps or anchors, or covered to prevent wind transport.
- All points of entry into the storm drainage system will be screened to prevent entry of litter or debris.
- Construction chemicals and hazardous substances will be stored in accordance with all applicable environmental regulations. The contractor will have appropriate spill containment devices on the jobsite at all times.

Proposed Area of Ground Disturbance = 0.84 Acres. Calculated Ground Disturbance Includes 25 S.F. per Tree Planted Outside the Delineated Limit of

CONTRACTOR CERTIFICATION


Contractor Name and Telephone

Contractor Address

Contractor Signature

<u>APPROVALS</u>

Planning Board Chairperson	Date
Town Engineer	Date
Town Water/Highway Superintendent	Date

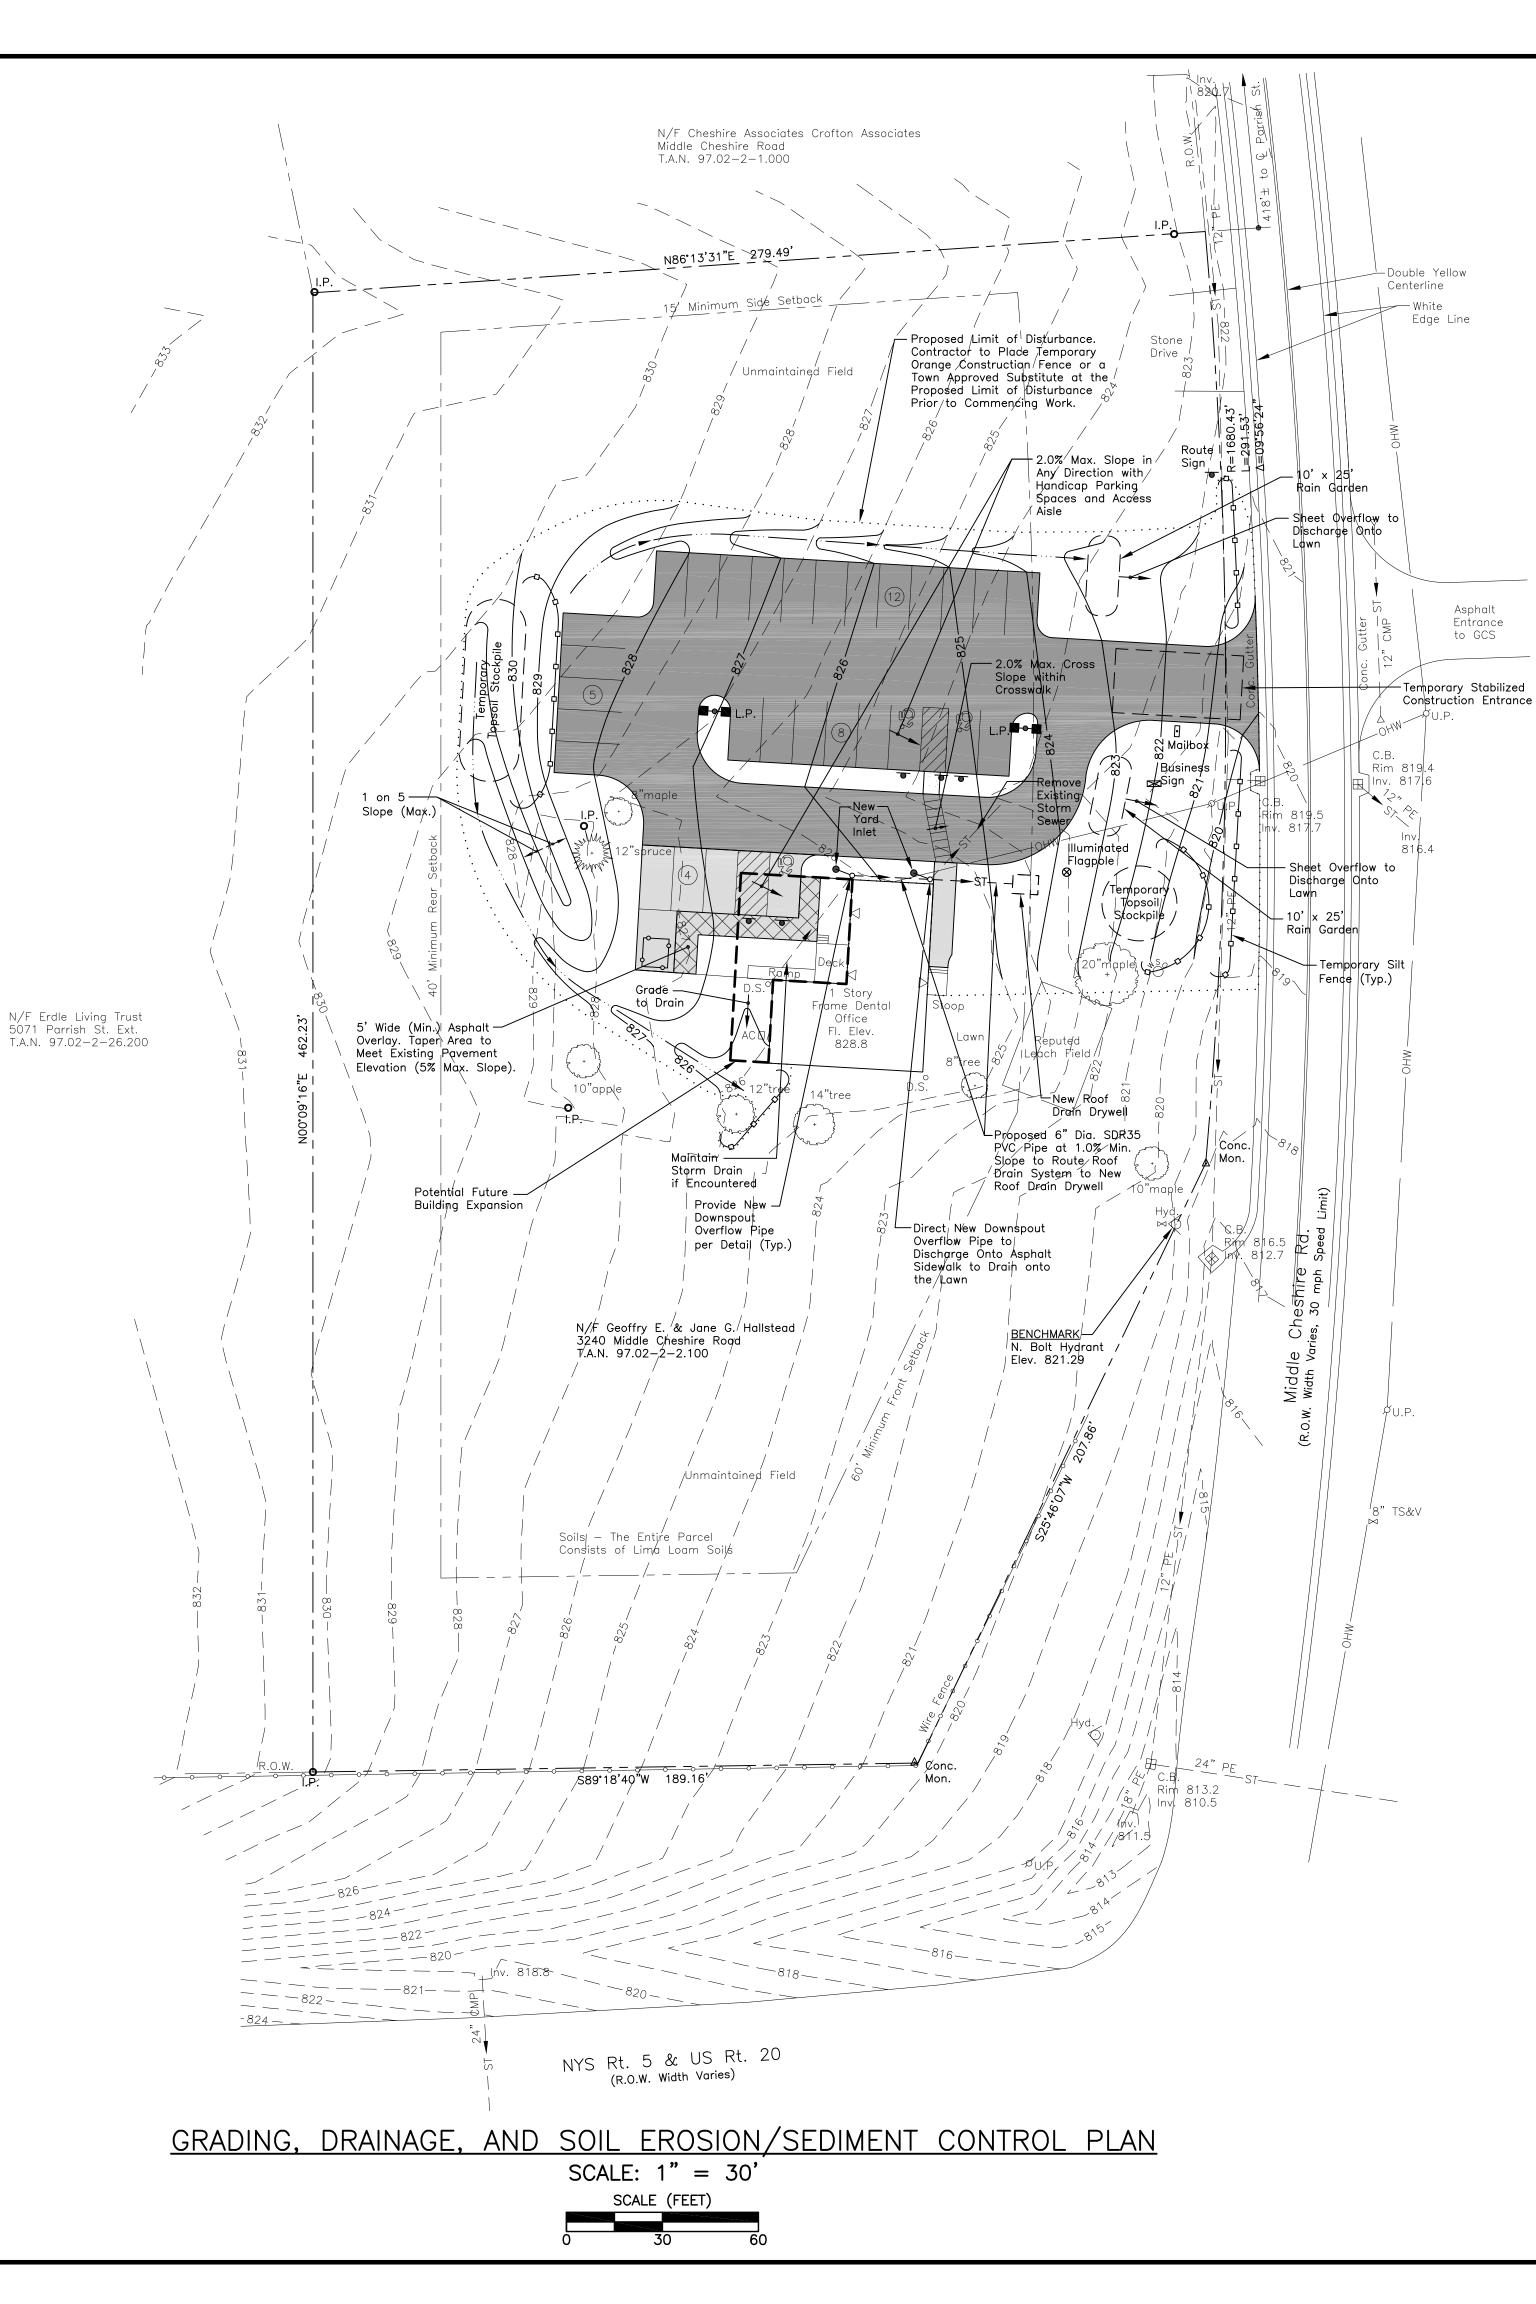

		REVISIONS			
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		CONSTRUCTION			

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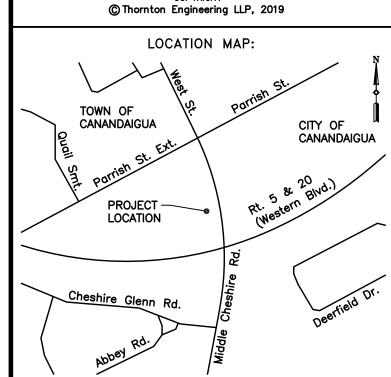
30 Assembly Drive, Suite 106



Consultant Engineers

Entrance to GCS

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PROJECT NAME:

Hallstead Dental Office Parking Lot Relocation

3240 Middle Cheshire Rd. Town of Canandaigua Ontario County, NY

DRAWING TITLE:

Grading, Drainage, and Soil Erosion/ **Sediment Control** Plan

GRADINGPLAN.DWG	DESIGNED BY: GFT
DRAWN BY: HKT	CHECKED BY: GFT
APPROVED BY: GFT	DATE: JUNE 2019
1" = 30'	PROJECT NO.: 18-710
SHEET NO.:	DRAWING NO.:
2 of _5_	S-2

LANDSCAPING NOTES

- 1. All plants shall meet or exceed the requirements set forth in the latest edition of the American Standard for Nursery Stock by the American Association of Nurserymen,
- 2. Upon completion and acceptance of the landscaping by the Town of Canandaigua, a two (2) year maintenance guarantee is required.
- 3. All planting beds to receive 3" of shredded hardwood bark mulch and weed barrier.
- 4. No trees are to be planted within 20' of overhead wires or within 5' of underground
- 5. Stake and wrap tree trunks upon planting.
- 6. Planting backfill mixture to consist of 4 parts of topsoil and 1 part peat moss. Provide 10 lbs. of 5-10-5 fertilizer per 1 cubic yard of planting backfill.
- 7. Apply lawn seed mix at a rate of 5 lbs. per 1,000 s.f. of lawn area using the following proportions by weight:

<u>Lawn Areas</u> % by Weight in Mixture <u>Species or Variety</u>

- Kentucky Bluegrass Red Fescue (commercial)
- Common Ryegrass Rate of lawn fertilizer to be 25 lbs. per 1,000 s.f.
- 8. All seeded areas are to receive 4" of topsoil, seed, straw mulch cover, fertilizer, and water until a thick turf cover is obtained.
- 9. All planting bed areas shall be constructed with 12" of planting backfill mixture.
- 10. Topsoil must be stripped and stockpiled before construction and replaced on all landscaped and lawn areas to a minimum depth of 4" before resale or removal from
- 11. No Phosphorous shall be used at planting time unless soil testing has been completed and tested by a Horticultural Testing Lab and the soil tests specifically indicate a phosphorous deficiency that is harmful, or will prevent new lawns and plantings from establishing properly.
- 12. If soil tests indicate a phosphorous deficiency that will impact plant and lawn establishment, phosphorous shall be applied at the minimum recommended level prescribed in the soil test following all NYS DEC regulations.

CONSTRUCTION	NOTES	

- 1. The locations of new underground lighting circuits have not been depicted on this plan. The Contractor shall provide necessary circuitry to energize the new lighting system per the detail on this drawing.
- 2. All site lighting is to comply with the lighting standards contained in Town Code Chapter 220, Section 220-77.


		ł	PLANTING SCHEDUL	.E		
QUANTITY	KEY	BOTANICAL NAME	COMMON NAME	SIZE	ROOT	NOTES
9	AC	Abies concolor	White Concolor Fir	6' to 7' Height	Balled and Burlapped	
9	PS	Pinus strobus	Eastern White Pine	6' to 8' Height	Balled and Burlapped	
4	SP	Syringa patula "Miss Kim"	Miss Kim Lilac	24" Height	Container	
3	PO	Physocarpus epulifolius "Nana"	Dwarf Ninebark	18" to 24" Height	Container	6' to 7' 0.
5	HJ	Juniperus chinensis "Hetzii Columnaris"	Columnar Hetz Juniper	4' to 5' Height	Balled and Burlapped	6' to 7' 0.0
5	TG	Thuja "Green Giant"	Green Giant Arborvitae	5' to 6' Height	Balled and Burlapped	6' to 7' 0.

LIGHTING FIXTURE SCHEDULE						
Designation	No. of Fixtures	Fixture	Lumens	Mounting		
Α	Two Back to Back	Philips—Gardco Lighting Ecoform Series LED Luminaire, R4 Distribution, with Internal Houseside Shield	6900	20' Mounting Height on Pole		



	Hunber	Drive	LED Color-				Options						
Pro/1×	of LEEDs	Current	Generation	Mouning	Distribution	Vol tage	Dimening controls	Motionswising	Photo-sending	Bectrical	Lundrighe	Duta	
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	LIGHTING FIXTURE SCHEDULE						
esignation	No. of Fixtures	Fixture	Lumens	Mounting			
Α	Two Back to Back	Philips—Gardco Lighting Ecoform Series LED Luminaire, R4 Distribution, with Internal Houseside Shield	6900	20' Mounting Height on Pole			
			,				

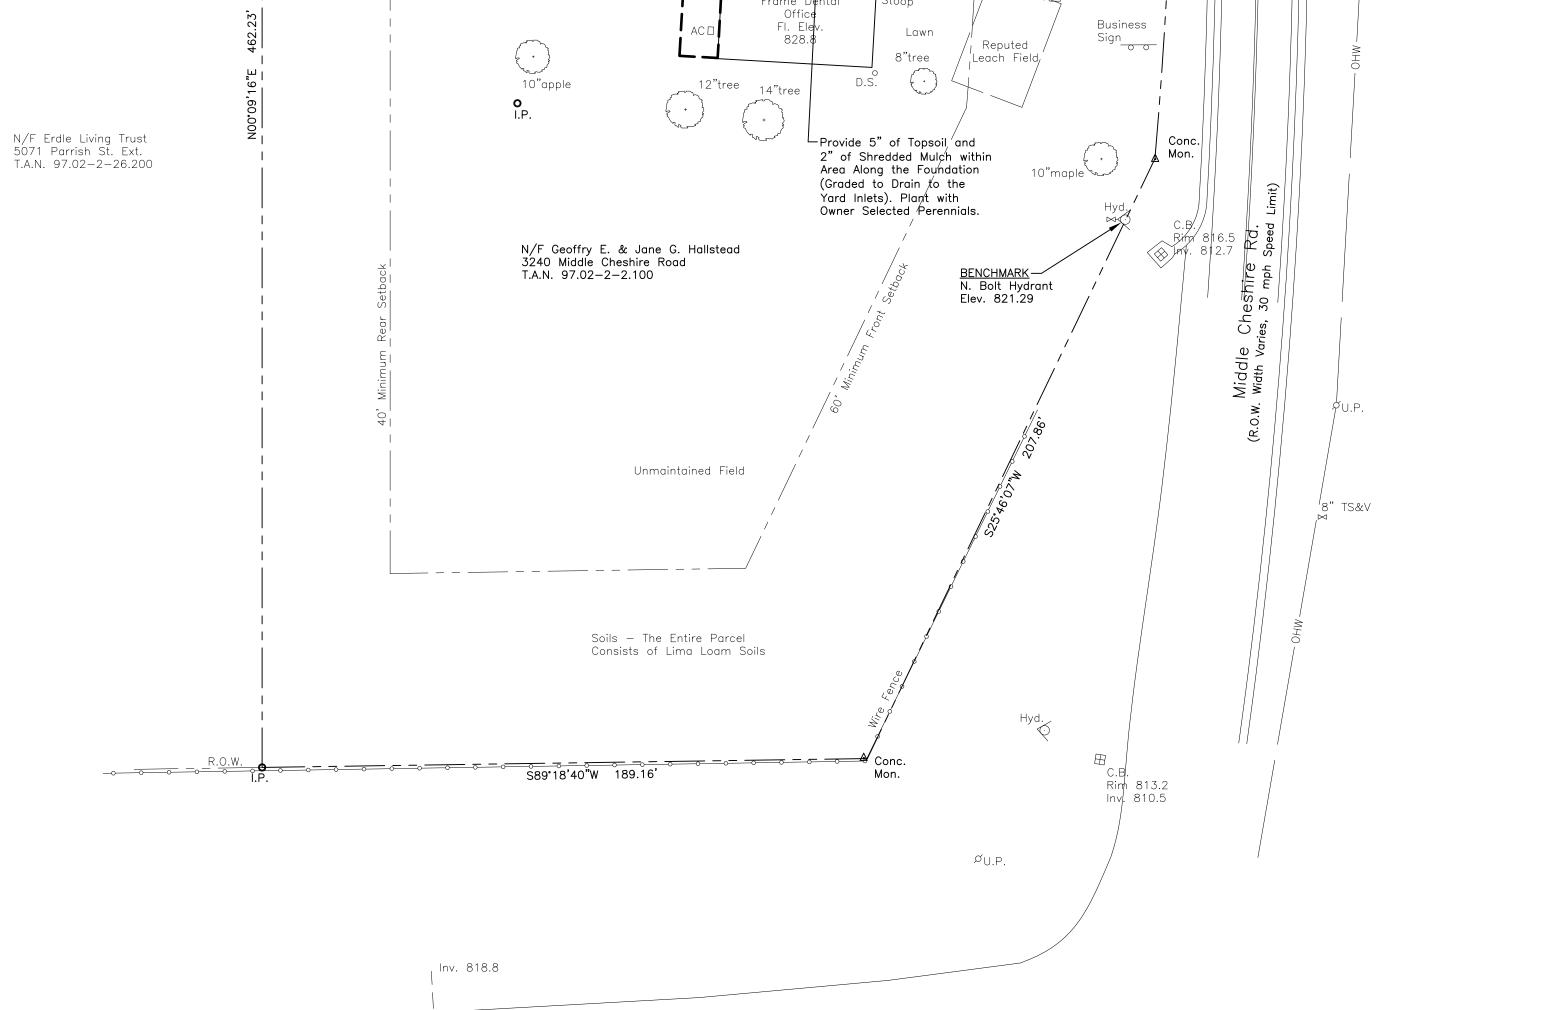

, Illuminated

Drywell |

N/F Cheshire Associates Crofton Associates

Unmaintained Field

Middle Cheshire Road

T.A.N. 97.02-2-1.000

Dumpster Enclosure

N86°13'31"E 279.49" -- -- -- -- -- -- 1.P.

<u>APPROVALS</u>

ECE-S_Gen2 09/7 page1of9

Planning Board Chairperson	Date
Town Engineer	Date
Town Water/Highway Superintendent	Date

LIGHTING AND LANDSCAPING PLAN SCALE: 1" = 30'


NYS Rt. 5 & US Rt. 20 (R.O.W. Width Varies)

	REVISIONS			
NO.	DESCRIPTION	DATE	BY	
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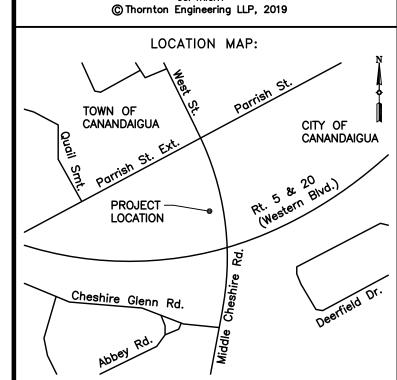


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Centerline

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PROJECT NAME:


Hallstead Dental Office Parking Lot Relocation

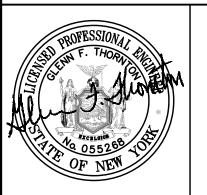3240 Middle Cheshire Rd. Town of Canandaigua Ontario County, NY

DRAWING TITLE:


Lighting and Landscaping Plan Plan

FILE NAME:	DESIGNED BY:
LTLANDSCAPE.DWG	GFT
DRAWN BY:	CHECKED BY:
HKT	GFT
APPROVED BY:	DATE:
GFT	JUNE 2019
SCALE:	PROJECT NO.:
1" = 30'	18–710
SHEET NO.:	DRAWING NO.:
3 of _5_	S-3

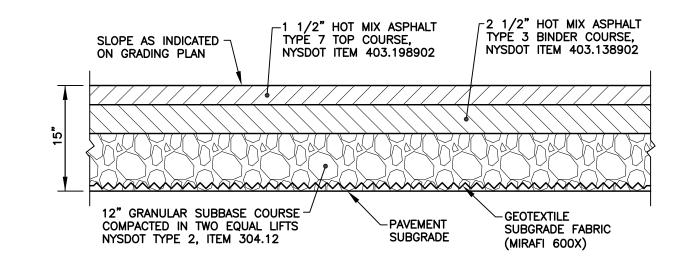


<u>NOTES</u>

- 1. PAVEMENT SUBGRADE AREAS SHALL BE COMPACTED TO A DEPTH OF SIX INCHES AND TO A DENSITY OF NOT LESS THAN 95% OF THE MAXIMUM DENSITY AS DETERMINED BY ASTM D-1557.
- 2. EXISTING TOPSOIL (6" MINIMUM THICKNESS) SHALL BE REMOVED FROM ALL PROPOSED PAVEMENT AREAS. AREAS BELOW THE PAVEMENT SUBGRADE SHALL BE FILLED WITH COMPACTED GRANULAR SUBBASE COURSE.

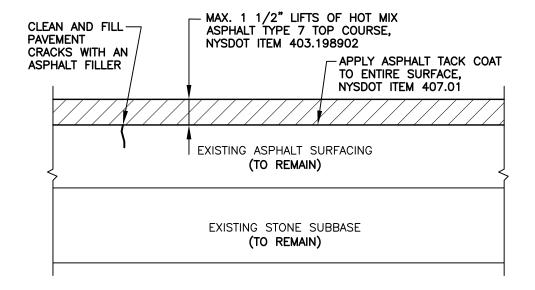

WORK PROCEDURE

- STEP 1 CLEAN AND FILL PAVEMENT CRACKS (1/4" WIDE OR LARGER) WITH AN ASPHALT FILLER.
- STEP 2 THOROUGHLY CLEAN PAVEMENT SURFACES OF ALL DEBRIS.
- STEP 3 APPLY ASPHALT TACK COAT UPON A CLEAN AND DRY PAVEMENT THROUGHOUT THE ENTIRE OVERLAY AREA.
- STEP 4 PLACE AND COMPACT 1 1/2" (MAX. COMPACTED THICKNESS) OF HOT MIX ASPHALT TYPE 7 TOP COURSE. MULTIPLE LIFTS OF ASPHALT PAVEMENT OVERLAY MAY BE REQUIRED IN SOME AREAS. THE ASPHALT SURFACE SHALL BE SLOPED TO DRAIN WITHOUT PONDING

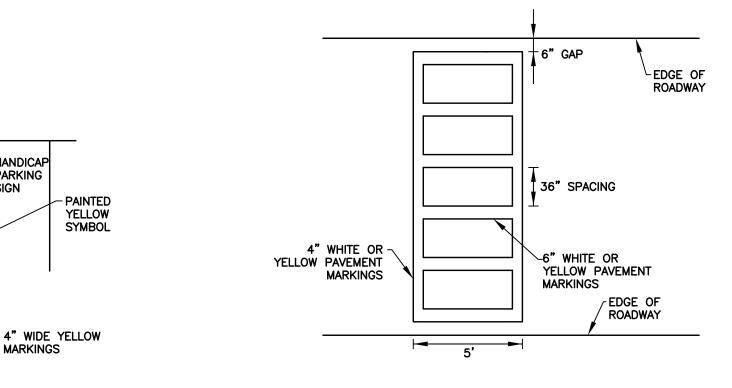

ASPHALT PAVEMENT NOT TO SCALE


ASPHALT OVERLAY NOT TO SCALE


PAVEMENT MARKINGS NOT TO SCALE


PARKING

SIGN

CROSSWALK MARKINGS NOT TO SCALE

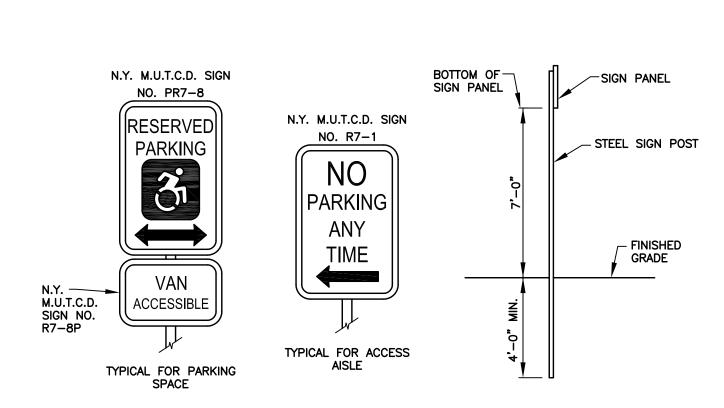


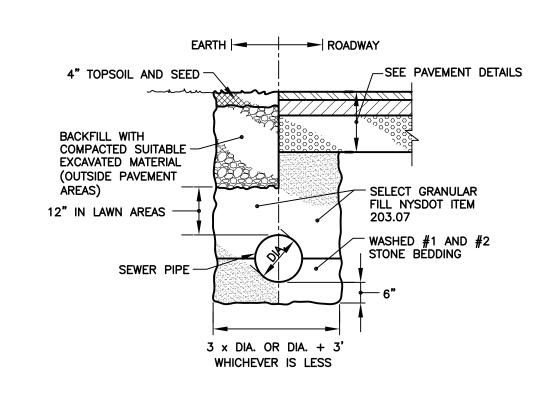

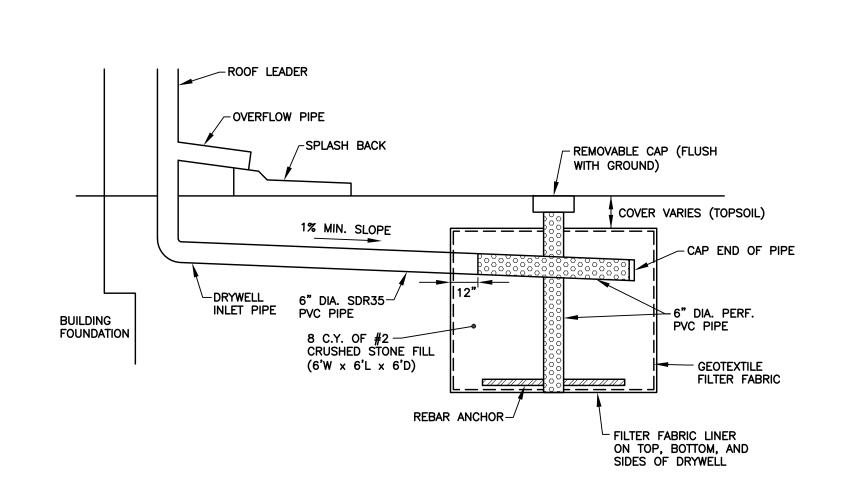

PARKING-

SIGN

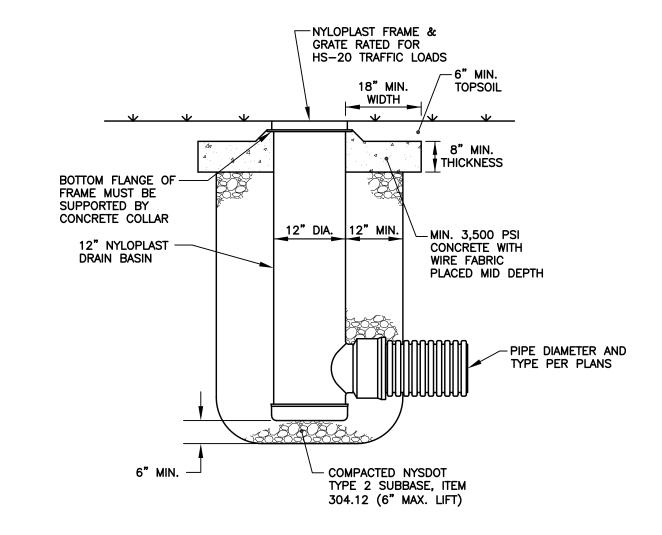

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LOCATION MAP:

PROJECT NAME:

Hallstead Dental

Office Parking Lot

Relocation

3240 Middle Cheshire Rd.

Town of Canandaigua

Ontario County, NY

DRAWING TITLE:

Miscellaneous

Details

DESIGNED BY:

GFT

CHECKED BY:

GFT

DATE:

JUNE 2019

PROJECT NO.:

18-710

DRAWING NO.:

D-1

FILE NAME:

DETAILS.DWG

DRAWN BY:

HKT

APPROVED BY:

GFT

SCALE:

NOT TO SCALE

SHEET NO .:

4 of 5

CANANDAIGUA

30 Assembly Drive, Suite 106 Mendon, New York 14506

Consultant Engineers

TOWN OF

CANANDAIGUA

PROJECT -

LOCATION

acting under the direction of a licensed professional

DESCRIPTION

PRC COMMENTS

DATE BY


06/19/19 GFT


HANDICAP PARKING SIGNS NOT TO SCALE


STORM SEWER INSTALLATION NOT TO SCALE

ROOF DRAIN DRYWELL NOT TO SCALE

YARD INLET NOT TO SCALE

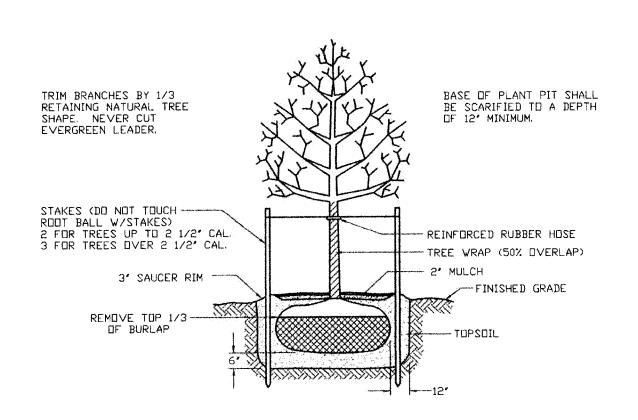

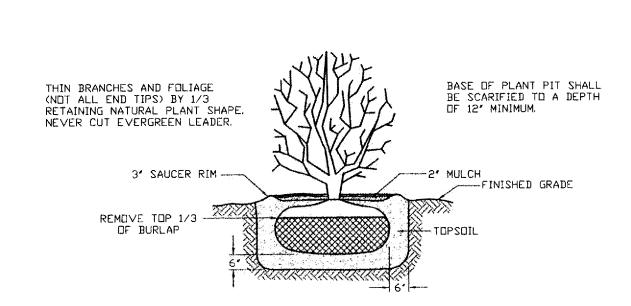

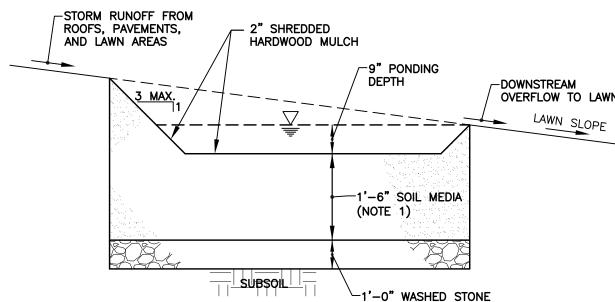


RAIN GARDEN NOT TO SCALE

STORM RUNOFF FROM ROOFS, PAVEMENTS, AND LAWN AREAS	2" SHREDDED HARDWOOD M		
3 MAX.	/ - - - - - - - - - - -	9" PONDING DEPTH	DOWNSTREAM OVERFLOW TO LAWN LAWN SLOPE
		1'-6" SOIL MEDIA (NOTE 1)	
	SUBSOIL	1'-0" WASHED ST	TONE

- 1. SOIL MEDIA SHALL CONSIST OF BLENDED 50% TO 70% SAND AND 50% TO 30%
- 2. LANDSCAPE STONES, AND PLANTS THAT ARE TOLERANT TO BOTH WET AND DRY CONDITIONS, SHOULD BE PROVIDED. SUGGESTED PLANTS INCLUDE RED OSIER DOGWOOD, ARROWWOOD, WINTERBERRY, WITCH HAZEL, BROOK-SIDE ADER, SWEET PEPPERBUSH, SWITCH GRASS, NEW ENGLAND ASTER, WOOLGRASS, CUTLEAF CONEFLOWER, AND FOX SEDGE. PLANTS MUST BE IN ACCORDANCE WITH THE NYSDEC RECOMMENDED SPECIES LIST.

TYPICAL TREE PLANTING NOT TO SCALE

TYPICAL SHRUB PLANTING NOT TO SCALE

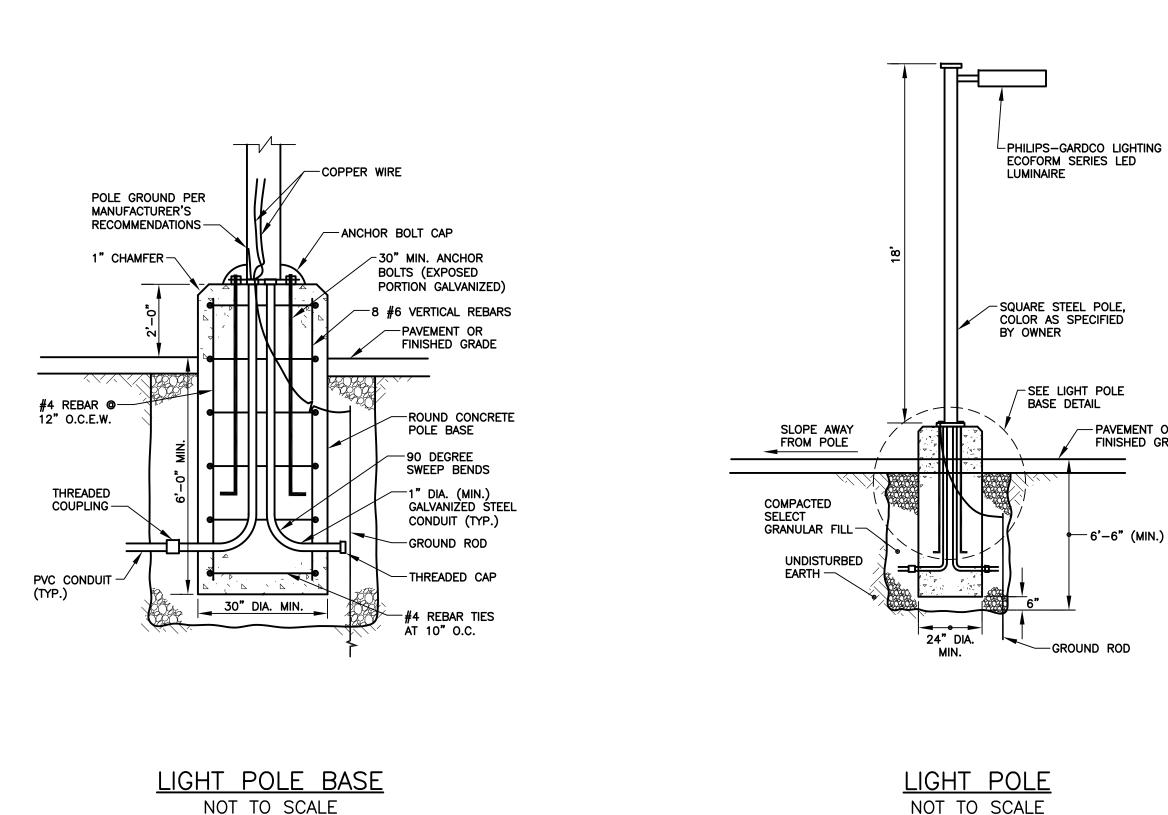

THE TOP AND BOTTOM WOOD CROSS BRACES SHALL BE PLACED 6" FROM THE END OF THE WOOD PICKETS. THE MIDDLE BRACE SHALL BE CENTERED WITHIN THE FENCE.

<-

INSTALL 1 x 6 BOARDS

HORIZONTAL TO ACCOUNT FOR GRADE CHANGES. SPACE 1 x 6 BOARDS

EQUALLY (3/8" MAX.)

SLOPE OR BE

ELEVATION

MECHANICAL UNIT SIDE

LAWN AND STREET SIDE


_4 x 4 TREATED WOOD POST (TYP.)

└1 x 6 TREATED WOOD PICKET (TYP.)

VERTICALLY, 2 x 6'S MAY

PLAN VIEW

8'-0" POST FACE TO FACE (MAX.)

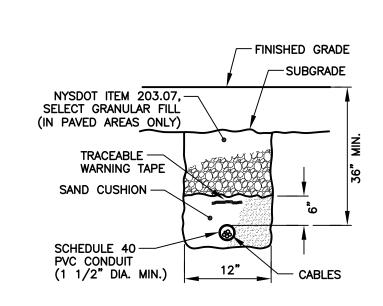

- PAVEMENT OR

-6'-6" (MIN.)

ATTACH EACH 2 x 6 CROSS BRACE TO THE 4 x 4 TREATED WOOD POST WITH 2-3" x 1/4" GALVANIZED LAG BOLTS WITH WASHERS (TYP.)

4 x 4 TREATED WOOD POST (TYP.)

ASPHALT -PAVEMENT

-4 x 4 TREATED WOOD POST (TYP.)

 $^{\sim}2$ x 6 TREATED WOOD CROSS BRACE (TYP.)

-2 x 6 TREATED WOOD CROSS BRACE (TYP.)

ATTACH EACH 1 x 6
WOOD PICKET TO THE 2 x
6 CROSS BRACE WITH 3

GALVANIZED NAILS (TYP.)

TOP OF CONC. FOUNDATION TO

BE A RECTANGULAR SHAPE

NOTE: ALL FENCE MEMBERS TO BE STAINED PER

OWNER'S REQUIREMENTS.

~1 x 6 TREATED WOOD PICKET (TYP.)


—1/2" SLOPE

WOOD FENCE SECTION A-A

FINISHED GRADE

CONDUIT INSTALLATION AND TRENCH NOT TO SCALE


GATE OPENING = 8' LOCKABLE HEAVY DUTY DOOR SECURITY SURFACE BOLT HEAVY DUTY WROUGHT STEEL T-HINGE (TYP.) - 1 x 6 TREATED WOOD PICKET (TYP.) OUTSIDE VIEW -1/8" TENSION WIRE WITH A 3" "EYE & EYE" TURNBUCKLE, WIRE ROPE THIMBLES AND CLAMPS. SECURE EACH END OF WIRE WITH SCREW EYEBOLTS. INSTALL 1 x 6 BOARDS VERTICALLY, 2 x 6'S MAY SLOPE OR BE HORIZONTAL TO ACCOUNT FOR GRADE CHANGES. SPACE 1 x 6 BOARDS ▼ EQUALLY (3/8" MAX.) _2x4 TREATED WOOD STRINGER AND BRACE (TYP.) -4 x 4 TREATED WOOD POST (TYP.) TOENAIL BRACE TO STRINGER _2 x 6 TREATED WOOD CROSS BRACE (TYP.) GRADE_¬ PLACE LOWER END OF BRACE TOWARDS THE HINGE, NOT THE LATCH REFER TO WOOD POST DETAIL - CONCRETE FOUNDATION, TYP. -6" GRAVEL BASE **INSIDE VIEW**

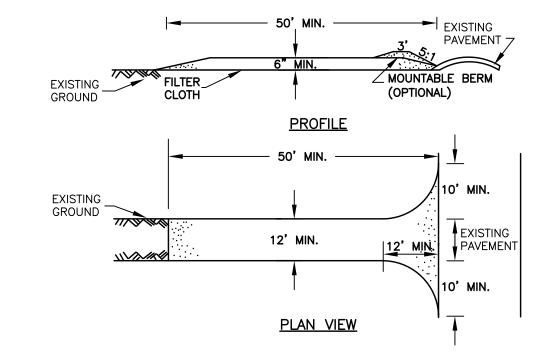

CONSTRUCTION SPECIFICATIONS

- 1. STONE SIZE USE 2" STONE, OR RECLAIMED OR RECYCLED CONCRETE EQUIVALENT.
- 2. LENGTH NOT LESS THAN 50' (EXCEPT ON A SINGLE RESIDENCE LOT WHERE A 30' MINIMUM LENGTH WOULD APPLY).
- 3. THICKNESS NOT LESS THAN 6".
- 4. WIDTH 12' MINIMUM, BUT NOT LESS THAN THE FULL WIDTH AT POINTS WHERE INGRESS OR EGRESS OCCURS. 24' IF SINGLE ENTRANCE TO SITE.
- 5. FILTER CLOTH WILL BE PLACED OVER THE ENTIRE AREA PRIOR TO PLACING OF STONE.
- 6. SURFACE WATER ALL SURFACE WATER FLOWING OR DIVERTED TOWARD CONSTRUCTION ENTRANCES SHALL BE PIPED ACROSS THE ENTRANCE. IF PIPING IS
- IMPRACTICAL, A MOUNTABLE BERM WITH 5:1 SLOPES WILL BE PERMITTED. 7. MAINTENANCE — THE ENTRANCE SHALL BE MAINTAINED IN A CONDITION WHICH WILL PREVENT TRACKING OR FLOWING OF SEDIMENT ONTO PUBLIC RIGHTS—OF—WAY, ALL SEDIMENT SPILLED, DROPPED, WASHED OR TRACTED ONTO PUBLIC RIGHTS-OF-WAY MUST BE REMOVED IMMEDIATELY.
- 8. WHEN WASHING IS REQUIRED, IT SHALL BE DONE ON AN AREA STABILIZED WITH STONE AND WHICH DRAINS INTO AN APPROVED SEDIMENT TRAPPING DEVICE.
- 9. PERIODIC INSPECTION AND NEEDED MAINTENANCE SHALL BE PROVIDED AFTER EACH

STABILIZED CONSTRUCTION ENTRANCE NOT TO SCALE

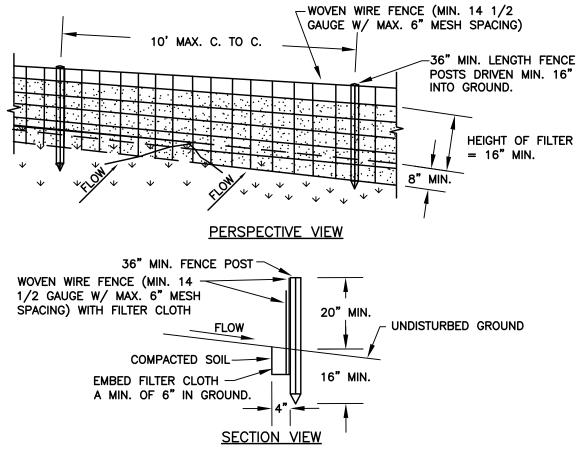

CONSTRUCTION SPECIFICATIONS

- 1. WOVEN WIRE FENCE TO BE FASTENED SECURELY TO FENCE POSTS WITH WIRE TIES OR STAPLES. POSTS SHALL BE STEEL EITHER "T" OR "U" TYPE OR HARDWOOD.
- 2. FILTER CLOTH TO BE TO BE FASTENED SECURELY TO WOVEN WIRE FENCE WITH TIES SPACED EVERY 24" AT TOP AND MID SECTION.
- FENCE SHALL BE WOVEN WIRE, 12 1/2 GAUGE, 6" MAXIMUM MESH OPENING.
- 3. WHEN TWO SECTIONS OF FILTER CLOTH ADJOIN EACH OTHER THEY SHALL BE OVER-LAPPED BY 6" AND FOLDED. FILTER CLOTH SHALL BE EITHER FILTER X,
- MIRAFI 100X, STABILINKA T140N, OR APPROVED EQUIVALENT. 4. PREFABRICATED UNITS SHALL BE GEOFAB, ENVIROFENCE, OR APPROVED EQUIVALENT.
- 5. MAINTENANCE SHALL BE PERFORMED AS NEEDED AND MATERIAL REMOVED WHEN "BULGES" DEVELOP IN THE SILT FENCE.

SILT FENCE NOT TO SCALE


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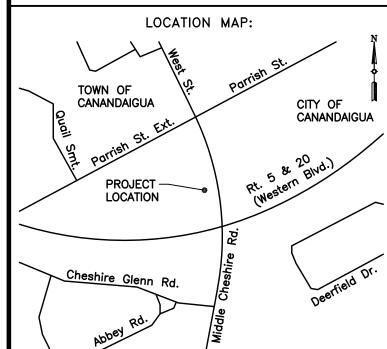
Consultant Engineers



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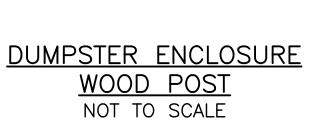
Hallstead Dental Office Parking Lot Relocation

3240 Middle Cheshire Rd. Town of Canandaigua Ontario County, NY

DRAWING TITLE:

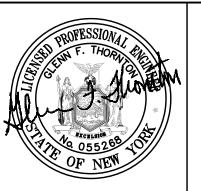Miscellaneous Details

DATE:	



3/8" DIA. GALVANIZED A307 BOLTS (TYP.)

TUBULAR STEEL 4" x 4"

x 1/4" FENCE POST

SLEEVE (TYP.)

REFER TO-

WOOD POST DETAIL

COMPACTED SUBGRADE (TYP.)

4 x 4 TREATED —

WOOD POST (TYP.)

DUMPSTER ENCLOSURE FENCE NOT TO SCALE

DUMPSTER ENCLOSURE GATE NOT TO SCALE