# FINAL PLANS - SECTION 9B for LAKEWOOD MEADOWS SUBDIVISION


ST. JAMES PARKWAY

SITUATE IN:

# TOWN OF CANANDAIGUA - ONTARIO COUNTY - STATE OF NEW YORK

### AMENDED PRELIMINARY OVERALL CONDITIONS OF APPROVAL (09/17/2014)

- 1. A LETTER OF CREDIT ESTIMATE IN FAVOR OF THE TOWN OF CANANDAIGUA IS TO BE PROVIDED AND ACCEPTED BY THE TOWN BOARD PRIOR TO ISSUANCE OF BUILDING PERMITS.
- 2. THE TITLE OF THE DRAWING IS TO READ "AMENDED PRELIMINARY OVERALL SUBDIVISION PLAT LAKEWOOD MEADOWS SECTION 9."
- 3. THE AMENDED PRELIMINARY OVERALL SUBDIVISION PLAT LAKEWOOD MEADOWS SECTION 9 APPROVAL WITH CONDITIONS AS SPECIFIED IS VALID FOR A PERIOD OF 180 DAYS FROM TODAY AND SHALL EXPIRE UNLESS AN EXTENSION IS REQUESTED BY THE APPLICANT AND APPROVED BY THE PLANNING BOARD AT A LATER DATE WITH A SEPARATE RESOLUTION.
- 4. ONCE ALL CONDITIONS OF THE AMENDED PRELIMINARY OVERALL SUBDIVISION PLAT LAKEWOOD MEADOWS SECTION 9 APPROVAL HAVE BEEN MET AND SHOWN ON REVISED DRAWINGS INCLUDING THE REVISION DATES, AND ALL REQUIRED SIGNATURES ARE AFFIXED TO THE SUBDIVISION PLANS, THE PLANNING BOARD CHAIRPERSON'S SIGNATURE SHALL BE AFFIXED AND THE MAPS FILED IN THE TOWN DEVELOPMENT OFFICE AND TOWN CLERK WITHIN 180 DAYS FROM TODAY.
- THE PLANNING BOARD DETERMINES THAT PARKLAND IS NOT A CONDITION OF AMENDED PRELIMINARY OVERALL SUBDIVISION PLAT LAKEWOOD
  MEADOWS SECTION 9 APPROVAL.
- 6. THE PLANNING BOARD DETERMINES THAT A PARK AND RECREATION FEE IN THE AMOUNT TO BE DETERMINED BY THE TOWN BOARD ON AN ANNUAL BASIS IS TO BE PAID AT THE TIME OF THE APPLICATION BUILDING PERMITS.
- 7. THE SUBDIVISION PLANS ARE TO BE REVISED TO LABEL WHETHER OR NOT THE EXISTING BARNS ALONG MIDDLE CHESHIRE ROAD ARE TO REMAIN OR BE REMOVED.
- 8. THE MINIMUM SETBACKS ARE TO BE THE FOLLOWING
  - FRONT SETBACK = 20'
  - REAR SETBACK = 10'
     SIDE SETBACK = 6' (PATIO HOMES ONLY)
- 9. A NOTE IS TO BE ADDED TO THE PRELIMINARY SUBDIVISION PLANS THAT STATES THAT THE APPLICANT IS REQUIRED TO FILE SUBDIVISION AND DEED RESTRICTIONS CONCERNING ACCESSORY STRUCTURES WITH THE FINAL SUBDIVISION PLANS. COPIES OF THESE RESTRICTIONS ARE TO BE FILED WITH THE TOWN OF CANANDAIGUA TOWN HALL.
- 10. THE PROPOSED TRAIL LOCATIONS ARE TO BE SHOWN IN THE AMENDED PRELIMINARY OVERALL SUBDIVISION PLAT LAKEWOOD MEADOWS SECTION 9 PLANS.
- 11. A NOTE IS TO BE ADDED TO THE PRELIMINARY SUBDIVISION PLANS THAT STATES THAT THE PROPOSED TRAIL IS TO BE INSTALLED BY THE DEVELOPER TO THE LIMITS AS SHOWN ON THE FINAL SUBDIVISION PLANS. THE DEVELOPER WILL BE RESPONSIBLE FOR MAINTENANCE OF THE TRAIL UNTIL SUCH TIME THAT IT IS CONVEYED TO THE HOME OWNERS ASSOCIATION, AT WHICH TIME THE HOA WILL ASSUME MAINTENANCE RESPONSIBILITIES.
- 12. A NOTE IS TO BE ADDED TO THE PRELIMINARY SUBDIVISION PLANS THAT STATES THAT THE PROPOSED OPEN SPACE AREAS ARE TO BE MAINTAINED BY THE DEVELOPER UNTIL SUCH TIME THAT THE HOME OWNERS ASSOCIATION (HOA) IS ESTABLISHED AND THE PROPERTIES ARE TRANSFERRED. THE OPEN SPACE MAINTENANCE TO BE AS SPECIFIED IN THE HOA DOCUMENTS ON FILE WITH THE TOWN OF CANANDAIGUA.
- 13. A NOTE IS TO BE ADDED TO THE PRELIMINARY SUBDIVISION PLANS THAT STATES THAT ANY DEVIATION OF HOUSE PAD ELEVATIONS MORE THAN 12 INCHES SHALL BE APPROVED BY THE PLANNING BOARD.
- 14. THE AMENDED PRELIMINARY OVERALL SUBDIVISION PLAT LAKEWOOD MEADOWS SECTION 9 PLANS ARE TO BE DESIGNED TO MEET THE TOWN OF CANANDAIGUA RIDGELINE DEVELOPMENT GUIDELINES.
- 15. THE AMENDED SUBDIVISION PLANS ARE TO PROVIDE A SECTION VIEW PLAN CONTAINING A PLAN VIEW AND SECTION VIEWS FROM THE CENTERLINE OF MIDDLE CHESHIRE ROAD LOOKING TOWARDS THE DEVELOPMENT AS PROVIDED WITH THE APPROVED 2007 PRELIMINARY SUBDIVISION PLANS FOR LAKEWOOD MEADOWS SECTION 9 & 10.
- 16. IF ANY EXISTING STRUCTURES INCLUDING THE BARNS AND SHED ALONG MIDDLE CHESHIRE ROAD ARE TO REMAIN OR BE RELOCATED, THEY ARE TO BE LABELED AS SUCH AND THE PROPOSED LOCATIONS IDENTIFIED ON THE AMENDED SUBDIVISION PLANS.
- 17. A NOTE IS TO BE ADDED TO THE AMENDED SUBDIVISION PLANS STATING THAT THE ALL OPEN SPACE AREAS, INCLUDING STORMWATER MANAGEMENT FACILITIES AND THE MAINTENANCE RESPONSIBILITIES OF THESE AREAS WILL BE TRANSFERRED TO THE EXISTING HOA.
- 18. MORRELL BUILDERS ARE TO SET UP A MEETING WITH THE EXISTING HOA AND PROVIDE WRITTEN NOTICE TO THE TOWN DEVELOPMENT OFFICE REGARDING THE DATE IN WHICH THIS MEETING WILL TAKE PLACE PRIOR TO THE PLANNING BOARD CHAIRMAN SIGNING THE AMENDED PRELIMINARY OVERALL SUBDIVISION PLAT LAKEWOOD MEADOWS SECTION 9 PLANS.
- 19. THE CONSERVATION EASEMENTS ASSOCIATED WITH SECTION 6 OF LAKEWOOD MEADOWS SUBDIVISION ARE TO BE TRANSFERRED TO THE TOWN OF CANANDAIGUA PRIOR TO THE PLANNING BOARD CHAIRMAN SIGNING THE AMENDED PRELIMINARY OVERALL SUBDIVISION PLAT LAKEWOOD MEADOWS SECTION 9 PLANS.
- 20. A MAXIMUM OF 81 UNITS (66 TOWNHOUSES AND 15 PATIO HOMES) ARE TO BE PROVIDED ON THE AMENDED PRELIMINARY OVERALL SUBDIVISION PLAT LAKEWOOD MEADOWS SECTION 9 PLANS.
- 21. THE AMENDED PRELIMINARY OVERALL SUBDIVISION PLAT LAKEWOOD MEADOWS SECTION 9 PLANS ARE REQUIRED TO PROVIDE A MINIMUM OPEN SPACE AREA OF 43.2 ACRES FOR SECTION 9 AND A MINIMUM OF 183.6 ACRES OF TOTAL OPEN SPACE FOR SECTIONS 1-9 OF LAKEWOOD MEADOWS.
- 22. THE PROPOSED ENTRANCE DRIVE TO SECTION 9 OF LAKEWOOD MEADOWS OFF OF MIDDLE CHESHIRE ROAD IS TO BE APPROVED BY THE TOWN HIGHWAY SUPERINTENDENT PRIOR TO SIGNATURES BEING AFFIXED TO THE AMENDED PRELIMINARY OVERALL SUBDIVISION PLAT LAKEWOOD MEADOWS SECTION 9 PLANS.

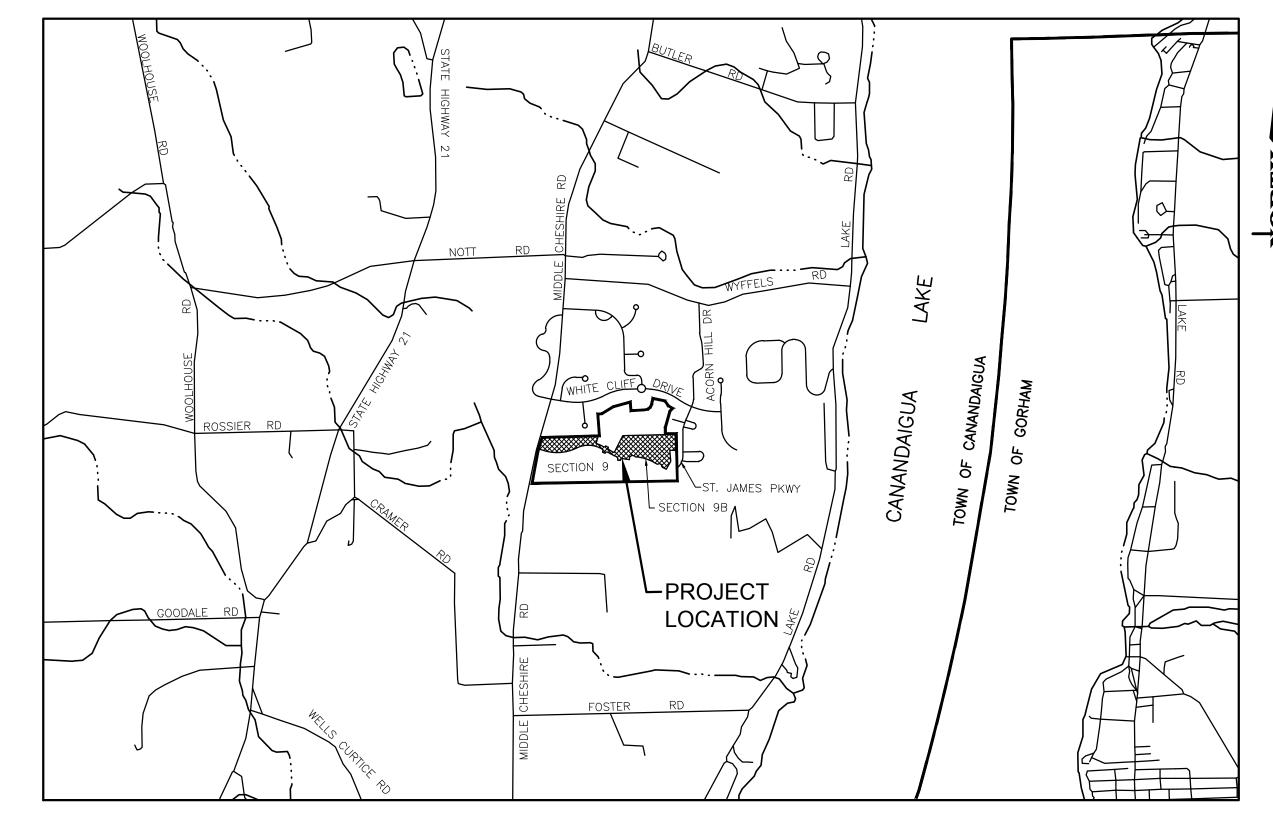

LOCATION MAP



39 CASCADE DRIVE ROCHESTER, NY 14614 PHONE 585-458-7770 www.marathoneng.com

### FINAL CONDITIONS OF APPROVAL (09/17/2014)

- 1. THE FINAL (PHASED) SUBDIVISION PLAT APPROVAL WITH CONDITIONS AS SPECIFIED IS VALID FOR A PERIOD OF 180 DAYS FROM AUGUST 23, 2016
  AND SHALL EXPIRE UNLESS AN EXTENSION IS REQUESTED BY THE APPLICANT AND APPROVED BY THE PLANNING BOARD AT A LATER DATE WITH A
  SEPARATE RESOLUTION.
- 2. ONCE ALL CONDITIONS OF FINAL (PHASED) SUBDIVISION PLAT APPROVAL HAVE BEEN MET AND SHOWN ON REVISED DRAWINGS INCLUDING THE REVISION DATES, AND ALL REQUIRED SIGNATURES ARE AFFIXED TO FOUR (4) PRINTS OF THE FINAL (PHASED) SUBDIVISION PLAT, THE PLANNING BOARD CHAIRPERSON'S SIGNATURE SHALL BE AFFIXED AND THE MAPS FILED IN THE TOWN DEVELOPMENT OFFICE WITHIN 180 DAYS FROM AUGUST 23, 2016.
- 3. ONE MYLAR OF THE FINAL (PHASED) SUBDIVISION PLAT IS TO BE PROVIDED FOR SIGNING BY THE IDENTIFIED TOWN OFFICIALS AND THE TOWN PLANNING BOARD CHAIRPERSON. ONCE THE MYLAR AND ALL PAPER PRINTS HAVE BEEN SIGNED, THE MYLAR AND TWO SETS OF PAPER PRINTS WILL BE RETURNED TO THE APPLICANT FOR FILING THE MYLAR IN THE OFFICE OF THE ONTARIO COUNTY CLERK.
- 4. ONCE THE FINAL (PHASED) SUBDIVISION PLAT HAS BEEN SIGNED BY THE PLANNING BOARD CHAIRPERSON, THE APPLICANT SHALL FILE IN THE OFFICE OF THE ONTARIO COUNTY CLERK SUCH APPROVED FINAL PLAT WITHIN SIXTY-TWO (62) DAYS FROM THE DATE OF FINAL APPROVAL OR SUCH APPROVAL SHALL EXPIRE (NYS TOWN LAW SECTION 276-11).
- 5. THE FINAL SUBDIVISION PLANS ARE TO NOTE ANY AND ALL RESTRICTIVE COVENANTS IN DETAIL OF THE CONSERVATION EASEMENT AREAS.
- 6. PAYMENT OF A FEE IN LIEU OF A SET ASIDE OF PARKLAND SHALL BE MADE AT THE TIME OF ISSUANCE OF BUILDING PERMITS PURSUANT TO TOWN CODE CHAPTER 111 AND NYS TOWN LAW.
- 7. THE DEED RESTRICTIONS CONCERNING ACCESSORY STRUCTURES SHALL BE NOTED ON THE FINAL SUBDIVISION PLAT AND SUBMITTED TO THE PLANNING BOARD ATTORNEY FOR APPROVAL AND SUCH APPROVAL SHALL BE OBTAINED PRIOR TO THE PLANNING BOARD CHAIRMAN'S SIGNATURE BEING AFFIXED TO THE FINAL SUBDIVISION PLAN. THE DEED RESTRICTIONS SHALL BE FILED AT THE ONTARIO COUNTY CLERK'S OFFICE AT THE SAME TIME AS THE APPROVED FINAL SUBDIVISION PLAT. COPIES OF THE FILED DEED RESTRICTIONS ARE TO BE SUBMITTED TO THE TOWN CLERK WITHIN FIVE (5) DAYS OF THEM BEING FILED. FAILURE TO FILE SUCH RESTRICTIONS AT THE TIME OF FILING THE FINAL SUBDIVISION PLAT SHALL INVALIDATE THIS APPROVAL.
- 8. THE HOMEOWNERS ASSOCIATION AGREEMENT FOR THE TOWNHOMES (ST. JAMES PARKWAY) REGARDING THE MAINTENANCE OF THE OPEN SPACE AREAS, TRAILS, AND STORMWATER MANAGEMENT FACILITIES SHALL BE SUBMITTED TO THE TOWN PLANNING BOARD ATTORNEY FOR REVIEW AND APPROVAL AND SUCH APPROVAL SHALL BE OBTAINED PRIOR TO THE PLANNING BOARD CHAIRMAN'S SIGNATURE BEING AFFIXED TO THE FINAL SUBDIVISION PLAN
- 9. A LETTER OF CREDIT ESTIMATE IN FAVOR OF THE TOWN OF CANANDAIGUA IS TO BE PREPARED BY THE APPLICANT AND PROVIDED TO THE TOWN DEVELOPMENT OFFICE FOR REVIEW AND ACCEPTED BY THE TOWN BOARD PRIOR TO THE ISSUANCE OF BUILDING PERMITS.
- 10. THE COMMENTS WITHIN THE TOWN ENGINEER'S LETTER DATED AUGUST 19, 2016 ARE TO BE ADDRESSED TO THE SATISFACTION OF THE TOWN ENGINEER PRIOR TO SIGNING BY THE PLANNING BOARD CHAIRMAN.
- 11. THE COMMENTS WITHIN THE TOWN HIGHWAY AND WATER SUPERINTENDENTS LETTER DATED AUGUST 4, 2016 ARE TO BE ADDRESSED TO THE SATISFACTION OF THE TOWN HIGHWAY AND WATER SUPERINTENDENT PRIOR TO SIGNING BY THE PLANNING BOARD CHAIRMAN.
- 12. THE FINAL SUBDIVISION PLANS ARE TO BE REVISED TO DELINEATE A STONE DUST TRAIL ALONG ST. JAMES PARKWAY EXTENDING FROM HARVEST VIEW TO MIDDLE CHESHIRE ROAD CONNECTING TO THE EXISTING TRAIL NETWORK.
- 13. THE FINAL SUBDIVISION PLANS ARE TO BE REVISED TO DEPICT A 20' WIDE EASEMENT TO THE TOWN OF CANANDAIGUA ALONG THE MIDDLE CHESHIRE EXTENDING FROM ST. JAMES PARKWAY TO THE NORTH PROPERTY LINE.
- 14. THE LANDSCAPING PLAN IS TO BE UPDATED TO COMPLY WITH THE NYSDEC SPECIES LAW.

LIST OF DRAWINGS							
Sheet No.	t No. DWG. No. Description						
1	COVER	COVER SHEET					
2	SV0.1	OVERALL PLAN					
3	SV1.0	SUBDIVISION PLAT - SHEET 1					
4	SV1.1	SUBDIVISION PLAT - SHEET 2					
5	CO.1	NOTES, LEGEND & ABBREVIATIONS					
6 C1.0		EXISTING CONDITIONS PLAN					
7	C3.0	UTILITY PLAN - SHEET 1					
8	C3.1	UTILITY PLAN - SHEET 2					
9	C4.0	GRADING PLAN - SHEET 1					
10	C4.1	GRADING PLAN - SHEET 2					
11	C4.2	EROSION CONTROL PLAN - SHEET 1					
12	C4.3	EROSION CONTROL PLAN - SHEET 2					
13	C4.4	EROSION CONTROL DETAILS					
14	C6.0	PROFILE - ST. JAMES PARKWAY					
15	C6.1	PROFILE - WOODVINE RISE					
16	C8.0	LANDSCAPING PLAN - SHEET 1					
17	C8.1	LANDSCAPING PLAN - SHEET 2					
18	C8.2	DEEP HOLE SOILS DATA					
19	C9.0	CONSTRUCTION DETAILS					
20	C9.1	CONSTRUCTION DETAILS					
21	C9.2	CONSTRUCTION DETAILS					


APPLICANT:

Morrell Builders

A successful builder for over 50 years

1501 PITTSFORD-VICTOR ROAD, STE. 100 VICTOR, NY 14564

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NEW YORK

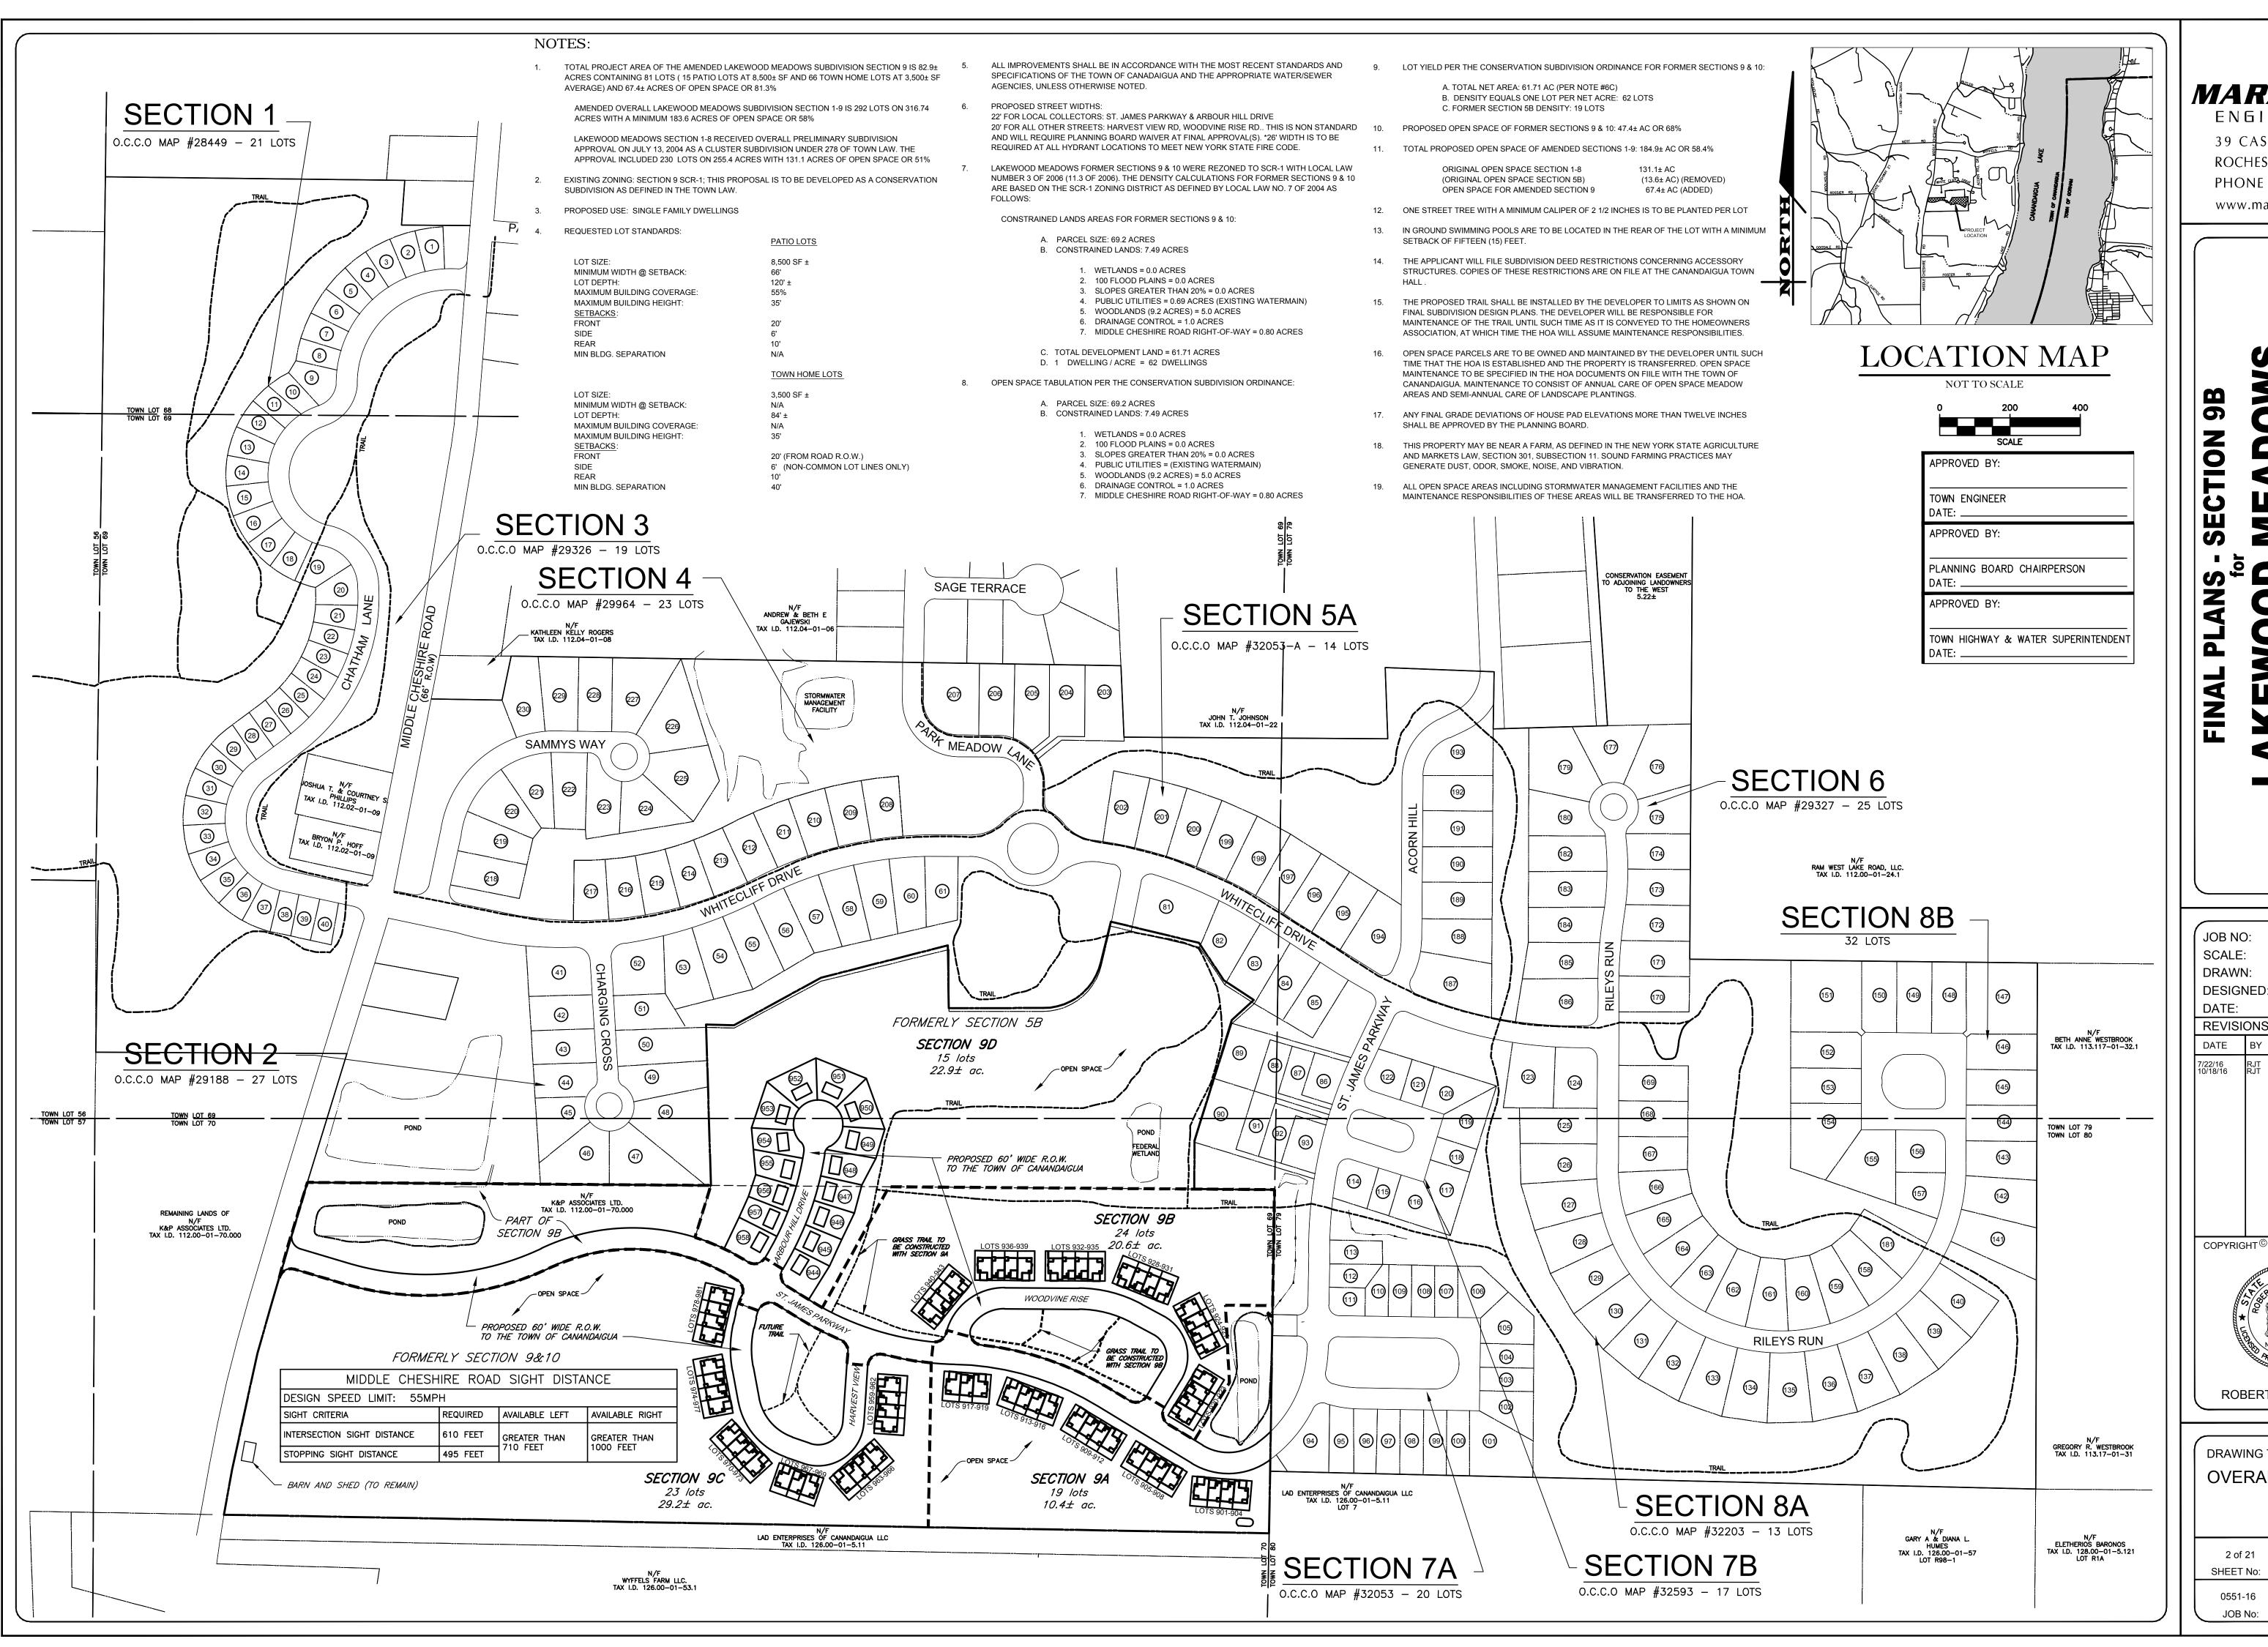EADOWS ION

ST. JAMES PARKW

0551-16 1" = 200' RJT

0551-16 1" = 200' RJT D: RJT 7/15/16

DATE BY REVISION

7/22/16
10/18/16

RJT REV. TRAILS
ISSUED FOR FINAL REVIEV

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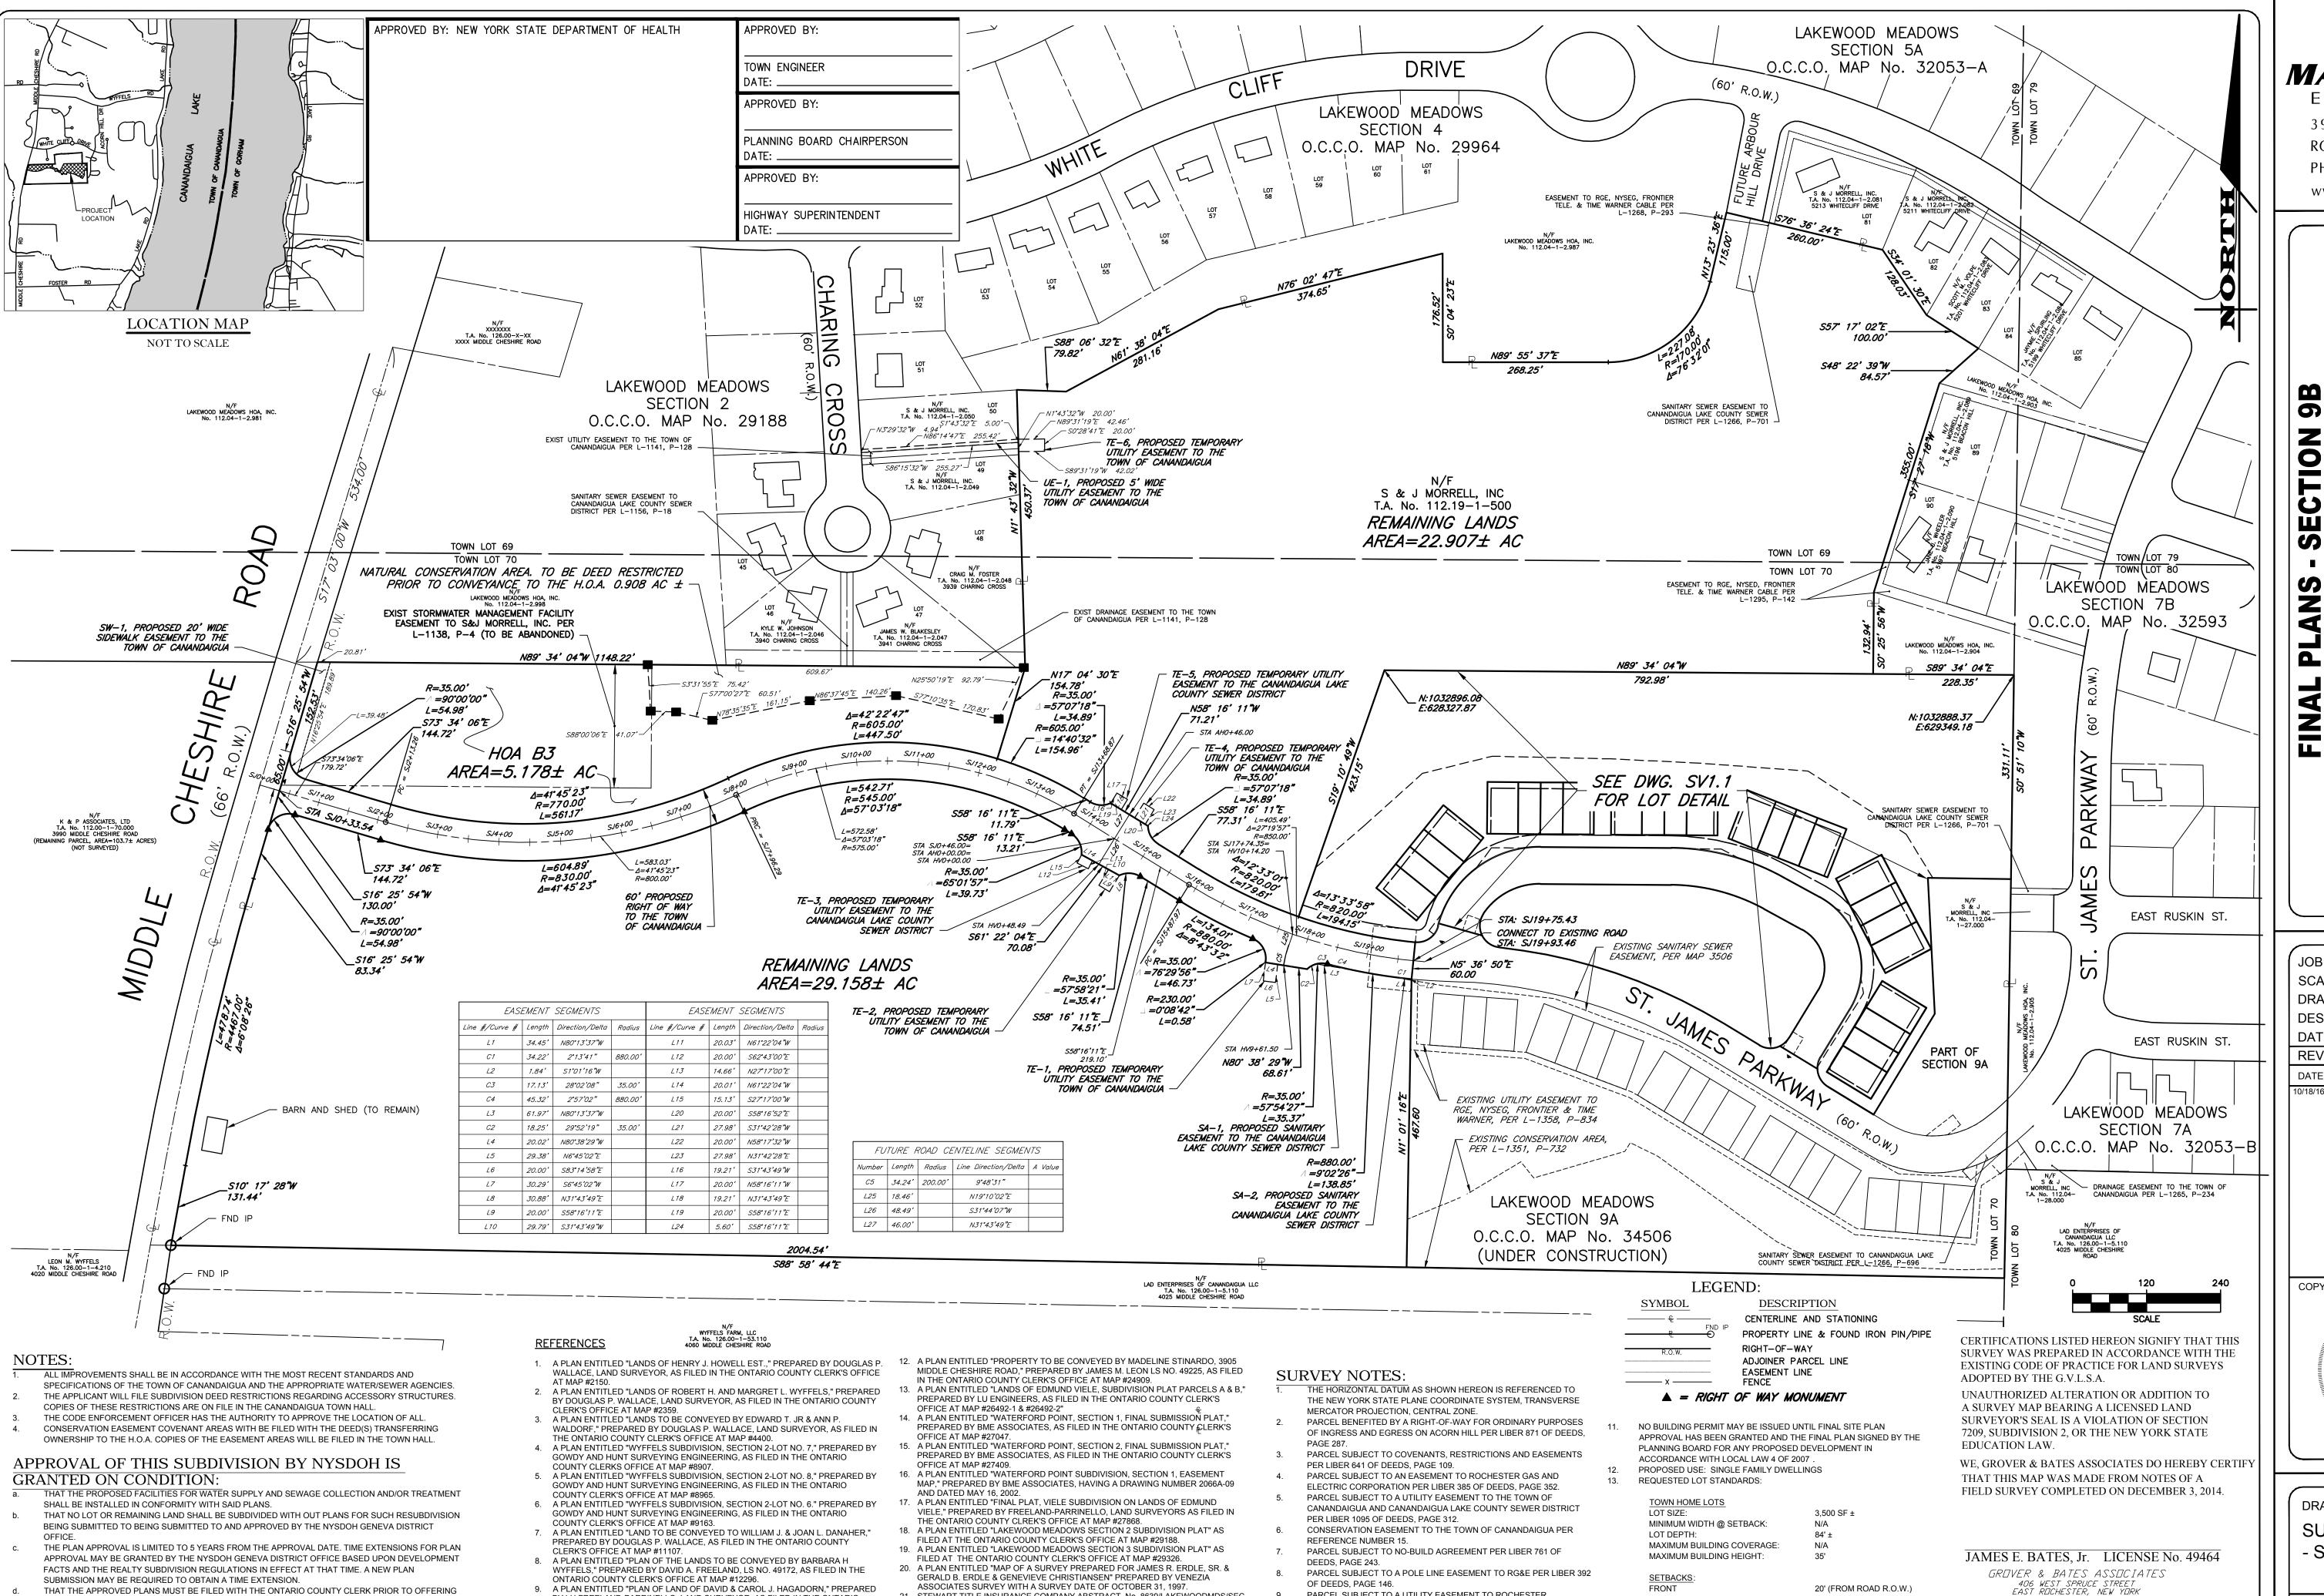
ROBERT P. BRINGLEY

DRAWING TITLE:

OVERALL PLAN

2 of 21
SHEET No:

0551-16
JOB No:
DRAWING No:



STEWART TITLE INSURANCE COMPANY ABSTRACT No. 8639/LAKEWOODMDS/SEC

22. A PLAN ENTITLED "FINAL PARCEL ANNEXATION MAP, LANDS TO BE ANNEXED TO

S&J MORRELL" AS FILED IN THE ONTARIO COUNTY CLERKS OFFICE AT MAP

23. A PLAN ENTITLED "LAKEWOOD MEADOWS SECTION 9B SUBDIVISION PLAT" AS

FILED AT THE ONTARIO COUNTY CLERK'S OFFICE AT MAP #34506

5, LAST DATED NOVEMBER 10, 2014

BY LU FREELAND-PARRINELLO, LAND SURVEYOR, AS FILED IN THE ONTARIO

10. A PLAN ENTITLED "PLAN OF LAND OF DAVID & CAROL J. HAGADORN," PREPARED

BY LU FREELAND-PARRINELLO, LAND SURVEYOR, AS FILED IN THE ONTARIO

PREPARED BY WARREN R. MCGRAIL, LAND SURVEYOR, AS FILED IN THE ONTARIO

11. A PLAN ENTITLED "RESUBDIVISON OF LOTS 1,2,3,4,8 & 9 OF THE LANDINGS,"

COUNT CLERK'S OFFICE AT MAP #19422.

COUNT CLERK'S OFFICE AT MAP #20379.

COUNTY CLERK'S OFFICE AT MAP #22018.

LOTS FOR SALE AND WITHIN 90 DAYS OF THE DATE OF PLAN APPROVAL.

PART OF TOWN LOTS 69&70, TOWNSHIP 9, RANGE 3

OF THE PHELPS AND GORHAM PURCHASE

THAT ALL LOCAL AND STATE AGENCY RULES AND REGULATIONS SHALL BE COMPLIED WITH.

PARCEL SUBJECT TO A UTILITY EASEMENT TO ROCHESTER

TELEPHONE CORPORATION PER LIBER 651 OF DEEDS PAGE 712.

FARM NOTE: THE PROPERTY WHICH IS THE SUBJECT OF THIS

SUBDIVISION IS LOCATED WITHIN AN AGRICULTURAL DISTRICT

SUCH FARM OPERATIONS MAY GENERATE DUST, ODOR, SMOKE,

NOISE, VIBRATION AND OTHER ACTIVITIES WHICH MAY NOT BE

COMPATIBLE WITH RESIDENTIAL USE OF THE PROPERTY.

CONTAINING FARM OPERATION. RESIDENTS SHOULD BE AWARE THAT

SIDE

MIN BLDG. SEPARATION

No OF LOTS: 24

SECTION 9B AREA: 20.564± ACRES

OPEN SPACE: 14.544± ACRES

6' (NON-COMMON

LOT LINES ONLY)

*MARATHON* ENGINEERING

39 CASCADE DRIVE ROCHESTER, NY 14614 PHONE 585-458-7770

www.marathoneng.com OF

JOB NO: 0551-16 SCALE: 1" = 120' DRAWN: RJT DESIGNED: RJT DATE: 1/17/15 REVISIONS DATE BY REVISION SSUED FOR FINAL REVIEW COPYRIGHT © 2016 MARATHON ENG.

JAMES E. BATES, JR. PLS

SHEET No: 0551-16

OWNER T.A. No. 112.19-1-500


S & J MORRELL, INC. 1501 PITTSFORD VICTOR ROAD,

SUITE 100

VICTOR, NY 14564

**DRAWING TITLE:** SUBDIVISION PLAT - SHEET 1

JOB No: DRAWING No:

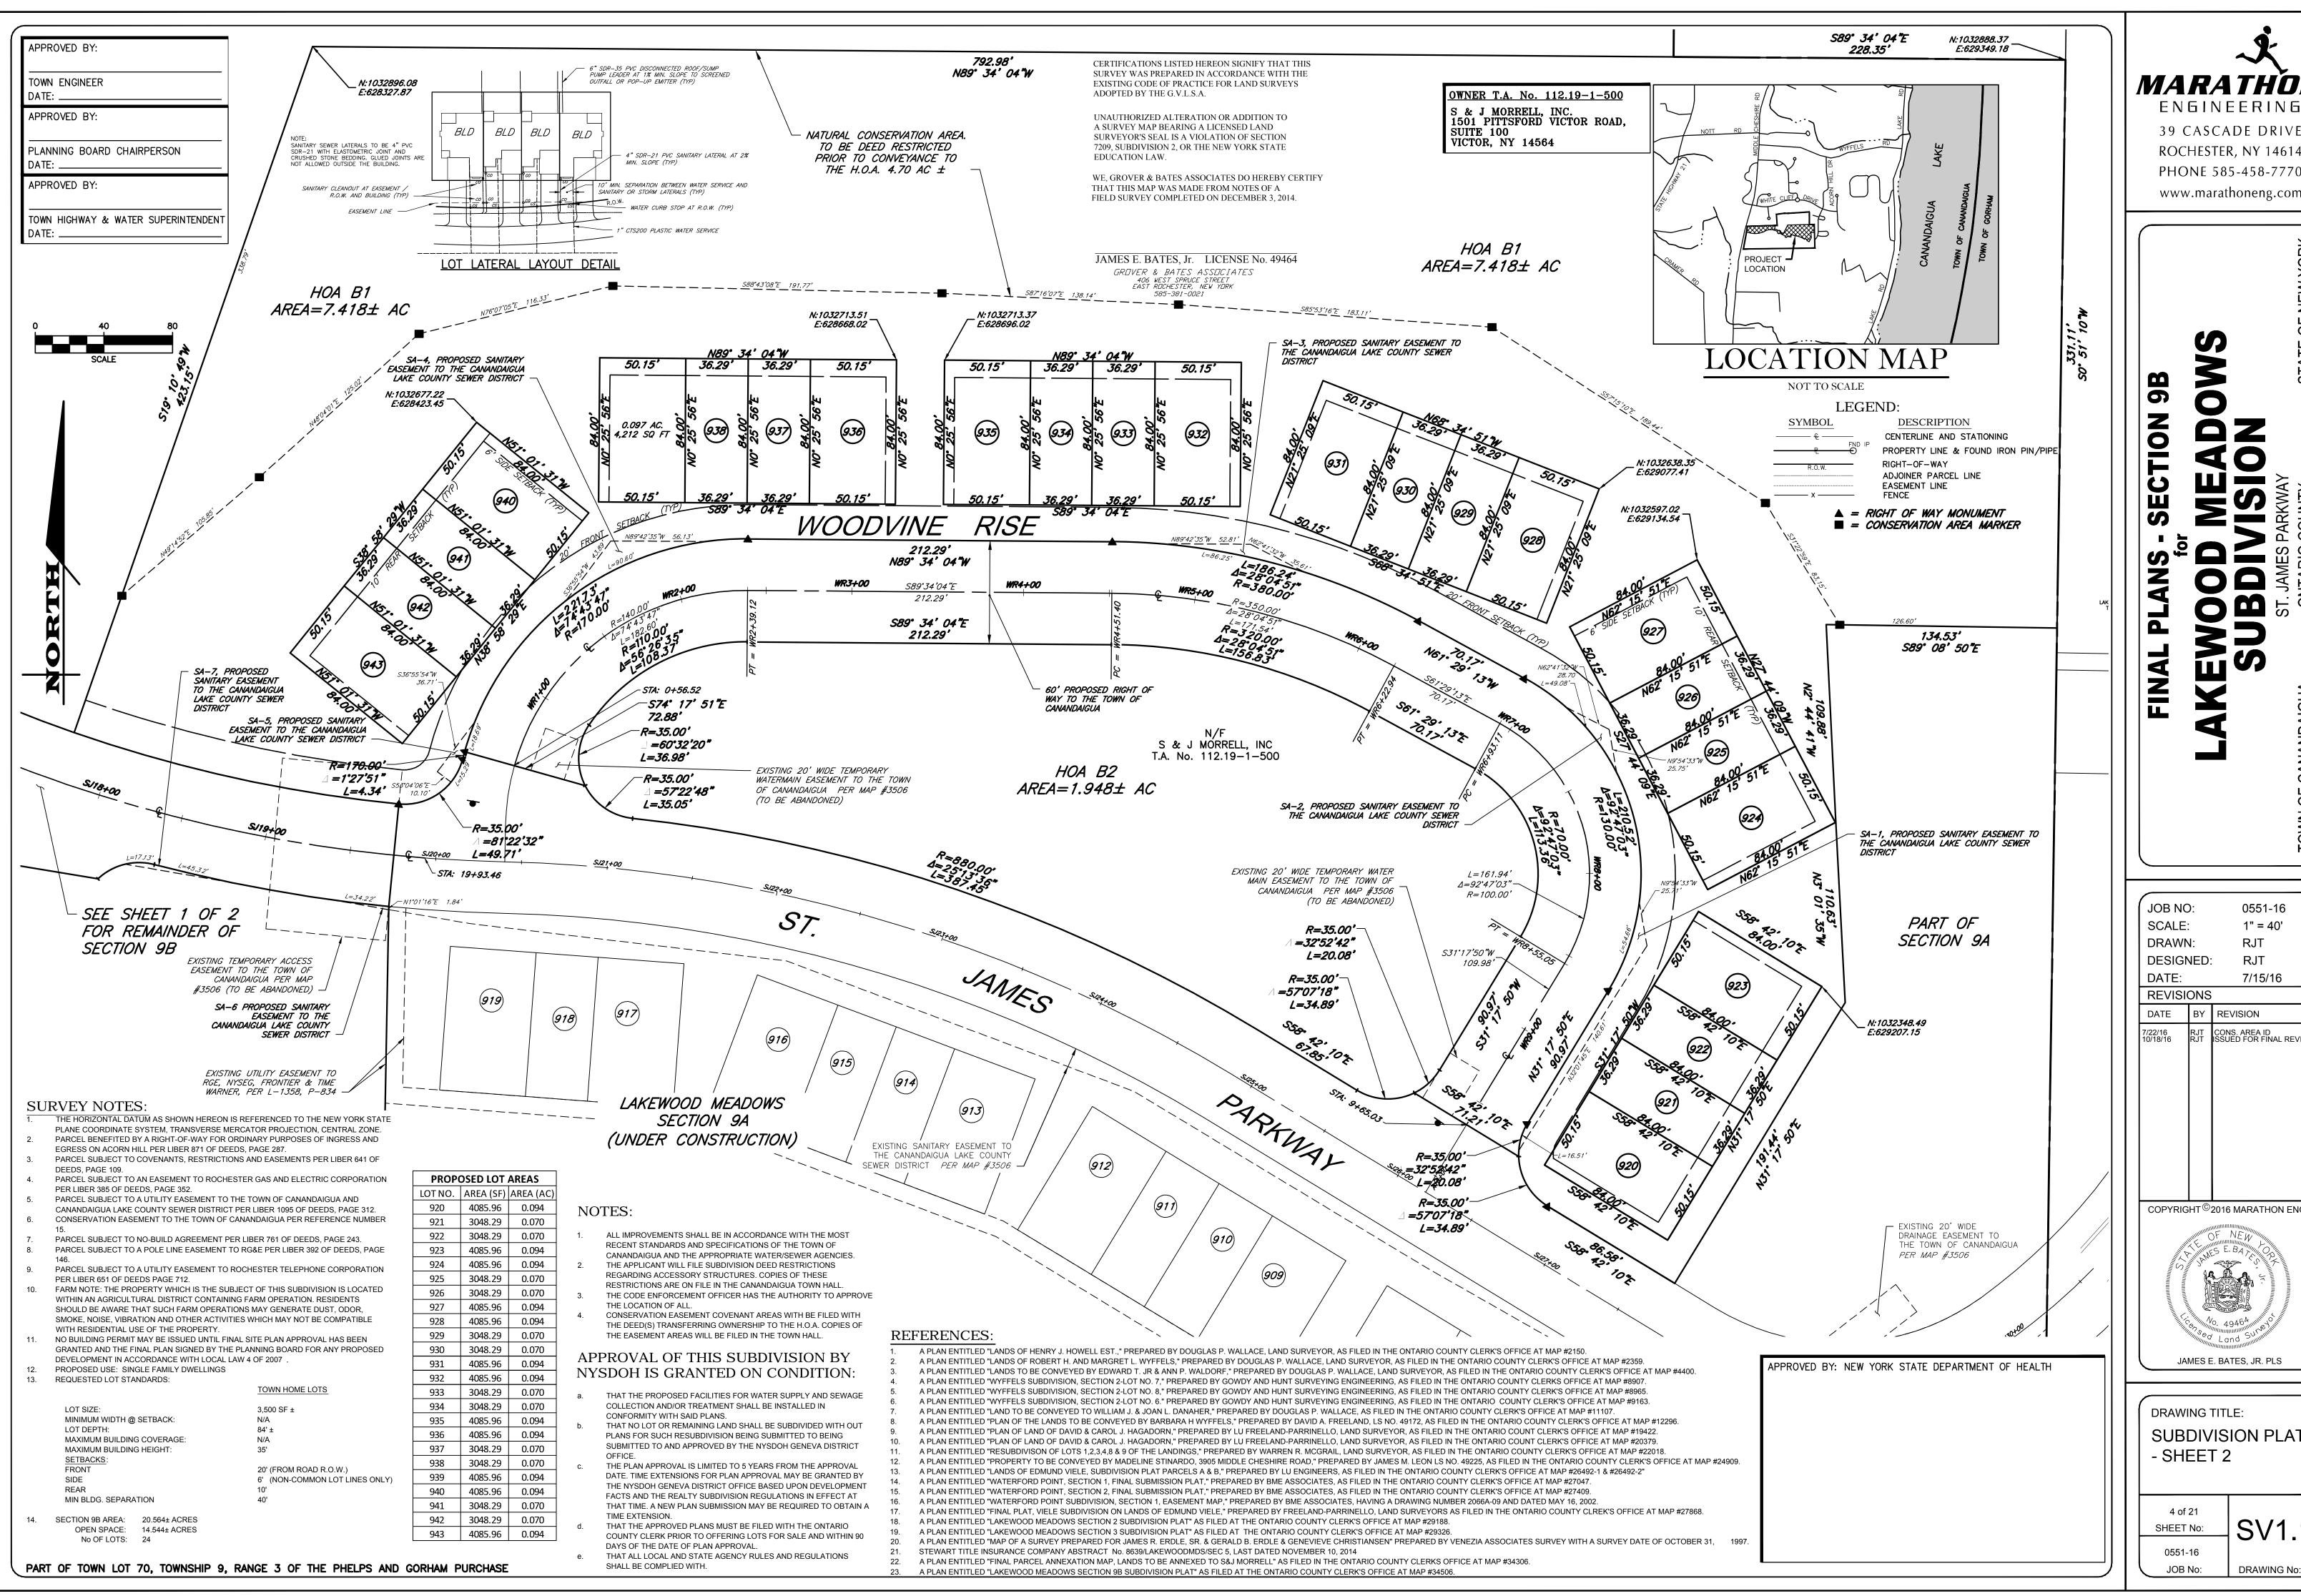

**MARATHON** 

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JOB NO: 0551-16 1" = 40' RJT DESIGNED: RJT 7/15/16

REVISIONS DATE REVISION CONS. AREA ID SSUED FOR FINAL REVIEW COPYRIGHT©2016 MARATHON ENG.

**DRAWING TITLE:** SUBDIVISION PLAT - SHEET 2

JAMES E. BATES, JR. PLS

SHEET No: 0551-16 DRAWING No:

# NOTES, INFORMATION AND SPECIFICATIONS

### GENERAL

- 1. APPLICABILITY THE NOTES AND INFORMATION PROVIDED ON THIS SHEET ARE APPLICABLE TO ALL "C" SERIES DRAWINGS. THE "C" SERIES DRAWINGS COVER SITE RELATED IMPROVEMENTS OUTSIDE THE BUILDING ENVELOPE. THE BUILDING ENVELOPE INCLUDES ALL AREA WITHIN 5' OUTSIDE OF THE BUILDING'S EXTERIOR WALL.
- 2. MAPPING THE EXISTING UNDERGROUND UTILITIES WERE PLOTTED BASED ON RECORD MAPPING SUPPLIED BY OTHERS. THE ENGINEER MAKES NO WARRANTY AS TO THE LOCATION, SIZE, TYPE, ELEVATION, AND/OR NUMBER OF EXISTING UTILITIES. THE CONTRACTOR SHALL BE RESPONSIBLE FOR DETERMINING THE HORIZONTAL AND VERTICAL LOCATION OF UTILITIES IN THE VICINITY OF THE NEW INFRASTRUCTURE.
- 3. STAKEOUT THE CONTRACTOR SHALL NOTIFY DIG SAFELY NEW YORK (1-800-962-7962) FOR A UTILITY STAKEOUT 48 HOURS IN ADVANCE OF COMMENCING WORK. STAKEOUT OF PRIVATE UTILITIES SHALL BE COORDINATED WITH THE OWNER.
- 4. PROPERTY PROTECTION THE CONTRACTOR IS RESPONSIBLE FOR DAMAGE TO EXISTING PAVEMENT, CURBS, WALKS, LAWNS, TREES, ETC. CAUSED BY THEIR CONSTRUCTION OPERATIONS. ALL DAMAGE SHALL BE REPAIRED OR REPLACED BY THE CONTRACTOR TO THE OWNER'S SATISFACTION AT NO ADDITIONAL EXPENSE.
- 5. ACCESS THE CONTRACTOR SHALL PROVIDE SATISFACTORY VEHICULAR ACCESS TO ALL ADJOINING PROPERTIES, PRIVATE ROADWAYS, PARKING FACILITIES, AND PUBLIC STREETS DURING CONSTRUCTION.
- 6. SITE SAFETY PRIOR TO AND THROUGHOUT CONSTRUCTION, THE CONTRACTOR SHALL POST SIGNAGE IN CONFORMANCE WITH THE REQUIREMENTS OF THE LOCAL MUNICIPALITY AND OCCUPATIONAL HEALTH AND SAFETY ACT (OHSA). JOB SAFETY AND MAINTENANCE AND PROTECTION OF TRAFFIC IS THE RESPONSIBILITY OF THE CONTRACTOR.
- 7. EXCAVATIONS ALL EXCAVATIONS SHALL BE BACKFILLED/BARRICADED TO THE SATISFACTION OF THE OWNER'S REPRESENTATIVE AT THE CONCLUSION OF EACH WORKING DAY.
- 8. MAINTENANCE PUBLIC STREETS, PRIVATE DRIVES AND PARKING FACILITIES SHALL BE KEPT FREE OF FOREIGN MATERIALS. ALL AREAS SHALL BE SWEPT CLEAN AT THE END OF EACH WORKING DAY AND/OR AS DIRECTED BY THE OWNER'S ON-SITE REPRESENTATIVE.
- 9. CONSTRUCTION STORAGE STORAGE OF EQUIPMENT AND MATERIALS SHALL BE WITHIN A SPECIFIED AND SECURED AREA AS DETERMINED IN CONTRACT DOCUMENTS OR AS SPECIFIED BY THE OWNER'S ON-SITE REPRESENTATIVE.
- 10. PERMIT(S) PRIOR TO CONSTRUCTION, THE CONTRACTOR SHALL OBTAIN THE NECESSARY PERMITS FROM THE APPLICABLE MUNICIPALITY OR AGENCY. THE CONTRACTOR IS RESPONSIBLE FOR ALL BONDS AND INSURANCES AND THE OWNER IS RESPONSIBLE FOR PERMIT FEES UNLESS OTHERWISE STATED IN THE OWNER/ CONTRACTOR AGREEMENT

### CONSTRUCTION

- 1. STAKEOUT THE CONSTRUCTION STAKEOUT SHALL BE PERFORMED BY A LICENSED LAND SURVEYOR USING CONTROL PROVIDED ON THESE PLANS. ANY DISCREPANCIES SHALL BE REPORTED TO THE DESIGN ENGINEER (PRIOR TO THE INSTALLATION OF IMPROVEMENTS) FOR COORDINATION AND CLARIFICATION.
- 2. DEMOLITION CLEARING AND GRUBBING SHALL BE LIMITED TO THE SITE BOUNDARIES OR WITHIN THE "WORK LIMIT LINE" AS DEFINED ON THE PLAN. TREES AND OBJECTS DESIGNATED FOR REMOVAL SHALL BE COORDINATED AND FIELD VERIFIED WITH PROJECT ON-SITE REPRESENTATIVE. ALL MATERIALS SHALL BE LEGALLY DISPOSED OF OFF-SITE OR RETURNED TO OWNER AS DIRECTED BY CONTRACT DOCUMENTS. ALL ITEMS NOT SPECIFICALLY CALLED OUT TO BE
- 3. COORDINATION THE CONTRACTOR SHALL COORDINATE INSTALLATION OF UTILITY WORK WITH OTHER SITE UTILITIES (I.E. GAS, ELECTRIC, LIGHTING, COMMUNICATIONS) TO AVOID POTENTIAL INSTALLATION CONFLICTS.
- 4. STAGING AS DEFINED BY THE CONTRACT DOCUMENTS THE CONTRACTOR SHALL CONSTRUCT A SECURE STAGING AREA FOR STORAGE OF EQUIPMENT, MATERIALS, EMPLOYEE PARKING AND OFFICE SPACE. IF THE AREA/METHOD IS NOT SPECIFICALLY DEFINED ON THE DOCUMENTS THEN IT SHALL BE COORDINATED WITH THE OWNER'S ON-SITE
- 5. CLOSE-OUT THE CONTRACTOR'S WORK SCOPE INCLUDES BUT IS NOT LIMITED TO THE FOLLOWING AT PROJECT CLOSE-OUT TO THE SATISFACTION OF OWNER'S ON-SITE REPRESENTATIVE:
- LOSE-OUT TO THE SATISFACTION OF OWNER'S ON-SIT REMOVAL OF ANY CONSTRUCTION DEBRIS.
- CLEANING PAVEMENT AND WALKWAY SURFACES.
- RESTORATION OF ALL DISTURBED GRASS AND LANDSCAPED AREAS.
   PROVIDING BONDS, GUARANTEES, CERTIFICATIONS, ETC. AS REQUIRED BY CONTRACT DOCUMENTS.
- PROVIDING A RECORD DRAWING.
  COMPLETION OF FINAL PUNCH LIST ITEMS.
- 6. CONSTRUCTION ENTRANCE & PARKING INITIALLY, CONSTRUCTION EQUIPMENT, TRUCKS, EMPLOYEES OF THE SUB-CONTRACTORS, ETC. WILL USE THE ENTRANCE OFF WYFFELS ROAD TO ACCESS THE SITE. THE ROAD IS TO BE KEPT CLEAN FOR THE RESIDENTS WHO LIVE THERE. PROVIDE A PARKING AREA FOR VEHICLES OTHER THAN THE PUBLIC ROAD FOR EMPLOYEES WORKING ON THE SITE.
- AFTER THE ST. JAMES PARKWAY CONNECTION IS MADE TO MIDDLE CHESHIRE ROAD, CONSTRUCTION EQUIPMENT, TRUCKS, EMPLOYEES OF THE SUB-CONTRACTORS, ETC. WILL USE THIS ENTRANCE TO ACCESS THE CONSTRUCTION SITE.

ABBR.	TERM	ABBR.	TERM		
AC.	ACRE	LS	LUMP SUM		
A.O.B.E.	AS ORDERED BY ENGINEER	I T.	LEET		
ASPH.	ASPHALT	MB.	MAILBOX		
AZ.	AZIMUTH	M.O.	MIDDLE ORDINATE		
₿	BASELINE	MON.	MONUMENT OR MONTH		
ВМ	BENCHMARK	MCGS	MONROE COUNTY GEODETIC SURVEY		
Ç	CENTERLINE	M.H.	MANHOLE		
CLF	CHAIN LINKED FENCE	NEC.	NECESSARY		
C.O.	CLEAN-OUT	N.I.C.	NOT-IN- CONTRACT		
CONC.	CONCRETE	NTS	NOT TO SCALE		
CPP	CORRUGATED POLYETHYLENE PIPE	N/F	NOW OR FORMERLY		
CSP	CORRUGATED STEEL PIPE	PAV'T.	PAVEMENT		
COV.	COVER	PE	POLYETHYLENE PIPE		
CB	CURB BOX	PPE	PERFORATED POLYETHYLENE PIPE		
CY	CUBIC YARD	PC	POINT OF CURVATURE		
D.	DEGREE OF CURVE	PI	POINT OF INTERSECTION		
DIA.	DIAMETER	PT	POINT OF TANGENCY		
DI	DROP INLET	PVC	POINT OF VERTICAL CURVATURE		
D.I.P.	DUCTILE IRON PIPE	PVI	POINT OF VERTICAL INTERESECTION		
EA.	EACH	PVT	POINT OF VERTICAL TANGENCY		
EIC	ENGINEER IN CHARGE	PP	POWER POLE		
ELEV.	ELEVATION	P	PROPERTY LINE		
EP	EDGE OF PAVEMENT	Ŕ.	RADIUS		
FF	FINISH FLOOR = FINISH FLOOR ELEVATION	RCP	REINFORCED CONCRETE PIPE		
FI	FIELD INLET	RG&E	ROCHESER GAS AND ELECTRIC		
FR.	FRAME	R.O.W.	RIGHT-OF-WAY		
FP	FINISH PAD = GARAGE FLOOR ELEVATION	RT.	RIGHT		
FT.	FEET	RTC	ROCHESTER TELEPHONE COMPANY		
G	GAS MAIN	SA.	SANITARY SEWER		
GAL.	GALLON	ST.	STORM SEWER		
GR.	GRAVEL	STA.	STATION		
G.R.	GUIDE RAIL	STY.	STORY		
HCL	HORIZONTAL CONTROL LINE	SY	SQUARE YARD		
HYD.	HYDRANT	I.	TANGENT DISTANCE		
INV.	INVERT	TGL	THEORETICAL GRADE LINE		
IP	IRON PIPE OR IRON PIN	TYP.	TYPICAL		
L.	LENGTH OR LENGTH OF CURVE	VC	VERTICAL CURVE		
LF	LINEAR FEET	VTP	VITRIFIED TILE PIPE		
LP	LIGHT POST (PRIVATE)	Δ	CENTRAL ANGLE		

### UTILITIES

### 1. STORM

- 1.1 REGULATIONS STORM SEWERS AND APPURTENANCES SHALL BE CONSTRUCTED IN CONFORMANCE WITH THE LATEST REGULATIONS OF THE MUNICIPALITY.
- 1.2 MATERIALS THE CONTRACTOR MAY USE THE FOLLOWING PIPE MATERIAL FOR THE MAIN SEWER AS ALLOWED BY THE MUNICIPALITY, PROVIDING THAT THE ROUGHNESS COEFFICIENT ("N" FACTOR) IS 0.013 OR BETTER:
  - REINFORCED CONCRETE PIPE (RCP), CLASS III
    HIGH DENSITY CORRUGATED POLYETHYLENE PIPE (PE), AASHTO M-29, TYPE S, ASTM D-3350.
- 1.3 ROOF DRAINAGE ALL ROOF DRAINAGE AND SUMP PUMPS SHALL BE DISCONNECTED TO THE REAR OF THE LOT AS SHOWN IN THE PLANS
- 1.4 TESTING UPON COMPLETION OF SYSTEM INSTALLATION, THE MAIN SEWER SYSTEM AND LEADS TO STRUCTURES SHALL BE FLUSHED AND LAMPED TO THE SATISFACTION OF THE MUNICIPALITY.

### 2. PUBLIC WATER EXTENSION

- CANANDAIGUA CONSOLIDATED WATER DISTRICT AND NEW YORK STATE DEPARTMENT OF HEALTH
- 2.1 SPECIFICATIONS WATER MAINS AND APPURTENANCES TO BE CONSTRUCTED IN ACCORDANCE WITH THE REGULATIONS AND SPECIFICATIONS OF THE TOWN OF CANANDAIGUA WATER DEPARTMENT AND NYSDOH.
  - WATER MAIN(S) SHALL BE 8" DR-14 PLASTIC.
  - WATER SERVICE(S) SHALL BE 1-INCH CTS200 FROM THE WATER MAIN TO THE CURB BOX AND 1-INCH FROM THE CURB BOX TO THE METER.
  - WATER METER(S) SHALL BE LOCATED ON THE INTERIOR OF EXTERIOR WALLS IMMEDIATELY UPON SERVICE ENTRANCE INTO THE BUILDING(S). ON METERED SERVICES REQUIRING A 1 1/2-INCH OR LARGER METER A BYPASS AROUND THE METER IS REQUIRED.
  - ' ALL GATE VALVES SHALL HAVE STAINLESS STEEL BODY AND BONNET BOLTS.
  - ALL WATERMAIN MATERIALS AND GATE VALVES ARE TO BE MUELLER AND ALL CAST IRON FITTINGS ARE TO BE TYLER.

    HYDRANTS ARE TO BE PAINTED RED.

### 2.3 TESTING:

PRESSURE - THE WATER MAIN SHALL BE PRESSURE/LEAKAGE TESTED IN ACCORDANCE WITH THE MINIMUM REQUIREMENTS OF THE AWWA STANDARD C605 (LATEST REVISION) OR IN ACCORDANCE WITH MORE STRINGENT REQUIREMENTS IMPOSED BY THE CANANDAIGUA WATER DEPARTMENT.

### HEALTH SAMP

- THE WATER MAIN SHALL BE DISINFECTED EQUAL TO AWWA STANDARD SPECIFICATIONS, DESIGNATION C-651, BY USING THE CONTINUOUS FEED METHOD. AFTER FLUSHING AND DISINFECTING THE WATER MAIN, WATER SAMPLES SHALL BE COLLECTED FROM THE MAIN BY THE TOWN OF CANANDAIGUA WATER DEPARTMENT AND RESULTS PROVIDED TO NYSDOH
- TWO CONSECUTIVE DAYS OF ACCEPTABLE BACTERIOLOGICAL SAMPLE RESULTS ARE REQUIRED. FIRE HYDRANTS
  ARE NOT ACCEPTABLE SAMPLING POINTS. APPROVAL AND NOTIFICATION BY THE HEALTH DEPARTMENT MUST BE
  RECEIVED BEFORE THE MAIN IS PLACED IN SERVICE.

### 2.4 INSTALLATION:

WATER MAINS AND ALL WATER SERVICE LINES SHALL HAVE A MINIMUM OF FIVE FEET OF COVER FROM FINISHED GRADE IN LAWN AREAS AND A MINIMUM OF SIX FEET OF COVER FROM FINISHED GRADE IN PAYED AREAS

TRACER WIRE IS TO BE PLACED WITH THE WATERMAIN AND LOOPED AT THE FIRE HYDRANTS.

MINIMUM VERTICAL SEPARATION BETWEEN WATER MAINS AND SEWER PIPELINES SHALL BE 18 INCHES MEASURED FROM THE OUTSIDE OF THE PIPES AT THE POINT OF CROSSING. ONE FULL STANDARD LAYING LENGTH OF WATER MAIN SHALL BE CENTERED UNDER OR OVER THE SEWER SO THAT BOTH JOINTS WILL BE AS FAR FROM THE SEWER AS POSSIBLE. IN ADDITION, WHEN THE WATER MAIN PASSES UNDER A SEWER, ADEQUATE STRUCTURAL SUPPORT (COMPACTED SELECTED FILL) SHALL BE PROVIDED FOR THE SEWER TO PREVENT EXCESSIVE DEFLECTIONS OF JOINTS AND SETTLING OF THE SEWER ON THE WATER MAIN. MINIMUM HORIZONTAL SEPARATION BETWEEN PARALLEL WATER MAINS AND SEWER PIPES (INCLUDING MANHOLES AND VAULTS) SHALL BE 10 FEET MEASURED FROM THE OUTSIDE OF THE PIPES, MANHOLES, OR VAULTS.

FIRE HYDRANT WEEP HOLES (DRAINS) SHALL BE PLUGGED WHEN GROUND WATER IS ENCOUNTERED WITHIN SEVEN FEET OF THE FINISHED GRADE.

ALL MECHANICAL JOINT FITTINGS (TEES, BENDS, PLUGS, ETC.) SHALL BE BACKED WITH 2500 PSI CONCRETE THRUST BLOCKS

THERE ARE NO KNOWN SOIL CHARACTERISTICS REQUIRING SPECIAL INSTALLATION MEASURES (WRAPPING PIPE, ETC.). IF CONTRACTOR ENCOUNTERS SOILS DURING INSTALLATION THAT MAY REQUIRE SPECIAL INSTALLATION MEASURES NOT INCLUDED IN THIS DOCUMENT, THE CONTRACTOR SHALL CONTACT THE ENGINEER FOR OBSERVATION AND INSTALLATION DIRECTION.

THE TOWN OF CANANDAIGUA WATER SUPERINTENDANT IS TO BE CONTACTED TO INSPECT WATERMAIN MATERIALS

2.5 FLUSHING - WATER MAINS DESIGNATION C651 (LATEST REVISION). FOLLOWING DISINFECTION, THE WATER MAIN SHALL BE FLUSHED UNTIL THE CHLORINE CONCENTRATION IN THE WATER LEAVING THE MAIN IS NO HIGHER THAN THAT GENERALLY PREVAILING IN THE SYSTEM. FLUSHING OF THE WATER MAIN MUST BE WITNESSED BY THE TOWN OF CANANDAIGUA WATER DEPARTMENT EMPLOYEES. THE TOWN OF CANANDAIGUA WILL PROVIDE A DE-CHLORINATION DEVICE FOR THE SUPER-CLORINATED WATER.

### 2.6 DISINFECTION -

THE WATER MAIN SHALL BE DISINFECTED EQUAL TO AWWA STANDARD FOR DISINFECTING WATER MAINS DESIGNATION C651 (LATEST REVISION). FOLLOWING DISINFECTION, THE WATER MAIN SHALL BE FLUSHED UNTIL THE CHLORINE CONCENTRATION IN THE WATER LEAVING THE MAIN IS NO HIGHER THAN THAT GENERALLY PREVAILING IN THE SYSTEM.

ALL WATER MAIN FITTINGS NOT RECEIVING 24-HOUR CHLORINE DISINFECTION CONTACT TIME MUST BE SWAB DISINFECTED 30 MINUTES PRIOR TO INSTALLATION.

### 2.7 SAMPLING - THE SAMPLING POINT(S) MUST BE DECONTAMINATED BY FLAMING.

- FIRE HYDRANTS ARE NOT ACCEPTABLE SAMPLING POINTS
   SAMPLING SHALL NOT BE PERFORMED PRIOR TO RECEIPT FROM A NEW YORK
- STATE LICENSED OR REGISTERED DESIGN PROFESSIONAL (ENGINEER, ARCHITECT OR LAND SURVEYOR WITH A SPECIAL EXEMPTION UNDER SECTION 7208(N) OF THE EDUCATION LAW) CERTIFYING THAT THE WATER SUPPLY IMPROVEMENTS, TESTING AND DISINFECTION PROCEDURES WERE COMPLETED IN ACCORDANCE WITH THE APPROVED PLANS, REPORTS, SPECIFICATIONS AND ANY APPROVED AMENDMENTS. SAMPLES SHALL BE COLLECTED FOR FREE CHLORINE RESIDUAL, TOTAL COLIFORM, ESCHERICHIA COLI (E. COLI) AND TURBIDITY.

  THE WATER MAIN SHALL NOT BE PLACED INTO SERVICE LINTIL SO ALITHOPIZED BY THE NEW YORK STATE DEPT.
- THE WATER MAIN SHALL NOT BE PLACED INTO SERVICE UNTIL SO AUTHORIZED BY THE NEW YORK STATE DEPT. OF HEALTH.

  TOWN OF CANANDAIGUA WATER DEPARTMENT WILL COLLECT SAMPLES.

### EARTHWORK

- 1. PREPARATION PRIOR TO START OF EARTHWORK OPERATIONS THE CONTRACTOR SHALL COMPLETE THE FOLLOWING APPLICABLE ITEMS AS DEFINED BY CONTRACT DOCUMENTS:
- SITE DEMOLITION REMOVAL AND DISPOSAL OFF-SITE IN A LEGAL MANNER; STRUCTURES, UTILITIES, PAVEMENTS, ETC.
- **CLEARING AND GRUBBING** REMOVAL AND DISPOSAL OFF-SITE IN A LEGAL MANNER; TREES, BRUSH, STUMPS, ETC.
- **TOPSOIL STRIPPING** STRIP AND STOCKPILE TOPSOIL FOR REUSE. EXCESS TOPSOIL MAY BE REMOVED FROM SITE WITH APPROVAL BY OWNER AND MUNICIPALITY.
- 2. RESPONSIBILITY THE CONTRACTOR IS RESPONSIBLE FOR:
- ESTIMATE COMPLETION OF A QUANTITY TAKEOFF TO DETERMINE THE VOLUME OF CUT, FILL, AND TOPSOIL.
   COMPARE AND COORDINATE WITH INFORMATION PROVIDED BY THE DESIGN ENGINEER.
   GRADE TOLERANCES ESTABLISHING DESIGN SUBGRADE ELEVATIONS TO WITHIN ONE TENTH OF ONE FOO
- GRADE TOLERANCES ESTABLISHING DESIGN SUBGRADE ELEVATIONS TO WITHIN ONE TENTH OF ONE FOOT (0.10') IN PAVEMENT AREAS (INCLUDING WALKS) AND TO WITHIN THIRTY-THREE HUNDREDTHS OF ONE FOOT (0.33') FOR ALL REMAINING AREAS.
- **COMPACTION** ACHIEVING THE SPECIFIED MINIMUM COMPACTION VALUES FOR EMBANKMENT/FILL AREAS. THE TERMS "FILL" AND EMBANKMENT" ARE INTERCHANGEABLE. **CUTS** ONCE EXCAVATIONS ARE SHAPED TO THE DESIGN GRADES THE AREAS SHALL BE PROTECTED TO ASSURE
- THAT THE INTEGRITY OF MATERIAL IS NOT COMPROMISED BY CONSTRUCTION VEHICLES AND/OR IMPROPER DRAINAGE. AREAS DETERMINED BY CONTRACTOR TO BE **NOT** SUITABLE FOR SUBGRADE PLACEMENT SHALL BE IMMEDIATELY REPORTED WHEN THE SUBGRADE IS ESTABLISHED TO OWNER'S REPRESENTATIVE. STABILIZATION MEASURES FOR CUT AREAS MAY BE CONSIDERED BY OWNER'S REPRESENTATIVE AS A CHANGE TO THE BASE CONTRACT.
- 3. TESTING THE FOLLOWING MAXIMUM DRY DENSITIES SHALL BE ACHIEVED AS MEASURED BY THE MODIFIED PROCTOR METHOD ASTM D-1557:
- 95% UNDER PAVEMENTS, WALKS, AND IN STRUCTURAL FILL AREAS
   85% IN REMAINING AREAS
- THE AGREEMENT BETWEEN THE OWNER AND CONTRACTOR SHALL DEFINE THE NUMBER OF TESTS AND RESPONSIBILITY. WE RECOMMEND IN EMBANKMENT AREAS ONE PER LIFT AND/OR ONE PER 1,000 CUBIC YARDS.
- THE TOWN OF CANANDAIGUA HAS THE FOLLOWING ADDITIONAL REQUIREMENTS:
- METHODS AND EQUIPMENT PROPOSED FOR COMPACTION SHALL BE SUBJECT TO THE APPROVAL OF THE TOWN.
  COMPACTION BY ROLLING OR OPERATING HEAVY EQUIPMENT OVER FILL AREAS SHALL BE CONDUCTED IN A
  MANNER BY WHICH DAMAGE TO EXISTING UTILITIES AND STRUCTURES SHALL BE AVOIDED. ANY PIPE OR
  STRUCTURE DAMAGED THEREBY SHALL BE REPLACED OR REPAIRED AS DIRECTED BY THE TOWN AT THE EXPENSE
  OF THE DEVELOPER.
- FIELD DENSITY TESTS MAY BE ORDERED BY THE TOWN AS NECESSARY AND WILL BE PAID FOR BY THE DEVELOPER.
   THE DEVELOPER SHALL FURNISH ALL NECESSARY SAMPLES FOR LABORATORY TESTS AND SHALL PROVIDE ASSISTANCE AND COOPERATION DURING FIELD TESTS. THE DEVELOPER SHALL PLAN HIS OPERATIONS TO ALLOW ADEQUATE TIME FOR LABORATORY TESTS AND TO PERMIT TAKING OF FILED DENSITY TESTS DURING COMPACTION.
- ANY AREAS FOUND TO BE BELOW REQUIRED COMPACTION DENSITIES SHALL BE REMOVED AND REPLACED WITH NEW MATERIAL AT THE DEVELOPER'S EXPENSE. THE METHODS OF OPERATION AND/OR THE BACKFILL MATERIALS SHALL BE CHANGED TO MEET REQUIRED COMPACTIONS.
   INADEQUATE COMPACTION SHALL BE CAUSE FOR THE TOWN TO ISSUE A STOP WORK ORDER ON A PROJECT.
- 4. LIFT THICKNESS THE MAXIMUM LIFT THICKNESS UNDER PAVEMENTS, WALKS, AND STRUCTURAL FILLS SHALL BE 12 INCHES. HAND OPERATED COMPACTION FILLS SHALL NOT EXCEED 6 INCHES.
- 5. PROOF ROLLING THE TOWN OF CANANDAIGUA HIGHWAY DEPARTMENT SHALL BE NOTIFIED PRIOR TO A PROOF ROLL (I.E. LOADED TEN WHEELER) OF SUBGRADE AREAS BEING PERFORMED PRIOR TO PLACEMENT OF SUBBASE MATERIALS. AREAS THAT "FAIL" SHALL BE REMOVED AND REPLACED TO ACHIEVE A PASSING SUBGRADE.
- 6. EXISTING SOIL CONDITIONS NO EXISTING SOIL INFORMATION HAS BEEN PROVIDED BY THE OWNER/DEVELOPER. IT IS ASSUMED THAT SOILS ARE SUITABLE FOR CUTS AND FILLS. FOR PURPOSES OF DESIGN 12" OF TOPSOIL WAS ASSUMED TO BE PRESENT ON AVERAGE THROUGHOUT THE SITE.
- 7. DEWATERING THE CONTRACTOR IS RESPONSIBLE FOR ALL DEWATERING PRACTICES INCLUDING DRYING OF MATERIAL TO ACCOMPLISH COMPACTION IN FILL AREAS AND DEMONSTRATING SUITABILITY OF SUBGRADE.
   CONTRACTOR IS RESPONSIBLE FOR DEWATERING THE EXISTING POND PRIOR TO EXCAVTION/GRADING TO PROPOSED GRADES SHOWN ON THE PLANS. DEWATERING OUTFLOW SHALL BE PUMPED TO A STONE FILTER EXITING TO THE EXISTING OUTFALL SWALE.

### EROSION CONTROL

- 1. CERTIFICATION THE STORM WATER POLLUTION PREVENTION PLAN (SWPPP), WHICH INCLUDES THE "GRADING PLAN", "EROSION CONTROL PLAN", "EROSION CONTROL NOTES", ALONG WITH THE "DRAINAGE REPORT", DEFINES AND MEETS THE REQUIREMENTS OF THE NEW YORK STATE DEPARTMENT OF ENVIRONMENTAL CONSERVATION (NYSDEC) LATEST STORM WATER REGULATIONS.
- 2. CONTRACTOR RESPONSIBILITY ALL CONTRACTORS AND SUB-CONTRACTORS SHALL CERTIFY WITHIN THE SWPPP THAT THEY WILL IMPLEMENT AND MAINTAIN STORM WATER MANAGEMENT PRACTICES.
- 3. INSPECTION EROSION CONTROL (EC) MEASURES INSTALLED AND MAINTAINED BY THE SITE WORK CONTRACTOR ARE SUBJECT TO THE REVIEW AND APPROVAL OF THE: MUNICIPALITY, DESIGN ENGINEER, NYSDEC, AND OWNER'S REPRESENTATIVE. IMMEDIATE ACTION BY THE CONTRACTOR SHALL BE TAKEN IF ADDITIONAL OR CORRECTIVE MEASURES ARE REQUIRED BY ANY ONE OF THESE CITED REVIEWERS. EROSION CONTROL MEASURES NOT SPECIFICALLY SHOWN ON CONTRACT DRAWINGS (I.E., STRAW BALES, COLLARS, FABRICS, ETC.) SHALL BE INSTALLED AS WARRANTED BY FIELD CONDITIONS, AND AS DIRECTED BY THE AFOREMENTIONED REVIEWERS.
- 4. NOTIFICATION AS DESIGN ENGINEER, OUR OFFICE HAS NOTIFIED THE OWNER OF THE INSPECTION REQUIREMENTS UNDER GP-15-02. DISTURBANCES OF 1.0 ACRE OR GREATER REQUIRE THAT THE OWNER FILE A NOTICE OF INTENT (NOI) AND A SWPPP WITH THE NYSDEC UNDER STATE POLLUTANT DISCHARGE ELIMINATION SYSTEM (SPDES) GENERAL PERMIT #GP-15-02. SWPPP INSPECTIONS ARE TO BE COMPLETED BY A LICENSED PROFESSIONAL AND INSPECTION REPORTS ARE TO BE PROVIDED TO THE TOWN DEVELOPMENT OFFICE UNTIL THE SITE IS PERMANENTLY STABILIZED AND APPROVED BY THE TOWN CODE ENFORCEMENT OFFICER.
- 5. PRE-CONSTRUCTION THE APPROPRIATE EROSION CONTROL MEASURES AS DEFINED BY THE CONSTRUCTION DOCUMENTS SHALL BE INSTALLED PRIOR TO THE START OF ANY CONSTRUCTION ACTIVITIES.
- 6. TOPSOIL UPON COMPLETION OF THE STOCKPILE STRIPPING OPERATION, STOCKPILES SHALL BE STABILIZED IN ACCORDANCE TO NYSDEC REGULATIONS.
- 7. SLOPES UPON COMPLETION OF GRADING, SLOPES WITH A GRADIENT OF ONE FOOT VERTICAL TO THREE FEET HORIZONTAL (1 ON 3) OR GREATER SHALL BE: TOPSOILED, SEEDED, FERTILIZED, MULCHED AND STABILIZE WITH AN EROSION CONTROL BLANKET. RILLS SHALL BE IMMEDIATELY ADDRESSED AND STABILIZED AS NEEDED WITH JUTE MESH OR REAPPLICATION OF MULCH.
- 8. DUST THE CONTRACTOR SHALL APPLY WATER AND/OR CALCIUM CHLORIDE, AS CONDITIONS WARRANT, TO CONTROL WIND BORN EROSION. THIS MEASURE APPLIES TO: HAUL ROADS, CUT AND FILL OPERATIONS, SUB-BASE AND ANY OTHER EXPOSED SURFACES.
- 9. OPERATION & MAINTENANCE THROUGHOUT THE PERIOD OF CONSTRUCTION AND PRIOR TO ESTABLISHING FINAL GROUND COVER THE SITE CONTRACTOR IS RESPONSIBLE FOR THE OPERATION AND MAINTENANCE OF THE TEMPORARY EROSION CONTROL MEASURES. FOR EXAMPLE, THE SILTATION FACILITIES SHALL BE RE-EXCAVATED WHEN THE VOLUME (3600 CUBIC FEET/DISTURBED ACRE) IS REDUCED BY ONE-HALF OR MORE OF ITS SPECIFIED CAPACITY AND/OR THE MATERIAL IS WITHIN ONE FOOT OF THE DISCHARGE POINT.
- 10. WORK STOPPAGE ALL DISTURBED AREAS NOT TO BE WORKED WITHIN 14 DAYS MUST BE SEEDED AND STABILIZED WITHIN 14 DAYS FROM THE LAST CONSTRUCTION ACTIVITY IN THAT AREA.
- 11. TOWN OF CANANDAIGUA REQUIREMENTS -
- DEVELOPMENT WITHIN THE CANANDAIGUA LAKE WATERSHED THAT REQUIRES POST CONSTRUCTION WATER QUALITY MEASURES SUCH AS STORMWATER MANAGEMENT FACILITIES, THE DEVELOPER IS REQUIRED TO PROVIDE DAILY OBSERVATION OF THE SITE BY A LICENSED PROFESSIONAL OR A CERTIFIED PERSONS IN EROSION AND SEDIMENT CONTROL (CPESC) UNTIL SUCH TIME THAT THE MASS GRADING OF THAT SECTION OR PHASE IS COMPLETED AND ALL STORMWATER MANAGEMENT COMPONENTS OF THE SWPPP ARE INSTALLED AND FUNCTIONING.
- DEVELOPMENT WITHIN THE CANANDAIGUA LAKE WATERSHED THAT WILL DISTURB MORE THAN 5-ACRES AT ONE TIME, SHALL BE REQUIRED TO COORDINATE THE REGULAR STORMWATER OBSERVATIONS (REQUIRED BY SPDES GENERAL PERMIT) WITH THE WATERSHED INSPECTOR AND THE WATERSHED PROGRAM MANAGER

### CANANDAIGUA LAKE COUNTY SEWER DISTRICT

- 1. SEWER PERMITS AND PERMITS FOR WORK WITHIN ONTARIO COUNTY HIGHWAY RIGHTS OF WAY MUST BE PURCHASED IN ADVANCE AT THE ONTARIO COUNTY PUBLIC WORKS OFFICE LOCATED AT 2962 COUNTY ROAD 48 IN THE TOWN OF HOPEWELL. CALL 585-396-4000 FOR INFORMATION.
- SANITARY SEWER CONSTRUCTION AND/OR IMPROVEMENTS SHALL BE IN ACCORDANCE WITH THE MOST RECENT STANDARDS AND SPECIFICATIONS OF THE CANANDAIGUA LAKE COUNTY SEWER DISTRICT, N.Y.S. DEPARTMENT OF ENVIRONMENTAL CONSERVATION, N.Y.S. DEPARTMENT OF HEALTH, THE LATEST EDITION OF <u>RECOMMENDED</u>
- STANDARDS FOR WASTEWATER FACILITIES AND ANY OTHER AGENCIES HAVING JURISDICTION.

  3. SANITARY SEWER MAIN GRAVITY PIPE SHALL BE 8" DIA. OR LARGER PVC CLASS SDR-35 OR SDR-21 WITH ELASTOMERIC JOINTS. LATERALS SHALL BE 4" DIA. SDR-21 WITH ELASTOMERIC JOINTS. ACTUAL FIELD CONDITIONS MAY REQUIRE ADDITIONAL PIPE OR BACKFILL REINFORCEMENT. THE SANITARY SEWER WILL BE
- DESIGNED BY THE DEVELOPER'S ENGINEER. FIELD CHANGES MUST BE APPROVED BY THE SEWER DISTRICT.

  4. THE SANITARY SEWER IS DESIGNED TO PROVIDE GRAVITY SERVICE TO ALL ADJACENT BUILDING BASEMENTS.

  EXCEPTIONS HAVE BEEN APPROVED BY THE SEWER DISTRICT AND ARE CLEARLY NOTED ON THE UTILITY PLAN.

  BASEMENT FLOOR ELEVATIONS WILL BE SHOWN ON THE SANITARY SEWER PROFILE FOR EACH LOT THAT WILL NOT
- BE SERVED BY GRAVITY LATERALS.

  5. THE CONTRACTOR SHALL LOCATE, MARK AND PRESERVE ANY RIGHT OF WAY MONUMENTS OR SURVEY CONTROL IN THE AREA OF CONSTRUCTION.
- 6. UTILITY LOCATIONS SHOWN ARE APPROXIMATE ONLY. THE CONTRACTOR SHALL DETERMINE EXACT LOCATION OF UTILITIES, EXCAVATING TO EXPOSE THE UTILITY, IF NECESSARY IN THE AREA OF CONSTRUCTION, BEFORE COMMENCING CONSTRUCTION. CONTACT U.F.P.O. AT 1-800-962-7962 AT LEAST 72 HOURS PRIOR TO CONSTRUCTION.
- 7. THE SANITARY SEWER SHALL BE LOCATED A MINIMUM HORIZONTAL DISTANCE OF 10' FROM ANY EXISTING OR PROPOSED WATER MAIN (AS MEASURED FROM THE OUTSIDE OF THE SEWER TO THE OUTSIDE OF THE WATER MAIN). IN CASES WHERE THE SANITARY SEWER CROSSES A WATER MAIN, THE MINIMUM VERTICAL SEPARATION SHALL BE 18" (MEASURED OUT-TO-OUT). THE CROSSING SHALL BE ARRANGED SO THAT THE SEWER JOINTS WILL BE FOUNDED AND AS FAR AS POSSIBLE FROM THE WATER MAIN JOINTS.
- SHALL BE 18" (MEASURED OUT-TO-OUT). THE CROSSING SHALL BE ARRANGED SO THAT THE SEWER JOINTS WILL BE EQUIDISTANT AND AS FAR AS POSSIBLE FROM THE WATER MAIN JOINTS.

  8. A LETTER OF CREDIT, OR ENGINEER APPROVED EQUIVALENT, FOR AN AMOUNT EQUAL TO THE ESTIMATED COST OF CONSTRUCTION, INSPECTION, RECORD DRAWINGS, DEDICATION DOCUMENTS AND RELATED EXPENSES FOR THE SANITARY SEWER PLUS AN ADDITIONAL 10% FOR CONTINGENCIES MUST BE SUBMITTED TO THE
- COMMISSIONER OF PUBLIC WORKS BEFORE A PERMIT IS ISSUED OR SEWER CONSTRUCTION MAY COMMENCE.

  9. THE CONTRACTOR SHALL PROVIDE THE DISTRICT WITH SHOP DRAWINGS AND MATERIAL SPECIFICATIONS THAT HAVE BEEN PRE-APPROVED BY THE DESIGN ENGINEER BEFORE A PERMIT WILL BE ISSUED.
- 10. THE DEVELOPER IS RESPONSIBLE FOR THE PREPARATION OF ALL REQUIRED EASEMENT MAPS AND DESCRIPTIONS AND SUBMISSION TO THE DISTRICT FOR APPROVAL. PERMITS WILL NOT BE ISSUED PRIOR TO THE EASEMENT DOCUMENTS BEING SIGNED BY THE COMMISSIONER AND RECORDED IN THE COUNTY CLERK'S OFFICE.
- 11. THE CONTRACTOR IS RESPONSIBLE FOR COMPLIANCE WITH OSHA REQUIREMENTS IN ALL ASPECTS OF CONSTRUCTION, PAYING PARTICULAR ATTENTION TO REQUIREMENTS FOR OPEN TRENCH AND CONFINED SPACE. ENTRY INTO ANY DISTRICT STRUCTURE <u>MUST</u> COMPLY WITH ALL DISTRICT AND OSHA APPROVED PROCEDURES FOR CONFINED SPACES.

12. WHEN SANITARY SEWER CONSTRUCTION ACTIVITIES BEGIN, THE CONTRACTOR SHALL PLUG THE MAIN AT THE

- CONNECTING MANHOLE. PLUGS SHALL NOT BE REMOVED UNTIL THE COMPLETED SEWER LINE IS TESTED AND APPROVED FOR USE.
- 13. THE CONTRACTOR SHALL BE RESPONSIBLE FOR MAINTAINING SANITARY FLOWS AT ALL TIMES BY METHODS ACCEPTABLE TO THE DEVELOPER'S ENGINEER AND THE DISTRICT.
- THE SEWER LINE SHALL BE LAID USING A PIPE LASER. GRADE SHALL BE CHECKED EVERY 100 FEET USING A SURVEYOR'S LEVEL TO INSURE THE CORRECT GRADE IS BEING MAINTAINED.
   FLOOR DRAINS IN THE BASEMENT OR GARAGE ARE TO BE CONNECTED TO THE SANITARY SEWER. FLOOR DRAINS DO NOT INCLUDE FOUNDATION OR FOOTER DRAINS INSTALLED TO INTERCEPT UNCONTAMINATED GROUND WATER. ALL DISCHARGES TO THE SANITARY SEWER MUST COMPLY WITH EFFLUENT LIMITS OF THE ONTARIO COUNTY
- GROUND WATER FROM DRAINING INTO THE SANITARY SEWER PIPE CRADLE.

  16. OPENINGS IN EXISTING MANHOLES SHALL BE MADE WITH A CORE SAW. A RUBBER, WATER-TIGHT PIPE-TO-MANHOLE BOOT ADAPTER OR OTHER DISTRICT APPROVED CONNECTOR CONFORMING TO ASTM C-923, SHALL BE USED TO MAKE THE CONNECTION TO THE EXISTING MANHOLE.

SEWER USE LAW. FOUNDATION AND FOOTER DRAINS SHALL BE CONSTRUCTED IN A MANNER THAT WILL PROHIBIT

- 17. THE CONTRACTOR SHALL PERFORM ALL EXISTING MANHOLE MODIFICATION OPERATIONS IN SUCH A MANNER TO ENSURE NO DEBRIS OR CONSTRUCTION MATERIALS ENTER THE SANITARY SEWER SYSTEM.
- 18. THE CONTRACTOR SHALL EXERCISE CAUTION WHEN PERFORMING EXISTING MANHOLE MODIFICATION OPERATIONS. ANY DAMAGE TO THE EXISTING SLAB, BARREL OR ANY OTHER PART OF THE STRUCTURE SHALL BE REPLACED IN KIND TO THE SATISFACTION OF THE CANANDAIGUA LAKE COUNTY SEWER DISTRICT REPRESENTATIVE AT THE CONTRACTOR'S EXPENSE.
- 19. EXISTING MANHOLES THAT ARE MODIFIED IN ANY MANNER SHALL BE SUBJECT TO VACUUM TESTING PER DISTRICT REQUIREMENTS.
- 20. CONNECTIONS REQUIRING OPENINGS IN ASBESTOS CEMENT PIPE WILL BE DESIGNED, INSPECTED AND CERTIFIED BY THE DESIGN ENGINEER OR REPRESENTATIVE THEREOF.
- 21. ALL PIPES ENTERING AND EXITING MANHOLES SHALL HAVE A FLEXIBLE WATER-TIGHT JOINT NO LESS THAN 1 FOOT AND NO GREATER THAN 3 FEET FROM THE OUTSIDE WALL OF THE MANHOLE.
- 22. MANHOLES DEEPER THAN 14 FEET, LESS THAN 5 FEET IN DEPTH, OR HAVING THREE OR MORE PIPE CONNECTIONS SHALL HAVE A MINIMUM INSIDE DIAMETER OF 5 FEET.23. ANY EXCAVATION NOT BACKFILLED BY THE END OF THE WORKDAY SHALL BE FENCED, BARRICADED AND LIGHTED
- FOR SAFETY AND PROTECTION OF THE PUBLIC.

  24. THE CONTRACTOR SHALL BE RESPONSIBLE FOR THE REMOVAL OF EXISTING SANITARY MAINS, STRUCTURES AND
- APPURTENANCES, IF ANY, NEEDED TO COMPLETE THE WORK.

  25. EXISTING LATERALS TO BE DISCONNECTED MUST BE PERMANENTLY PLUGGED OR CAPPED AT THE EASEMENT OR RIGHT OF WAY LINE UNDER THE DIRECTION OF THE CANANDAIGUA LAKE COUNTY SEWER DISTRICT SUPERVISOR. THE CONTRACTOR IS REQUIRED TO OBTAIN A PERMIT PRIOR TO PERFORMING THE WORK. THE LOCATION OF THE PLUG OR CAP SHALL BE RECORDED FOR AS-BUILT DRAWING PURPOSES.
- 26. LATERAL CLEAN OUTS WILL BE PROVIDED AT THE RIGHT OF WAY LINE OR SANITARY SEWER EASEMENT LINE,
- WHICHEVER IS FURTHEST FROM THE SEWER MAIN, AND EVERY 90 LINEAR FEET THEREAFTER.

  27. THE CONTRACTOR SHALL TAKE AND RECORD FIELD MEASUREMENTS TO ALL WYES, CLEAN OUTS AND LATERAL PLUGS AS WELL AS LENGTHS OF RISERS AND DEPTHS AT LATERAL PLUGS. THE INFORMATION WILL BE GIVEN TO THE DEVELOPER'S ENGINEER FOR USE IN PREPARING RECORD DRAWINGS.
- 28. FOLLOWING PROJECT COMPLETION AND 30 DAYS AFTER THE BACKFILL HAS BEEN IN PLACE THE FOLLOWING TESTS SHALL BE PERFORMED ON GRAVITY SANITARY SEWER MAIN:
- a. INFILTRATION/EX-FILTRATION TESTS ON SEWER MAIN AND MANHOLES. AIR PRESSURE TESTING FOR SEWER MAINS AND VACUUM TESTING FOR MANHOLES IS RECOMMENDED. TESTS ON MANHOLES MAY BE PERFORMED ONLY AFTER MANHOLE BENCHES AND INVERTS ARE COMPLETE.
- b. A DEFLECTION TEST USING A RIGID BALL OR MANDREL HAVING A DIAMETER OF 95% OF THE INSIDE DIAMETER OF THE PIPE. MECHANICAL PULLING DEVICES WILL NOT BE USED.
  c. THE SEWER LINE WILL BE TELEVISED AND LAMPED AFTER ALL OTHER TESTS ARE COMPLETE. A GOOD

QUALITY COPY OF THE DVD OR VIDEO-TAPE AND RELATED RECORDS WILL BE SUBMITTED FOR EVALUATION

- TO CANANDAIGUA LAKE COUNTY SEWER DISTRICT. PRIOR TO TELEVISING THE SEWER LINE SHALL BE FLUSHED AND CLEARED OF DIRT, STONES AND DEBRIS. IF PERMISSION IS GRANTED TO REMOVE THE PLUG AT THE CONNECTING MANHOLE PRIOR TO FLUSHING OPERATION, PROVIDEDOWNSTREAM SCREENS OR OTHER DEVICES TO PREVENT DEBRIS FROM ENTERING THE COUNTY'S SEWER SYSTEM. SECTIONS OF PIPE REPAIRED OR RE-FLUSHED WILL BE RE-TELEVISED UNTIL ACCEPTABLE.

  29. UPON PROJECT COMPLETION AND DISTRICT APPROVAL, THE DEVELOPER'S ENGINEER WILL SUBMIT RECORD DRAWINGS ON MYLAR AND IN ELECTRONIC FORMAT, TIED TO NAD83 HORIZONTAL AND NAVD 88 VERTICAL DATUM. THE DRAWINGS WILL SHOW ACTUAL FIELD MEASURED LOCATIONS. LENGTHS, ELEVATIONS AND TYPES OF PIPE
- THE DRAWINGS WILL SHOW ACTUAL FIELD MEASURED LOCATIONS, LENGTHS, ELEVATIONS AND TYPES OF PIPE AND APPURTENANCES, INCLUDING WYES AND LATERALS, AS WELL AS PROFILES, EASEMENTS AND ANY OTHER RELATED INFORMATION REQUESTED BY THE DISTRICT. MYLAR DRAWINGS WILL BE STAMPED/SEALED AND SIGNED BY A PROFESSIONAL ENGINEER OR SURVEYOR, AND SHALL BE AT STANDARD ENGINEERING SCALE (L" = 50' MIN.), AND ON STANDARD SIZED DRAWINGS NO SMALLER THAN 11" X 17" AND NO LARGER THAN 24" X 36". PROJECT MONUMENTATION AND PERMANENT BENCHMARKS SHALL BE SHOWN WITH COORDINATE AND/OR ELEVATION INFORMATION.

  30. THE DEVELOPER IS RESPONSIBLE FOR PROVIDING EASEMENT MAPS AND DESCRIPTIONS AND SEWER DEDICATION

DOCUMENTS. MAPS WILL BE RECORDED WITH DEDICATION DOCUMENTS IN THE ONTARIO COUNTY CLERK'S

31. PRIOR TO RELEASING THE RETAINAGE FROM THE ORIGINAL LETTER OF CREDIT, A MAINTENANCE BOND FOR A

CANANDAIGUA LAKE COUNTY SEWER DISTRICT WILL BE SUBMITTED TO THE COMMISSIONER. THE BOND WILL

EXPIRE NO SOONER THAN ONE YEAR FROM THE DATE OF DEDICATION OF THE SEWER, OR THE RELEASE DATE OF

MINIMUM OF 10% OF THE TOTAL SANITARY SEWER-RELATED COST OF THE PROJECT IN FAVOR OF THE

OFFICE, AND THEREFORE NEED TO BE SUBMITTED ON LEGAL SIZE (8 1/2" X 14") PAPER.

THE RETAINAGE FROM THE LETTER OF CREDIT, WHICHEVER OCCURS LAST.

MARATHON ENGINEERING

> 39 CASCADE DRIVE ROCHESTER, NY 14614 PHONE 585-458-7770 www.marathoneng.com

DIVIDIO COLINITY

N OF CANANDAIGU

JOB NO: 0551-16
SCALE: N/A
DRAWN: RJT
DESIGNED: RPB
DATE: 7/15/16

REVISIONS

DATE BY REVISION

10/18/16 RJT ISSUED FOR FINAL REVIEW

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AOFESSIONAL HISTORY

ROBERT P. BRINGLEY


DRAWING TITLE:

NOTES, LEGEND 8

ABBREVIATIONS

5 of 21 SHEET No: 0551-16

NOTE: SEE DRAWING NO. C1.0 FOR LEGEND.

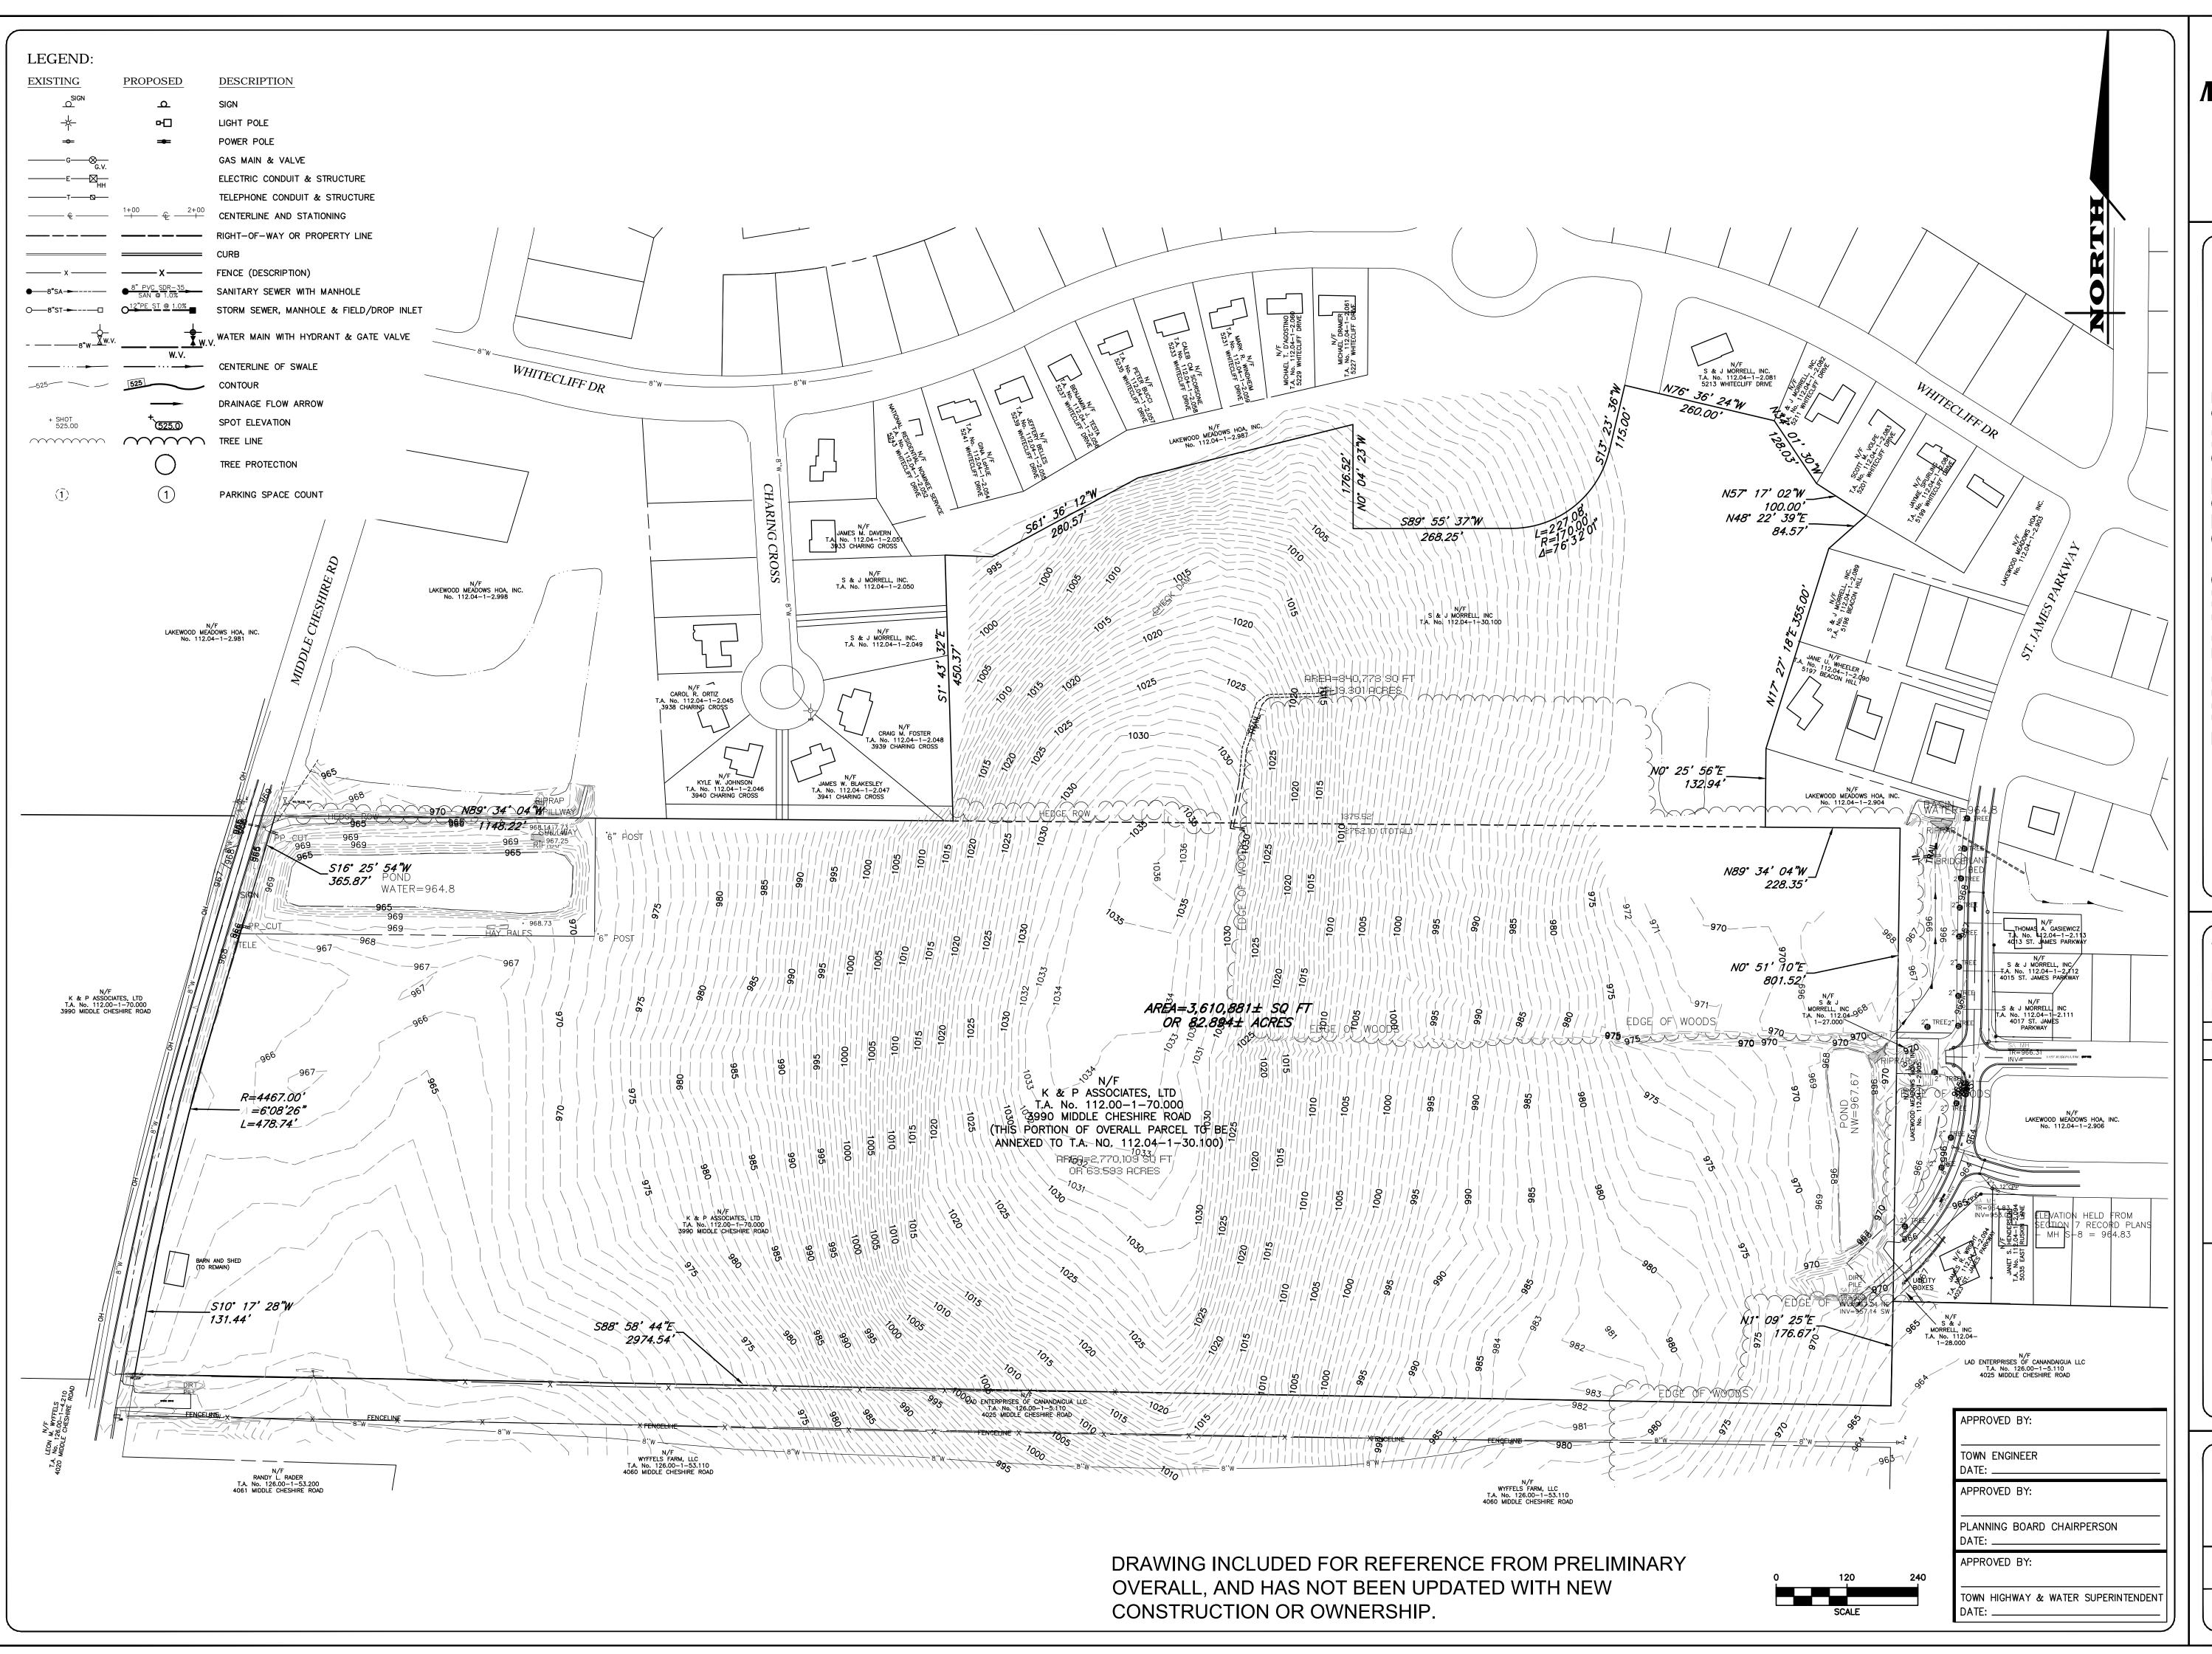



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FINAL PLANS - SECTION 9B.

AKEWOOD MEADOWS
ST. JAMES PARKWAY

JOB NO: 0551-16
SCALE: 1" = 120'
DRAWN: RJT
DESIGNED: RJT
DATE: 12/18/14
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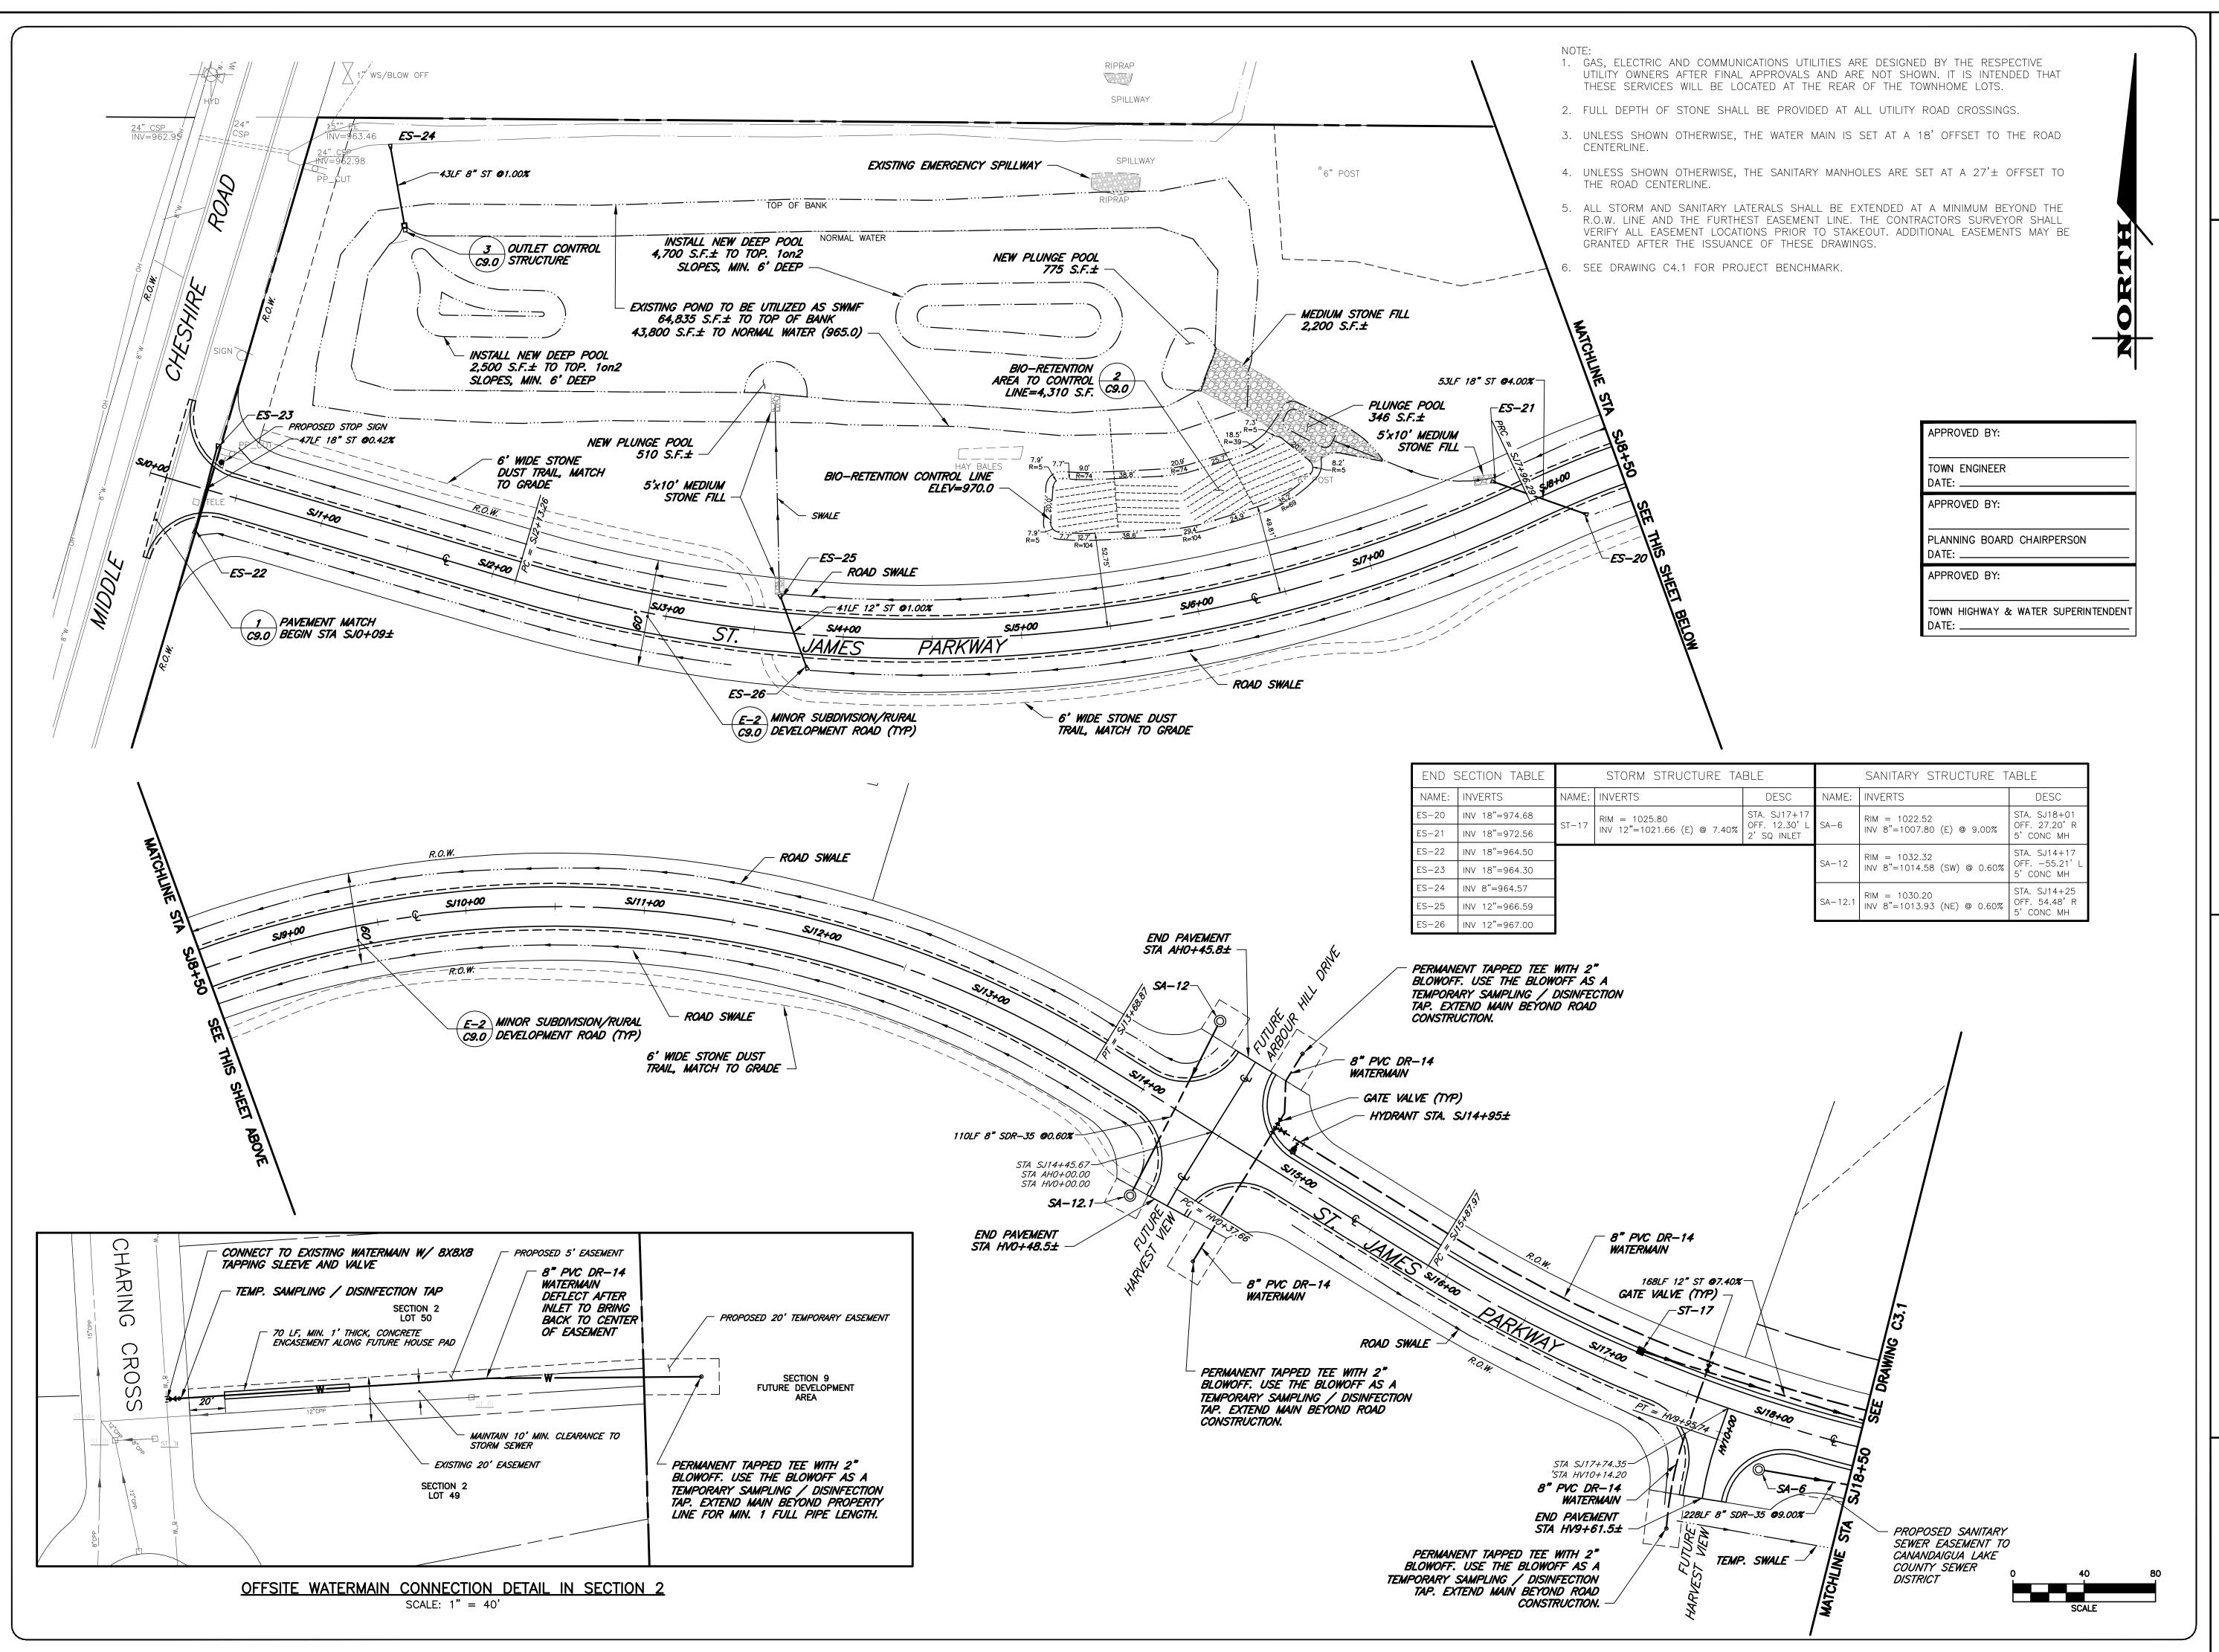
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DRAWING TITLE:
EXISTING
CONDITIONS PLAN

ROBERT P. BRINGLEY

6 of 21
SHEET No:

0551-16
JOB No: DRAWING No:





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SE

ST. JAMES PARKWAY ONTARIO COUNTY

OWN OF CANANDAIGUA

JOB NO: 0551-16
SCALE: 1" = 40'
DRAWN: RJT
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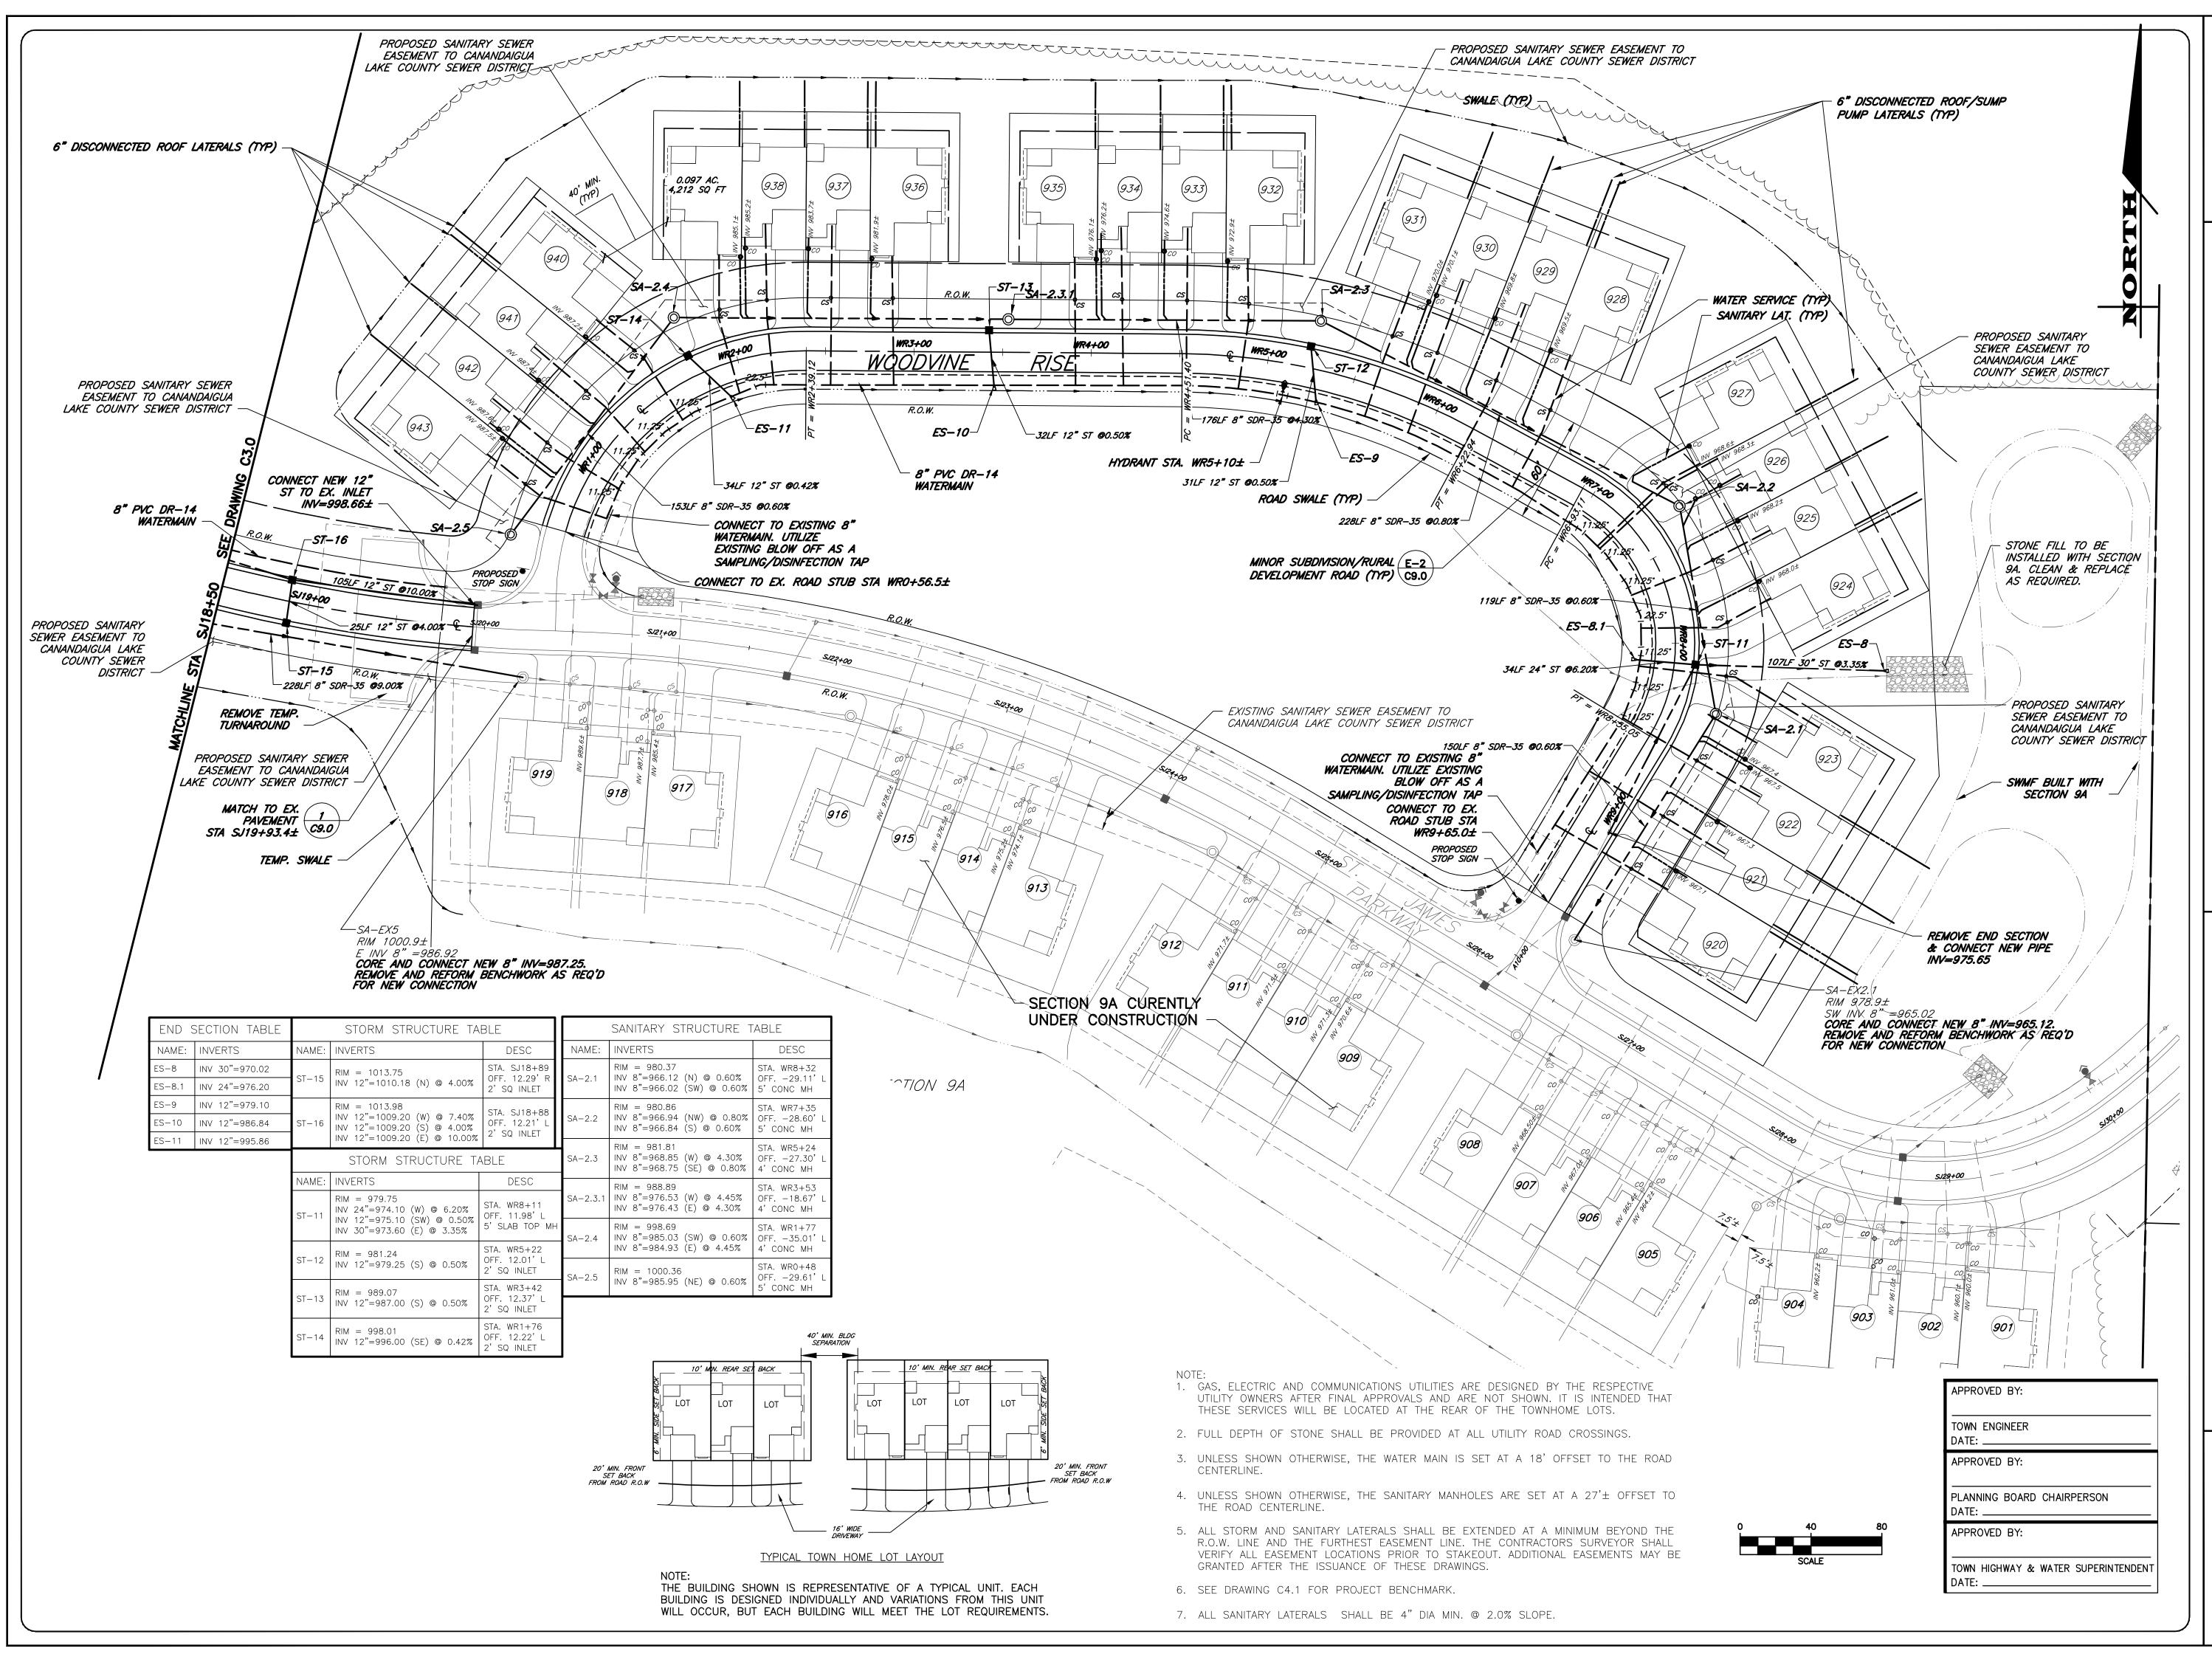
DRAWING TITLE:

UTILITY PLAN SHEET 1

ROBERT P. BRINGLEY

7 of 21
SHEET No:

0551-16
JOB No: DRAWING No:





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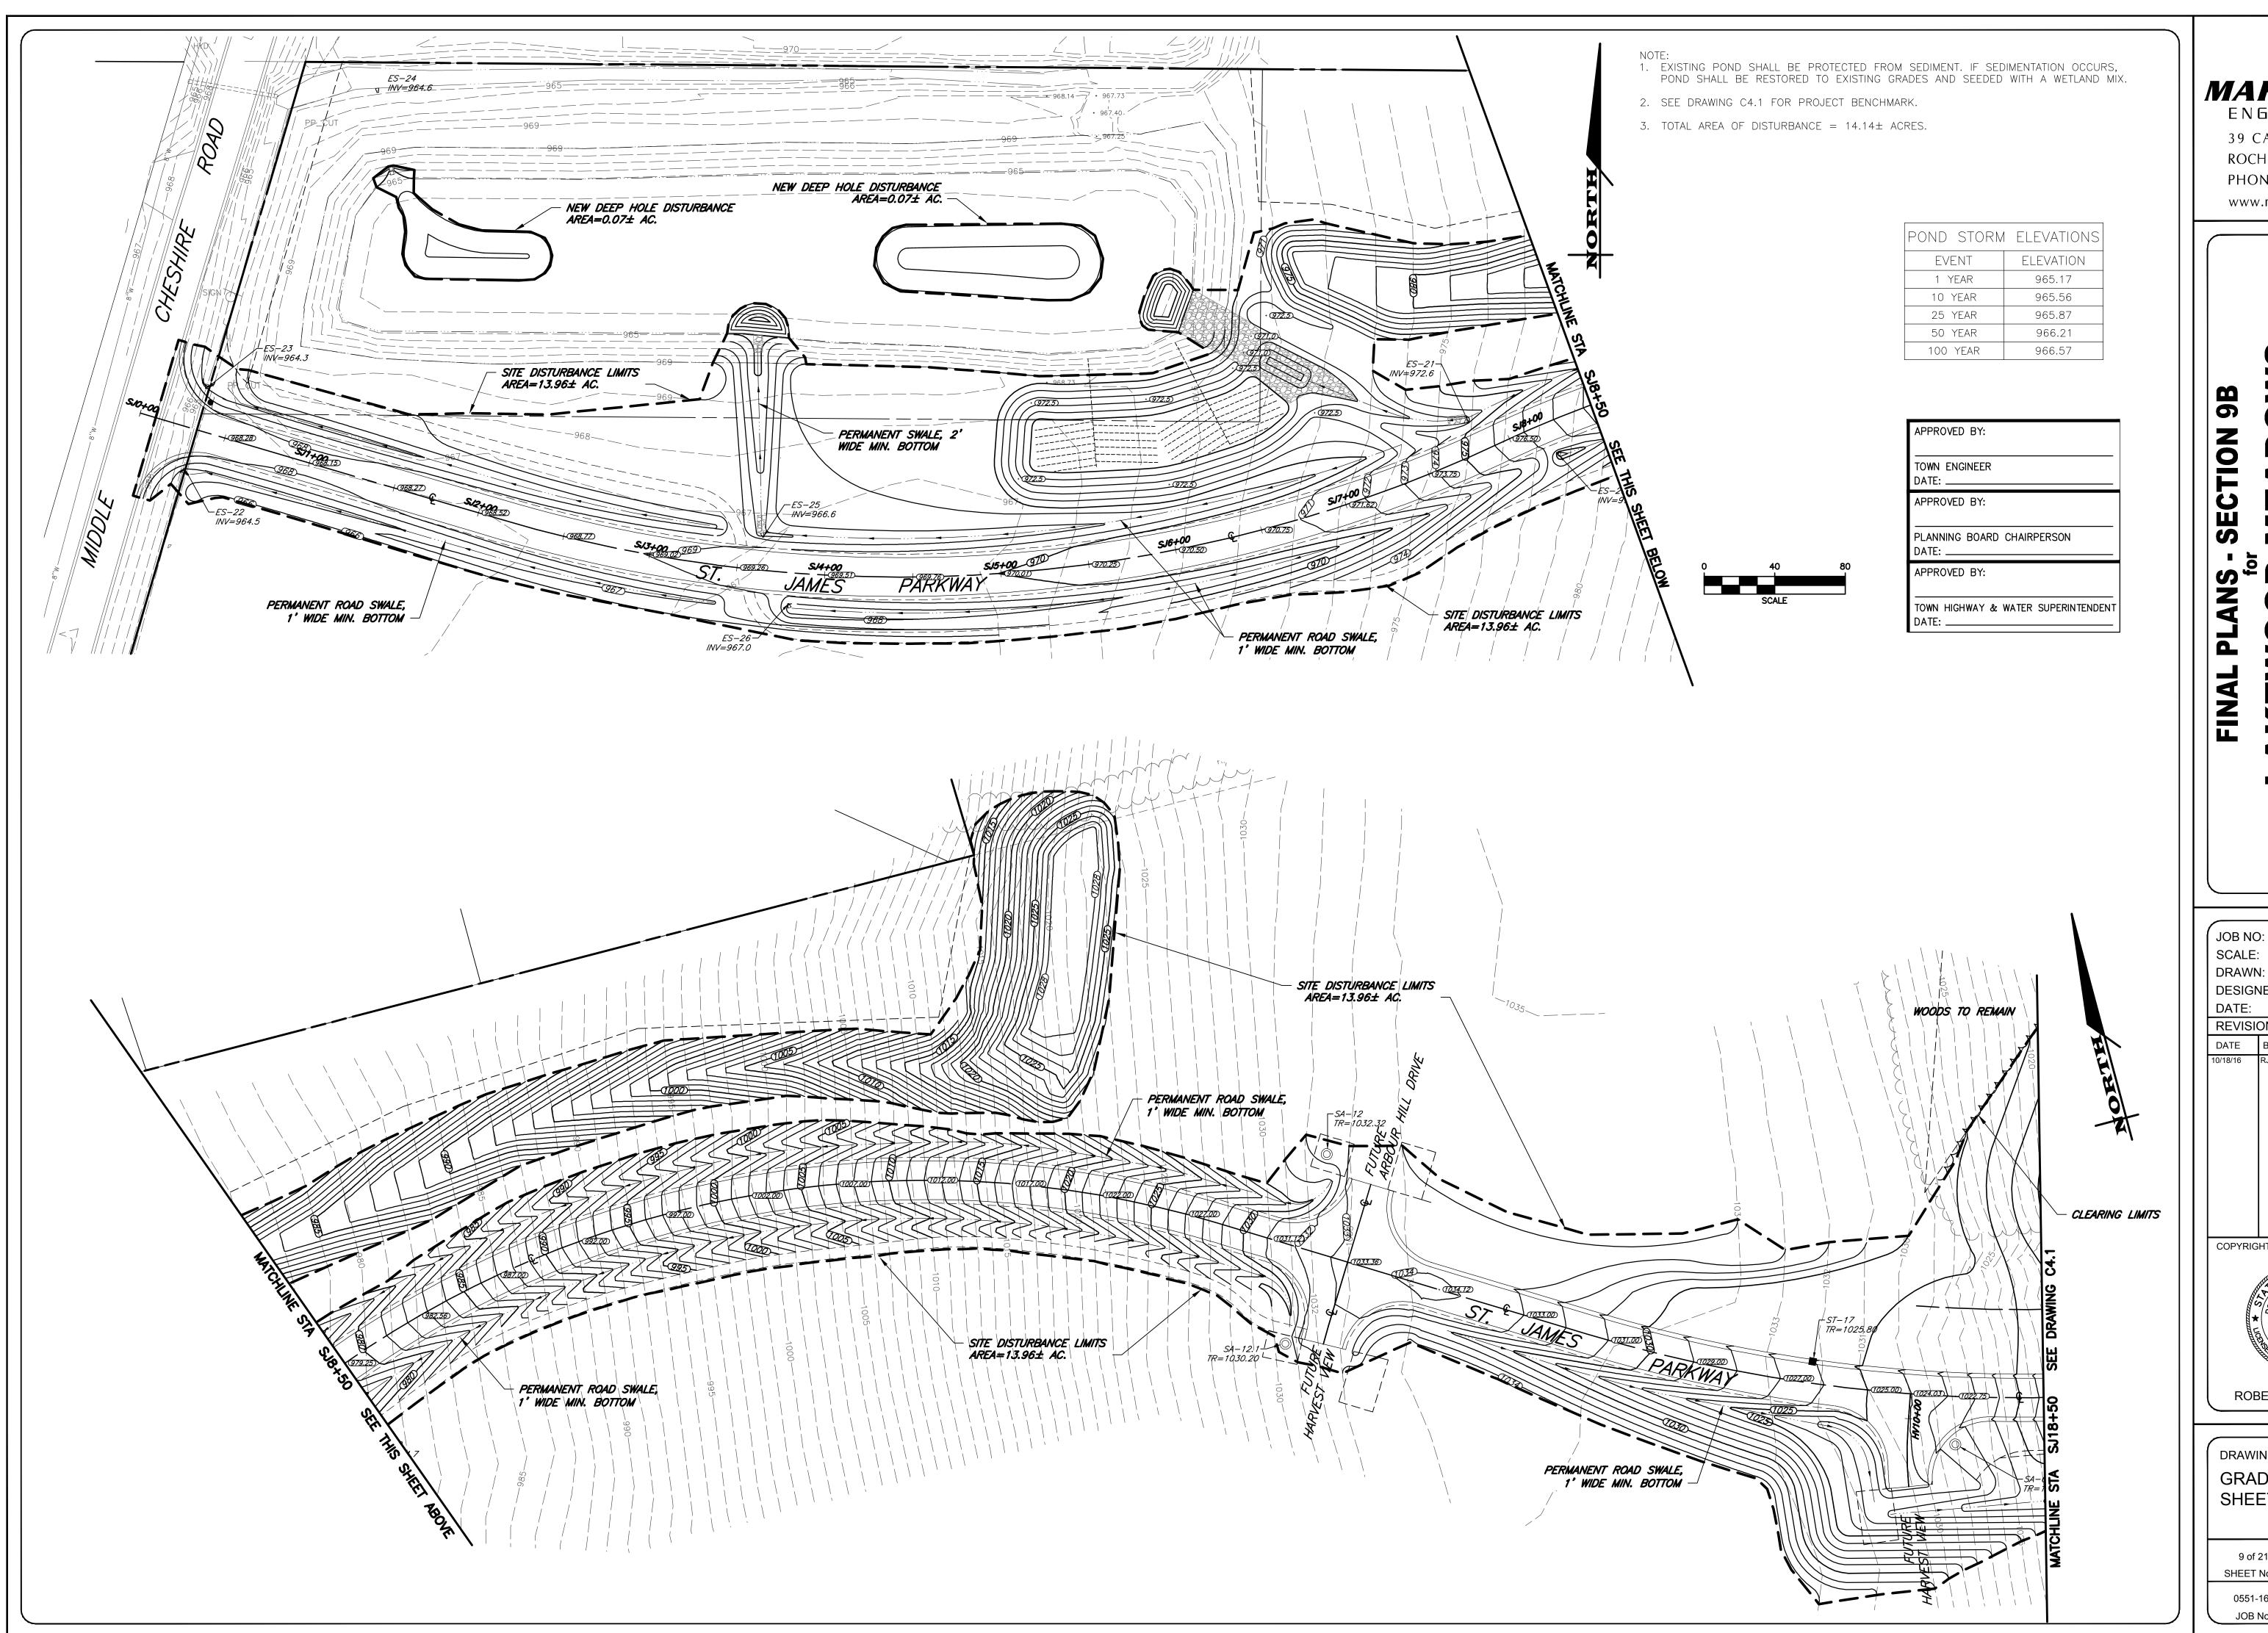
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**DRAWING TITLE:** UTILITY PLAN -

SHEET No: 0551-16 DRAWING No:

SHEET 2





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1" = 40'

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DATE: REVISIONS DATE BY REVISION


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DRAWING TITLE: **GRADING PLAN -**SHEET 1

SHEET No:

0551-16 DRAWING No:



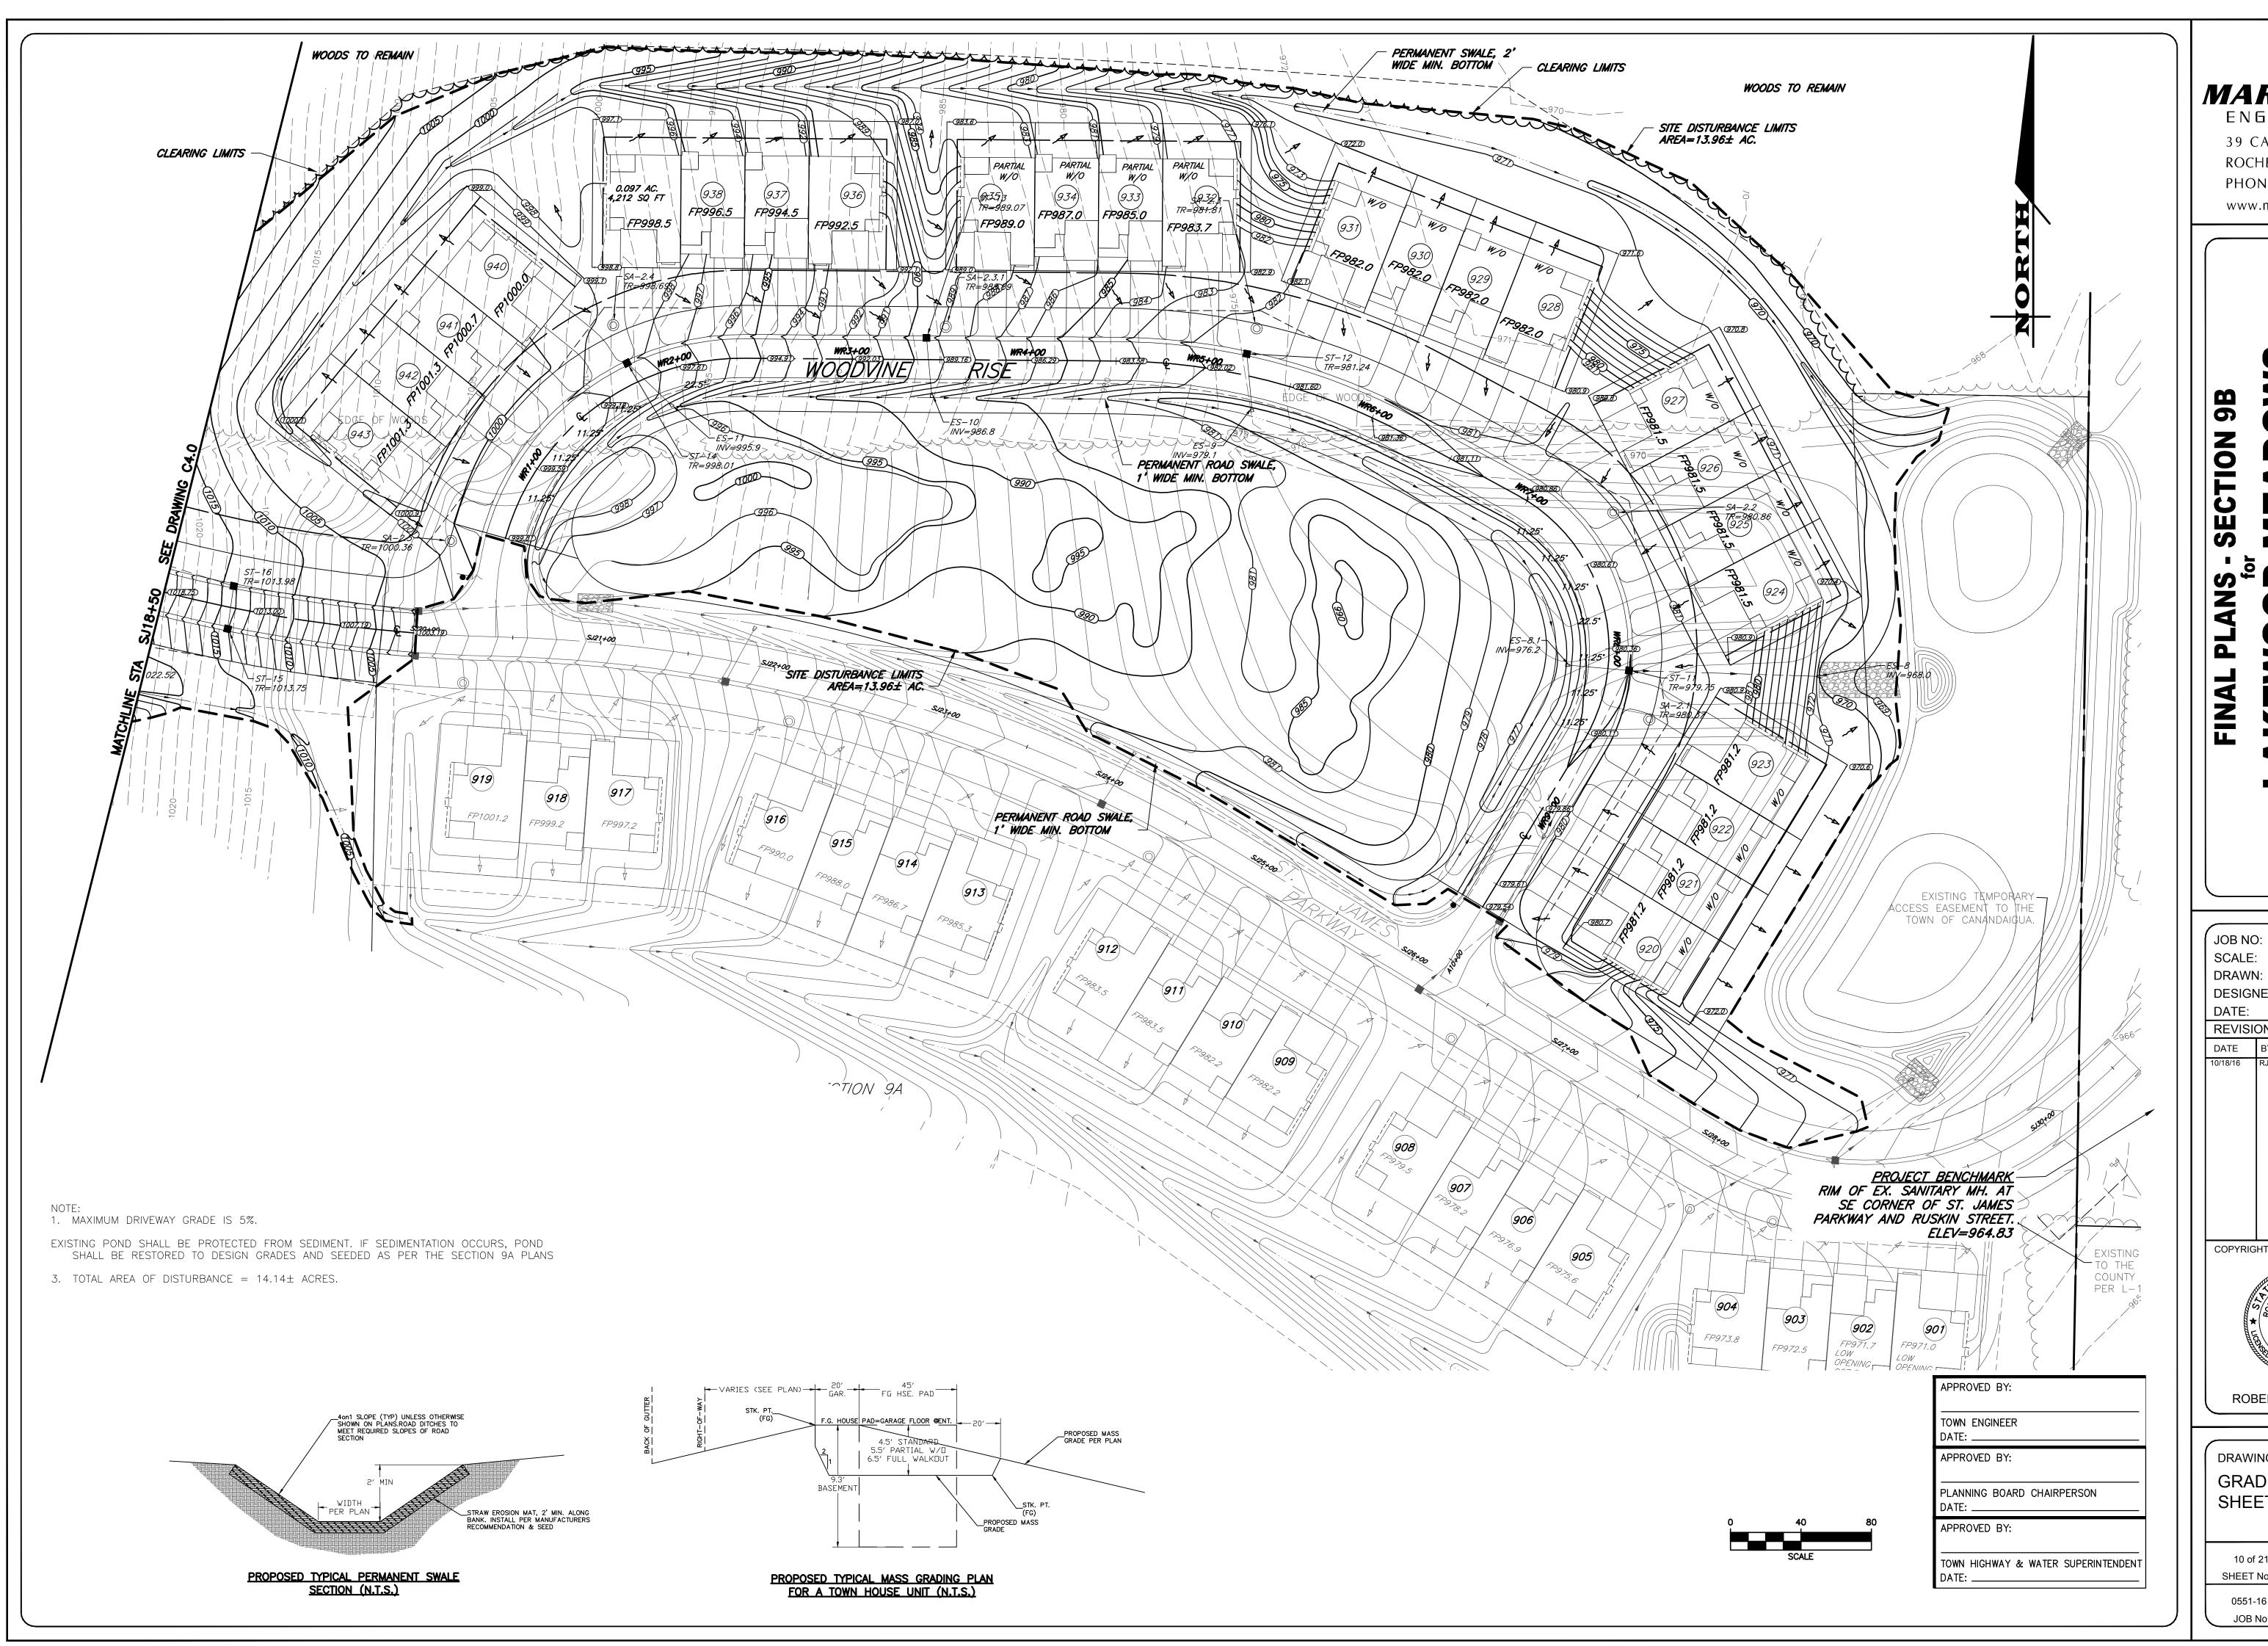

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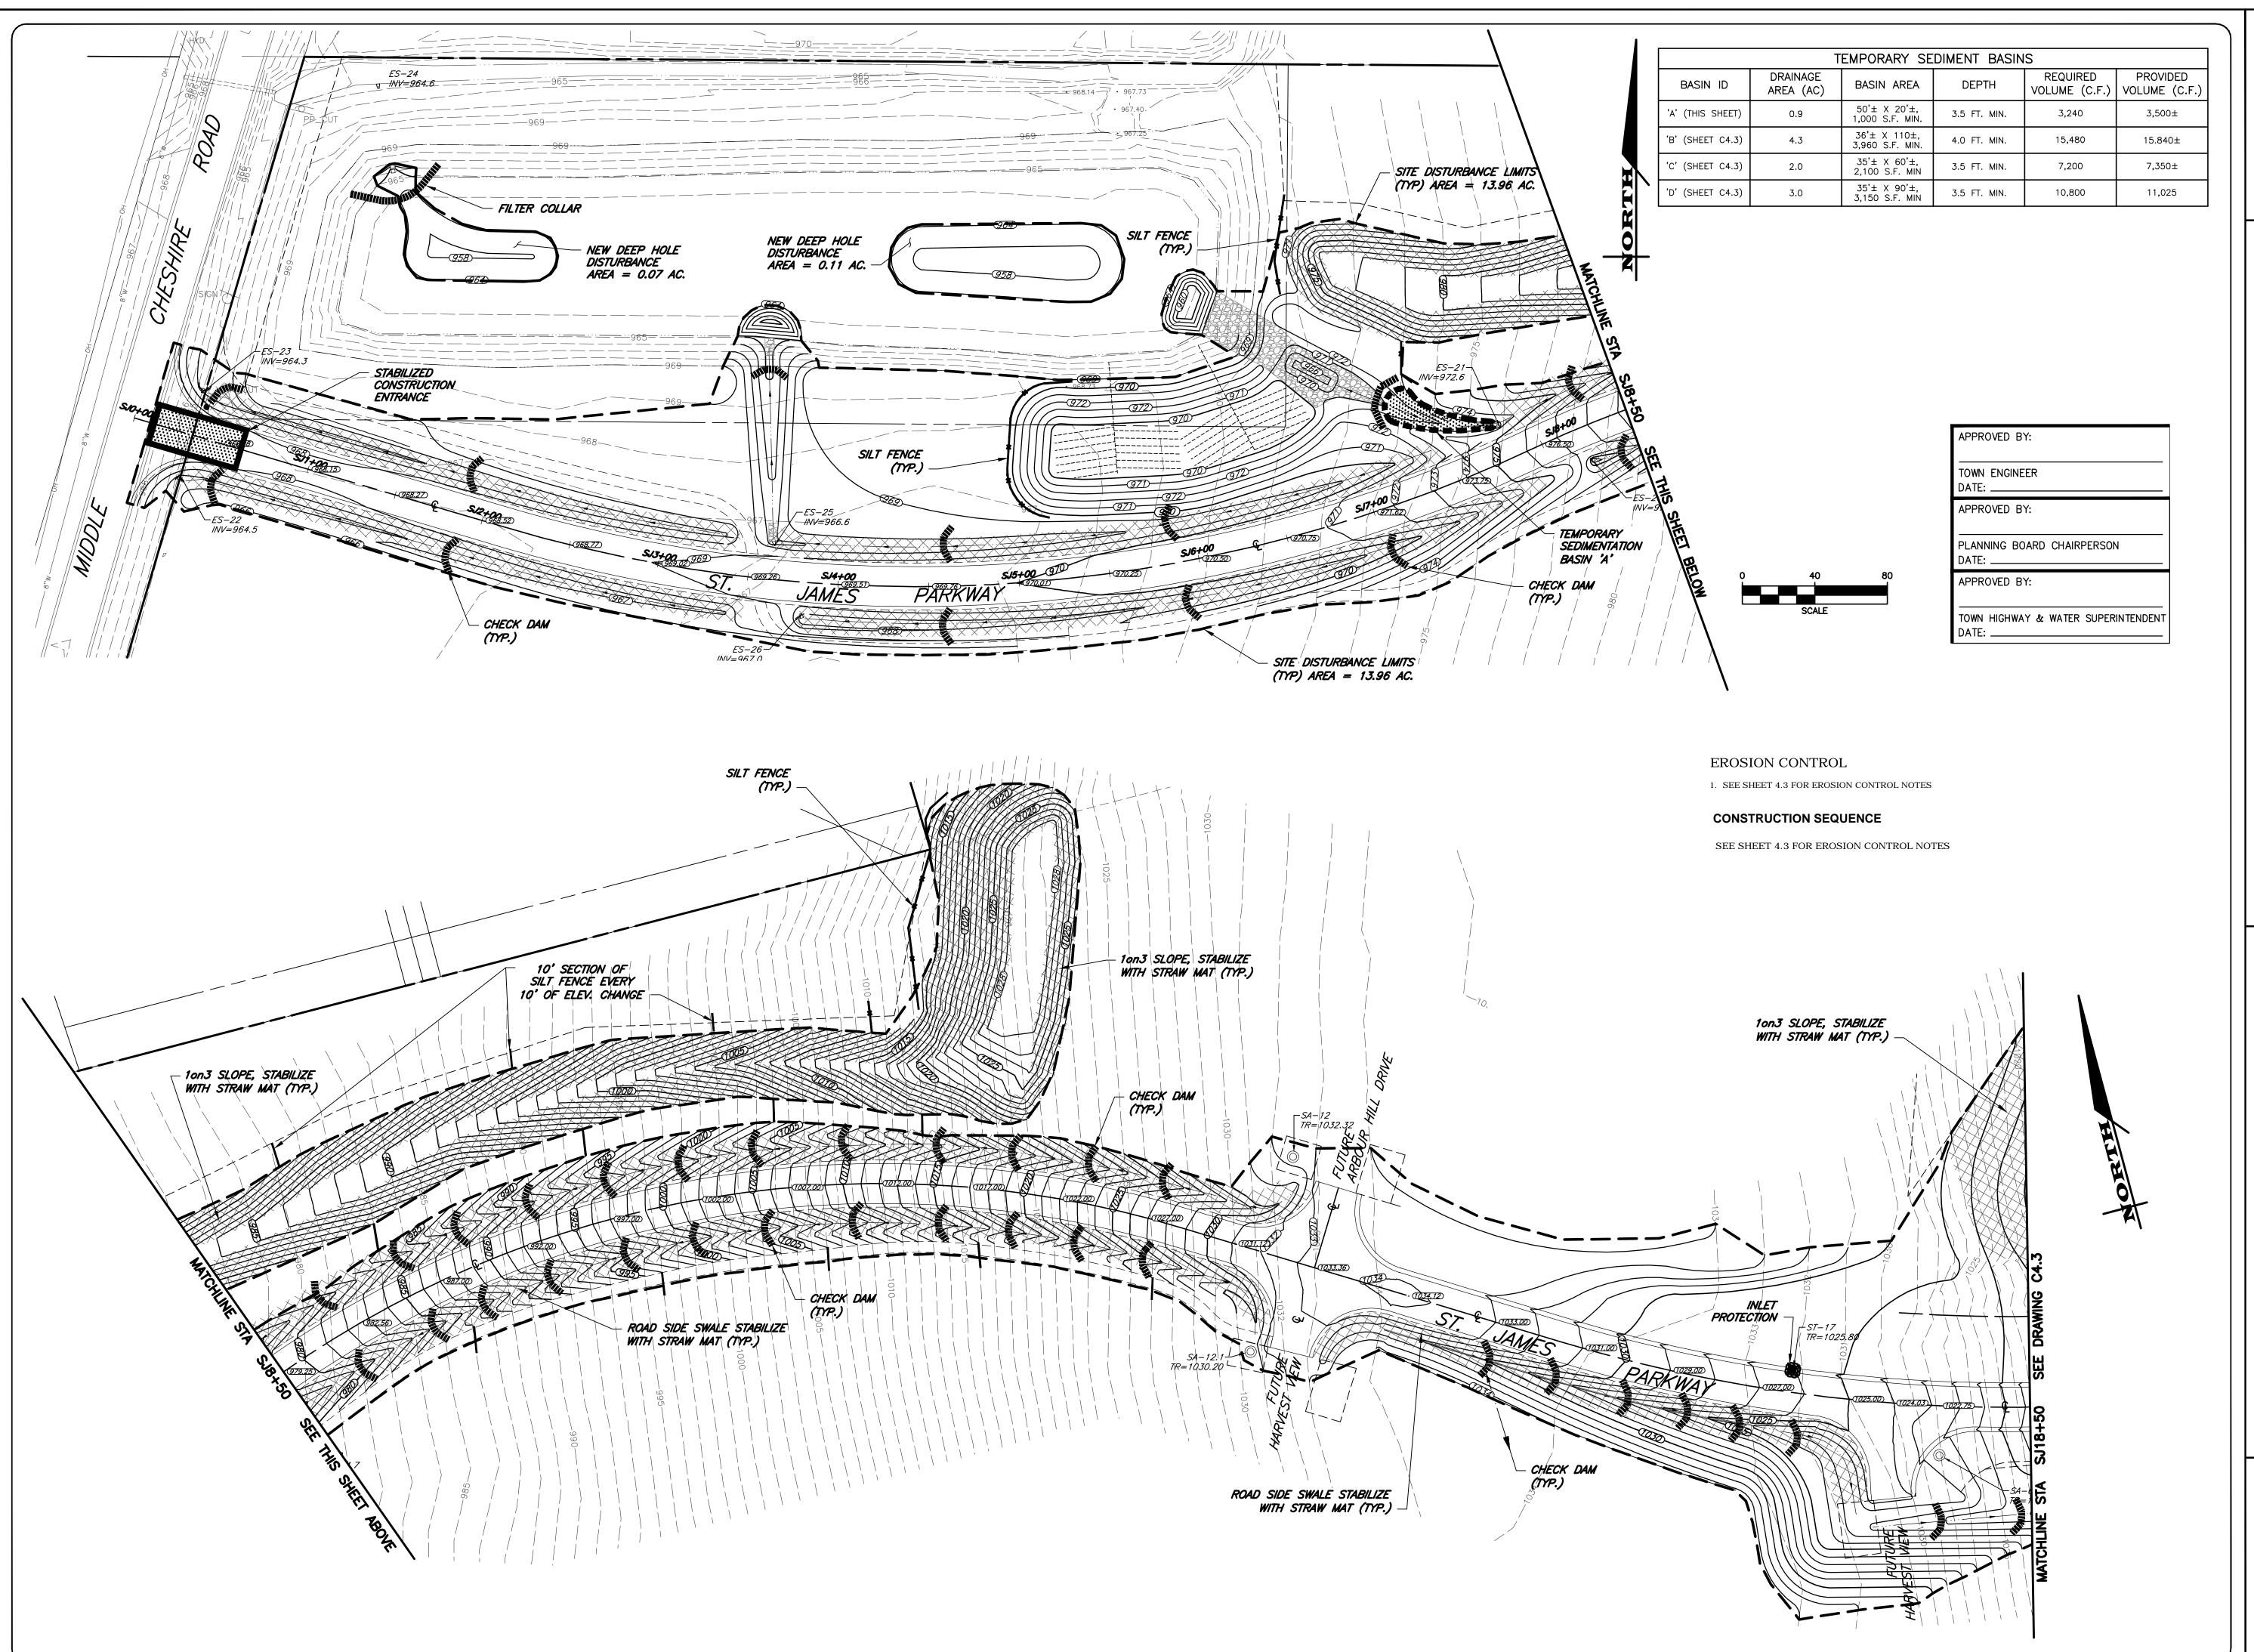
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DRAWING TITLE:

GRADING PLAN SHEET 2

10 of 21
SHEET No:

0551-16
JOB No:
DRAWING No:





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SECTION

. JAMES PARKWAY

ONTARIO COUNTY

DF CANANDAIGUA

0551-16 1" = 40' RJT

SCALE: 1" = 40'
DRAWN: RJT
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DATE: 7/15/16
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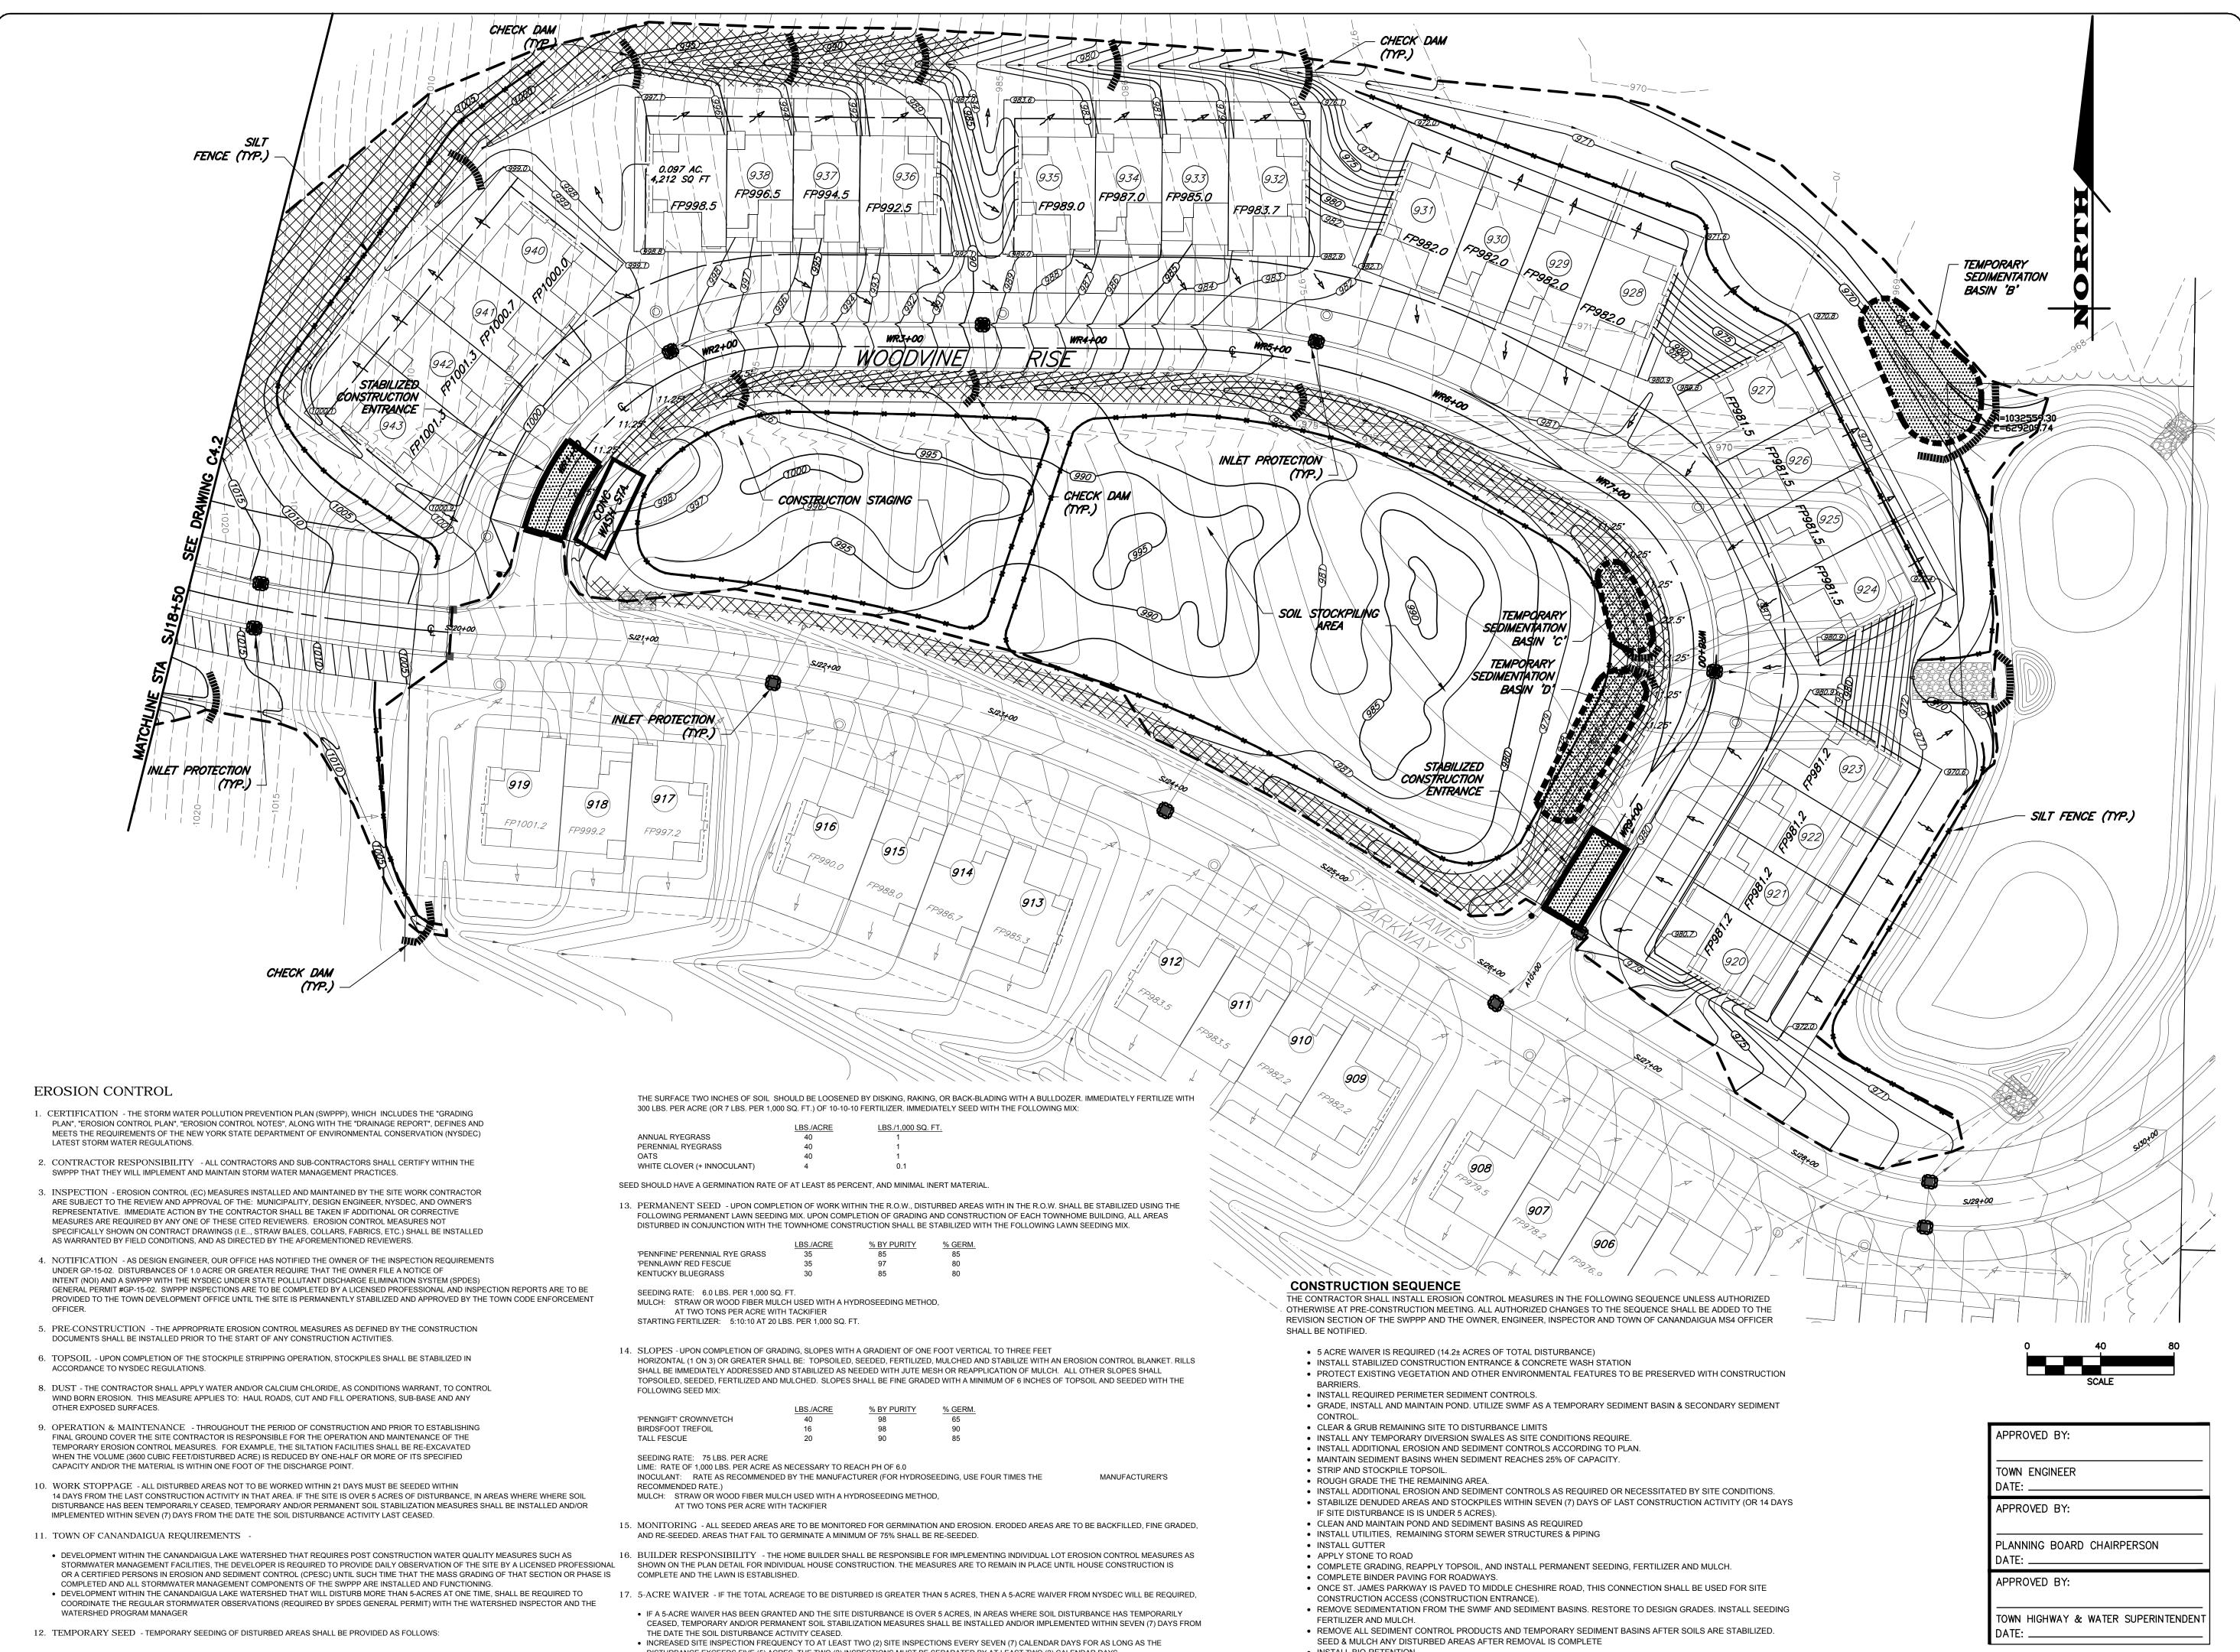
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DRAWING TITLE:
EROSION
CONTROL PLAN SHEET 1

11 of 21 SHEET No: C4

DRAWING No:

JOB No:



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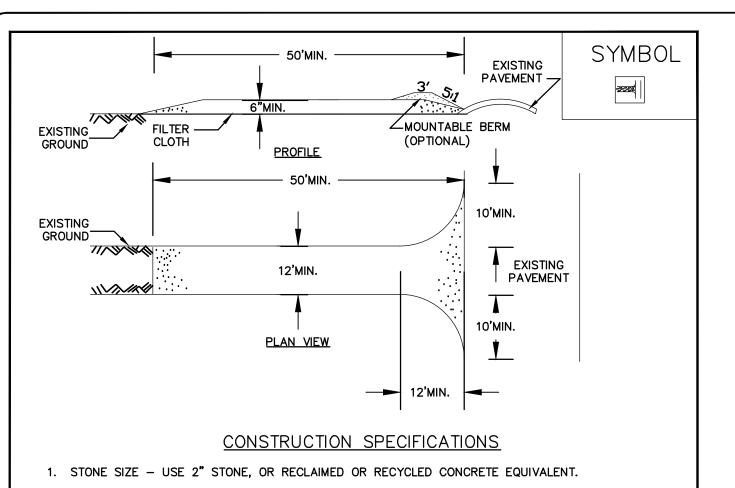
ROBERT P. BRINGLEY

DRAWING TITLE: **EROSION CONTROL PLAN -**SHEET 2

SHEET No: 0551-16

• INSTALL BIO-RETENTION. FINAL ROAD PAVING

DISTURBANCE EXCEEDS FIVE (5) ACRES. THE TWO (2) INSPECTIONS MUST BE SEPARATED BY AT LEAST TWO (2) CALENDAR DAYS.



- 2. LENGTH NOT LESS THAN 50 FEET (EXCEPT ON A SINGLE RESIDENCE LOT WHERE A 30 FOOT MIN. LENGTH WOULD APPLY).
- 3. THICKNESS NOT LESS THAN SIX (6) INCHES.


BERM WITHI 5:1 SLOPES WILL BE PERMITTED.

- 4. WIDTH TWELVE (12) FOOT MINIMUM, BUT NOT LESS THAN THE FULL WIDTH AT POINTS WHERE INGRESS OR EGRESS OCCURS, TWENTY-FOUR (24) FOOT IF SINGLE ENTRANCE TO SITE.
- 5. FILTER CLOTH WILL BE PLACED OVER THE ENTIRE AREA PRIOR TO PLACING OF STONE.
- 6. SURFACE WATER ALL SURFACE WATER FLOWING OR DIVERTED TOWARD CONSTRUCTION ENTRANCES SHALL BE PIPED ACROSS THE ENTRANCE. IF PIPING IS IMPRACTICAL, A MOUNTABLE
- MAINTENANCE THE ENTRANCE SHALL BE MAINTAINED IN A CONDITION WHICH WILL PREVENT TRACKING OR FLOWING OF SEDIMENT ONTO PUBLIC RIGHTS-OF-WAY, ALL SEDIMENT SPILLED,
- DROPPED, TACKED, OR WASHED ONTO PUBLIC RIGHTS-OF-WAY MUST BE REMOVED IMMEDIATELY. 8. WHEN WASHING IS REQUIRED, IT SHALL BE DONE ON AN AREA STABILIZED WITH STONE AND WHICH
- 9. PERIODIC INSPECTION AND NEEDED MAINTENANCE SHALL BE PROVIDED AFTER EACH RAIN.

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DRAINS INTO AN APPROVED SEDIMENT TRAPPING DEVICE.

STABILIZED CONSTRUCTION **ENTRANCE** 

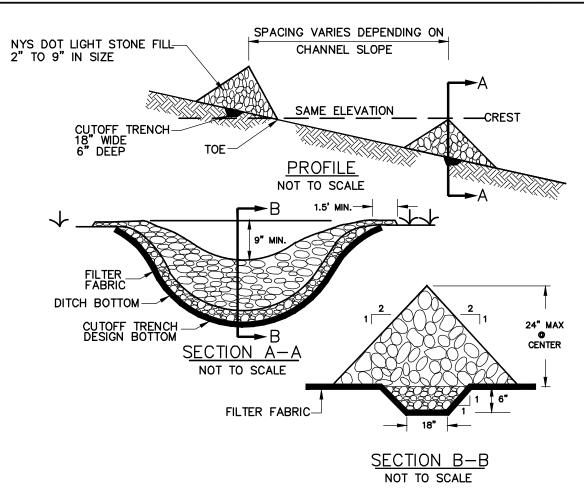

### CONSTRUCTION SPECIFICATIONS

STONE CHECK DAM


SCALE: N.T.S


- 1. STONE WILL BE PLACED ON A FILTER FABRIC FOUNDATION TO THE LINES, GRADES AND LOCATION SHOWN ON IN THE PLAN
- 2. SET SPACING OF CHECK DAMS TO ASSUME THAT THE ELEVATIONS OF THE CREST OF THE
- DOWNSTREAM DAM IS AT THE SAME ELEVATION OF THE UPSTREAM DAM.
- 3. EXTEND THE STONE A MINIMUM OF 1.5 FEET BEYOND THE DITCH BANKS TO PREVENT CUTTING
- 4. PROTECT THE CHANNEL DOWNSTREAM OF THE LOWEST CHECK DAM FROM SCOUR AND EROSION WITH STONE OR LINER AS APPROPRIATE.
- ENSURE THAT CHANNEL APPURTENANCES SUCH AS CULVERT ENTRANCES BELOW CHECK DAMS ARE NOT SUBJECT TO DAMAGE OF BLOCKAGE FROM DISPLACED STONES. MAXIMUM DRAINAGE AREA - 2 ACRES


# **CONCRETE WASHOUT** SCALE: N.T.S

WITHIN 30' OF THE TEMPORARY CONCRETE WASHOUT

4. HOLES, DEPRESSIONS OR OTHER GROUND DISTURBANCE CAUSED BY THE REMOVAL OF THE TEMPORARY CONCRETE WASHOUT FACILITIES SHALL BE BACKFILLED, REPAIRED, AND STABILIZED TO PREVENT EROSION.

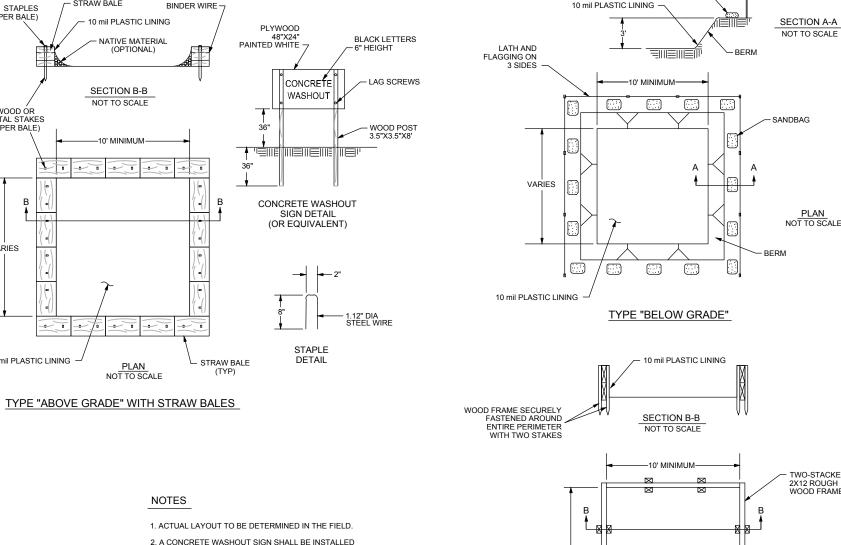

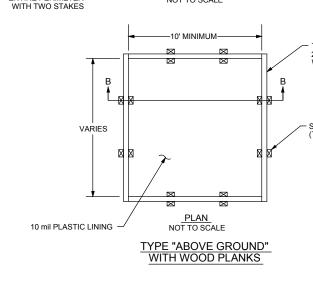

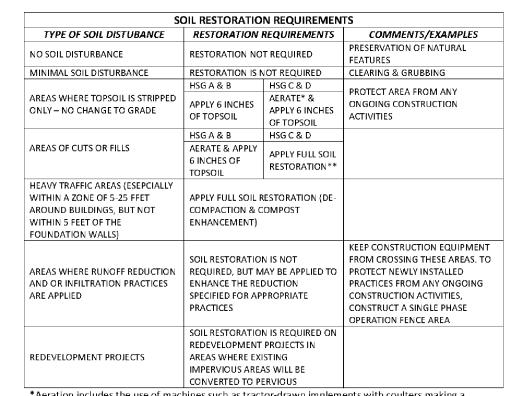

\*Aeration includes the use of machines such as tractor-drawn implements with coulters making a narrow slit in the soil, a roller with many spikes making indentations in the soil, or prongs which function like a mini-subsoiler.

\*\* Per "Deep Ripping and De-compaction, DEC 2008".

1. DURING PERIODS OF RELATIVELY LOW TO MODERATE SUBSOIL MOISTURE, THE DISTURBED SUBSOILS ARE RETURNED TO ROUGH GRADE AND THE FOLLOWING SOIL RESTORATION STEPS

- APPLIED:
- APPLY 3 INCHES OF COMPOST OVER SUBSOIL. TILL COMPOST INTO SUBSOIL TO A DEPTH OF AT LEAST 12 INCHES USING A CAT-MOUNTED RIPPER, TRACTOR-MOUNTED DISC, OR TILLER, MIXING, AND CIRCULATING AIR AND COMPOST INTO SUBSOILS
- ROCK-PICK UNTIL UPLIFTED STONE/ROCK MATERIALS OF FOUR INCHES AND LARGER SIZE ARE CLEANED OFF THE SITE
- APPLY TOPSOIL TO A DEPTH OF 6 INCHES


\*\*SOIL RESTORATION APPLIES TO ALL DISTURBED AREAS THAT ARE TO REMAIN AS PERVIOUS AREAS AFTER FINAL CONSTRUCTION.



### **CONSTRUCTION SPECIFICATIONS**

- 1. SEDIMENT SHALL BE REMOVED AND THE TRAP RESTORED TO ITS ORIGINAL DIMENSIONS WHEN THE SEDIMENT STALL BE REMOVED AND THE TRAF RESTORED TO THE TRAP. REMOVED SEDIMENT SHALL BE DEPOSITED IN A SUITABLE AREA AND IN SUCH A MANNER THAT IT WILL NOT ERODE.
- THE VOLUME OF SEDIMENT STORAGE SHALL BE 3600 CUBIC FEET PER ACER OF CONTRIBUTORY DRAINAGE.
- 3. THE STRUCTURE SHALL BE INSPECTED AFTER EACH RAIN AND REPAIRS MADE AS NEEDED.
- 4. CONSTRUCTION OPERATIONS SHALL BE CARRIED OUT IN SUCH A MANNER THAT EROSION AND WATER POLLUTION SHALL BE MINIMIZED.
- 5. THE SEDIMENT TRAP SHALL BE REMOVED AND THE AREA STABILIZED WHEN THE CONSTRUCTED DRAINAGE AREA HAS BEEN PROPERLY STABILIZED.
- 6. ALL CUT SLOPED SHALL BE 1:1 OR FLATTER.

MAXIMUM DRAINAGE AREA: 3 ACRES. CATCH BASIN SEDIMENT TRAP

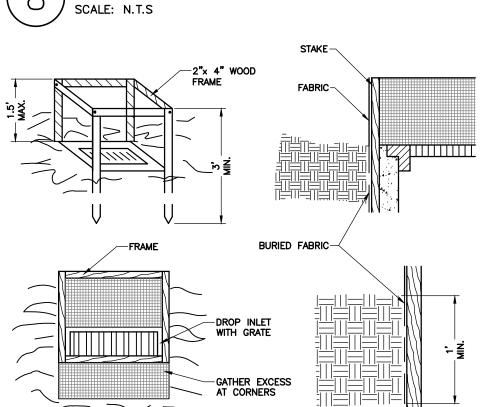


### CONSTRUCTION SPECIFICATIONS


- FILTER FABRIC SHALL HAVE AN EOS OF 40-85. BURLAP MAY BE USED FOR SHORT TERM APPLICATIONS.
   CUT FABRIC FROM A CONTINUOUS ROLL TO ELIMINATE JOINTS. IF JOINTS ARE NEEDED THEY WILL BE OVERLAPPED TO THE NEXT STAKE.
- 3. STAKE MATERIALS WILL BE STANDARD 2" x 4" WOOD OR EQUIVALENT METAL WITH A MINIMUM LENGTH OF 3 FEET.

  4. SPACE STAKES EVENLY AROUND INLET 3 FEET APART AND DRIVE A MINIMUM OF 18 INCHES DEEP. SPANS GREATER THAN 3 FEET MAY BE BRIDGED WITH THE USE OF WIRE MESH BEHIND THE FILTER FABRIC FOR SUPPORT.


  5. FABRIC SHALL BE EMBEDDED 1 FOOT MINIMUM BELOW GROUND AND BACKFILLED. IT SHALL BE SECURELY FASTEND TO THE STAKES AND FRAME.

SCALE: N.T.S

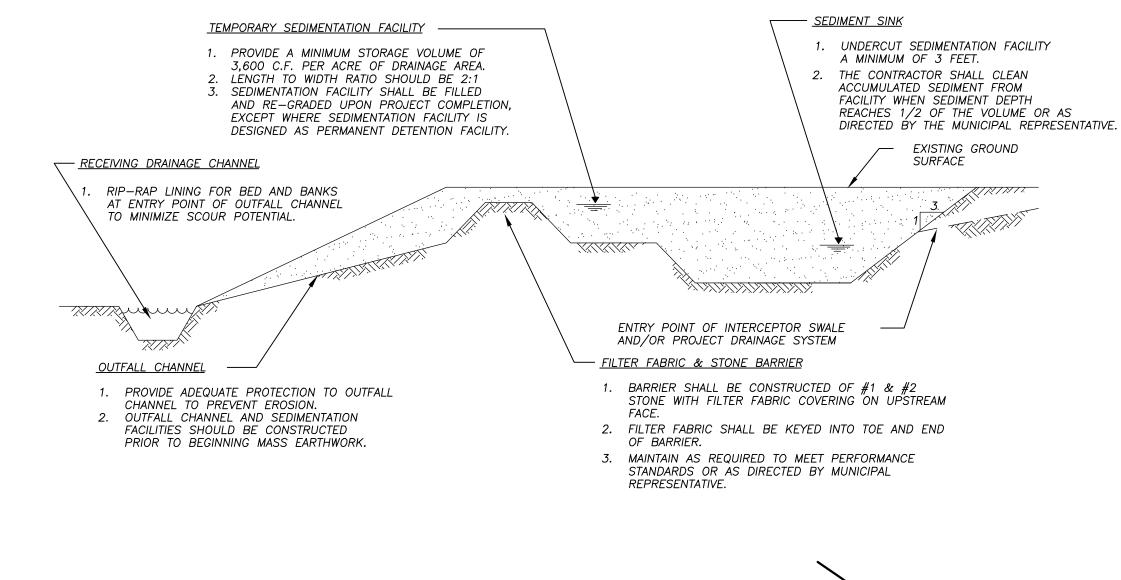

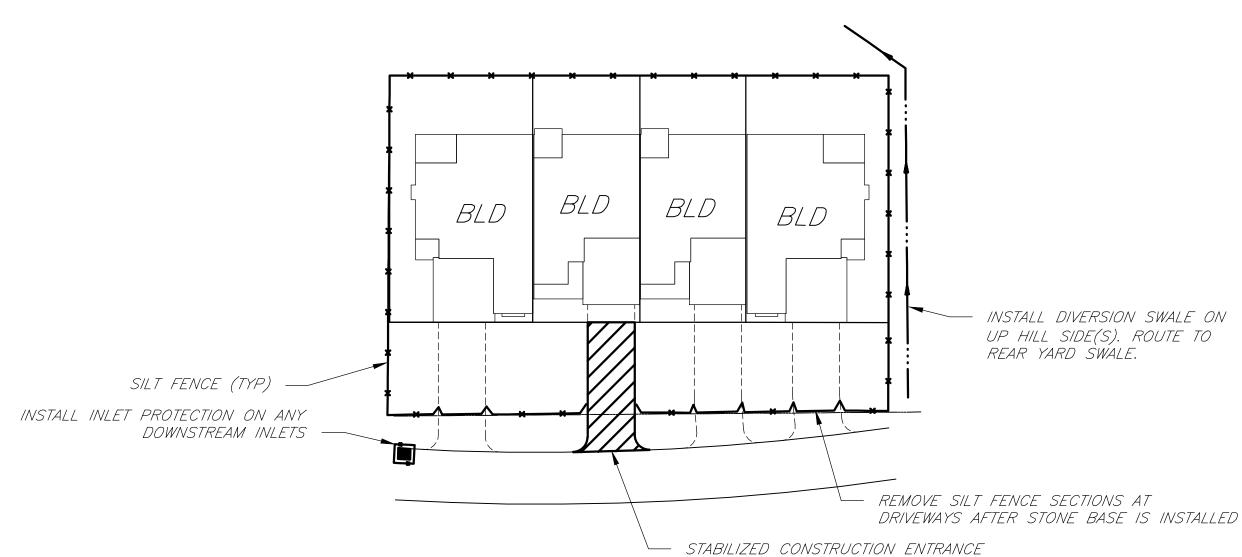


TYP. BUILDING CONSTRUCTION EROISION CONTROL DETAIL SCALE: N.T.S

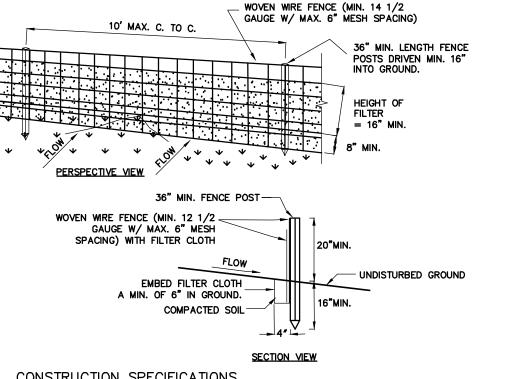


## **CONSTRUCTION SPECIFICATIONS**


10 mil PLASTIC LINING -

- WOVEN WIRE FENCE TO BE FASTENED SECURELY TO FENCE POSTS WITH WIRE TIES OR STAPLES, POSTS SHALL BE STEEL "T" OF "U" TYPE OF HARDWOOD.
- 2. FILTER CLOTH TO BE FASTENED SECURELY TO WOVEN WIRE FENCE WITH TIES SPACED EVERY 24" AT TOP AND MID SECTION. FENCE SHALL BE WOVEN WIRE, 12 1/2 GAUGE, 6" MAXIMUM MESH
- 3. WHEN TWO SECTIONS OF FILTER CLOTH ADJOIN EACH OTHER THEY SHALL BE OVERLAPPED BY SIX INCHES AND FOLDED. FILTER CLOTH SHALL BE EITHER FILTER X, MIRAFI 100X, STABLINKKA T140N, OR APPROVED EQUIVALENT.
- 4. PREFABRICATED UNITS SHALL BE GEOFAB, ENVIROFENCE, OR APPROVED EQUIVALENT.
- MAINTENANCE SHALL BE PERFORMED AS NEEDED AND MATERIAL REMOVED WHEN "BULGES" DEVELOP IN THE SILT FENCE.
- 6. ENVIRO-FENCE WITH INTEGRAL MESH IS AN ACCEPTABLE SUBSTITUTE. SILT FENCE

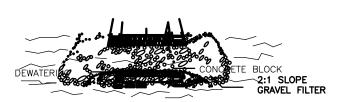

SCALE: N.T.S

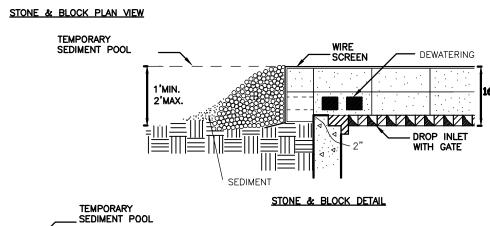

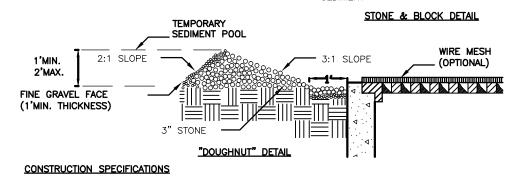

1. LAY ONE BLOCK ON EACH SIDE OF THE STRUCTURE ON ITS SIDE FOR DEWATERING, FOUNDATION SHALL BE 2 INCHES MINIMUM BELOW REST OF INLET AND BLOCKS SHALL BE PLACED AGAINST INLET FOR HARDWARE CLOTH OR 1/2" WIRE MESH SHALL BE PLACED OVER BLOCK OPENINGS TO SUPPORT STONE.
 USE CLEAN STONE OR GRAVEL 1/2-3/4 INCH IN DIAMETER PLACED 2 INCHES BELOW TOP OF THE BLOCK ON A 2:1 SLOPE OR FLATTER.

4. FOR STONE STRUCTURES ONLY, A 1 FOOT THICK LAYER OF THE FILTER STONE WILL BE PLACED AGAINST THE 3 INCH STONE AS SHOWN ON THE DRAWINGS.

5. MAXIMUM DRAINAGE AREA 1 ACRE STONE & BLOCK DROP INLET PROTECTION SCALE: N.T.S

- 6. A 2" x 4" WOOD FRAME SHALL BE COMPLETED AROUND THE CREST OF THE FABRIC FOR OVER FLOW STABILITY.

DROP INLET PROTECTION

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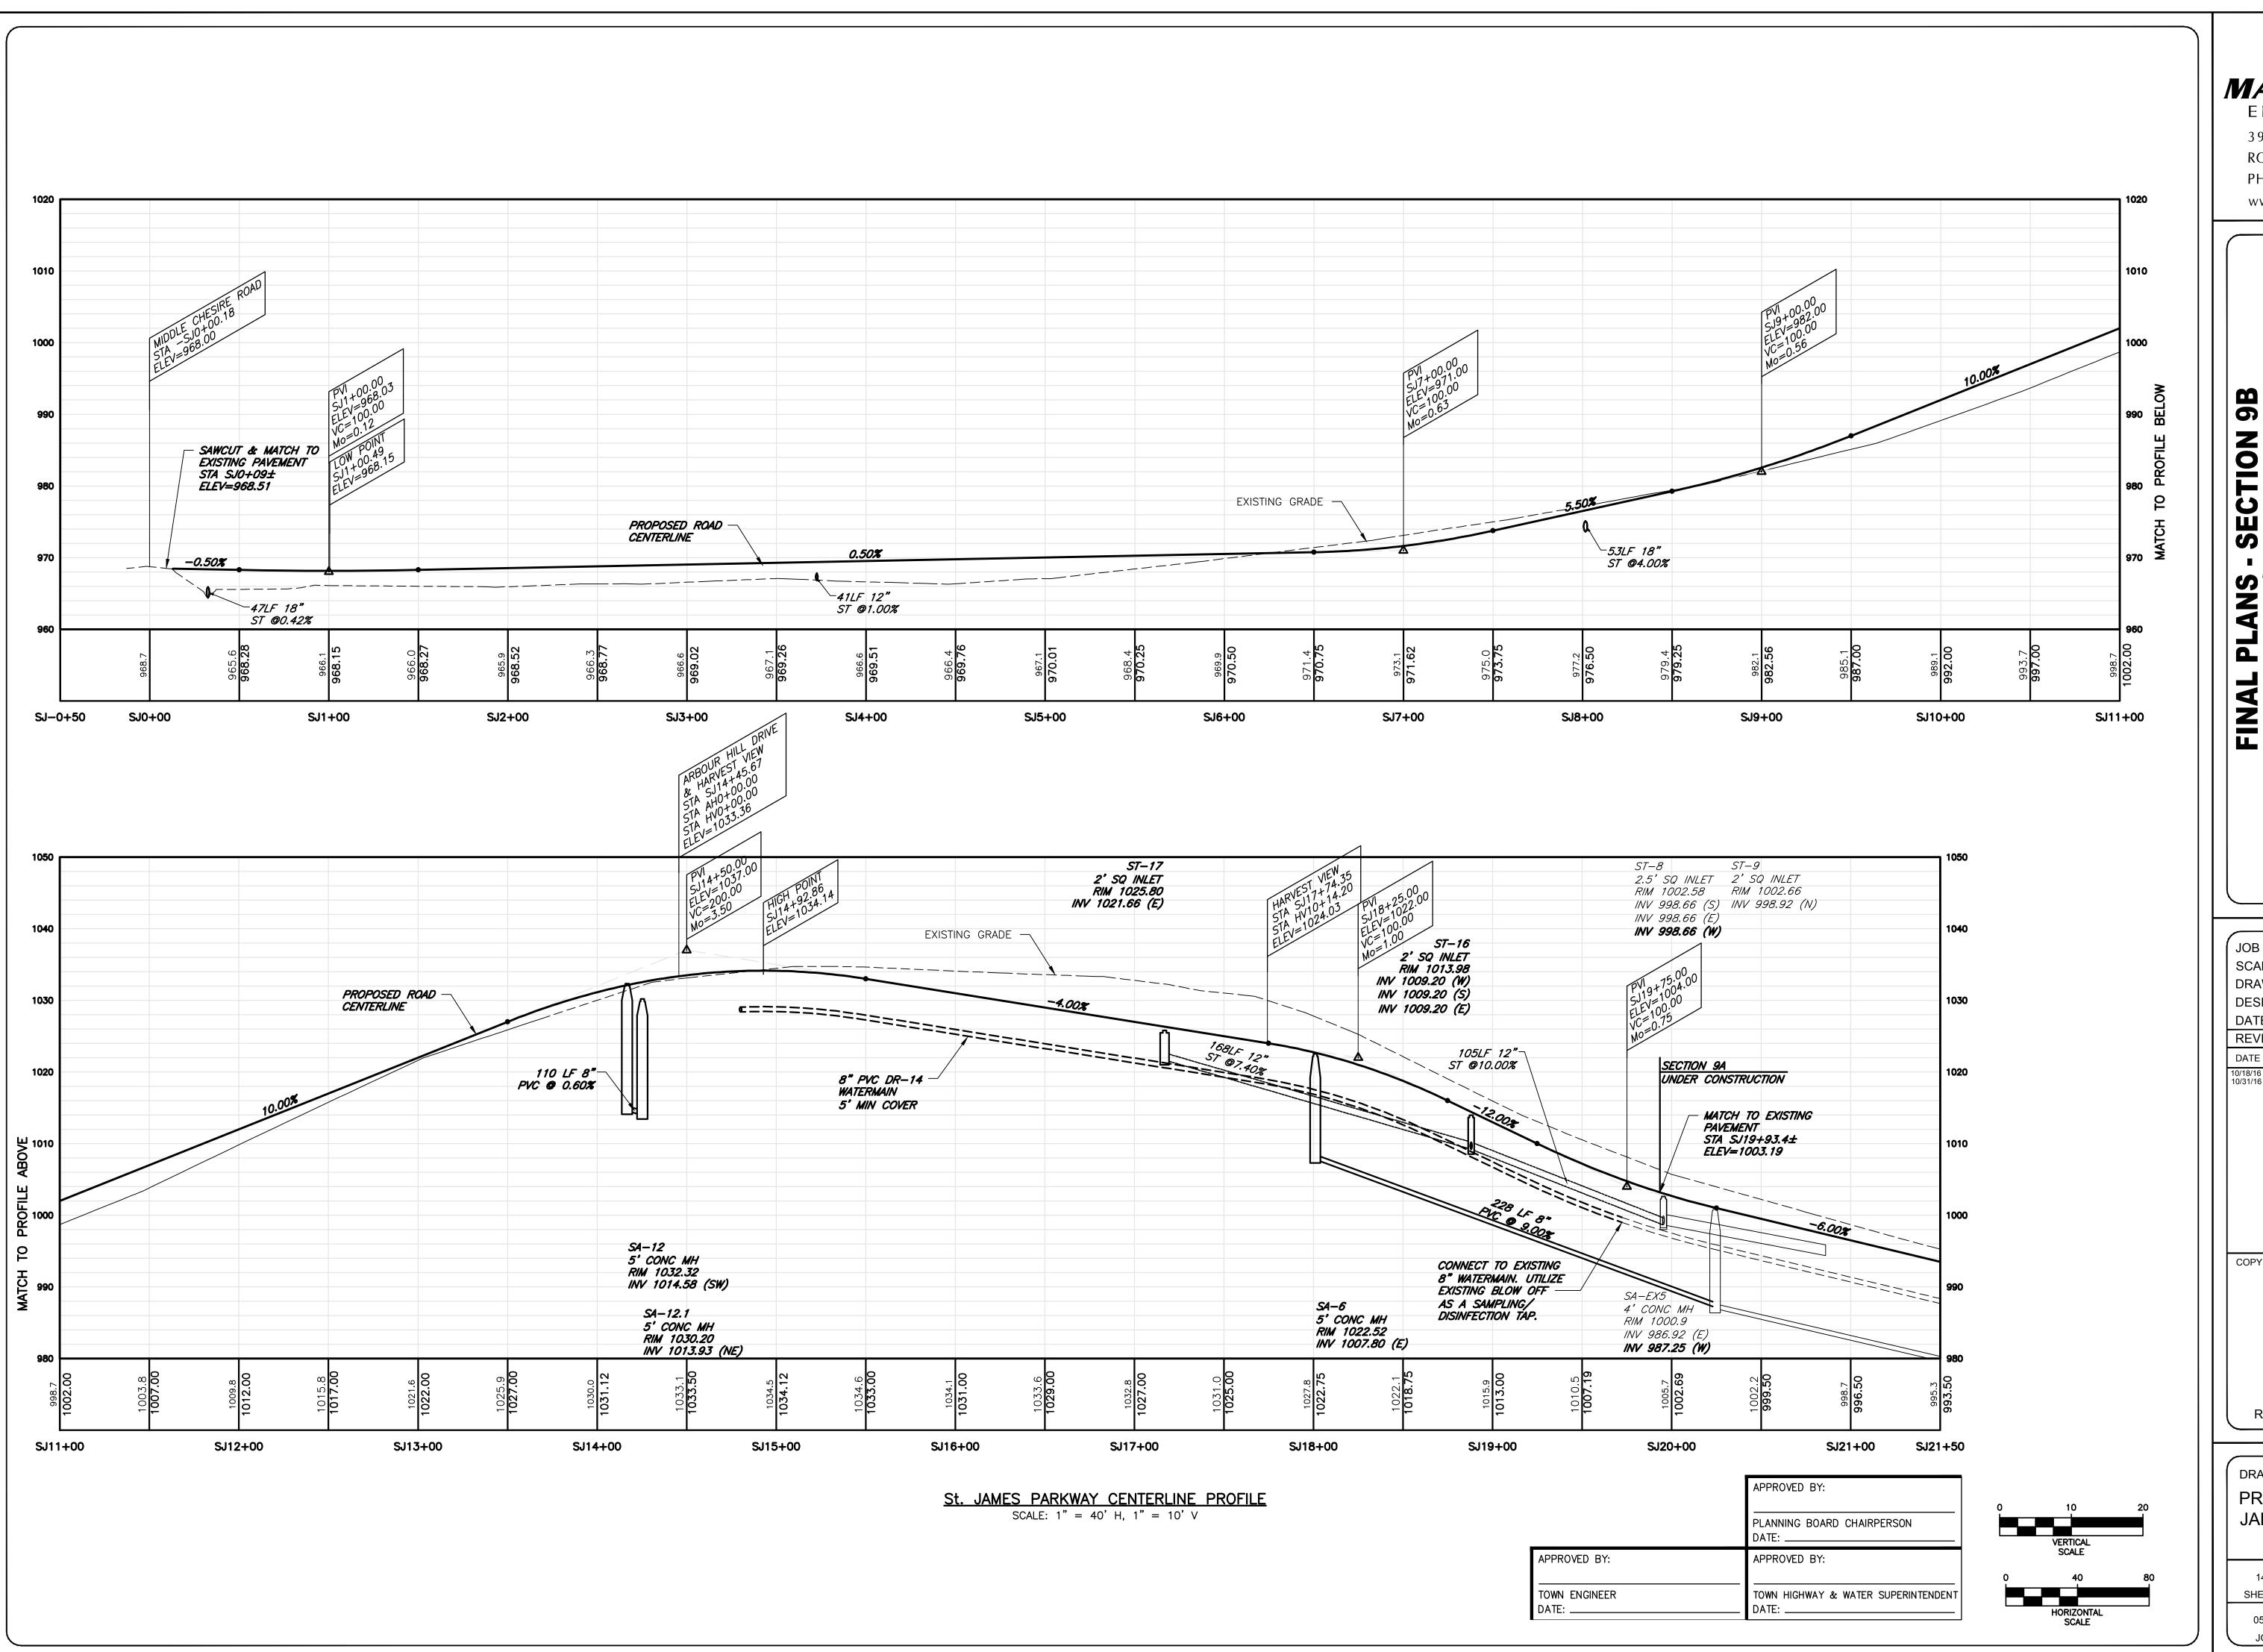
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**DRAWING TITLE: EROSION** CONTROL **DETAILS** 

13 of 21 SHEET No: 0551-16

DRAWING No:






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DRAWING TITLE: PROFILE - ST. JAMES PARKWAY

ROBERT P. BRINGLEY

14 of 21 SHEET No: 0551-16 JOB No: DRAWING No:



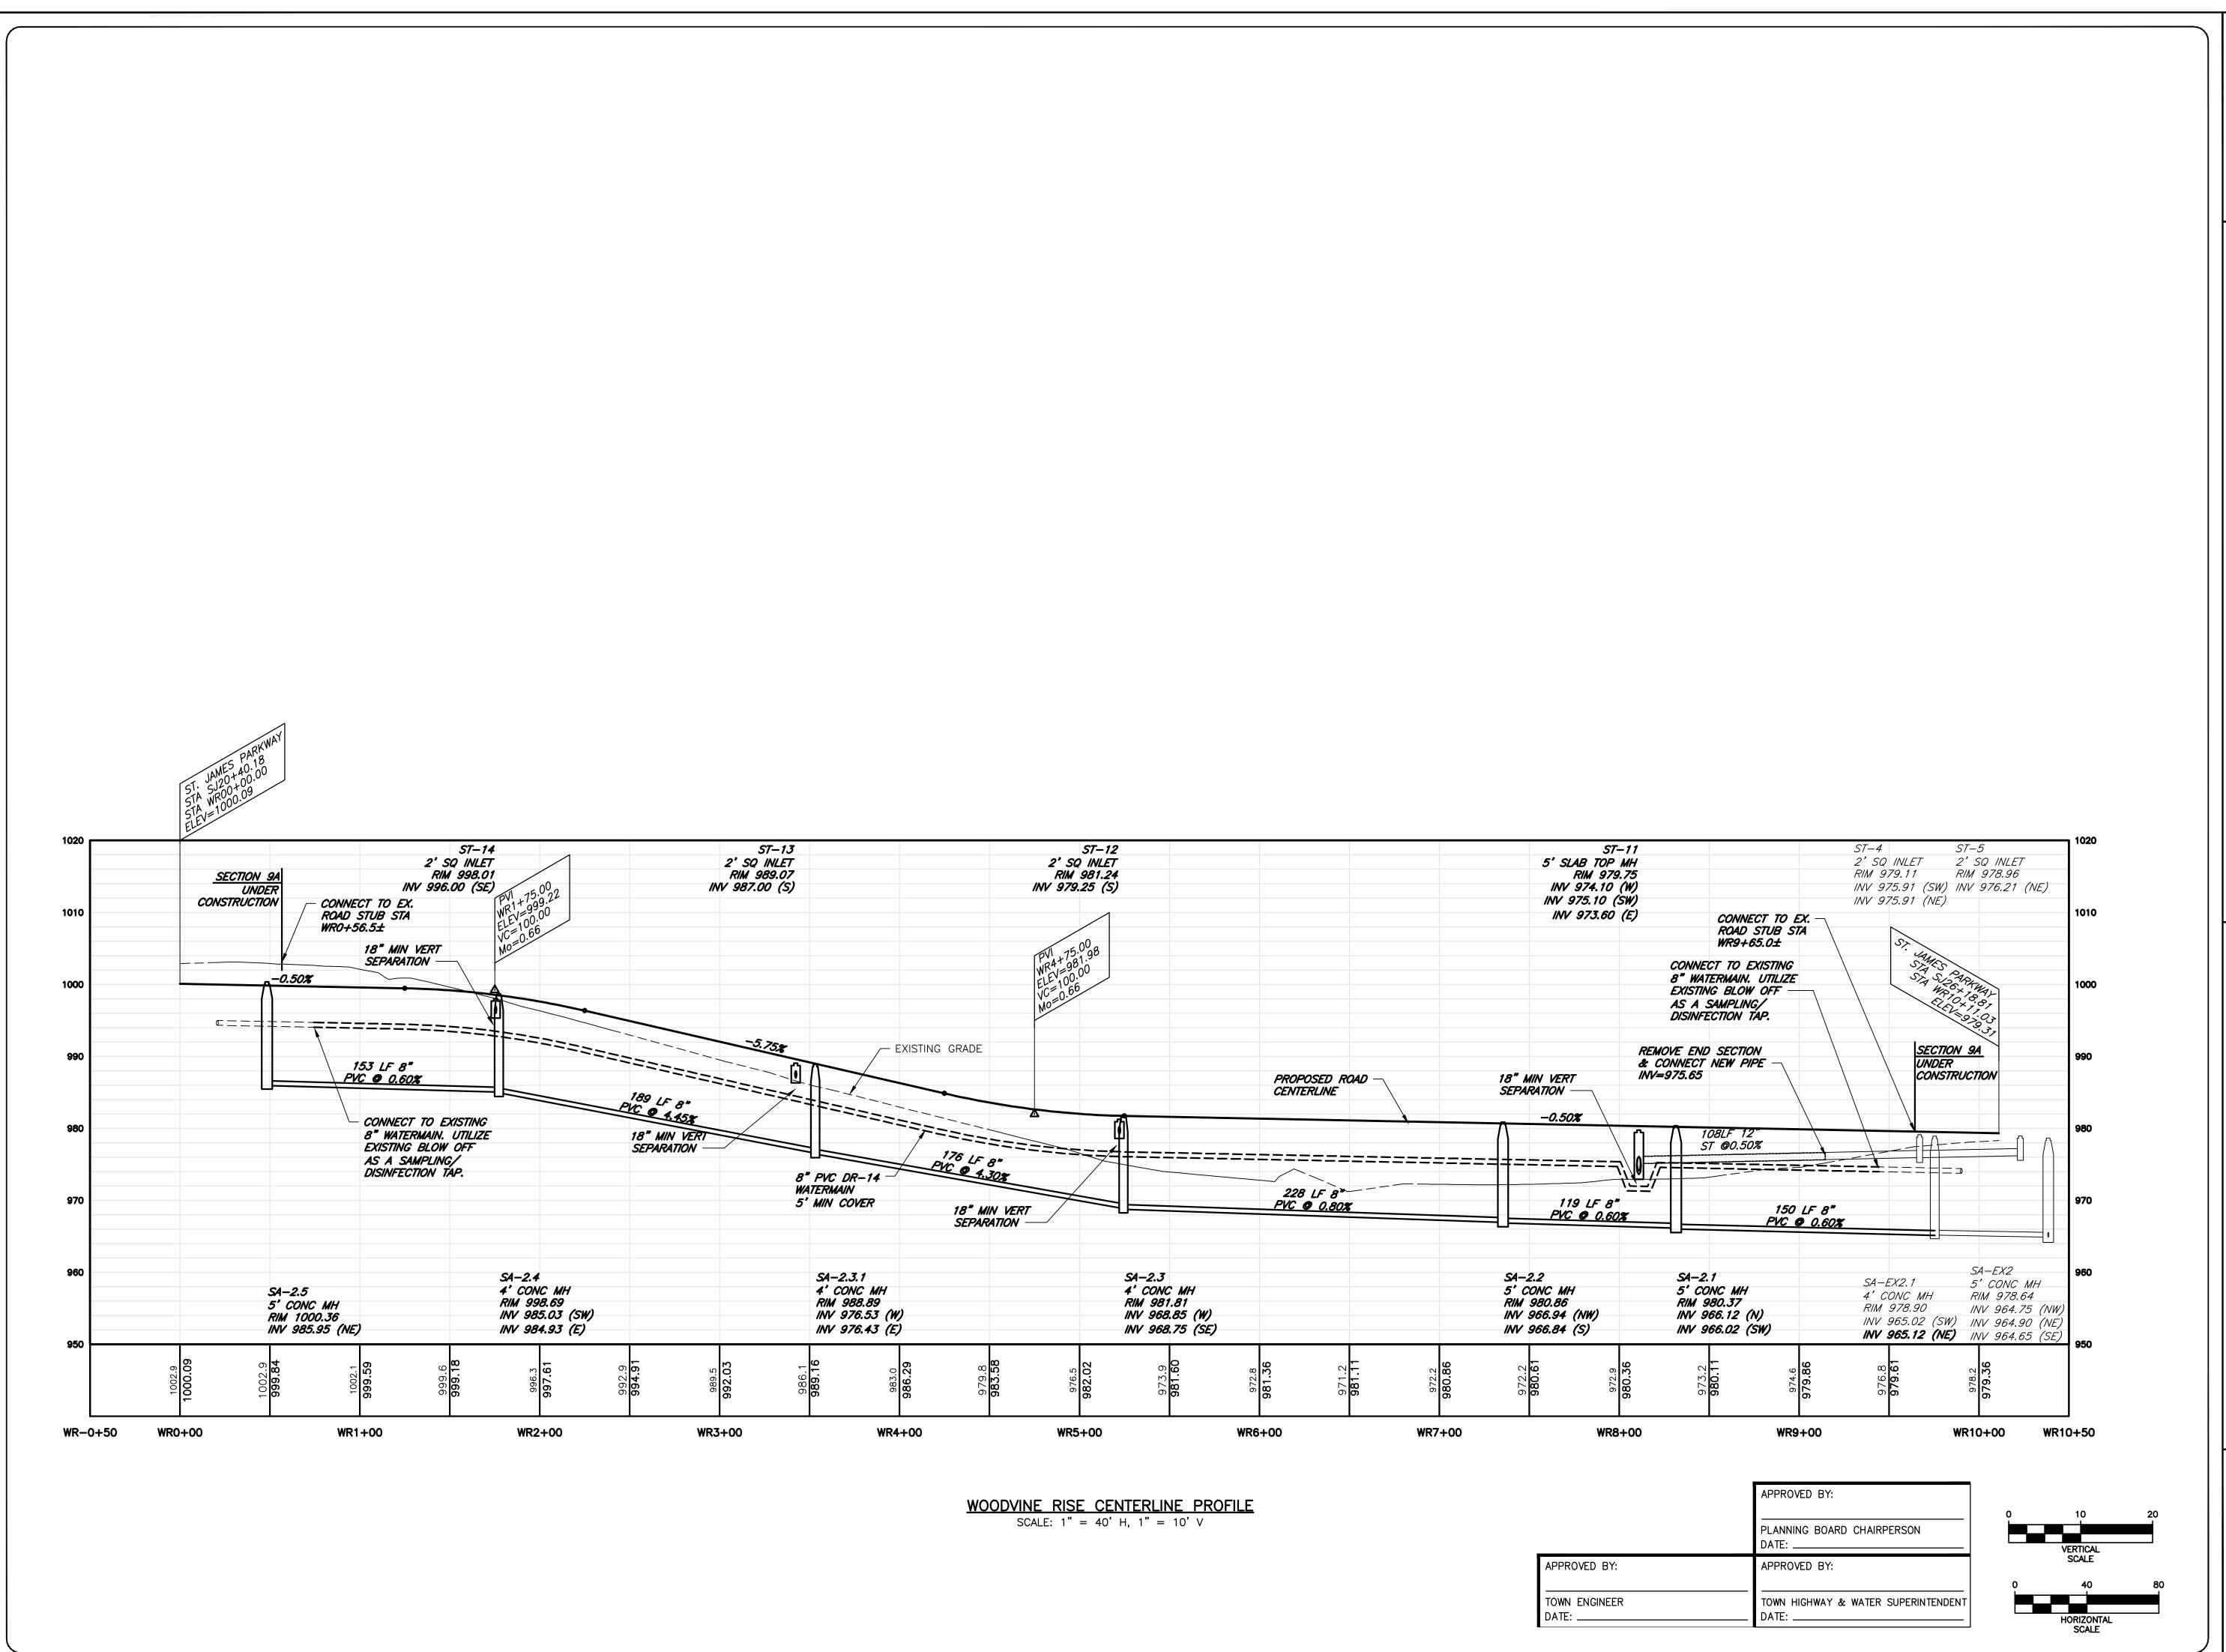

NEW YORK

ST. JAMES PARKWAY
ONTARIO COUNTY

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JOB NO: 0551-16
SCALE: 1" = 30'
DRAWN: RJT
DESIGNED: RJT

DRAWN: RJT
DESIGNED: RJT
DATE: 7/15/16
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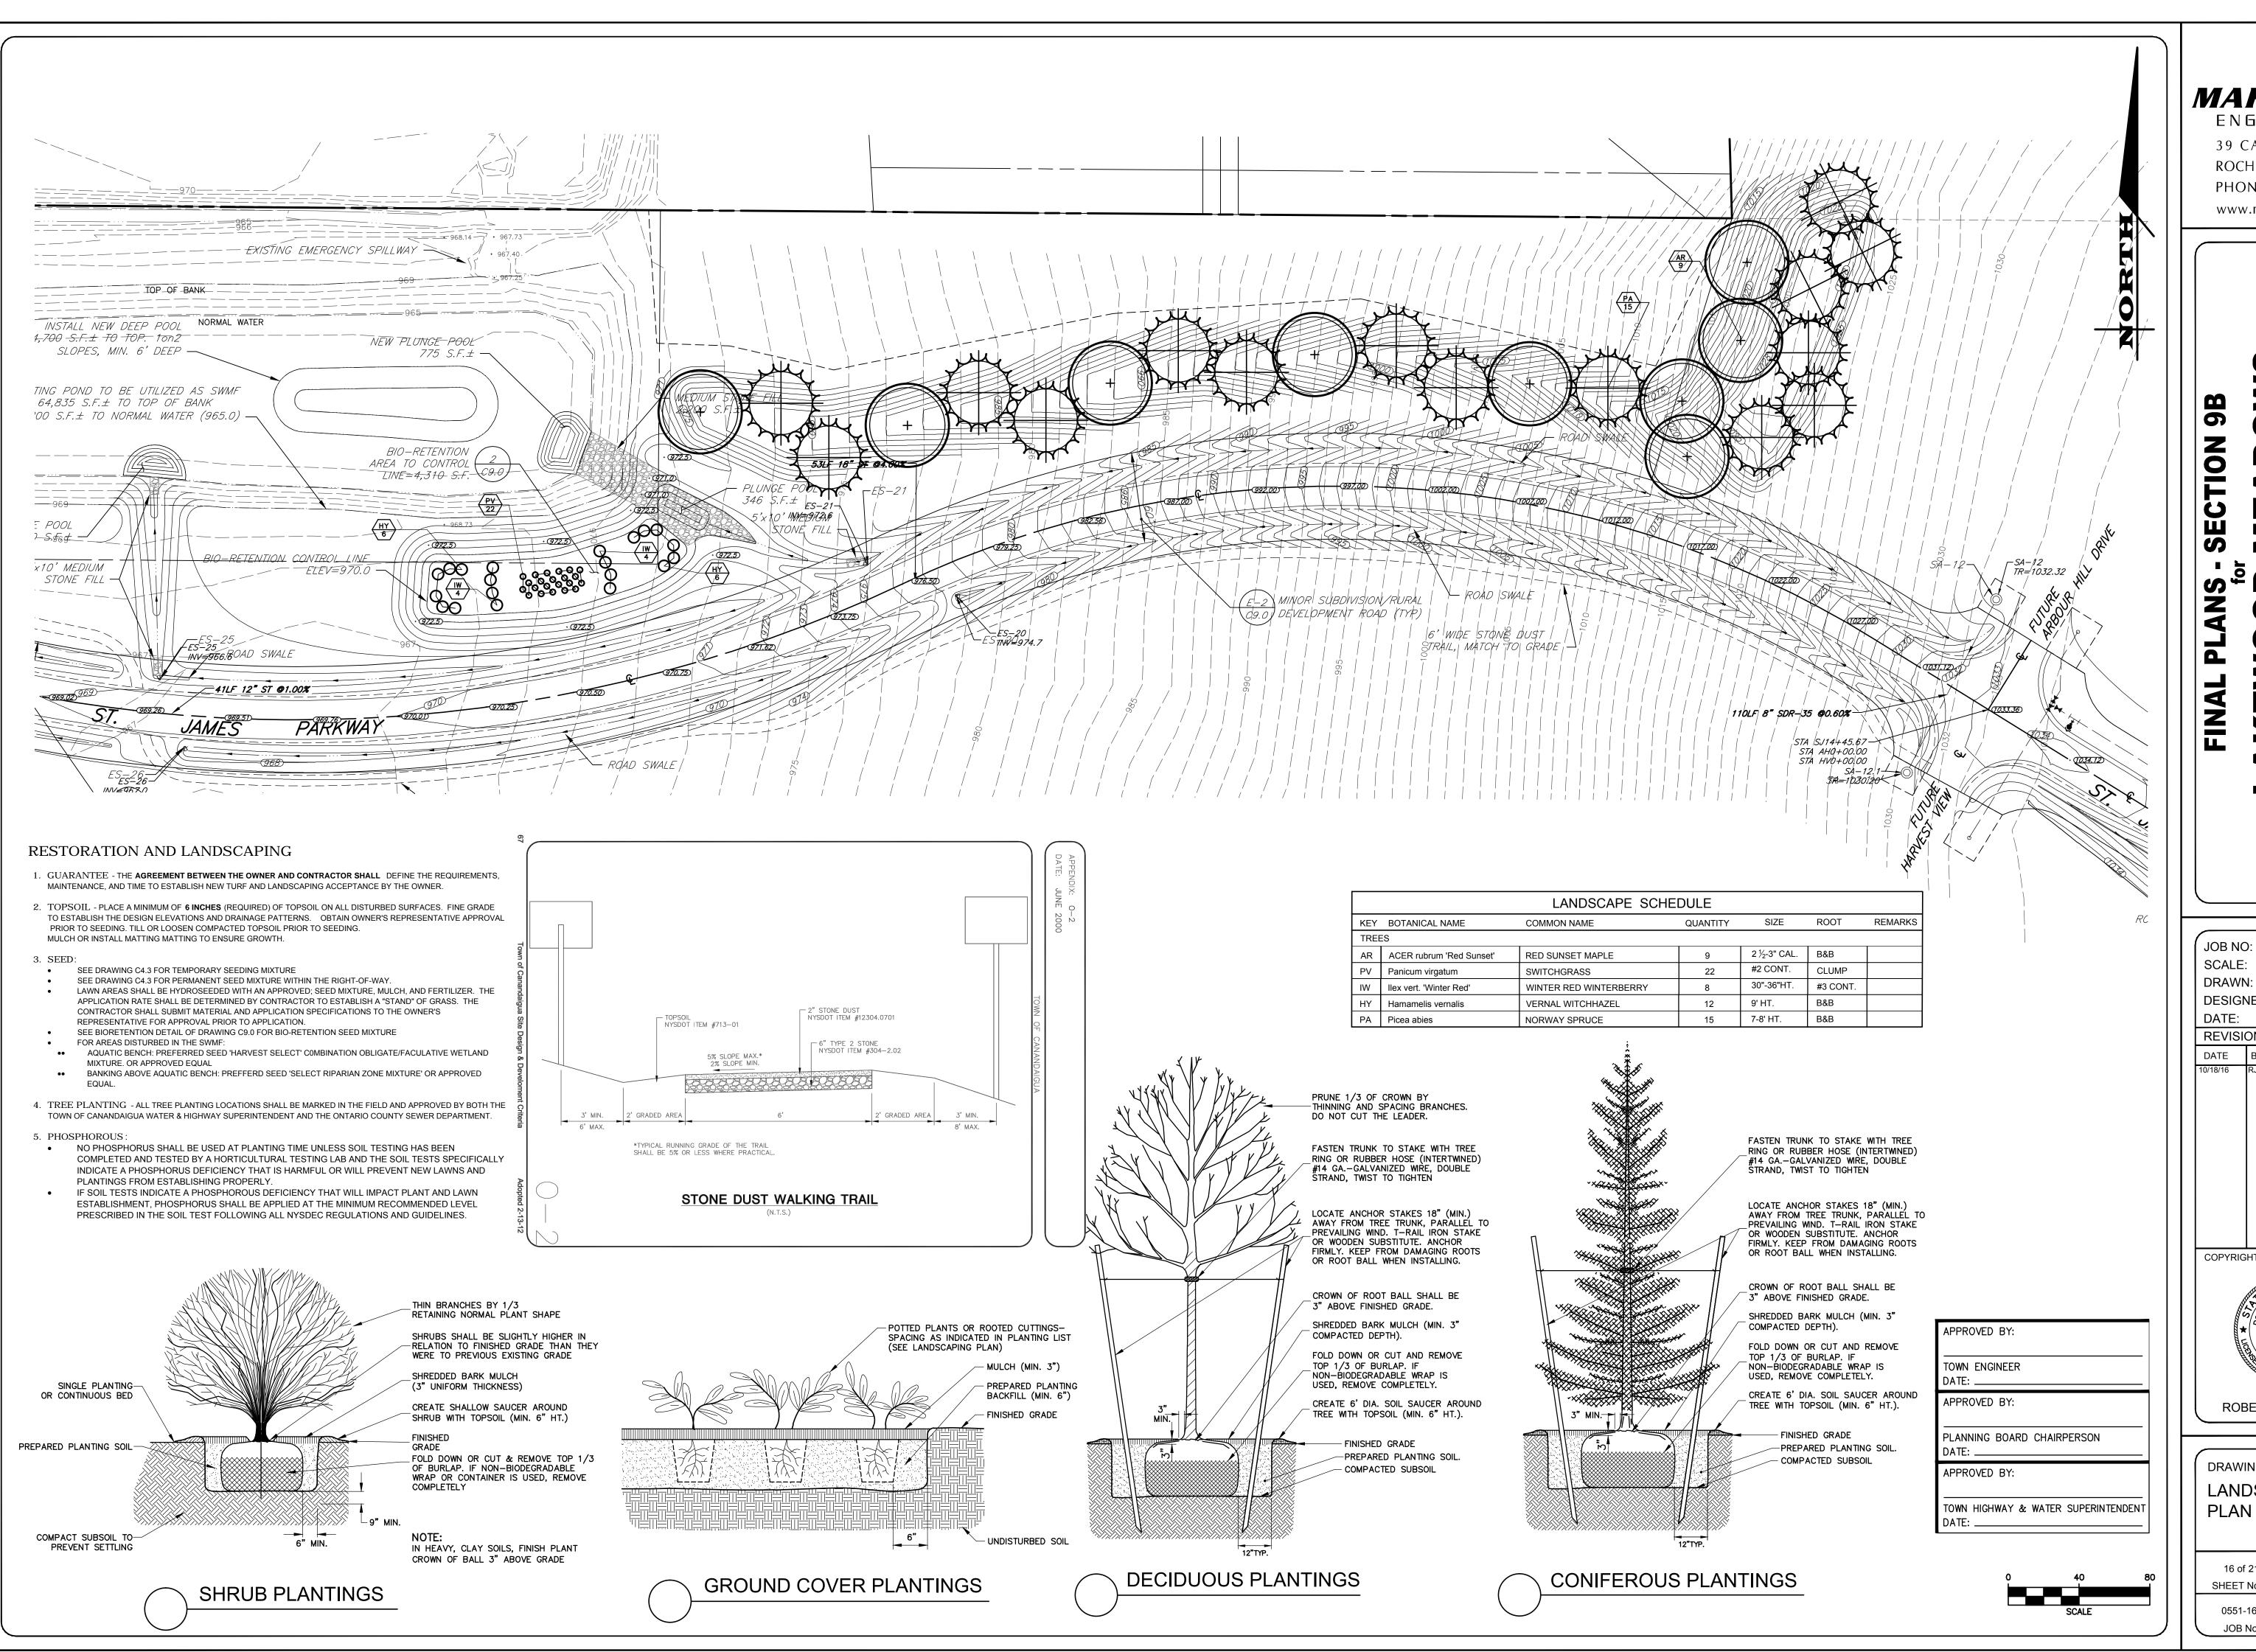
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DRAWING TITLE:
PROFILE WOODVINE RISE

15 of 21 SHEET No: **C6.** 0551-16

DRAWING No:

JOB No:



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JOB NO: 0551-16 1" = 40' RJT DESIGNED: RJT 7/15/16

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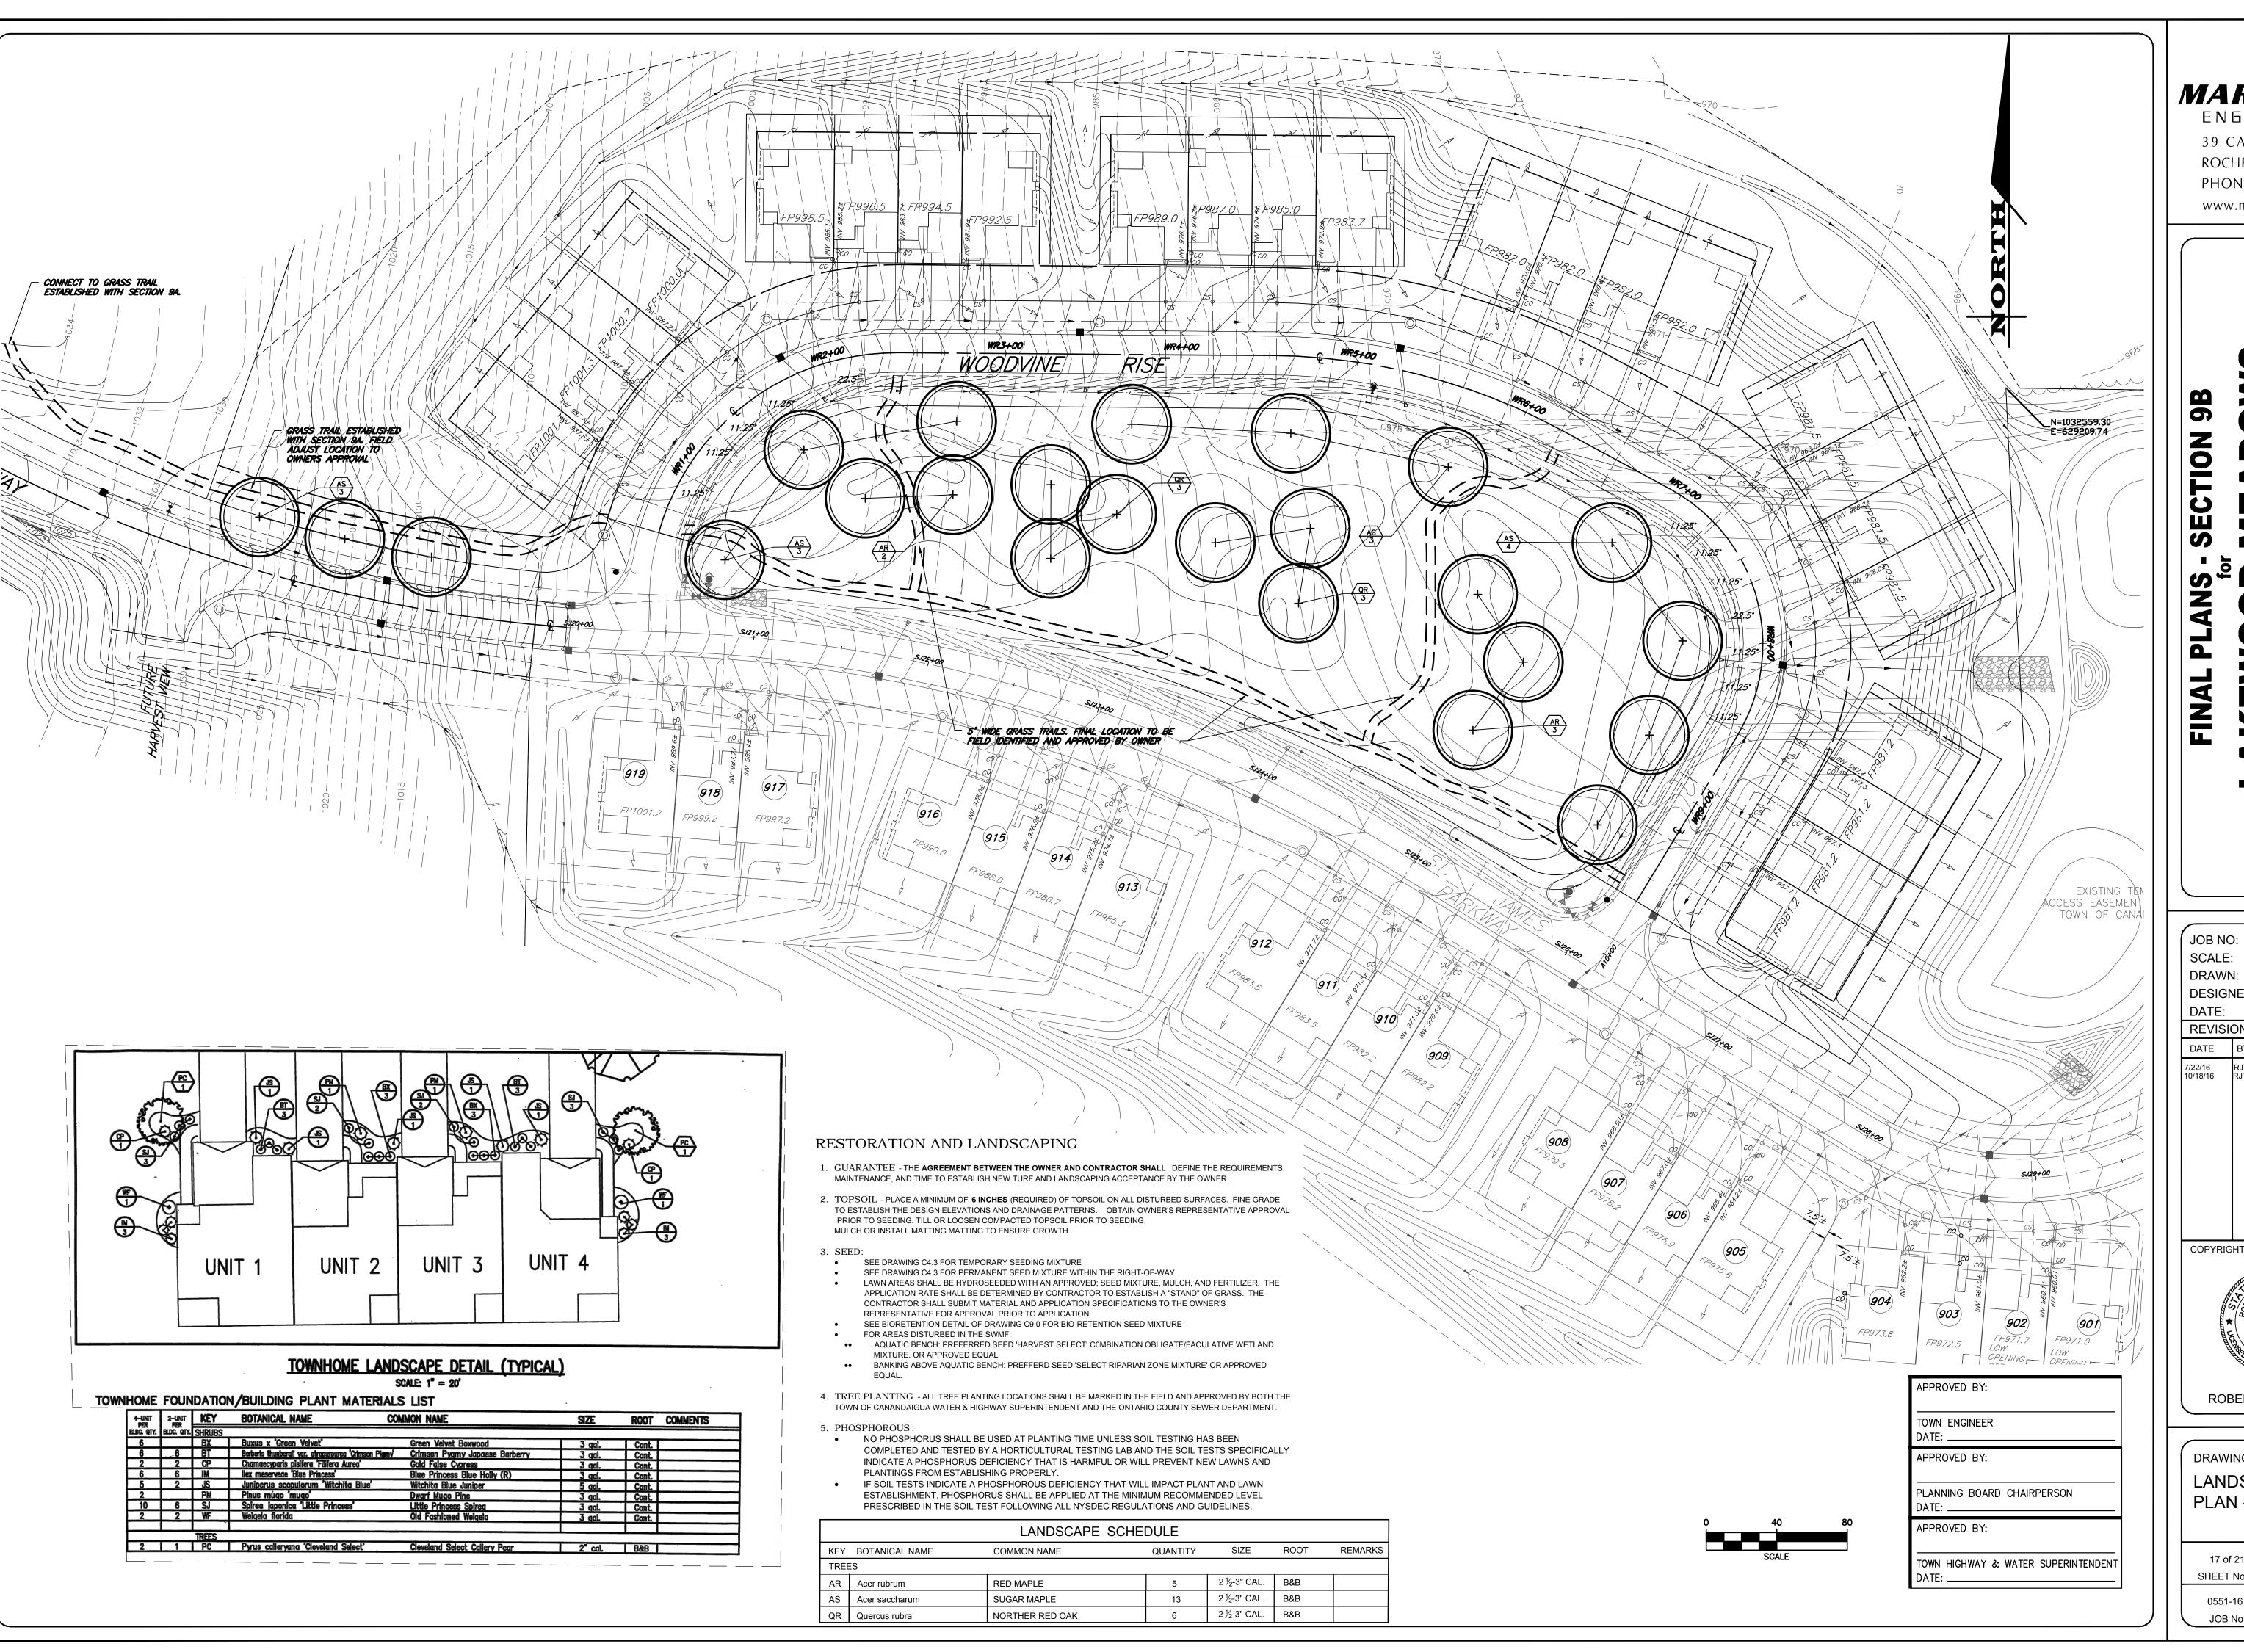


ROBERT P. BRINGLEY

DRAWING TITLE: LANDSCAPING PLAN - SHEET 1

SHEET No:

0551-16 JOB No: DRAWING No:



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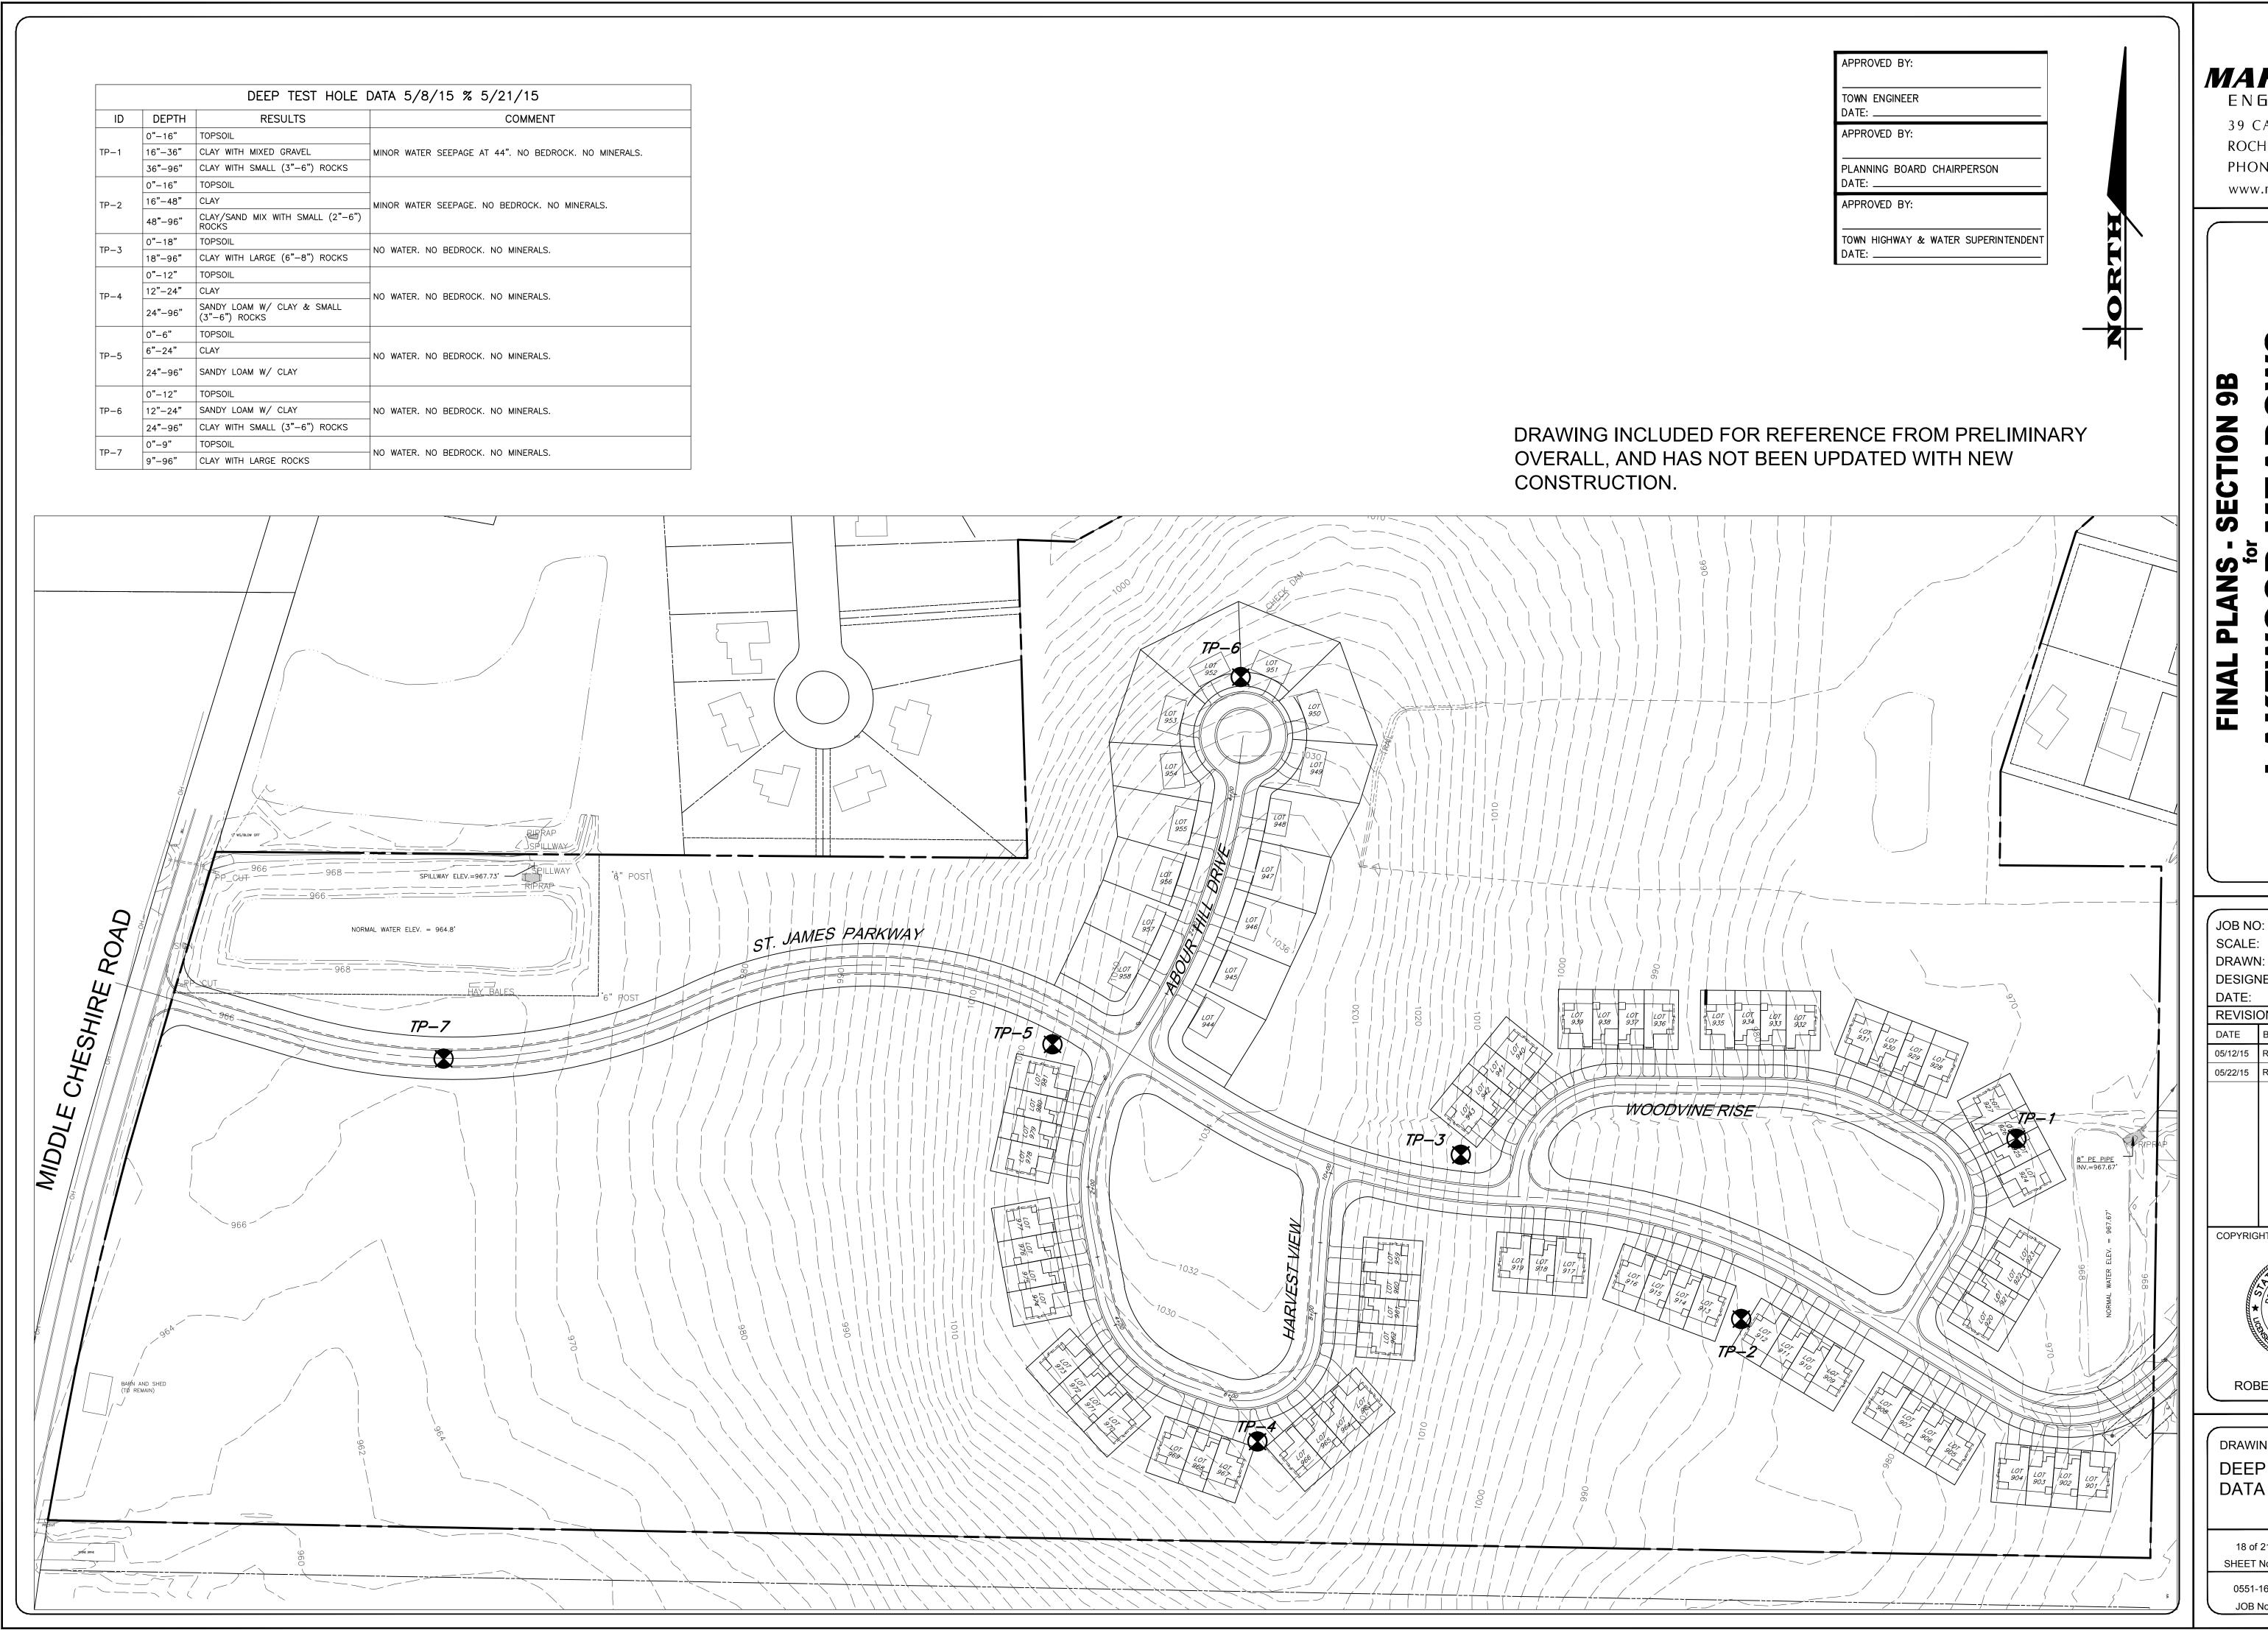
DRAWING TITLE:

ROBERT P. BRINGLEY

LANDSCAPING PLAN - SHEET 2

17 of 21 SHEET No: 0551-16

DRAWING No:





OF NEW YORK

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ST. JAMES PARKWA ONTARIO COUNTY

0551-16 1" = 100'

SCALE: 1" = 100'
DRAWN: RJT
DESIGNED: RJT
DATE: 5/5/15
REVISIONS

DATE BY REVISION

05/12/15 RJT ISSUED FOR BID

05/22/15 RJT DEEP HOLE DATA


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DRAWING TITLE:
DEEP HOLE SOILS
DATA

DRAWING No:

18 of 21
SHEET No: C8.2



TOWN ENGINEER

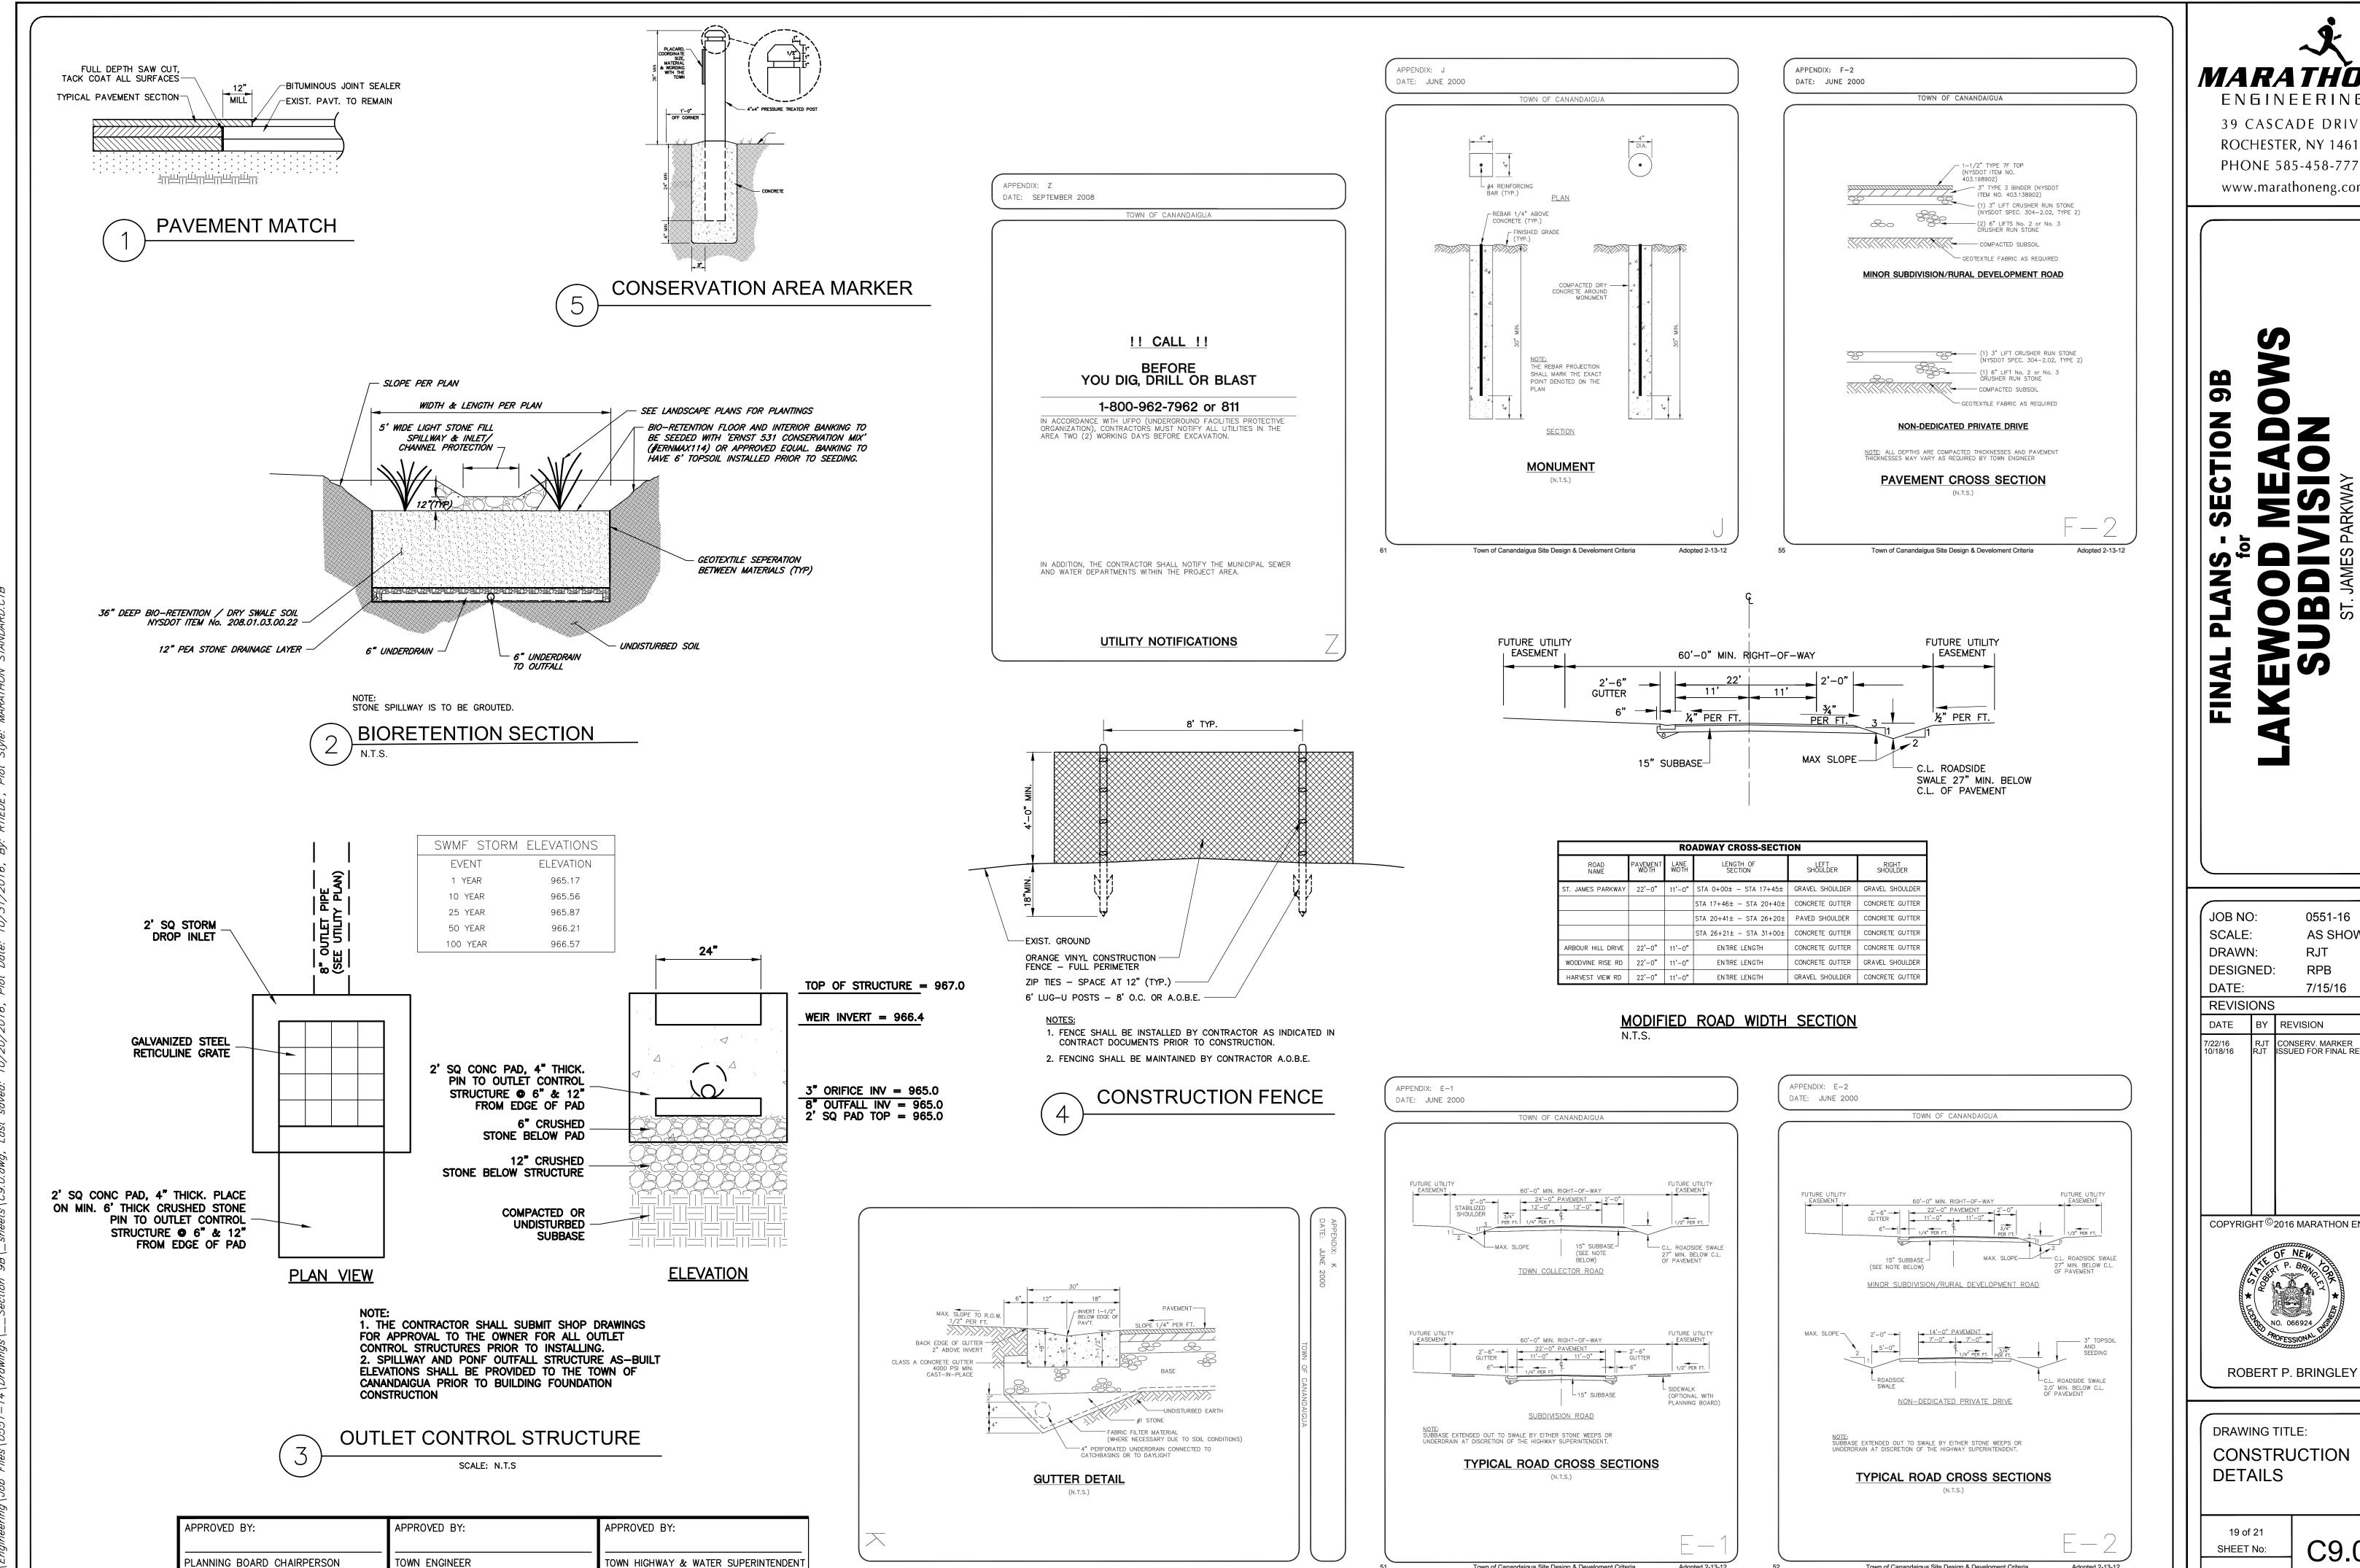DATE: \_\_\_

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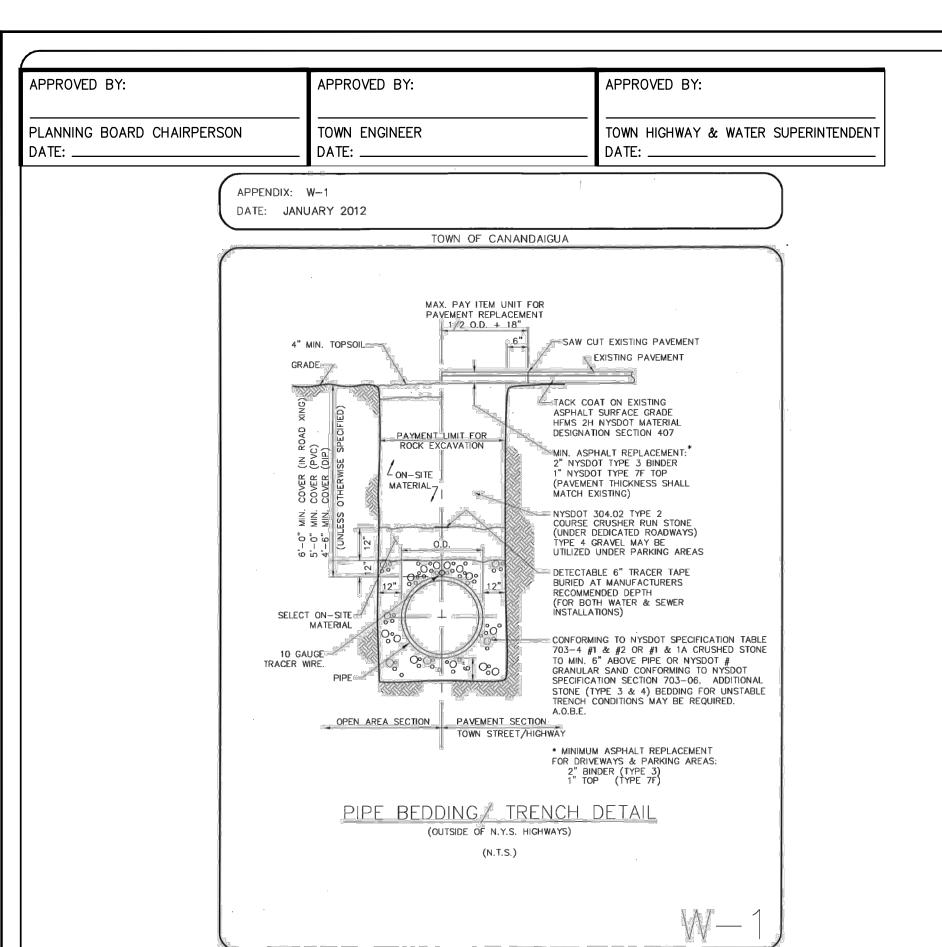
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**DRAWING TITLE:** CONSTRUCTION **DETAILS** 

19 of 21 SHEET No: 0551-16 JOB No: DRAWING No:


Town of Canandaigua Site Design & Develoment Criteria


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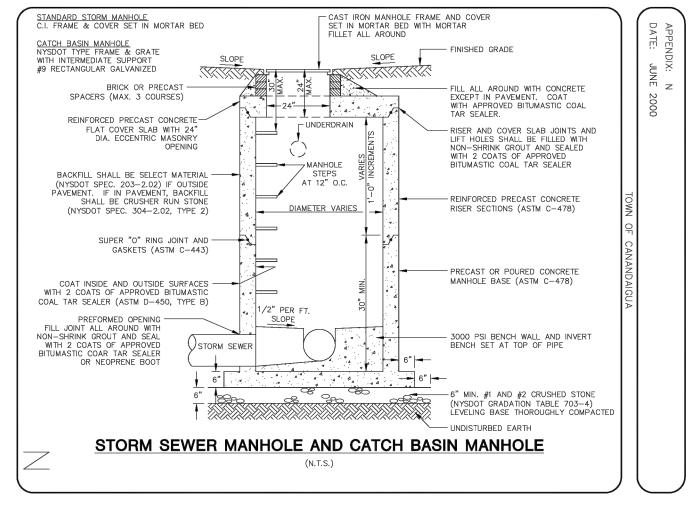



APPENDIX: M


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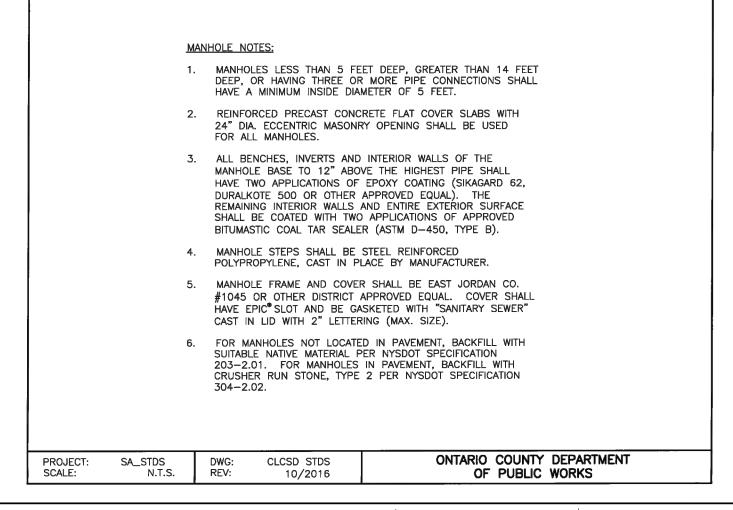





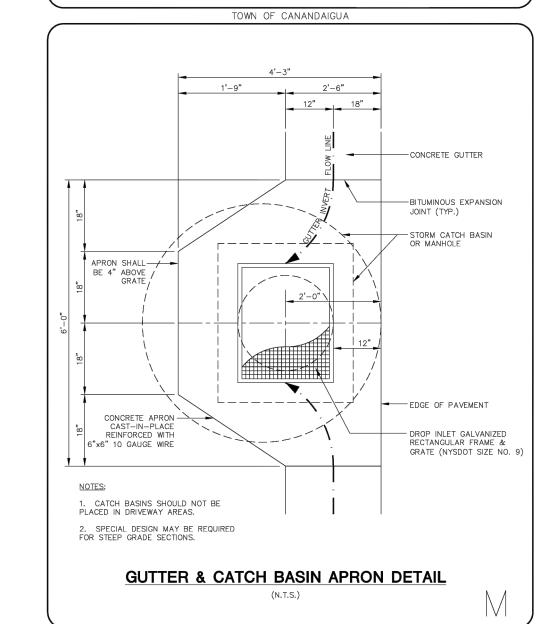


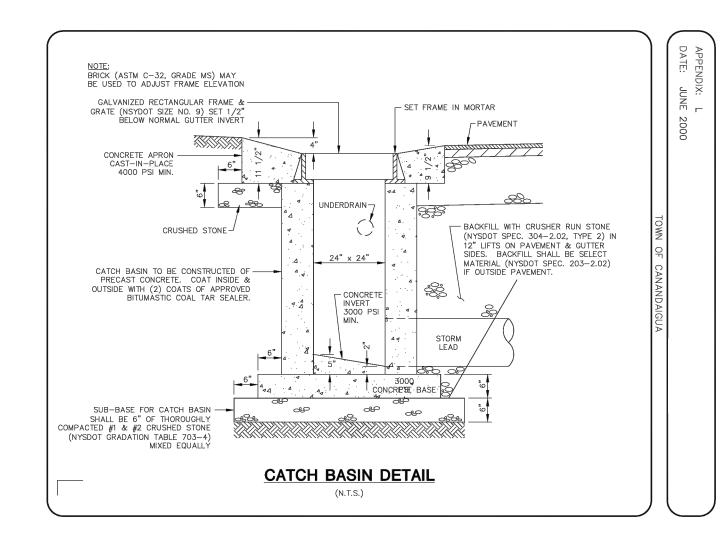

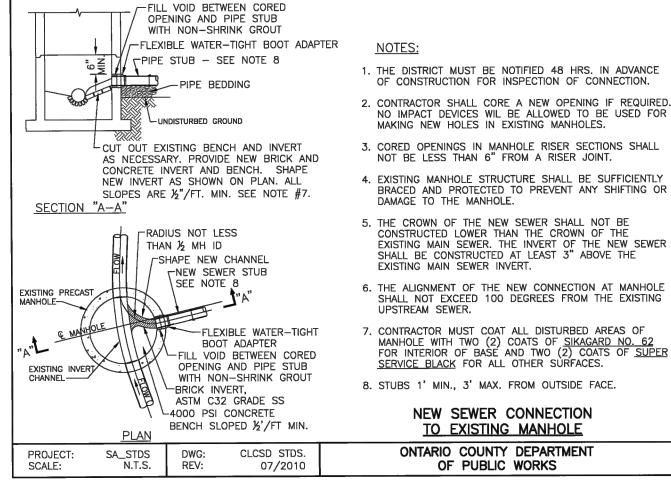


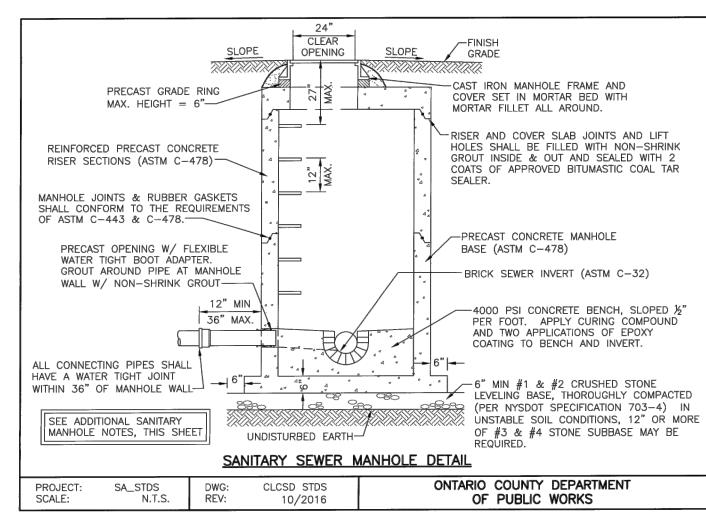


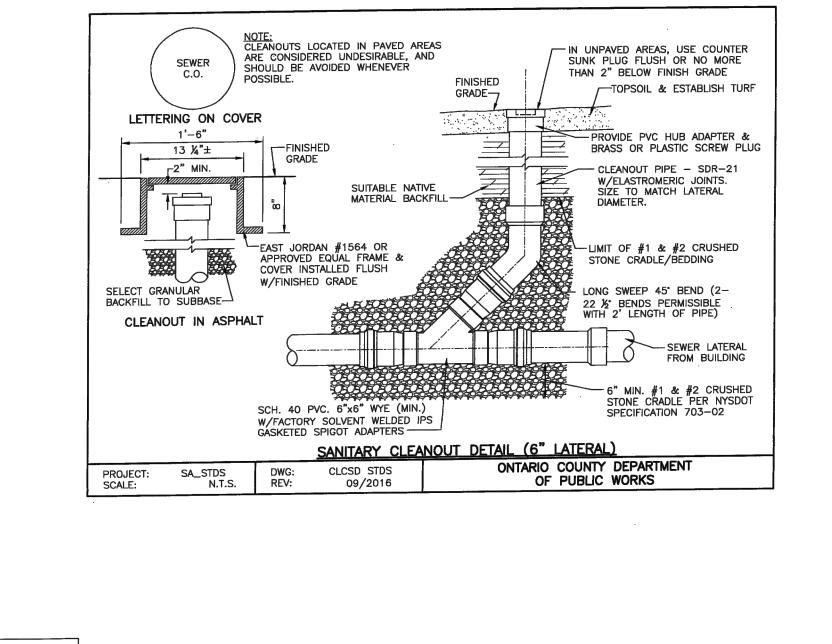

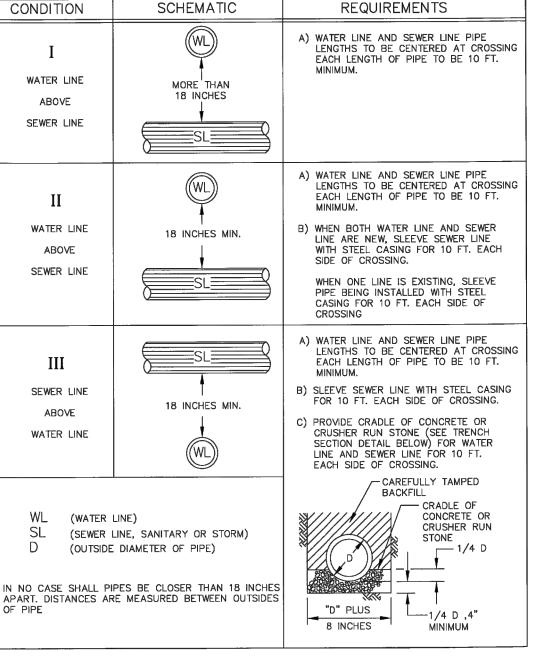

WATERMAIN / SEWER CROSSING DETAIL

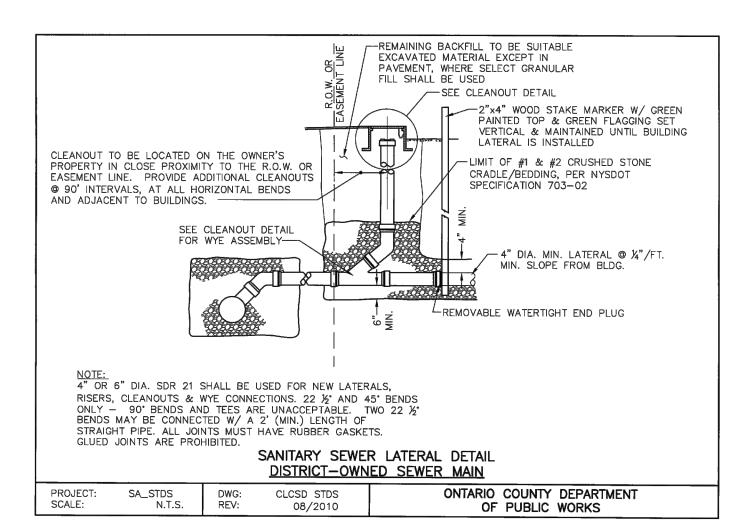

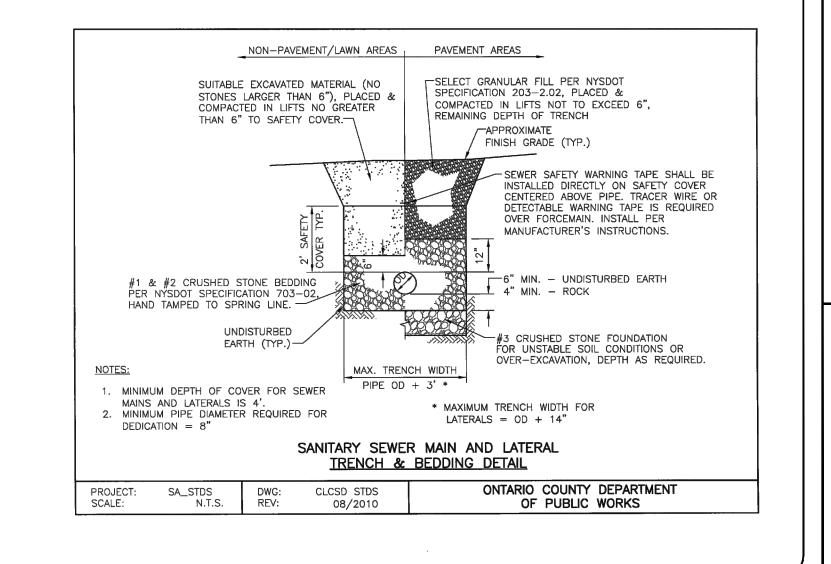



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0551-16

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**DRAWING TITLE:** CONSTRUCTION **DETAILS** 20 of 21

ROBERT P. BRINGLEY

SHEET No: 0551-16

DRAWING No:

JOB No:

### TOWN OF CANANDAIGUA SPECIFICATIONS FOR WATERMAIN MATERIALS

### 3.5 WATER MAINS

- A. DUCTILE IRON (DIP) PIPE SHALL CONFORM TO AWWA C-151/A21.51 AND THE MINIMUM ALLOWABLE THICKNESS SHALL BE CLASS 52. PIPE SHALL BE CEMENT LINED IN ACCORDANCE WITH AWWA C-104/A21.4 AND SHALL HAVE RUBBER GASKET PUSH-ON JOINT IN ACCORDANCE WITH AWWA C-111/A21.11. IF SOIL CONDITIONS WARRANT, POLYETHYLENE WRAP SHALL BE REQUIRED.
- B. POLYVINYL CHLORIDE (PVC) PIPE SHALL MEET SPECIFICATIONS OF AWWA C-900 MADE FROM PVC COMPOUND 12454-B (ASTM D1784) WITH GASKET JOINTS MEETING ASTM D3139
- C. MOLECULARLY ORIENTED POLYVINYL CHLORIDE (PVCO) PIPE PVCO SHALL MEET SPECIFICATIONS OF AWWA C-909 MADE FROM PVC COMPOUND 12454-B (ASTM D1784) WITH GASKET JOINTS MEETING ASTM D3139
- D. HIGH-DENSITY POLYETHYLENE (HDPE) PIPE SHALL MEET SPECIFICATIONS OF AWWA C-906 MADE FROM COMPOUND 345464-C (ASTM D3350) WITH FITTINGS TO BE USED WILL BE IN ACCORDANCE WITH THE MATERIAL'S SPECIFICATION.

### E. FITTINGS.

- (1) DUCTILE IRON SHALL MEET AWWA C-153/A21.53 SPECIFICATIONS, MINIMUM CLASS 350, WITH MECHANICAL OR PUSH-ON JOINT, EXCEPT FOR HYDRANT BRANCHES WHICH SHALL BE MECHANICAL JOINT.
- (2) FITTINGS SHALL BE CEMENT LINED IN ACCORDANCE WITH AWWA C-104/A21.4.
- (3) BOLTS AND NUTS SHALL BE HIGH-STRENGTH, LOW ALLOY STEEL.
- (4) ALL JOINTS SHALL CONFORM TO THE REQUIREMENTS OF AWWA C-111/A21.11.
- (5) ALL APPENDAGES WILL BE TYLER FITTINGS ONLY NO SUBSTITUTION.

### F. APPURTENANCES.

- (1) <u>DETECTOR TAPE</u> SHALL BE BLUE IN COLOR, SIX INCHES (6") WIDE DETECTABLE MARKER TAPE AS MANUFACTURED BY TERRA TAPE OR EQUAL, SHALL BE INSTALLED ALONG MAIN LINE WATER MAIN (12" ABOVE TOP OF PIPE).
- (2) TRACER WIRE SHALL BE SOLID COPPER WIRE (#8 GAUGE MINIMUM) INSULATED WITH HIGH DENSITY POLYETHYLENE PER ASTM D-1248 ATTACHED TO THE PIPE AT 5 FOOT INTERVALS WITH PLASTIC TIES WITH A MINIMUM OF 150# TENSILE STRENGTH. WIRE SHALL BE ATTACHED TO ALL CAST FITTINGS, HYDRANTS AND VALVE BOXES TO MAKE A CONTINUOUS TRACEABLE SYSTEM.

### 3.6 HYDRANTS

- A. HYDRANTS SHALL BE MANUFACTURED IN ACCORDANCE WITH AWWA C-502.
- B. HYDRANTS SHALL BE MUELLER SUPER CENTURION MODEL 250 5-1/2 BURY THREE NOZZLE MODEL A, OR TOWN APPROVED EQUAL, MANUFACTURED FOR 5 FOOT BURY WITH BREAKAWAY FLANGE CONSTRUCTION AND 6 INCH MECHANICAL JOINT INLET.
- C. THEY SHALL OPEN LEFT AND BE PAINTED RED BODIES.
- D. HYDRANTS SHALL BE THREE-WAY WITH TWO 2-1/2 INCH HOSE NOZZLES AND ONE 4-1/2 INCH PUMPER CONNECTION, ALL WITH NATIONAL STANDARD THREADS. MAIN VALVE OPENINGS SHALL BE 5-1/4 INCH WITH THE TOTAL UNIT CONSISTING OF THE TEE, GUARD VALVE, HYDRANT AND ADAPTORS. (SEE APPENDIX V).

### 3.7 FLUSHING HYDRANT — BLOWOFF

A. SHALL BE 2 INCH SELF-DRAINING, NON-FREEZING WITH 5 FOOT BURY, WITH ALL BRONZE PARTS DESIGNED TO CONNECT TO A 2 INCH MAIN LINE OUTLET AS MANUFACTURED BY GIL INDUSTRIES, INC., MODEL SLIM LINE 2, OR APPROVED EQUAL.

### 3.8 GATE VALVE AND BOX

- A. GATE VALVES SHALL CONFORM TO AWWA C-509 OR LATEST REVISION AND SHALL HAVE NON-RISING STEMS; "O" RING PACKING, AND OPEN LEFT. THEY SHALL BE OF THE 350 PSI TEST CLASS WITH A MINIMUM WORKING PRESSURE OF 250 PSI. VALVES SHALL BE MANUFACTURED BY MUELLER CO., MODEL 2360, OR TOWN APPROVED EQUAL, WITH MJ ENDS, A 2" SQUARE OPERATING NUT.
- B. VALVE BOXES SHALL BE BIBBY-STE-CROIX MODEL NUMBER VB3000 SERIES, OR APPROVED EQUAL, TWO-PIECE SCREW-TYPE, CAST-IRON CONSTRUCTION, VALVE BOX, WITH A 5-1/4 INCH INSIDE DIAMETER AND COVERS MARKED "WATER".
- C. IF THE VALVES ARE BURIED DEEP THEY MUST HAVE A VALVE BOX EXTENSION.

### 3.9 TAPPING SLEEVE AND VALVE

A. ALL VALVES SHALL HAVE MECHANICAL JOINT ENDS AND BE FURNISHED WITH SUFFICIENT QUANTITIES OF ACCESSORIES. FOR CAST/DUCTILE IRON PIPE AND PVC PIPE TS&V SHALL BE MUELLER H-615 SLEEVE WITH A T-2360-16 TAPPING VALVE, OR TOWN APPROVED EQUAL. FOR AC PIPE TS&V SHALL BE MUELLER H-619 WITH T-2360-16 TAPPING VALVE OR TOWN APPROVED EQUAL.

### 3.10 ANCHORING FITTINGS

A. ANCHORING PIPE IN ACCORDANCE WITH ANSI-A21.4, OR LATEST REVISION. SHALL BE EMPLOYED TO ANCHOR ALL HYDRANTS TO GATE VALVES. THE ANCHORING PIPE SHALL BE COAL TAR COATED, CEMENT LINED AND PROVIDED WITH A ROTATING GLAND. THERE SHOULD BE A MINIMUM 18 INCHES BETWEEN HYDRANT AND GATE VALVE. THESE ANCHORING PIPES SHALL BE MANUFACTURED BY THE TYLER COMPANY, MODEL 5-198, OR APPROVED EQUAL.

### 3.11 BUTTERFLY VALVES


A. ALL VALVES GREATER THAN 12" IN DIAMETER SHALL BE BUTTERFLY TYPE. ALL BUTTERFLY VALVES SHALL CONFORM TO AWWA C-504, OR LATEST REVISION.

### 3.12 RESTRAINERS

A. SHALL BE MANUFACTURED OF HIGH STRENGTH DUCTILE IRON PIPE AND INCORPORATE A FULL 360 DEGREE SUPPORT AROUND THE PIPE. THEY SHALL BE AS MANUFACTURED BY UNI-FLANGE SERIES 1300, 1350, 1390, OR APPROVED EQUAL, DEPENDING ON THE SPECIFIC USE.


# 3.13 WATER SERVICE MATERIAL


- A. CORPORATION STOP SHALL BE CAST BRASS WITH "O" RING SEALS, MUELLER H-15008 (3/4), 2").
- B. CURB STOPS SHALL HAVE CAST BRASS BODIES WITH "O" RING SEALS, COMPRESSION TYPE, MUELLER  $H\HICH15209 (3/4", 2").$
- C. CURB BOXES SHALL BE TWO (2) PIECE BOXES WITH A SLIDE TYPE EXTENSION, A CAST IRON ARCH PATTERN LOWER SECTION, A ONE (1) PIECE CAST IRON LID AND A STAINLESS STEEL STATIONARY SHUT-OFF ROD, MUELLER H-10314 (3/4"), H-10310 (2").
- D. WATER SERVICE PIPE SHALL BE TYPE "K" COPPER, MINIMUM 200 PSI WORKING PRESSURE, ALL
- ACCORDING TO ASTM B-88. PLASTIC TYPE CTS200 IS ALSO ALLOWED WITH TRACER WIRE.
- E. PLASTIC PIPE SHALL BE COPPER TUBE SIZE (CTS) POLYETHYLENE ASTM D-2737, PE4710 HDPE PER AWWA C-901 ON A MINIMUM BASIS OF 200 PSI (ONLY USED FROM CURB BOX TO UNIT AND A #10 GAUGE COPPER TRACER WIRE SHALL BE INCLUDED FROM THE CURB BOX TO THE STRUCTURE)

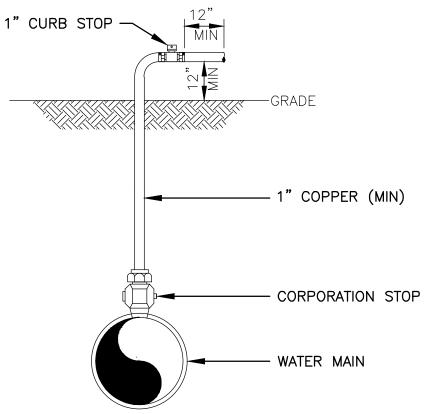


NOTE: IMMEDIATELY PRIOR TO THE AUTHORITY PLACING WATER MAIN/WATER SERVICE INTO SERVICE THE CONTRACTOR IS REQUIRED TO REMOVE ALL CORPORATIONS ASSOCIATED WITH TEMPORARY FACILITIES SUCH AS SAMPLING/DISINFECTION TAPS AND REPLACE WITH A THREADED BRASS PLUG. THE INSTALLATION OF THE PLUG MUST BE WITNESSED BY A WATER AUTHORITY REPRESENTATIVE.

### DISINFECTION/SAMPLING TAP NOT TO SCALE

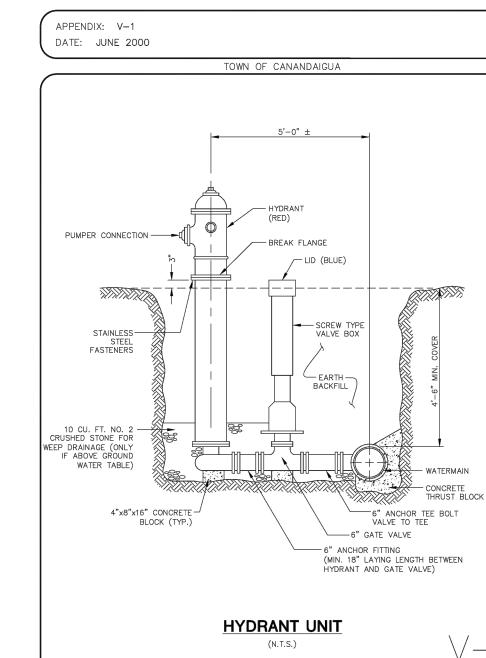

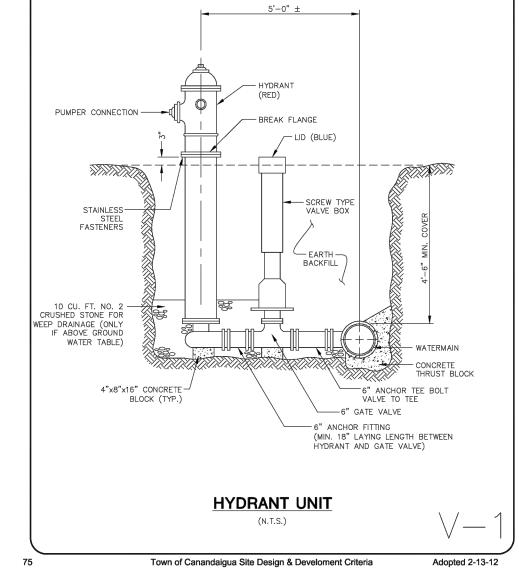

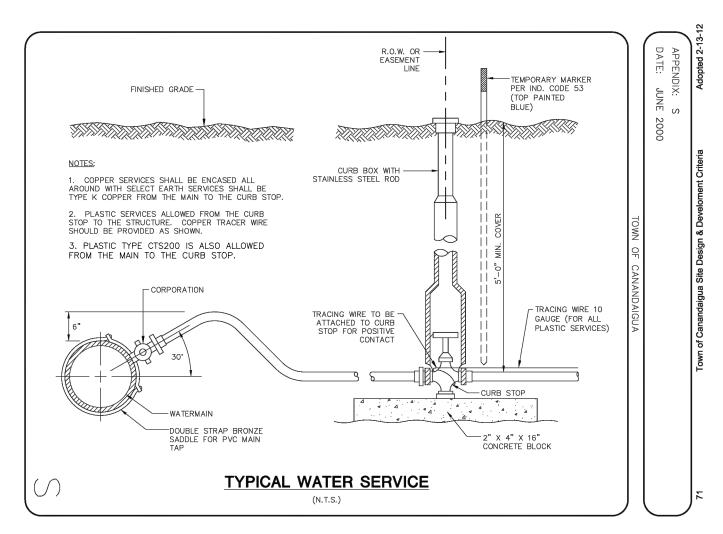

APPENDIX: U-2 DATE: JUNE 2000

### NOTES: ALL DIMENSIONS ARE IN FEET.

- 2. BEARING AREAS ARE BASED ON ALLOWABLE SOIL BEARING PRESSURE
- 3. HEIGHT OF THRUST BLOCK SHOULD BE EQUAL TO OR LESS THAN 1/2 THE DEPTH FROM THE GROUND SURFACE TO THE BASE OF THE BLOCK. 4. ALL THRUST BLOCKS SHALL CURE A MINIMUM OF SEVEN (7) DAYS BEFORE ANY PRESSURE TESTS ARE CONDUCTED.


TOWN OF CANANDAIGUA

	1								
PIPE SIZE	WORKING PRESSURE	TEE OR PLUG		90° BEND		45° BEND		22-1/2° BEND	
(INCHES)	(PSIG)	L	D	L	D	L	D	L	D
4	150	1.50	0.67	1.50	0.67	1.50	0.67	1.50	0.6
	250	1.50	0.67	1.67	0.75	1.50	0.67	1.50	0.6
6	150	1.67	0.75	2.00	1.00	1.50	0.67	1.50	0.6
	250	2.00	1.25	2.00	1.50	1.75	1.00	1.50	0.6
8	150	2.00	1.25	2.00	1.50	1.75	1.00	1.50	0.6
	250	2.25	1.75	3.00	2.00	2.00	1.50	1.67	1.00
10	150	2.00	1.75	2.50	2.00	1.75	1.50	1.67	1.00
	250	3.00	2.00	3.67	2.50	2.50	2.00	1.75	1.50
12	150	2.50	2.00	3.00	2.50	2.25	1.75	1.75	1.25
	250	3.67	2.50	4.00	3.00	3.00	2.33	2.00	1.75
14	150	3.00	2.33	4.00	2.50	2.75	2.00	2.00	1.50
	250	4.00	3.00	5.00	3.50	3.75	2.67	2.50	2.00
16	150	3.75	2.67	5.00	3.00	3.00	2.50	2.25	1.75
	250	5.00	3.25	6.00	3.50	4.00	3.00	3.25	2.00
18	150	4.00	3.00	5.50	3.25	3.67	2.50	2.50	2.00
	250	6.00	3.33	7.00	4.00	5.00	3.25	3.50	2.50
20	150	5.00	3.00	6.00	3.50	4.00	2.75	3.00	2.0
	250	6.50	4.00	8.00	4.50	6.00	3.25	4.00	2.50
24	150	6.00	3.33	7.00	4.25	5.00	3.25	3.67	2.5
	250	8.00	4.50	9.00	5.50	6.50	4.00	5.00	3.00


THRUST BLOCK DETAIL

Town of Canandaigua Site Design & Develoment Criteria

APPENDIX: U-1 DATE: JUNE 2000

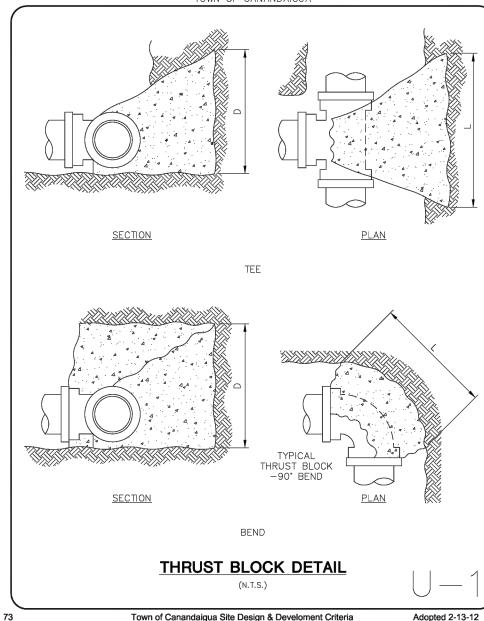

Town of Canandaigua Site Design & Develoment Criteria APPENDIX: T DATE: JUNE 2000 TOWN OF CANANDAIGUA

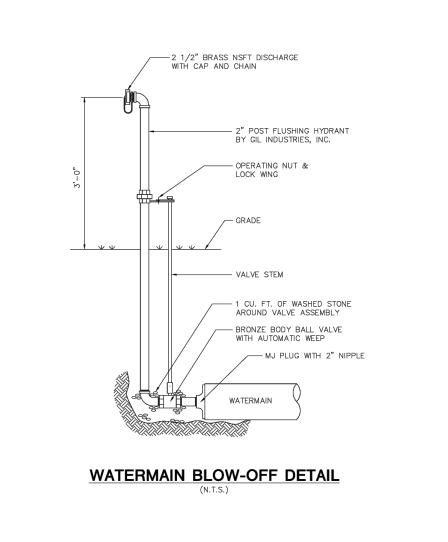

Town of Canandaigua Site Design & Develoment Criteria

*MARATHON* ENGINEERING


> 39 CASCADE DRIVE ROCHESTER, NY 14614 PHONE 585-458-7770 www.marathoneng.com

JOB NO: 0551-16 SCALE: AS SHOWN DRAWN: RJT DESIGNED: RPB DATE: 7/15/16 REVISIONS DATE BY REVISION COPYRIGHT©2016 MARATHON ENG.

**DRAWING TITLE:** CONSTRUCTION **DETAILS** 

ROBERT P. BRINGLEY

SHEET No: 0551-16 JOB No: DRAWING No:

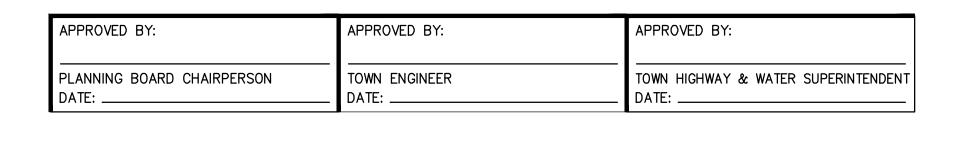

VALVE BOX ──►

GATE VALVE -

2. VALVE SHALL NOT SUPPORT VALVE BOX.

3. ALL BODY AND BONNET BOLTS SHALL BE STAINLESS STEEL.

4. ALL VALVES SHALL BE OPEN LEFT EXCEPT VALVES 12" AND SMALLER

INSTALLED IN THE TOWN OF WEBSTER (WHICH SHALL BE OPEN RIGHT).

**VALVE** 

NOT TO SCALE

1. VALVE BOX SHALL BE CENTERED ON VALVE AND SET ON COMPACTED BACKFILL.

-SOLID CONCRETE BLOCK

(MIN:4"x8"x16")

TYPE 1 CRUSHED STONE -FOR WIDTH OF TRENCH

AROUND VALVE BOX