

REVISIONS

NO. DESCRIPTION DATE BY

PRC COMMENTS 04/15/19 GFT

APPROVED FOR


CONSTRUCTION

It is a violation of New York State Education Law Article 145 Section 7209 for any person, unless he or she is acting under the direction of a licensed professional engineer or land surveyor, to alter an item in any way. If an item bearing the seal of an engineer or land surveyor is altered, the altering engineer or land surveyor shall affix to the item his or her seal and the notation "altered by" followed by his or her signature and the date of such alteration, and a specific description of the alteration.

# THORNTON >

30 Assembly Drive, Suite 106 Mendon, New York 14506


Consultant Engineers

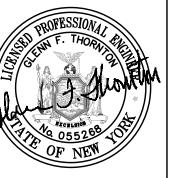

ALL RIGHTS RESERVED: No part of this document may be reproduced, stored in a retrieval system, or transmitted, in any form or by any means electronic, mechanical, photocopying, recording, or otherwise without the prior written authorization of Thornton Engineering LLP.

COPYRIGHT

© Thornton Engineering LLP, 2019

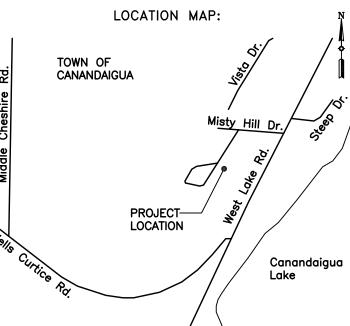

PROJECT NAME:


## Schriefer Residence


4609 Misty Hill Drive Town of Canandaigua Ontario County, NY

DRAWING TITLE:

Site Plan

FILE NAME:	DESIGNED BY:
SITEPLAN.DWG	GFT GFT
DRAWN BY:	CHECKED BY:
HKT	GFT
APPROVED BY:	DATE:
GFT	MARCH 2019
SCALE:	PROJECT NO.:
1" = 20'	19–717
SHEET NO.:	DRAWING NO.:
1 <sub>of</sub> 3	S-1
31	

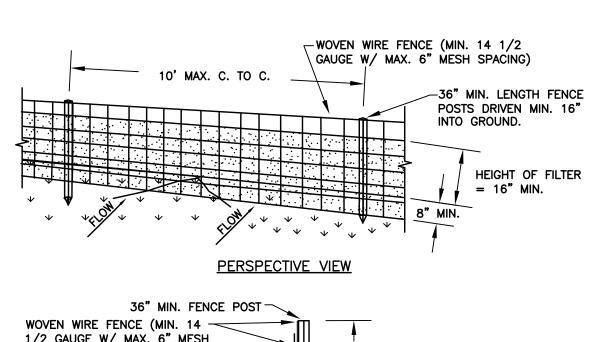


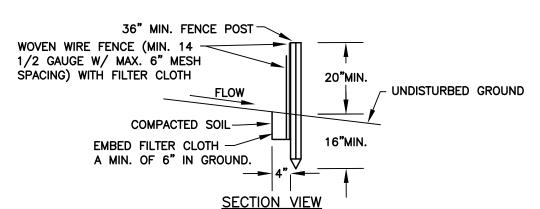

### CONSTRUCTION SPECIFICATIONS


- 1. WOVEN WIRE FENCE TO BE FASTENED SECURELY TO FENCE POSTS WITH WIRE TIES OR STAPLES. POSTS SHALL BE STEEL EITHER "T" OR "U" TYPE OR HARDWOOD.
- 2. FILTER CLOTH TO BE TO BE FASTENED SECURELY TO WOVEN WIRE FENCE WITH TIES SPACED EVERY 24" AT TOP AND MID SECTION. FENCE SHALL BE WOVEN WIRE, 12 1/2 GAUGE, 6" MAXIMUM MESH OPENING
- 3. WHEN TWO SECTIONS OF FILTER CLOTH ADJOIN EACH OTHER THEY SHALL BE OVER-LAPPED BY 6" AND FOLDED. FILTER CLOTH SHALL BE EITHER FILTER X, MIRAFI 100X, STABILINKA T140N, OR APPROVED EQUIVALENT.
- 4. PREFABRICATED UNITS SHALL BE GEOFAB, ENVIROFENCE, OR APPROVED EQUIVALENT.
- 5. MAINTENANCE SHALL BE PERFORMED AS NEEDED AND MATERIAL REMOVED WHEN "BULGES" DEVELOP IN THE SILT FENCE.

SILT FENCE NOT TO SCALE

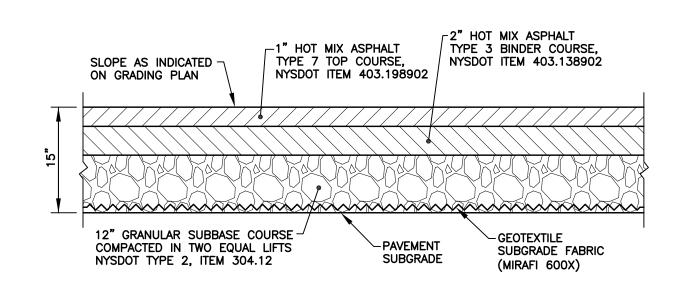


- 1. PAVEMENT SUBGRADE AREAS SHALL BE COMPACTED TO A DEPTH OF SIX INCHES AND TO A DENSITY OF NOT LESS THAN 95% OF THE MAXIMUM DENSITY AS DETERMINED BY ASTM D-1557.
- 2. EXISTING TOPSOIL (6" MINIMUM THICKNESS) SHALL BE REMOVED FROM ALL PROPOSED PAVEMENT AREAS. AREAS BELOW THE PAVEMENT SUBGRADE SHALL BE FILLED WITH COMPACTED GRANULAR SUBBASE COURSE.

### **ASPHALT PAVEMENT** NOT TO SCALE

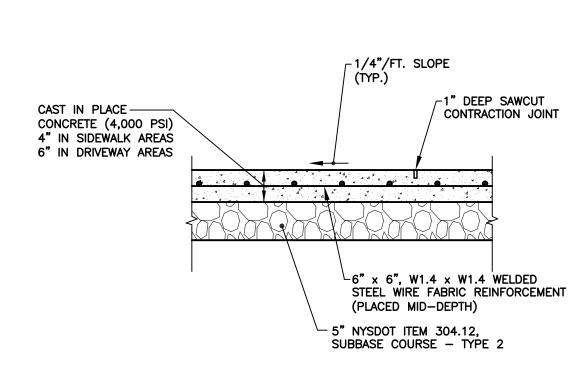

JOINTS (TOOLED OR 1 INCH SAWCUT) SHALL BE PROVIDED TO PROVIDE SQUARE SLABS (5' TO 6' WIDE).

CONCRETE SIDEWALK/DRIVEWAY NOT TO SCALE

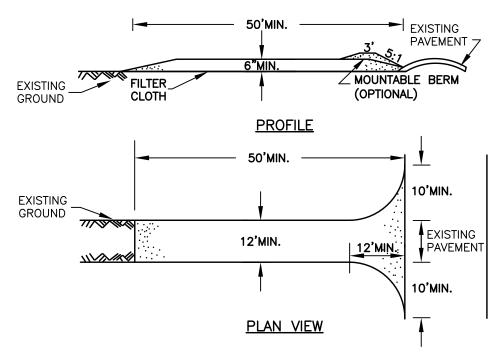

### CONSTRUCTION SPECIFICATIONS

- 1. STONE SIZE USE 2" STONE, OR RECLAIMED OR RECYCLED CONCRETE EQUIVALENT.
- 2. LENGTH NOT LESS THAN 50' (EXCEPT ON A SINGLE RESIDENCE LOT WHERE A 30' MINIMUM LENGTH WOULD APPLY).
- 3. THICKNESS NOT LESS THAN 6".
- 4. WIDTH 12' MINIMUM, BUT NOT LESS THAN THE FULL WIDTH AT POINTS WHERE INGRESS OR EGRESS OCCURS. 24' IF SINGLE ENTRANCE TO SITE.
- 5. FILTER CLOTH WILL BE PLACED OVER THE ENTIRE AREA PRIOR TO PLACING OF STONE.
- 6. SURFACE WATER ALL SURFACE WATER FLOWING OR DIVERTED TOWARD CONSTRUCTION ENTRANCES SHALL BE PIPED ACROSS THE ENTRANCE. IF PIPING IS IMPRACTICAL, A MOUNTABLE BERM WITH 5:1 SLOPES WILL BE PERMITTED.
- 7. MAINTENANCE THE ENTRANCE SHALL BE MAINTAINED IN A CONDITION WHICH WILL PREVENT TRACKING OR FLOWING OF SEDIMENT ONTO PUBLIC RIGHTS-OF-WAY, ALL SEDIMENT SPILLED, DROPPED, WASHED OR TRACTED ONTO PUBLIC RIGHTS-OF-WAY MUST BE REMOVED IMMEDIATELY.
- 8. WHEN WASHING IS REQUIRED, IT SHALL BE DONE ON AN AREA STABILIZED WITH STONE AND WHICH DRAINS INTO AN APPROVED SEDIMENT TRAPPING DEVICE.
- 9. PERIODIC INSPECTION AND NEEDED MAINTENANCE SHALL BE PROVIDED AFTER EACH

### STABILIZED CONSTRUCTION ENTRANCE NOT TO SCALE

FRAME AND GRATE RATED -

LOADING, ELEV. VARIES FROM

1'-6"

2. PROVIDE 1/2" COMPRESSIBLE FILLER BOARD WITH JOINT SEALANT.

3. GRATES SHALL BE SECURELY FASTENED TO THE FRAME

SEE NOTE

5'-6"

SLOPE

CLASS A

CONCRETE

-6"  $\times$  6", W2.9  $\times$  W2.9

WELDED STEEL WIRE

REINFORCEMENT

(4,000 PSI)

1'-6"

SECTION

1. THE FINISHED SURFACE OF CONCRETE SHALL BE 1/8" HIGHER THAN THE TOP OF THE CHANNEL EDGE.

TRENCH DRAIN

NOT TO SCALE

-SLOPED TRENCH

DRAIN CHANNEL

FOR HS-20-44 HIGHWAY

893.90 AT NORTH END TO 893.60 AT SOUTH END

SLOPE PER PLAN

Alman .


GEOTEXTILE SUBGRADE

1" HMA TOP-

12" SUBBASE -COURSE

COURSE

2" HMA BINDER-COURSE

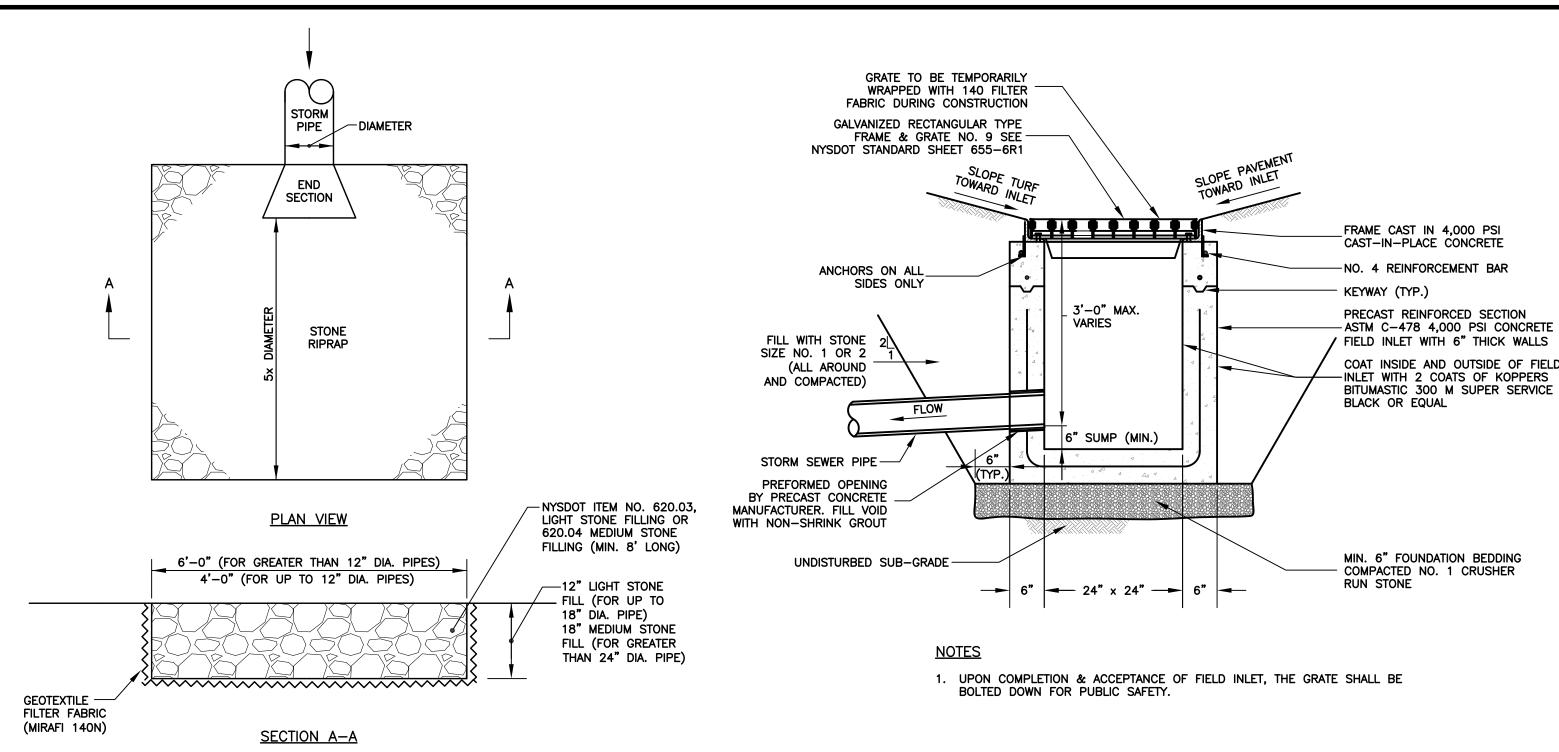

# STONE RIPRAP OUTLET PROTECTION


# NOT TO SCALE

-6" CONCRETE SIDEWALK/ DRIVEWAY

- 9" SUBBASE COURSE

R.O.W. OR ---EASEMENT LINE TEMPORARY MARKER PER IND. CODE 53 FINISHED GRADE -(TOP PAINTED BLUE) CURB BOX WITH ---. COPPER SERVICES SHALL BE ENCASED ALL STAINLESS STEEL ROD AROUND WITH SELECT EARTH SERVICES SHALL BE TYPE K COPPER FROM THE MAIN TO THE CURB STOP. 2. PLASTIC SERVICES ALLOWED FROM THE CURB STOP TO THE STRUCTURE. COPPER TRACER WIRE SHOULD BE PROVIDED AS SHOWN.  $\sim$ CORPORATION FTRACING WIRE 10 TRACING WIRE TO BE — ATTACHED TO CURB STOP FOR POSITIVE GAUGE (FOR ALL PLASTIC SERVICES)

### TYPICAL WATER SERVICE (N.T.S.)

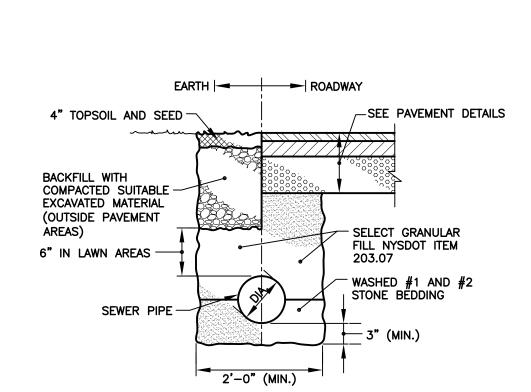


-WATERMAIN

-DOUBLE STRAP BRONZE

SADDLE FOR PVC MAIN

STORM SEWER INSTALLATION NOT TO SCALE

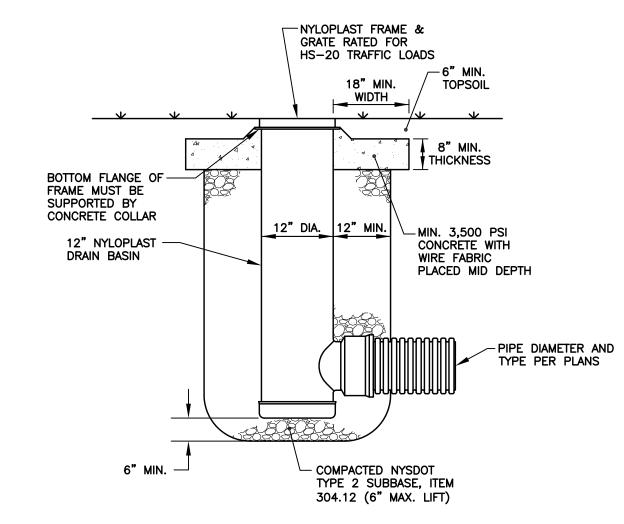

DRAINAGE INLET

CONCRETE BLOCK

NOT TO SCALE

YARD INLET NOT TO SCALE


# **REVISIONS** DESCRIPTION DATE BY PRC COMMENTS 04/15/19 GFT

is a violation of New York State Education Law Article 145 Section 7209 for any person, unless he or she is acting under the direction of a licensed professional engineer or land surveyor, to alter an item in any way. If n item bearing the seal of an engineer or land surveyor is altered, the altering engineer or land surveyor shall affix to the item his or her seal and the notation "altered by" followed by his or her signature and the date of such alteration, and a specific description of the alteration.

# THORNTON

30 Assembly Drive, Suite 106 Mendon, New York 14506


Consultant Engineers

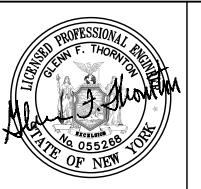

ALL RIGHTS RESERVED: No part of this document may be reproduced, stored in a retrieval system, or transmitted, in any form or by any means electronic, mechanical, photocopying, Thornton Engineering LLP. recording, or otherwise without the prior written authorization of

© Thornton Engineering LLP, 2019

LOCATION MAP:

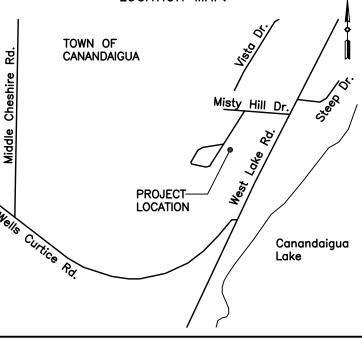

# Schriefer Residence

PROJECT NAME:

4609 Misty Hill Drive Town of Canandaigua Ontario County, NY

DRAWING TITLE:

Miscellaneous Details


FILE NAME:	DESIGNED BY:
DETAILS.DWG	GFT
DRAWN BY:	CHECKED BY:
HKT	GFT
APPROVED BY:	DATE:
GFT	MARCH 2019
SCALE:	PROJECT NO.:
NOT TO SCALE	19–717
SHEET NO.:	DRAWING NO.:
_2_ of _3_	D-1
	1

SOIL INVESTIGATION RESULTS performed by Glenn Thornton, P.E. Soil Percolation Tests 22" Deep (performed on XXX)

Deep Hole Test (performed on XXX)

### WASTEWATER TREATMENT SYSTEM NOTES

- Sewage disposal systems shall be constructed in accordance with the standards for individual sewage disposal systems of the New York State Department of Health.
- 2. Contractor to maintain a minimum of 10' setback of system from the property line for
- 3. Any deviation from the proposed plans will require new submission of plans to the appropriate agencies.
- 4. The Onsite Wastewater Treatment System has been designed to accept daily design flows of 330 gallons from a 3 bedroom dwelling or 440 gallons from a 4 bedroom dwelling. The daily design flows do not include additional capacity required for use of garbage
- 5. Non—wastewater flows (e.g. sumps, roof drains, footer drains, etc.) should not be added
- 6. The system has been designed for a 3 bedroom or 4 bedroom dwelling with low flow

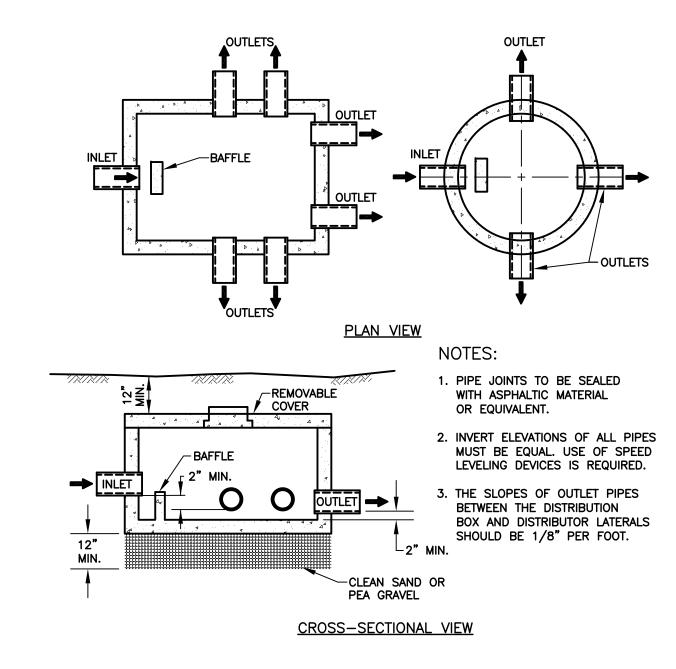


**DISTRIBUTION BOX** NOT TO SCALE

WASTEWATE SYSTEM I		
	3 BEDROOM HOUSE	4 BEDROOM HOUSE
DESIGN FLOW* MIN. SEPTIC TANK CAPACITY TYPE OF SYSTEM** PERCOLATION RATE REQ'D. ABSORPTION TRENCH DISTRIBUTION LINES	330 GPD 1000 GAL. CONVENTIONAL X MIN. X L.F. X @ X L.F.	440 GPD 1250 GAL. CONVENTIONAL C MIN. X L.F. X @ X L.F.
DESIGN ELEVATIONS*** MIN. INVERT AT HOUSE SEPTIC TANK IN SEPTIC TANK OUT DISTRIBUTION BOX IN DISTRIBUTION BOX OUT LEACH LINE 1 BEGIN LEACH LINE 1 END LEACH LINE 2 BEGIN LEACH LINE 3 BEGIN LEACH LINE 3 BEGIN LEACH LINE 4 BEGIN LEACH LINE 4 BEGIN LEACH LINE 5 BEGIN LEACH LINE 6 BEGIN LEACH LINE 7 BEGIN		

\* DESIGN FLOWS DO NOT INCLUDE ADDITIONAL REQUIRED CAPACITY FOR


USE OF GARBAGE GRINDERS OR JACUZZI TUBS.


- \*\* TRENCHES SHALL BE 18" TO 20" DEEP.
- \*\*\* SYSTEM DESIGN ELEVATIONS ARE BASED UPON INTERPOLATED GROUND ELEVATIONS BETWEEN SURVEYED CONTOURS.

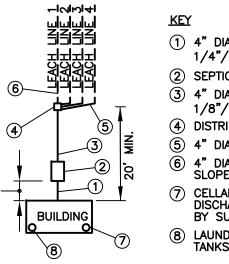


- (1) 4" DIA. SCH 40 CIP WITH TIGHT JOINTS, 1/4"/FT. SLOPE (MIN.) (2) SEPTIC TANK
- 3 4" DIA. SCH 40 PVC WITH TIGHT JOINTS, 1/8"/FT. SLOPE (MIN.) (4) DISTRIBUTION BOX
- 5 4" DIA. PVC, 1/8"/FT. SLOPE (MIN.) ) 4" DIA. PVC, PERFORATED, 1/16"/FT. SLOPE (MAX.), 1/32"/FT. SLOPE (MIN.) (7) CELLAR INFILTRATION WATER TO BE
- DISCHARGED TO SURFACE DRAINAGE SWALE BY SUMP PUMP WITH IN LINE CHECK VALVE 8 LAUNDRY WASTE TO BE PUMPED TO SEPTIC TANKS. INSTALL CHECK VALVE ON DISCHARGE LINE.

SEPTIC SYSTEM SCHEMATIC NOT TO SCALE

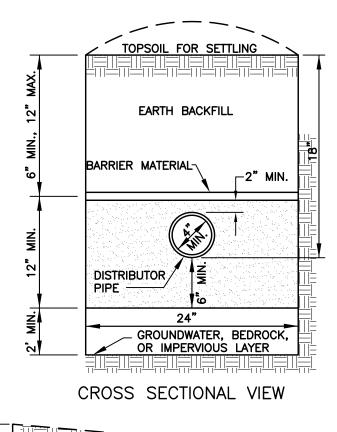

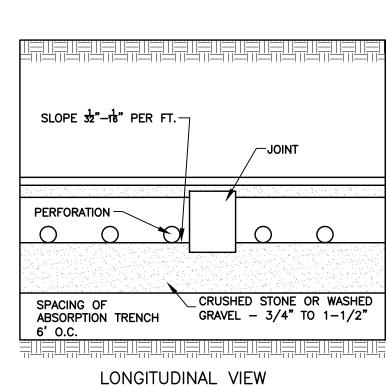

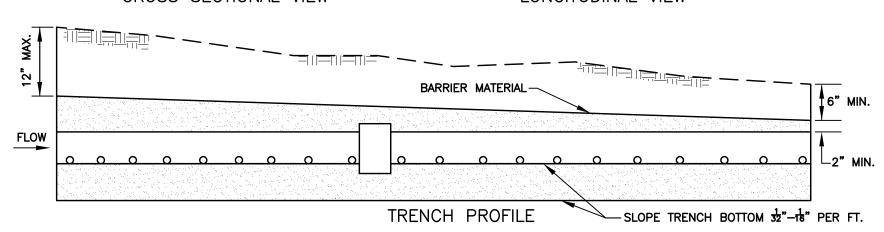


### <u>NOTES</u>

- 1. DO NOT INSTALL TRENCHES IN WET SOIL.
- 2. INSTALL TRENCHES PARALLEL TO CONTOURS.
- 3. INSTALL TRENCHES AS SHALLOW AS POSSIBLE WHICH MEET ABOVE NOTED MINIMUM DEPTHS.
- 4. RAKE SIDES AND BOTTOM OF TRENCH PRIOR TO PLACING GRAVEL.
- 5. ENDS OF ALL DISTRIBUTOR PIPES MUST BE CAPPED.

4 4 4 4 INLET INVERT 3" ABOVE OUTLET INVERT INLET SECTION VIEW L 3" MIN. BED OF SAND OR PEA GRAVEL 6" MIN. WALL THICKNESS FOR POURED IN PLACE CONCRETE - SILICONE SEAL PLAN VIEW

- 1. Compartments shall be connected by a 4 inch vertical slot at least 18 inches in width, a 6 inch elbow, two 4 inch elbows or four 4 inch diameter holes located
- Septic tanks shall be two compartment (dual chamber) construction such as Lakelands Concrete Model No. ST1000D (1000 gallons) or ST1250D (1250 gallons) with 5,000 psi concrete strength or approved equal.

SEPTIC TANK NOT TO SCALE

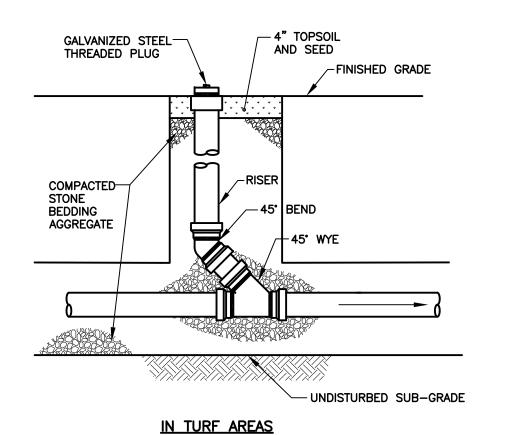

SANITARY CLEANOUT NOT TO SCALE


	REVISIONS		
NO.	DESCRIPTION	DATE	BY
$\triangle$	PRC COMMENTS	04/15/19	GFT
	~ ADDROVED	FO	KL
$\mu$	O APPROVED		
	CONSTRUCTI		

It is a violation of New York State Education Law Article 145 Section 7209 for any person, unless he or she is acting under the direction of a licensed professional engineer or land surveyor, to alter an item in any way. If an item bearing the seal of an engineer or land surveyor is altered, the altering engineer or land surveyor shall affix to the item his or her seal and the notation "altered by" followed by his or her signature and the date of such alteration, and a specific description of the alteration.

# THORNTON

30 Assembly Drive, Suite 106 Mendon, New York 14506


Consultant Engineers

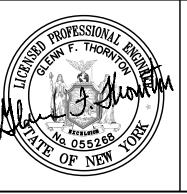

ALL RIGHTS RESERVED: No part of this document may be reproduced, stored in a retrieval system, or transmitted, in reproduced, stored in a retrieval system, or transmitted, in any form or by any means electronic, mechanical, photocopying, recording, or otherwise without the prior written authorization of Thornton Engineering LLP.

COPYRIGHT

© Thornton Engineering LLP, 2019

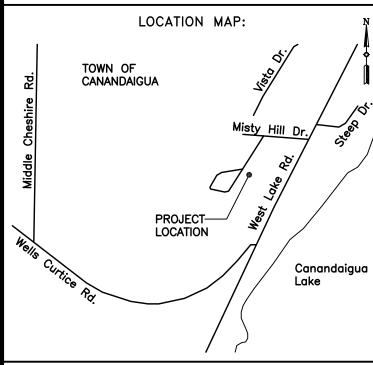

Schriefer Residence

PROJECT NAME:


4609 Misty Hill Drive Town of Canandaigua Ontario County, NY

DRAWING TITLE:

Wastewater Treatment System **Details** 

FILE NAME:	DESIGNED BY:
DETAILS.DWG	GFT
DRAWN BY:	CHECKED BY:
HKT	GFT
APPROVED BY:	DATE:
GFT	MARCH 2019
<u> </u>	
SCALE:	PROJECT NO.:
NOT TO SCALE	19-717
NOT TO SCALE	19-717
SHEET NO.:	DRAWING NO.:
0 0	Б 0
$3_{\rm of}$ $3$	D-2
6	

ABSORPTION TRENCH NOT TO SCALE

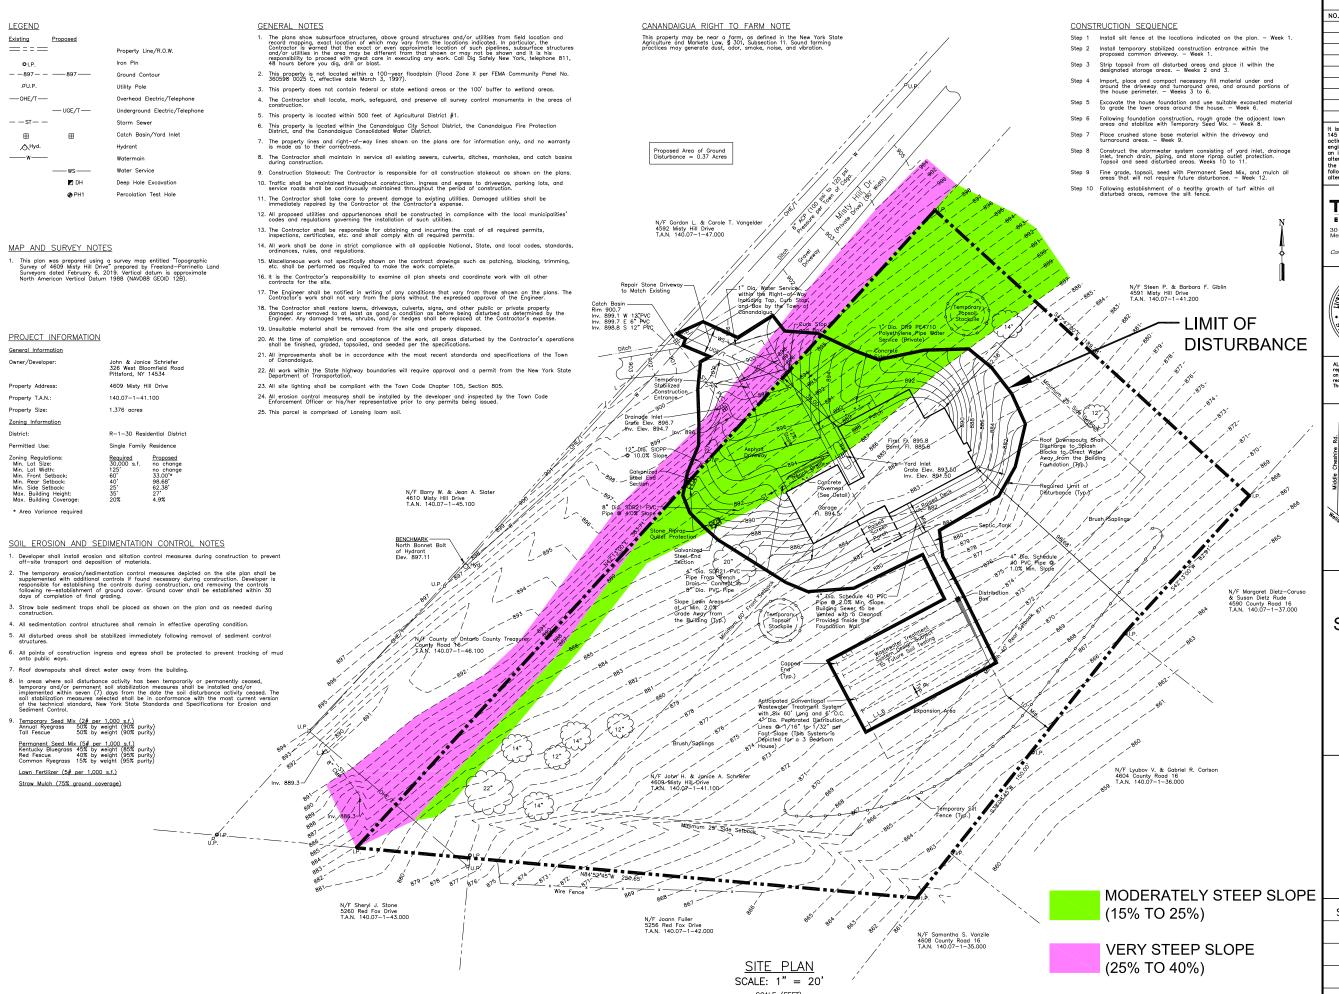

NO. DESCRIPTION DATE BY

It is a violation of New York State Education Law Article 145 Section 7209 for any person, unless he or she is acting under the direction of a licensed professional engineer or land surveyor, to alter an item in any way. If an item bearing the seal of an engineer or land surveyor is altered, the altering engineer or land surveyor shall offix to that the thing of the seal of the control of the

### THORNTON


30 Assembly Drive, Suite 106 Mendon, New York 14506

ultant Engineers



ALL RIGHTS RESERVED: No part of this document may be reproduced, stored in a retrieval system, or transmitted, in may form or by any mense selectronic, mechanical, photocopying, recording, or otherwise sithout the prior written authorization of fhornton Engineering LIP. COPPRIGHT

Thornton Engineering LLP, 2019

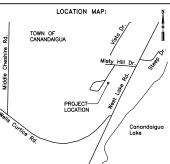

PROJECT NAME:

### Schriefer Residence

4609 Misty Hill Drive Town of Canandaigua Ontario County, NY

DRAWING TITLE:

### STEEP SLOPE ANALYSIS

FILE NAME:	DESIGNED BY:
SLOPES.DWG	GFT
DRAWN BY:	CHECKED BY:
HKT	GFT
APPROVED BY:	DATE:
GFT	MARCH 2019
SCALE:	PROJECT NO.:
1" = 20'	19-717
SHEET NO.:	DRAWING NO.:
OF	FIGURE 1