
PRELIMINARY SITE PLANS for PARKSIDE DRIVE APARTMENTS

PARKSIDE DRIVE

SITUATE IN:

TOWN OF CANANDAIGUA - ONTARIO COUNTY - STATE OF NEW YORK



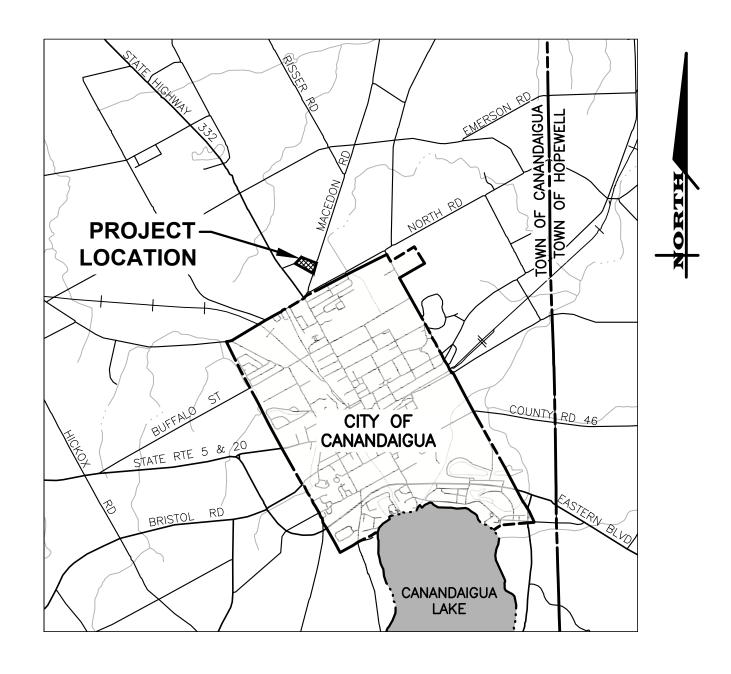

LOCATION MAP

NOT TO SCALE

3 9 CASCADE DRIVE ROCHESTER, NY 14614 5 8 5 - 4 5 8 - 7 7 7 0 ITHACA LOCATION 840 HANSHAW RD, STE 12 ITHACA, NY 14850 6 0 7 - 2 4 1 - 2 9 1 7

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No.	DWG. No.	DESCRIPTION	
01	COVER	COVER	
02	C0.1	NOTES AND SPECIFICATIONS	
03	V1.0	TOPOGRAPHIC SURVEY	
04	C2.0	LAYOUT PLAN	
05	C3.0	UTILITY PLAN	
06	C4.0	GRADING & EROSION CONTROL PLAN	
07	C5.0	LIGHTING PLAN	
08	C6.0	CONSTRUCTION DETAILS	
09	C6.1	CONSTRUCTION DETAILS	
10	C6.2	CONSTRUCTION DETAILS	

REFERENCE SHEETS: L-301 CONCEPT PLANTING PLAN

GENERAL

- 1. APPLICABILITY THE NOTES AND INFORMATION PROVIDED ON THIS SHEET ARE APPLICABLE TO ALL "C" SERIES DRAWINGS. THE "C" SERIES DRAWINGS COVER SITE RELATED IMPROVEMENTS OUTSIDE THE BUILDING ENVELOPE. THE BUILDING ENVELOPE INCLUDES ALL AREA WITHIN 5' OUTSIDE OF THE BUILDING'S EXTERIOR WALL.
- 2. MAPPING THE EXISTING UNDERGROUND UTILITIES WERE PLOTTED BASED ON RECORD MAPPING SUPPLIED BY OTHERS. THE ENGINEER MAKES NO WARRANTY AS TO THE LOCATION, SIZE, TYPE, ELEVATION, AND/OR NUMBER OF EXISTING UTILITIES. THE CONTRACTOR SHALL BE RESPONSIBLE FOR DETERMINING THE HORIZONTAL AND VERTICAL LOCATION OF UTILITIES IN THE VICINITY OF THE NEW INFRASTRUCTURE.
- UTILITY STAKEOUT THE CONTRACTOR SHALL NOTIFY DIG SAFELY NEW YORK (1-800-962-7962) FOR A UTILITY STAKEOUT 48 HOURS IN ADVANCE OF COMMENCING WORK. STAKEOUT OF PRIVATE UTILITIES SHALL BE COORDINATED WITH THE OWNER.
- 4. PROPERTY PROTECTION THE CONTRACTOR IS RESPONSIBLE FOR DAMAGE TO EXISTING PAVEMENT, CURBS, WALKS, LAWNS, TREES, ETC. CAUSED BY THEIR CONSTRUCTION OPERATIONS. ALL DAMAGE SHALL BE REPAIRED OR REPLACED BY THE CONTRACTOR TO THE OWNER'S SATISFACTION AT NO ADDITIONAL EXPENSE.
- 5. ACCESS THE CONTRACTOR SHALL PROVIDE SATISFACTORY VEHICULAR ACCESS TO ALL ADJOINING PROPERTIES, PRIVATE ROADWAYS, PARKING FACILITIES, AND PUBLIC STREETS DURING CONSTRUCTION.
- SITE SAFETY PRIOR TO AND THROUGHOUT CONSTRUCTION. THE CONTRACTOR SHALL POST SIGNAGE IN CONFORMANCE WITH THE REQUIREMENTS OF THE LOCAL MUNICIPALITY AND OCCUPATIONAL HEALTH AND SAFETY ACT (OHSA). JOB SAFETY AND MAINTENANCE AND PROTECTION OF TRAFFIC IS THE RESPONSIBILITY OF THE CONTRACTOR.
- **EXCAVATIONS** ALL EXCAVATIONS SHALL BE BACKFILLED/BARRICADED TO THE SATISFACTION OF THE OWNER'S REPRESENTATIVE AT THE CONCLUSION OF EACH WORKING DAY.
- 8. MAINTENANCE PUBLIC STREETS, PRIVATE DRIVES AND PARKING FACILITIES SHALL BE KEPT FREE OF FOREIGN MATERIALS. ALL AREAS SHALL BE SWEPT CLEAN AT THE END OF EACH WORKING DAY AND/OR AS DIRECTED BY THE OWNER'S ON-SITE REPRESENTATIVE.
- 9. CONSTRUCTION STORAGE STORAGE OF EQUIPMENT AND MATERIALS SHALL BE WITHIN A SPECIFIED AND SECURED AREA AS DETERMINED IN CONTRACT DOCUMENTS OR AS SPECIFIED BY THE OWNER'S ON-SITE
- 10. PERMIT(S) PRIOR TO CONSTRUCTION, THE CONTRACTOR SHALL OBTAIN THE NECESSARY PERMITS FROM THE APPLICABLE MUNICIPALITY OR AGENCY. THE CONTRACTOR IS RESPONSIBLE FOR ALL BONDS AND INSURANCES AND THE OWNER IS RESPONSIBLE FOR PERMIT FEES UNLESS OTHERWISE STATED IN THE OWNER/ CONTRACTOR AGREEMENT
- 11. INTERIM CONDITIONS THE CONTRACTOR IS RESPONSIBLE TO MAINTAIN POSITIVE DRAINAGE AWAY FROM BUILDINGS AND WITHIN PROJECT AREA TO A STABILIZED OUTLET THROUGHOUT THE CONSTRUCTION PERIOD. THIS MAY REQUIRE INTERIM GRADING, SHIMMING OF PAVEMENT ETC. THAT IS NOT SPECIFICALLY SHOWN ON THE PLANS AND SHALL BE THE RESPONSIBILITY OF THE CONTRACTOR.

CONSTRUCTION

- STAKEOUT THE CONSTRUCTION STAKEOUT SHALL BE PERFORMED BY A LICENSED LAND SURVEYOR USING CONTROL PROVIDED ON THE "LAYOUT PLAN". THE BUILDING FOOTPRINT(S), DATED 7/25/22, WERE PROVIDED BY SWBR ARCHITECTS. DISCREPANCIES WITH BUILDING(S), CONTROL POINTS, AND/ OR TIE DIMENSIONS SHALL BE REPORTED TO THE DESIGN ENGINEER (PRIOR TO THE INSTALLATION OF IMPROVEMENTS) FOR COORDINATION AND CLARIFICATION.
- **BOUNDARY** BOUNDARY INFORMATION WAS PREPARED BY MAGDE LAND SURVEYING DATED AND IS SHOWN FOR GRAPHICAL REPRESENTATION ONLY.
- LAYOUT DIMENSIONS SHOWN, WHERE APPLICABLE, SHALL BE FROM THE FACE OF CURB UNLESS SPECIFICALLY CALLED OUT OTHERWISE.
- **DEMOLITION** CLEARING AND GRUBBING SHALL BE LIMITED TO THE SITE BOUNDARIES OR WITHIN THE "WORK LIMIT LINE" AS DEFINED ON THE PLAN. TREES AND OBJECTS DESIGNATED FOR REMOVAL SHALL BE COORDINATED AND FIELD VERIFIED WITH PROJECT ON-SITE REPRESENTATIVE. ALL MATERIALS SHALL BE LEGALLY DISPOSED OF OFF-SITE OR RETURNED TO OWNER AS DIRECTED BY CONTRACT DOCUMENTS. ALL ITEMS NOT SPECIFICALLY CALLED OUT TO BE
- **COORDINATION** THE CONTRACTOR SHALL COORDINATE INSTALLATION OF UTILITY WORK WITH OTHER SITE UTILITIES (I.E. GAS, ELECTRIC, LIGHTING, COMMUNICATIONS) TO AVOID POTENTIAL INSTALLATION CONFLICTS.
- STAGING AS DEFINED BY THE CONTRACT DOCUMENTS THE CONTRACTOR SHALL CONSTRUCT A SECURE STAGING AREA FOR STORAGE OF EQUIPMENT, MATERIALS, EMPLOYEE PARKING AND OFFICE SPACE. IF THE AREA/METHOD IS NOT SPECIFICALLY DEFINED ON THE DOCUMENTS THEN IT SHALL BE COORDINATED WITH THE OWNER'S ON-SITE
- **CLOSE-OUT** THE CONTRACTOR'S WORK SCOPE INCLUDES BUT IS NOT LIMITED TO THE FOLLOWING AT PROJECT
- CLOSE-OUT TO THE SATISFACTION OF OWNER'S ON-SITE REPRESENTATIVE: REMOVAL OF ANY CONSTRUCTION DEBRIS.
- CLEANING PAVEMENT AND WALKWAY SURFACES.
- RESTORATION OF ALL DISTURBED GRASS AND LANDSCAPED AREAS. • PROVIDING BONDS, GUARANTEES, CERTIFICATIONS, ETC. AS REQUIRED BY CONTRACT DOCUMENTS.
- PROVIDING REDLINES FOR RECORD DRAWING. COMPLETION OF FINAL PUNCH LIST ITEMS.

UTILITIES

1. SANITARY

- LATERALS PIPING SHALL BE POLYVINYL CHLORIDE (PVC) WITH ENDS SUITABLE FOR ELASTOMERIC GASKET JOINTS, AND A MINIMUM WALL THICKNESS OF SDR-21. PIPING AND FITTINGS SHALL MEET ASTM D-2241. JOINTING MATERIALS - SHALL BE BELL-AND-SPIGOT WITH INTEGRAL PUSH ON TYPE ELASTOMERIC GASKET
- JOINTS, GASKET MATERIAL TO BE NEOPRENE MEETING ASTM D-3212. • MANHOLES - SHALL BE PRECAST CONCRETE WITH NEOPRENE GASKETS MEETING ASTM C-478 & ASTM C-443.
- 1.2 INFILTRATION/ EXFILTRATION MAXIMUM ALLOWABLE INFILTRATION OR EXFILTRATION SHALL NOT EXCEED 100 GALLONS PER INCH DIAMETER PER MILE OF PIPE PER DAY FOR THE SANITARY SEWER. IF AN AIR TEST IS USED, THE TEST AS A MINIMUM SHALL CONFORM TO THE PROCEDURE DESCRIBED IN ASTM F1417 ENTITLED STANDARD PRACTICE FOR INSTALLATION ACCEPTANCE OF PLASTIC NON-PRESSURE SEWER LINES USING LOW-PRESSURE AIR. SANITARY MANHOLES SHALL BE VISUALLY INSPECTED AND TESTED FOR LEAKAGE BY EX FILTRATION OR VACUUM. VACUUM TESTING OF MANHOLES SHALL COMPLY WITH THE METHOD OUTLINED IN THE NEW YORK STATE DEPARTMENT OF ENVIRONMENTAL CONSERVATION TECHNICAL INFORMATION PAMPHLET (TIP) NO. 15 (REVISED).
- 1.3 FLOOR DRAINS FLOOR DRAINS, IF CONSTRUCTED IN THE PROJECT. MUST BE CONNECTED TO THE SANITARY SEWER. **NOTE:** FLOOR DRAINS DO NOT INCLUDE FOUNDATION OR FOOTER DRAINS INSTALLED TO INTERCEPT UNCONTAMINATED GROUND WATER. ALL DISCHARGES FROM THE FLOOR DRAINS TO THE SANITARY SEWER MUST COMPLY WITH THE EFFLUENT LIMITS OF THE LOCAL SEWER USE LAW.
- **1.4 TESTING** DEFLECTION TESTS SHALL BE PERFORMED ON ALL FLEXIBLE PIPE. THE TEST SHALL BE CONDUCTED AFTER THE FINAL BACKFILL HAS BEEN IN PLACE AT LEAST 30 DAYS. NO PIPE SHALL EXCEED A DEFLECTION OF 5%. IF THE DEFLECTION TEST IS TO BE RUN USING A RIGID BALL OR MANDREL. IT SHALL HAVE A DIAMETER EQUAL TO 95% OF THE INSIDE DIAMETER OF THE PIPE. THE TEST SHALL BE PERFORMED WITHOUT MECHANICAL PULLING DEVICES.
- 1.5 SEPARATION MINIMUM VERTICAL SEPARATION BETWEEN WATER MAINS AND SEWER LINES SHALL BE 18 INCHES MEASURED FROM THE OUTSIDE OF THE PIPES AT THE POINT OF CROSSING. ONE FULL STANDARD LAYING LENGTH OF WATER MAIN SHALL BE CENTERED UNDER OR OVER THE SEWER SO THAT BOTH JOINTS WILL BE AS FAR FROM THE SEWER AS POSSIBLE. IN ADDITION. WHEN THE WATER MAIN PASSES UNDER A SEWER, ADEQUATE STRUCTURAL SUPPORT (COMPACTED SELECTED FILL) SHALL BE PROVIDED FOR THE SEWER TO PREVENT EXCESSIVE DEFLECTION OF JOINTS AND SETTLING OF THE SEWER ON THE WATER MAIN. MINIMUM HORIZONTAL SEPARATION BETWEEN PARALLEL WATER MAINS AND SEWER PIPES (INCLUDING MANHOLES AND VAULTS) SHALL BE 10 FEET MEASURED FROM THE OUTSIDE OF THE PIPES. MANHOLES OR VAULTS.

UTILITIES (CONT.)

- 2.1 REGULATIONS STORM SEWERS AND APPURTENANCES SHALL BE CONSTRUCTED IN CONFORMANCE WITH THE LATEST REGULATIONS OF THE MUNICIPALITY.
- 2.2 MATERIALS THE CONTRACTOR MAY USE THE FOLLOWING PIPE MATERIAL FOR THE MAIN SEWER AS ALLOWED BY THE MUNICIPALITY, PROVIDING THAT THE ROUGHNESS COEFFICIENT ("N" FACTOR) IS 0.013 OR
- REINFORCED CONCRETE PIPE (RCP), CLASS III HIGH DENSITY CORRUGATED POLYETHYLENE PIPE (PE), AASHTO M-29, TYPE S, ASTM D-3350.

2.3 ROOF DRAINAGE - ALL ROOF DRAINAGE SHALL BE COLLECTED AND PIPED TO THE STORM SEWER SYSTEM

2.4 TESTING - UPON COMPLETION OF SYSTEM INSTALLATION, THE MAIN SEWER SYSTEM AND LEADS TO STRUCTURES SHALL BE FLUSHED AND LAMPED TO THE SATISFACTION OF THE OWNERS ON-SITE REPRESENTATIVE.

3. PUBLIC WATER

- 3.1 SPECIFICATIONS WATER MAINS AND APPURTENANCES TO BE CONSTRUCTED IN ACCORDANCE WITH THE REGULATIONS AND SPECIFICATIONS OF THE WATER AUTHORITY.
- WATER MAIN(S) SHALL BE PVC AWWA C900 DR-18 WATERMAIN.
- WATER SERVICES(S) SHALL BE MASTER METERED AT THE BACKFLOW ROOM WITHIN THE BUILDING AS REQUIRED BY THE FARMINGTON WATER & SEWER DEPARTMENT. - ALL GATE VALVES SHALL HAVE STAINLESS STEEL BODY AND BONNET BOLTS.

- PRESSURE WATER MAINS TO BE PRESSURE TESTED IN ACCORDANCE WITH THE LATEST WATER DEPARTMENT SPECIFICATIONS. A WATER AUTHORITY REPRESENTATIVE MUST WITNESS THIS TEST.
- HEALTH SAMPLE THE WATER MAIN SHALL BE DISINFECTED EQUAL TO AWWA STANDARD SPECIFICATIONS, DESIGNATION C-651, BY USING THE CONTINUOUS FEED METHOD. AFTER FLUSHING AND DISINFECTING THE WATER MAIN WATER SAMPLES SHALL BE COLLECTED FROM THE MAIN BY THE CONTRACTOR TESTED BY AN APPROVED. LABORATORY AND RESULTS PROVIDED BY THE CONTRACTOR TO THE FARMINGTON WATER & SEWER DEPARTMENT TWO SAMPLES ARE REQUIRED AT EACH SAMPLE LOCATION 24 HOURS APART. ONE SAMPLE SHALL INCLUDE HETEROTROPHIC PLATE COUNT. FIRE HYDRANTS ARE NOT ACCEPTABLE SAMPLING POINTS. APPROVAL AND NOTIFICATION BY THE HEALTH DEPARTMENT MUST BE RECEIVED BEFORE THE MAIN IS PLACED IN SERVICE.

3.4 INSTALLATION:

WATER SERVICE LINES SHALL HAVE A MINIMUM OF FIVE FEET OF COVER FROM FINISHED GRADE IN LAWN AREAS AND A MINIMUM OF SIX FEET OF COVER FROM FINISHED GRADE IN PAVED AREAS.

MINIMUM VERTICAL SEPARATION BETWEEN WATER MAIN AND SEWER MAINS SHALL BE 18" MEASURED FROM THE OUTSIDE OF THE PIPES AT THE POINT OF CROSSING. MINIMUM HORIZONTAL SEPARATION BETWEEN WATER MAINS AND SEWER MAINS SHALL BE TEN FEET MEASURED FROM THE OUTSIDE OF THE PIPES. ONE FULL LENGTH OF WATER MAIN SHALL BE CENTERED LINDER OR OVER THE SEWER SO THAT BOTH JOINTS WILL BE AS FAR FROM THE SEWER AS POSSIBLE. WHERE A WATER MAIN CROSSES UNDER A SEWER, ADEQUATE STRUCTURAL SUPPORT (COMPACTED SELECTED FILL) SHALL BE PROVIDED FOR THE SEWERS TO PREVENT EXCESSIVE DEFLECTION OF JOINTS AND SETTLING ON AND BREAKING THE WATER MAINS.

FIRE HYDRANT WEEP HOLES (DRAINS) SHALL BE PLUGGED WHEN GROUND WATER IS ENCOUNTERED WITHIN SEVEN

ALL MECHANICAL JOINT FITTINGS (TEES, BENDS, PLUGS, ETC.) SHALL BE BACKED WITH 2500 PSI CONCRETE THRUST BLOCKS OF APPROPRIATE SIZE TO PROVIDE THRUST RESTRAINT

ABBREVIATIONS							
ABBR.	TERM	ABBR.	TERM				
AC.	ACRE	LS	LUMP SUM				
A.O.B.E.	AS ORDERED BY ENGINEER	LT.	LEFT				
ASPH.	ASPHALT	мв.	MAILBOX				
AZ.	AZIMUTH	M.O.	MIDDLE ORDINATE				
₽	BASELINE	MON.	MONUMENT OR MONTH				
₽ BM	BENCHMARK	MCGS	MONROE COUNTY GEODETIC SURVEY				
Ç CLF	CENTERLINE	м.н.	MANHOLE				
ČLF	CHAIN LINKED FENCE	NEC.	NECESSARY				
C.O.	CLEAN-OUT	N.I.C.	NOT-IN- CONTRACT				
CONC.	CONCRETE	NTS	NOT TO SCALE				
CPP	CORRUGATED POLYETHYLENE PIPE	N/F	NOW OR FORMERLY				
CSP	CORRUGATED STEEL PIPE	PÁV'T.	PAVEMENT				
COV.	COVER	PE	POLYETHYLENE PIPE				
CB	CURB BOX	PPE	PERFORATED POLYETHYLENE PIPE				
CY	CUBIC YARD	PC	POINT OF CURVATURE				
D.	DEGREE OF CURVE	PI	POINT OF INTERSECTION				
DIA.	DIAMETER	PT	POINT OF TANGENCY				
DI	DROP INLET	PVC	POINT OF VERTICAL CURVATURE				
D.I.P.	DUCTILE IRON PIPE	PVI	POINT OF VERTICAL INTERESECTION				
EA.	EACH	PVT	POINT OF VERTICAL TANGENCY				
EIC	ENGINEER IN CHARGE	PP	POWER POLE				
ELEV.	ELEVATION	凡	PROPERTY LINE				
EP	EDGE OF PAVEMENT	R.	RADIUS				
FF	FINISH FLOOR = FINISH FLOOR ELEVATION	RCP	REINFORCED CONCRETE PIPE				
FI	FIELD INLET	RG&E	ROCHESER GAS AND ELECTRIC				
FR.	FRAME	R.O.W.	RIGHT-OF-WAY				
FP	FINISH PAD = GARAGE FLOOR ELEVATION	RT.	RIGHT				
FT.	FEET	RTC	ROCHESTER TELEPHONE COMPANY				
G	GAS MAIN	SA.	SANITARY SEWER				
GAL.	GALLON	ST.	STORM SEWER				
GR.	GRAVEL	STA.	STATION				
G.R.	GUIDE RAIL	STY.	STORY				
HCL	HORIZONTAL CONTROL LINE	SY	SQUARE YARD				
HYD.	HYDRANT	T.	TANGENT DISTANCE				
INV.	INVERT	TGL	THEORETICAL GRADE LINE				
ΙP	IRON PIPE OR IRON PIN	TYP.	TYPICAL				
L.	LENGTH OR LENGTH OF CURVE	VC	VERTICAL CURVE				
LF	LINEAR FEET	VTP	VITRIFIED TILE PIPE				
	LIGHT DOOT (DDN/ATE)						

CENTRAL ANGLE

EARTHWORK

- 1. **PREPARATION** PRIOR TO START OF EARTHWORK OPERATIONS THE CONTRACTOR SHALL COMPLETE THE FOLLOWING APPLICABLE ITEMS AS DEFINED BY CONTRACT DOCUMENTS:
- SITE DEMOLITION REMOVAL AND DISPOSAL OFF-SITE IN A LEGAL MANNER; STRUCTURES, UTILITIES,
- CLEARING AND GRUBBING REMOVAL AND DISPOSAL OFF-SITE IN A LEGAL MANNER; TREES, BRUSH,
- TOPSOIL STRIPPING STRIP AND STOCKPILE TOPSOIL FOR REUSE. EXCESS TOPSOIL MAY BE REMOVED FROM SITE WITH APPROVAL BY OWNER AND MUNICIPALITY.
- **2. RESPONSIBILITY** THE CONTRACTOR IS RESPONSIBLE FOR:
- ESTIMATE COMPLETION OF A QUANTITY TAKEOFF TO DETERMINE THE VOLUME OF CUT, FILL, AND TOPSOIL. COMPARE AND COORDINATE WITH INFORMATION PROVIDED BY THE DESIGN ENGINEER.
- GRADE TOLERANCES ESTABLISHING DESIGN SUBGRADE ELEVATIONS TO WITHIN ONE TENTH OF ONE FOOT (0.10') IN PAVEMENT AREAS (INCLUDING WALKS) AND TO WITHIN THIRTY-THREE HUNDREDTHS OF ONE FOOT
- COMPACTION ACHIEVING THE SPECIFIED MINIMUM COMPACTION VALUES FOR EMBANKMENT/FILL AREAS. THE TERMS "FILL" AND EMBANKMENT" ARE INTERCHANGEABLE.
- CUTS ONCE EXCAVATIONS ARE SHAPED TO THE DESIGN GRADES THE AREAS SHALL BE PROTECTED TO ASSURE THAT THE INTEGRITY OF MATERIAL IS NOT COMPROMISED BY CONSTRUCTION VEHICLES AND/OR IMPROPER DRAINAGE. AREAS DETERMINED BY CONTRACTOR TO BE NOT SUITABLE FOR SUBGRADE PLACEMENT SHALL BE IMMEDIATELY REPORTED WHEN THE SUBGRADE IS ESTABLISHED TO OWNER'S REPRESENTATIVE. STABILIZATION MEASURES FOR CUT AREAS MAY BE CONSIDERED BY OWNER'S REPRESENTATIVE AS A CHANGE TO THE BASE CONTRACT.
- 3. TESTING THE FOLLOWING MAXIMUM DRY DENSITIES SHALL BE ACHIEVED AS MEASURED BY THE MODIFIED
- PROCTOR METHOD ASTM D-1557: • 95% UNDER PAVEMENTS, WALKS, AND IN STRUCTURAL FILL AREAS
- 85% IN REMAINING AREAS

THE AGREEMENT BETWEEN THE OWNER AND CONTRACTOR SHALL DEFINE THE NUMBER OF TESTS AND RESPONSIBILITY. WE RECOMMEND IN EMBANKMENT AREAS ONE PER LIFT AND/OR ONE PER 1,000 CUBIC YARDS.

- 4. LIFT THICKNESS THE MAXIMUM LIFT THICKNESS UNDER PAVEMENTS, WALKS, AND STRUCTURAL FILLS SHALL BE 12 INCHES. HAND OPERATED COMPACTION FILLS SHALL NOT EXCEED 6 INCHES.
- 5. PROOF ROLLING THE OWNER'S REPRESENTATIVE MAY REQUEST A PROOF ROLL (I.E. LOADED TEN WHEELER) OF SUBGRADE AREAS PRIOR TO PLACEMENT OF SUBBASE MATERIALS. AREAS THAT "FAIL" SHALL BE REMOVED AND REPLACED TO ACHIEVE A PASSING SUBGRADE.

EROSION CONTROL

- 1. CERTIFICATION THE STORM WATER POLLUTION PREVENTION PLAN (SWPPP), WHICH INCLUDES THE "GRADING PLAN", "EROSION CONTROL PLAN", "EROSION CONTROL NOTES", ALONG WITH THE "DRAINAGE REPORT", DEFINES AND MEETS THE REQUIREMENTS OF THE NEW YORK STATE DEPARTMENT OF ENVIRONMENTAL CONSERVATION (NYSDEC) LATEST STORM WATER REGULATIONS.
- 2. CONTRACTOR RESPONSIBILITY ALL CONTRACTORS AND SUB-CONTRACTORS SHALL CERTIFY WITHIN THE SWPPP THAT THEY WILL IMPLEMENT AND MAINTAIN STORM WATER MANAGEMENT PRACTICES.
- 3. INSPECTION EROSION CONTROL (EC) MEASURES INSTALLED AND MAINTAINED BY THE SITE WORK CONTRACTOR ARE SUBJECT TO THE REVIEW AND APPROVAL OF THE: MUNICIPALITY, DESIGN ENGINEER, NYSDEC, AND OWNER'S REPRESENTATIVE. IMMEDIATE ACTION BY THE CONTRACTOR SHALL BE TAKEN IF ADDITIONAL OR CORRECTIVE MEASURES ARE REQUIRED BY ANY ONE OF THESE CITED REVIEWERS. EROSION CONTROL MEASURES NOT SPECIFICALLY SHOWN ON CONTRACT DRAWINGS (I.E., STRAW BALES, COLLARS, FABRICS, ETC.) SHALL BE INSTALLED AS WARRANTED BY FIELD CONDITIONS, AND AS DIRECTED BY THE AFOREMENTIONED
- **4. NOTIFICATION** AS DESIGN ENGINEER, OUR OFFICE HAS NOTIFIED THE OWNER OF THE INSPECTION REQUIREMENTS UNDER GP-0-20-01. DISTURBANCES OF 1.0 ACRE OR GREATER REQUIRE THAT THE OWNER FILE A NOTICE OF INTENT (NOI) AND A SWPPP WITH THE NYSDEC UNDER STATE POLLUTANT DISCHARGE ELIMINATION SYSTEM (SPDES) GENERAL PERMIT #GP-0-20-01. THE REGULATIONS REQUIRE THAT A LICENSED PROFESSIONAL COMPLETE A WEEKLY INSPECTION (THROUGHOUT THE PERIOD OF LAND DISTURBANCE).
- 5. **PRE-CONSTRUCTION** THE APPROPRIATE EROSION CONTROL MEASURES AS DEFINED BY THE CONSTRUCTION DOCUMENTS SHALL BE INSTALLED PRIOR TO THE START OF ANY CONSTRUCTION ACTIVITIES.
- 6. TOPSOIL UPON COMPLETION OF THE STOCKPILE STRIPPING OPERATION, STOCKPILES SHALL BE STABILIZED IN ACCORDANCE TO NYSDEC REGULATIONS.
- 7. SLOPES UPON COMPLETION OF GRADING, SLOPES WITH A GRADIENT OF ONE FOOT VERTICAL TO THREE FEET HORIZONTAL (1 ON 3) OR GREATER SHALL BE: TOPSOILED, SEEDED, FERTILIZED AND MULCHED OR TREATED AS SPECIFIED ON CONTRACT DRAWINGS
- 8. DUST THE CONTRACTOR SHALL APPLY WATER AND/OR CALCIUM CHLORIDE, AS CONDITIONS WARRANT, TO CONTROL WIND BORN EROSION. THIS MEASURE APPLIES TO: HAUL ROADS, CUT AND FILL OPERATIONS, SUB-BASE AND ANY OTHER EXPOSED SURFACES.
- 9. OPERATION & MAINTENANCE THROUGHOUT THE PERIOD OF CONSTRUCTION AND PRIOR TO ESTABLISHING FINAL GROUND COVER THE SITE CONTRACTOR IS RESPONSIBLE FOR THE OPERATION AND MAINTENANCE OF THE TEMPORARY EROSION CONTROL MEASURES. FOR EXAMPLE, THE SILTATION FACILITIES SHALL BE RE-EXCAVATED WHEN THE VOLUME (3600 CUBIC FEET/DISTURBED ACRE) IS REDUCED BY ONE-HALF OR MORE OF ITS SPECIFIED CAPACITY AND/OR THE MATERIAL IS WITHIN ONE FOOT OF THE DISCHARGE POINT.
- 10. WORK STOPPAGE ALL DISTURBED AREAS NOT TO BE WORKED WITHIN 14 DAYS MUST BE SEEDED WITHIN 7 DAYS FROM THE LAST CONSTRUCTION ACTIVITY IN THAT AREA.
- 11. TEMPORARY STABILIZATION TEMPORARY STABILIZATION SHALL REQUIRE 4 TONS OF STRAW/ ACRE OF DISTURBANCE PLACED WITH TACKIFIER OR ROLLED WITH A TRACKED VEHICLE TO ENSURE NOT DISPLACED.
- 12. WINTER STABILIZATION ALL WINTER STABILIZATION METHODS IDENTIFIED IN THE NYS 'BLUE BOOK' SHALL BE FOLLOWED FOR ANY DISTURBANCE OR NON-STABILIZED AREAS FROM NOVEMBER 15TH - APRIL 1ST.
- 13. SUBSOIL RESTORATION ALL AREAS TO BE RESTORED AS LAWN SHALL BE RESTORED PER CHAPTER 5 (5.1.6) OF THE NEW YORK STATE STORMWATER DESIGN MANUAL AND THE SOIL RESTORATION TABLE (TABLE 5.3 -SOIL RESTORATION REQUIREMENTS) SHOWN ON THE PLANS. THE PROJECT SOILS ARE HYDROLOGIC SOIL GROUP A AND SHALL BE RESTORED AS SPECIFIED.
- 14. SEQUENCE THE CONTRACTOR SHALL INSTALL EROSION CONTROL MEASURES IN THE FOLLOWING SEQUENCE
- UNLESS AUTHORIZED OTHERWISE AT PRE-CONSTRUCTION MEETING: INSTALL PERIMETER SEDIMENT CONTROLS, I.E. EROSION FENCING.
- INSTALL STABILIZED CONSTRUCTION ENTRANCE. PROTECT VEGETATION TO REMAIN.
- CLEAR/GRUB AND CONSTRUCT DIVERSIONARY SWALES, AND SEDIMENT BASINS.
- COMPLETE CLEARING AND GRUBBING OPERATION.
- PLACE EROSION CONTROL MEASURES AT TOPSOIL STOCKPILES AND STRIP TOPSOIL. CONSTRUCT SWALES AND SILTATION DEVICES AS EARTHWORK OPERATIONS PROGRESS.
- MAINTAIN EROSION CONTROL MEASURES AND PLACE ADDITIONAL MEASURES AS EARTHWORK AND UNDERGROUND UTILITIES ARE CONSTRUCTED.
- RESTORE AREAS AS DEFINED BY CONTRACT DOCUMENTS. • REMOVE EROSION CONTROL MEASURES AS AREAS ARE REESTABLISHED WITH GROUND COVER.

SPECIAL DEMOLITION NOTES

- 1. IT IS INTENDED TO LIMIT DISTURBANCE AS MUCH AS POSSIBLE. THE CONTRACTOR WILL BE RESPONSIBLE TO COORDINATE DEMOLITION SCHEDULE. PHASING, PEDESTRIAN SAFETY, PARKING AND VEHICULAR CIRCULATION, STOCKPILE LOCATIONS AND SECURITY FENCING WITH OWNERS ON-SITE REPRESENTATIVE. ANY DISTURBANCE OUTSIDE THE WORK LIMIT LINE SHALL BE COORDINATED WITH THE OWNER'S ON-SITE REPRESENTATIVE.
- 2. REMOVE ALL TREES WITHIN THE WORK LIMIT LINE UNLESS SPECIFICALLY CALLED OUT TO REMAIN.

LEGEND:

EXISTING	PROPOSED	DESCRIPTION
SIGN O	٥	SIGN
- *	머	LIGHT POLE
=	===	POWER POLE
		GAS MAIN & VALVE
EHH		ELECTRIC CONDUIT & STRUCTURE
T		TELEPHONE CONDUIT & STRUCTURE
——— € ———	1+00	CENTERLINE AND STATIONING
		RIGHT-OF-WAY OR PROPERTY LINE
		CURB
x	x	FENCE (DESCRIPTION)
● —8"SA-►	8" PVC SDR-35 SAN @ 1.0%	SANITARY SEWER WITH MANHOLE
O—8"ST-──□	O 12"PE ST @ 1.0%	STORM SEWER, MANHOLE & FIELD/DROP IN
	y.v X w.	V. WATER MAIN WITH HYDRANT & GATE VALVE
	···	CENTERLINE OF SWALE
_525—	_(525)	CONTOUR
	\longrightarrow	DRAINAGE FLOW ARROW
√ ⁻ 525.0±	+ (525.0)	SPOT ELEVATION
~~~~~	$\sim\sim\sim$	TREE LINE
	$\Box$	TREE PROTECTION
$(\overline{1})$	1	PARKING SPACE COUNT

39 CASCADE DRIVE ROCHESTER, NY 14614 5 8 5 - 4 5 8 - 7 7 7 0 ITHACA LOCATION

840 HANSHAW RD, STE 6 ITHACA, NY 14850 6 0 7 - 2 4 1 - 2 9 1 7 www.marathoneng.com

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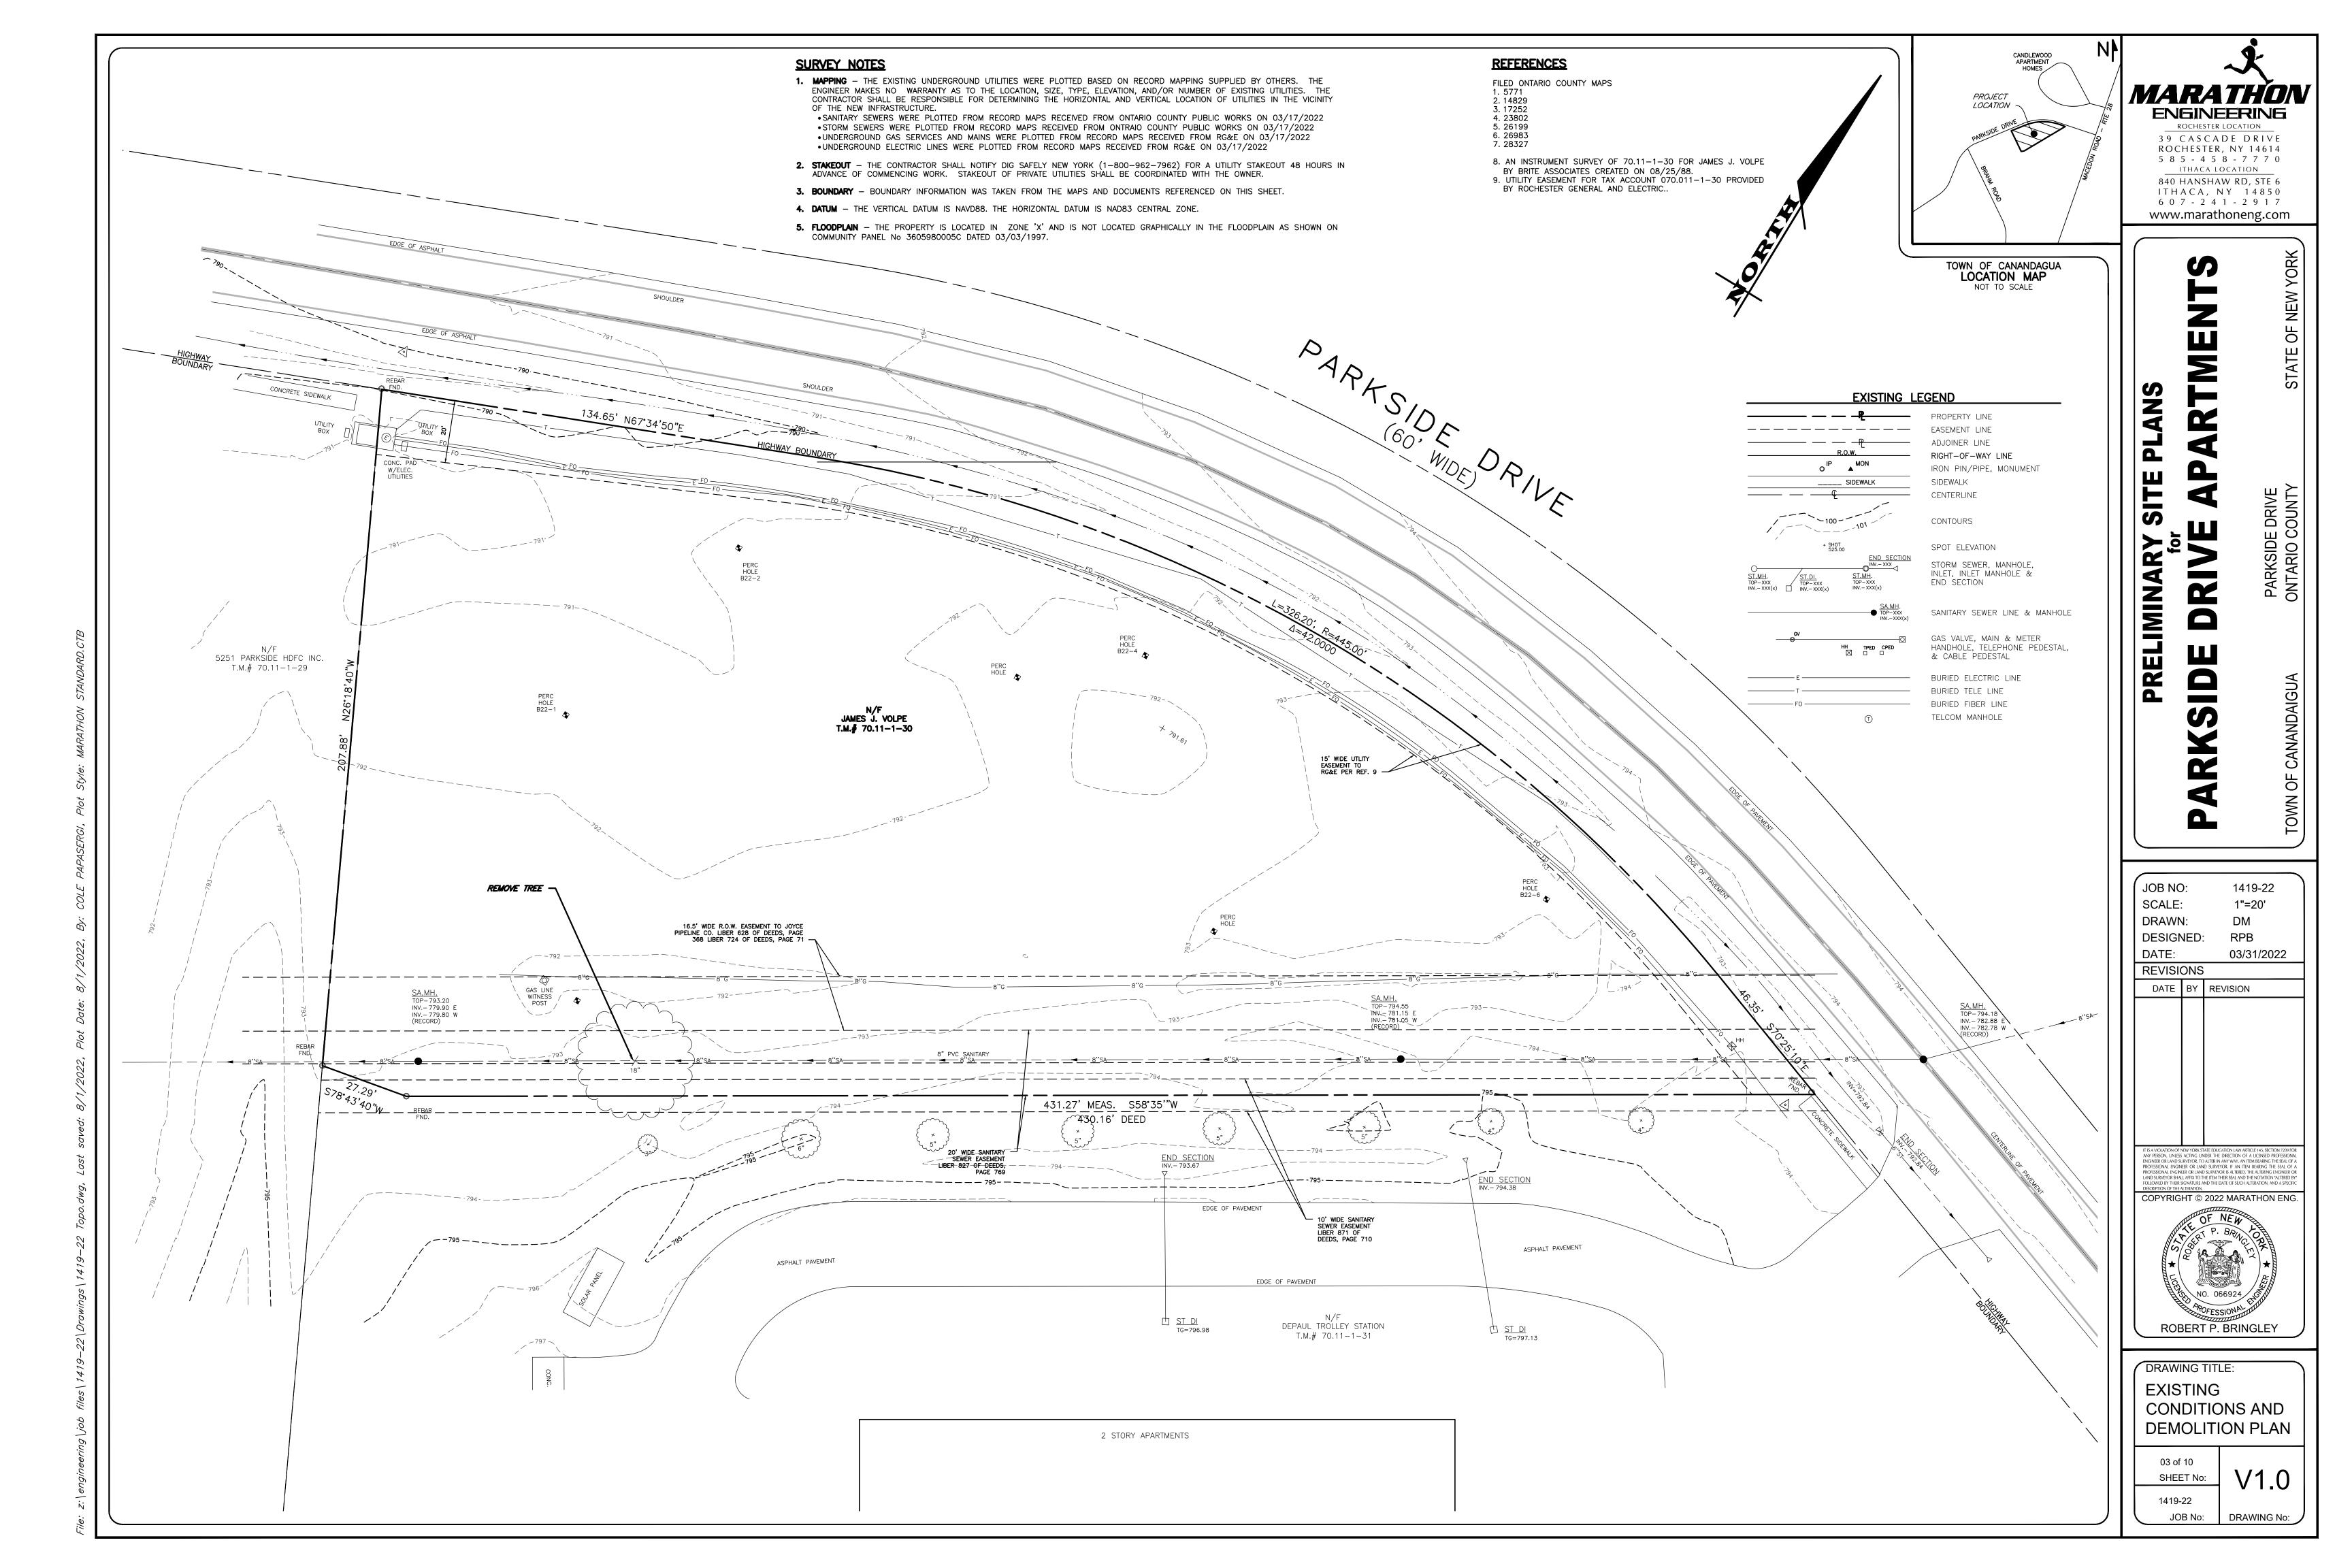
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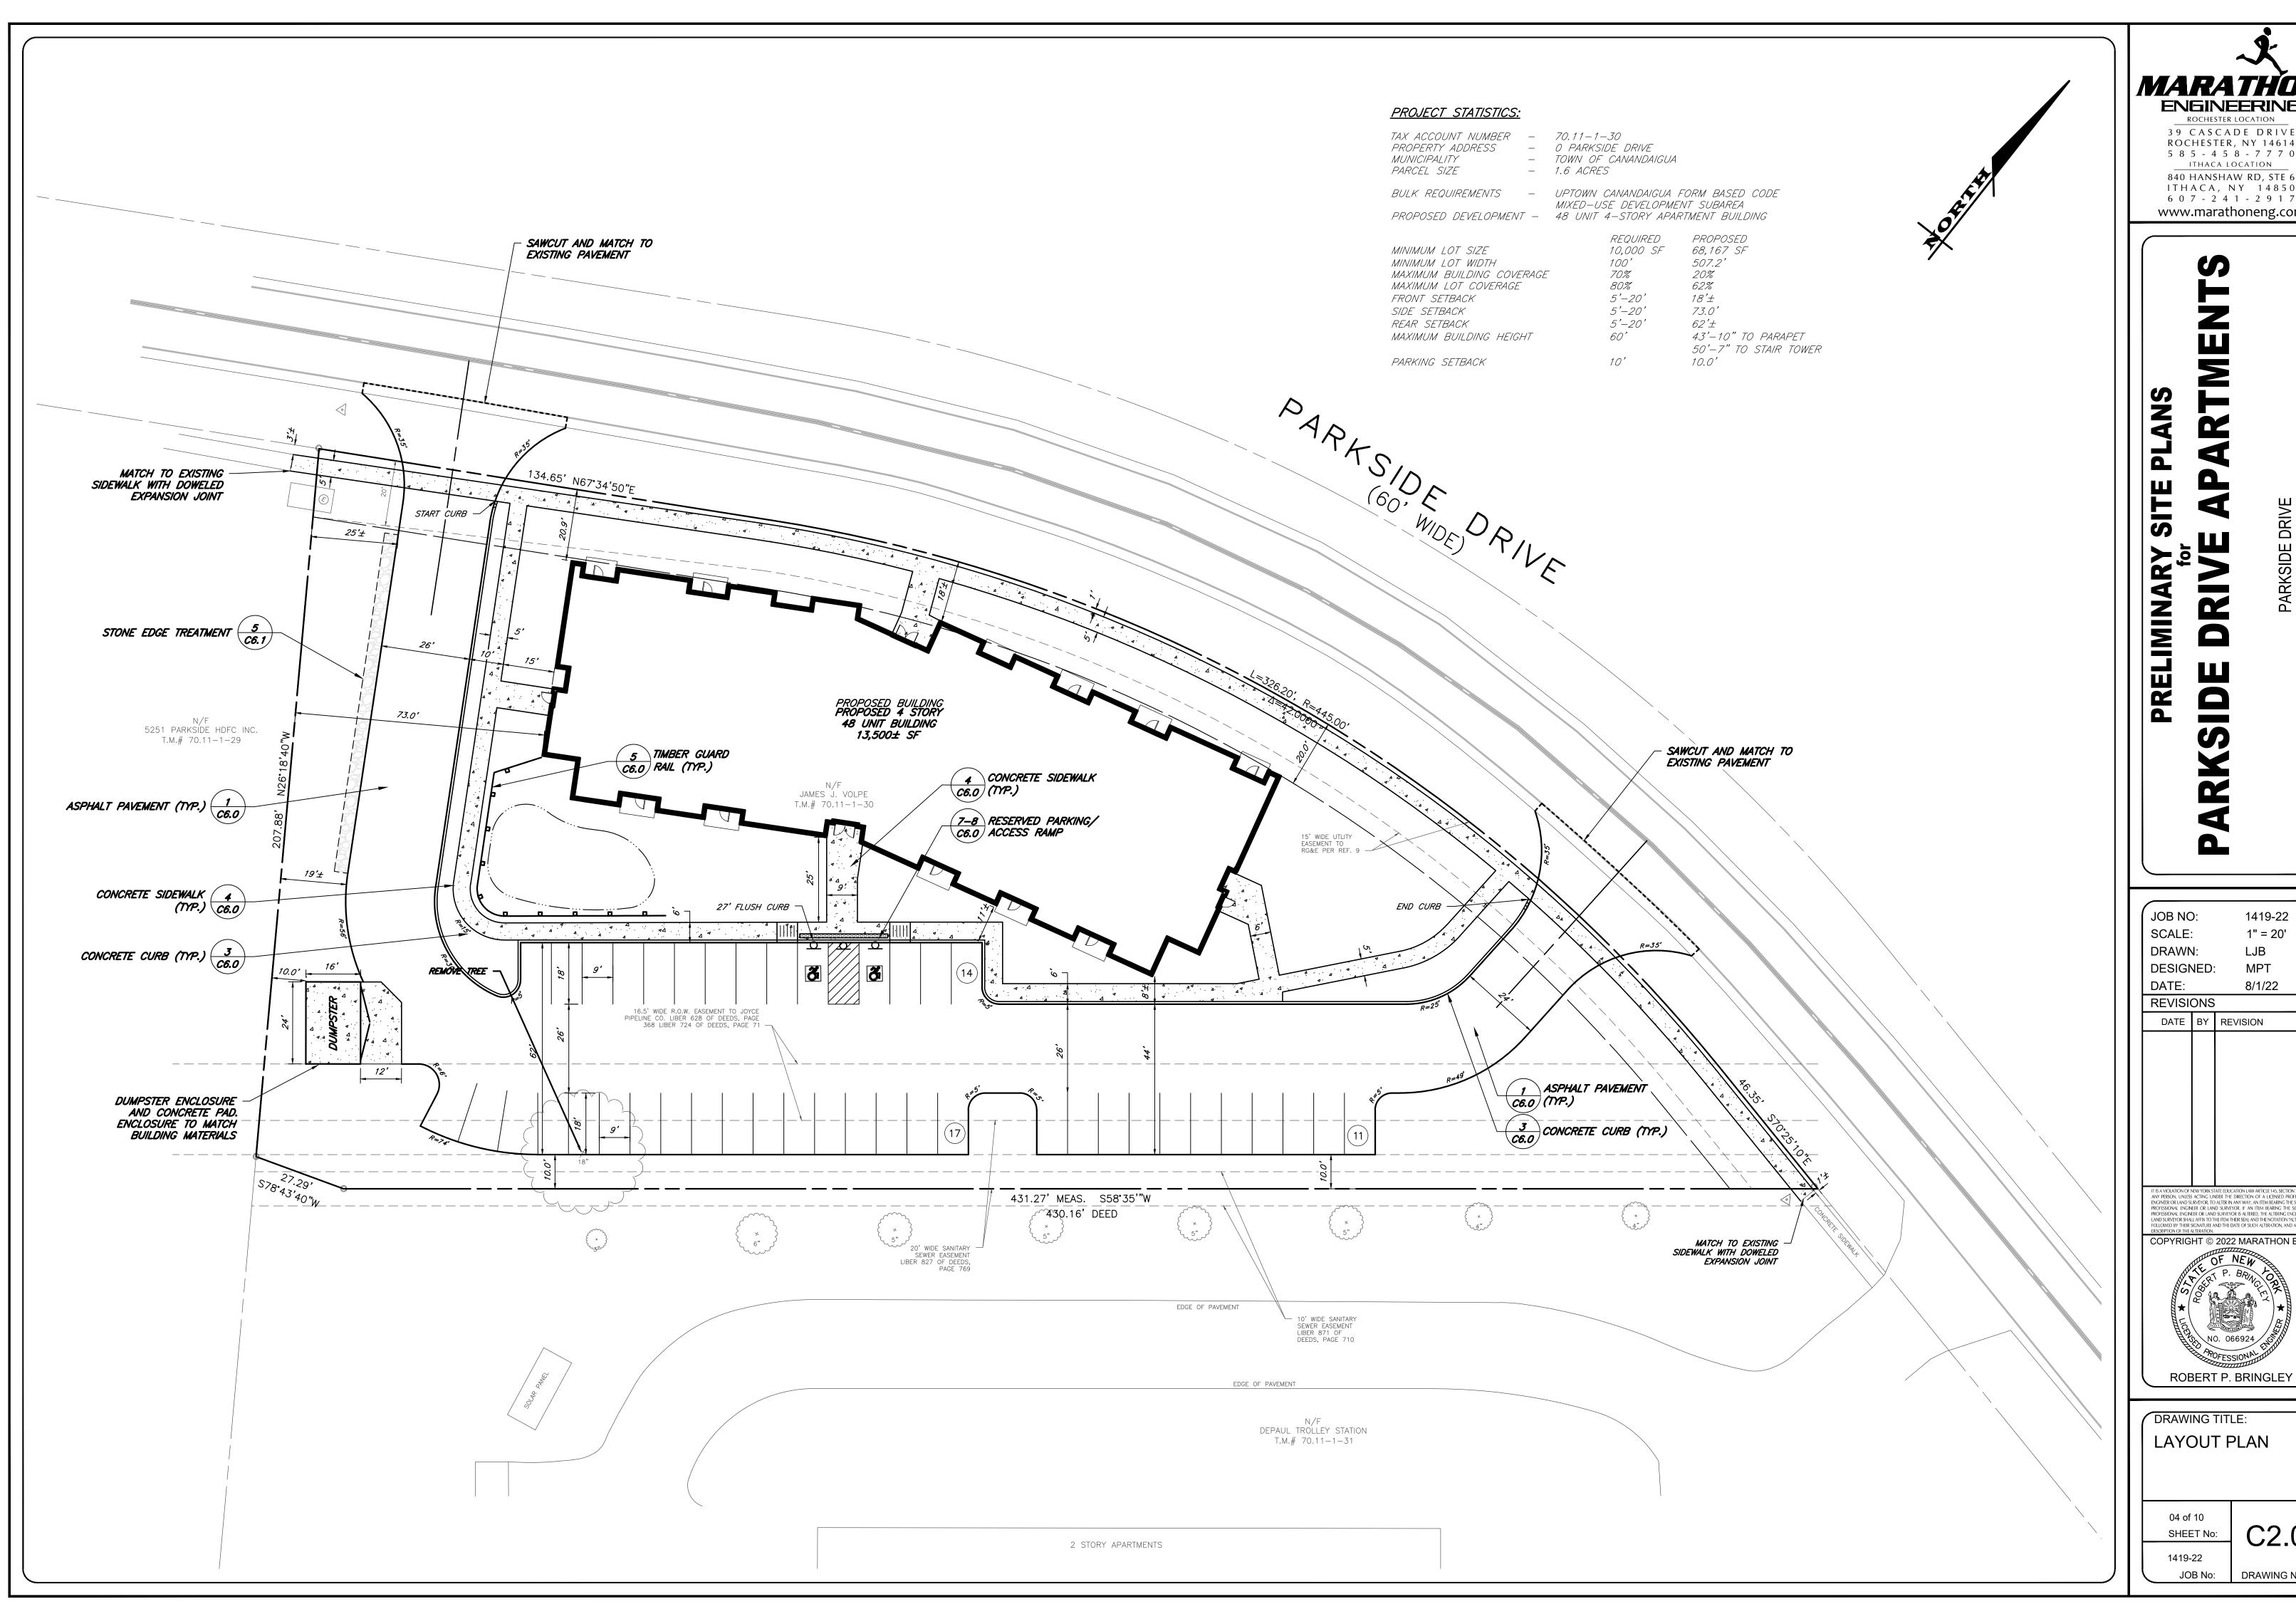
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SHEET No: 1419-22

DRAWING No:

JOB No:







39 CASCADE DRIVE ROCHESTER, NY 14614 5 8 5 - 4 5 8 - 7 7 7 0 ITHACA LOCATION 840 HANSHAW RD, STE 6 ITHACA, NY 14850 6 0 7 - 2 4 1 - 2 9 1 7


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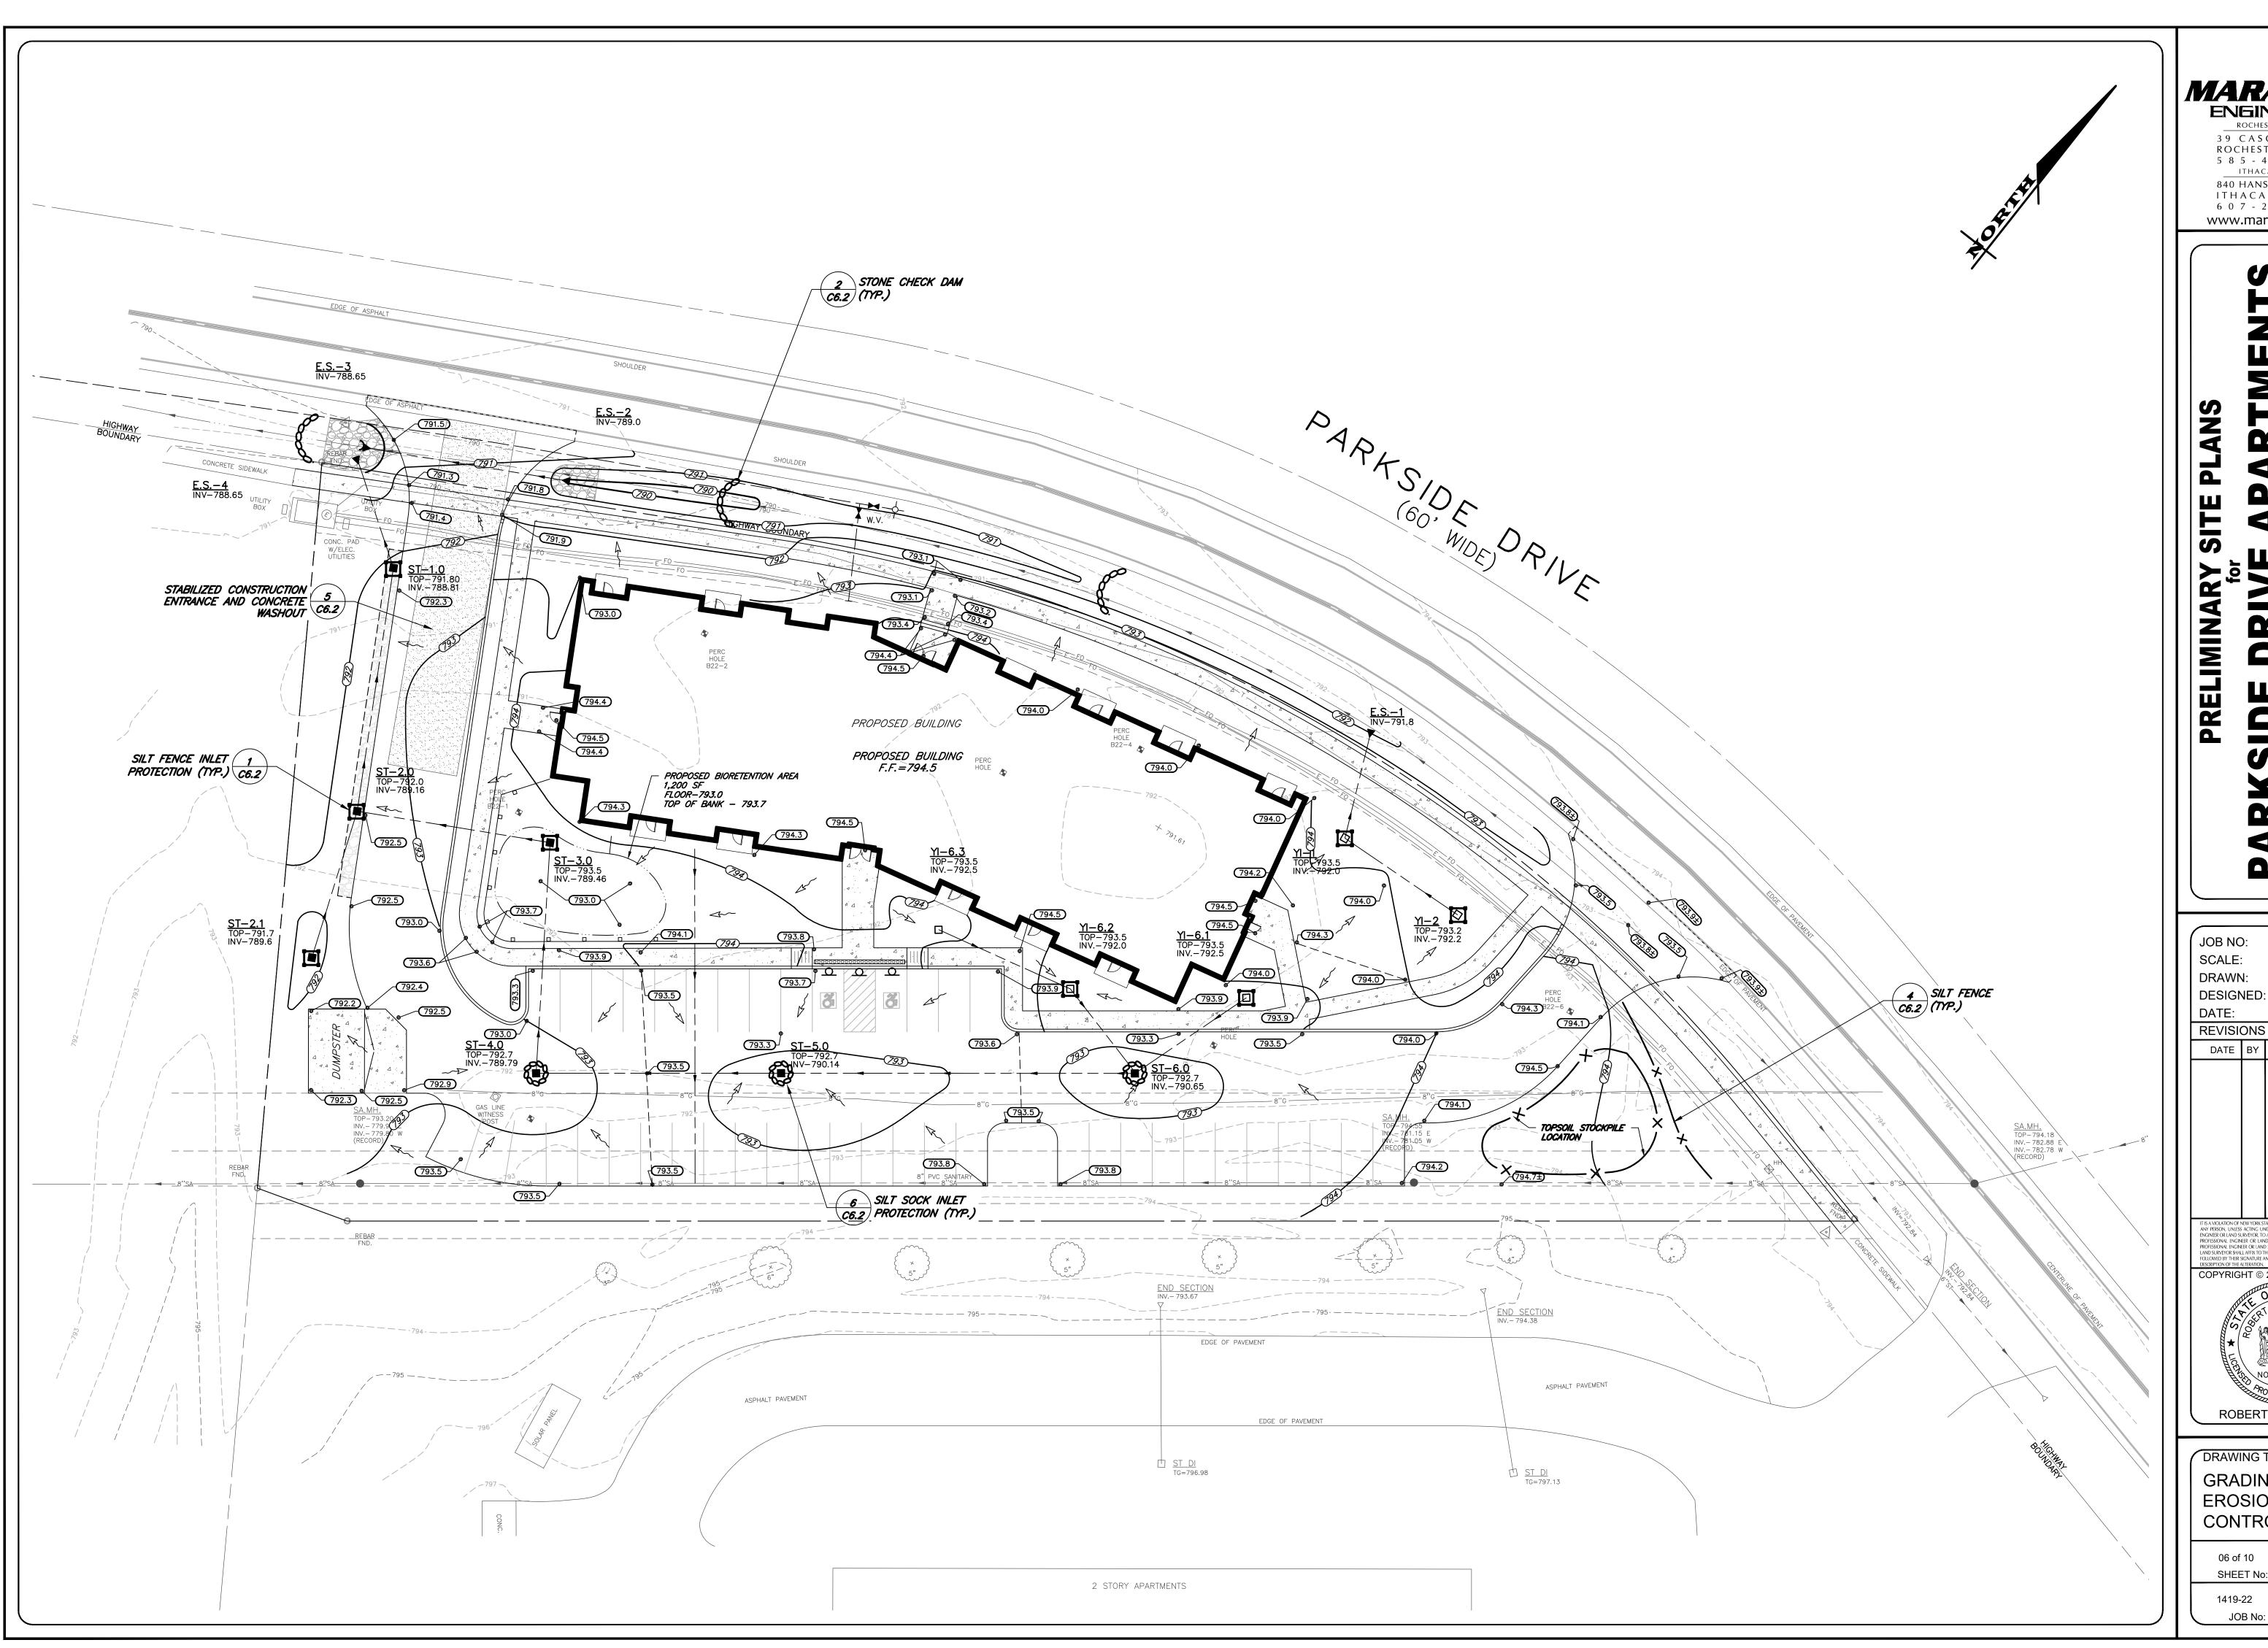
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JOB NO: 1419-22 SCALE: 1" = 20' DRAWN: LJB DESIGNED: MPT DATE: 8/1/22 REVISIONS DATE BY REVISION IT IS A VIOLATION OF NEW YORK STATE EDUCATION LAW ARTICLE 145, SECTION 7209 FOR ANY PERSON, UNLESS ACTING UNDER THE DIRECTION OF A LICENSED PROFESSIONAL ROGINEER OR LAND SURVEYOR, TO ALTER IT NAM' WAY, AN ITEM BEARING THE SEAL OF A PROFESSIONAL ENGINEER OR LAND SURVEYOR. IF AN ITEM BEARING THE SEAL OF A PROFESSIONAL ENGINEER OR LAND SURVEYOR IS ALTERED, THE ALTERING ENGINEER OR LAND SURVEYOR SHALL AFRIX TO THE ITEM THERE, STAL AND THE NOTATION "ALTERED BY FOLLOWED BY THEIR SIGNATURE AND THE DATE OF SUCH ALTERATION, AND A SPECIFIC DESCRIPTION OF THE ALTERIOR DATE OF SUCH ALTERATION, AND A SPECIFIC DESCRIPTION OF THE ALTERATION. COPYRIGHT © 2022 MARATHON ENG.

DRAWING TITLE: LAYOUT PLAN SHEET No: 1419-22 JOB No: DRAWING No:



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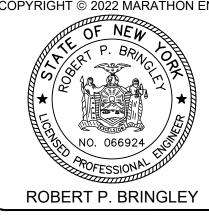
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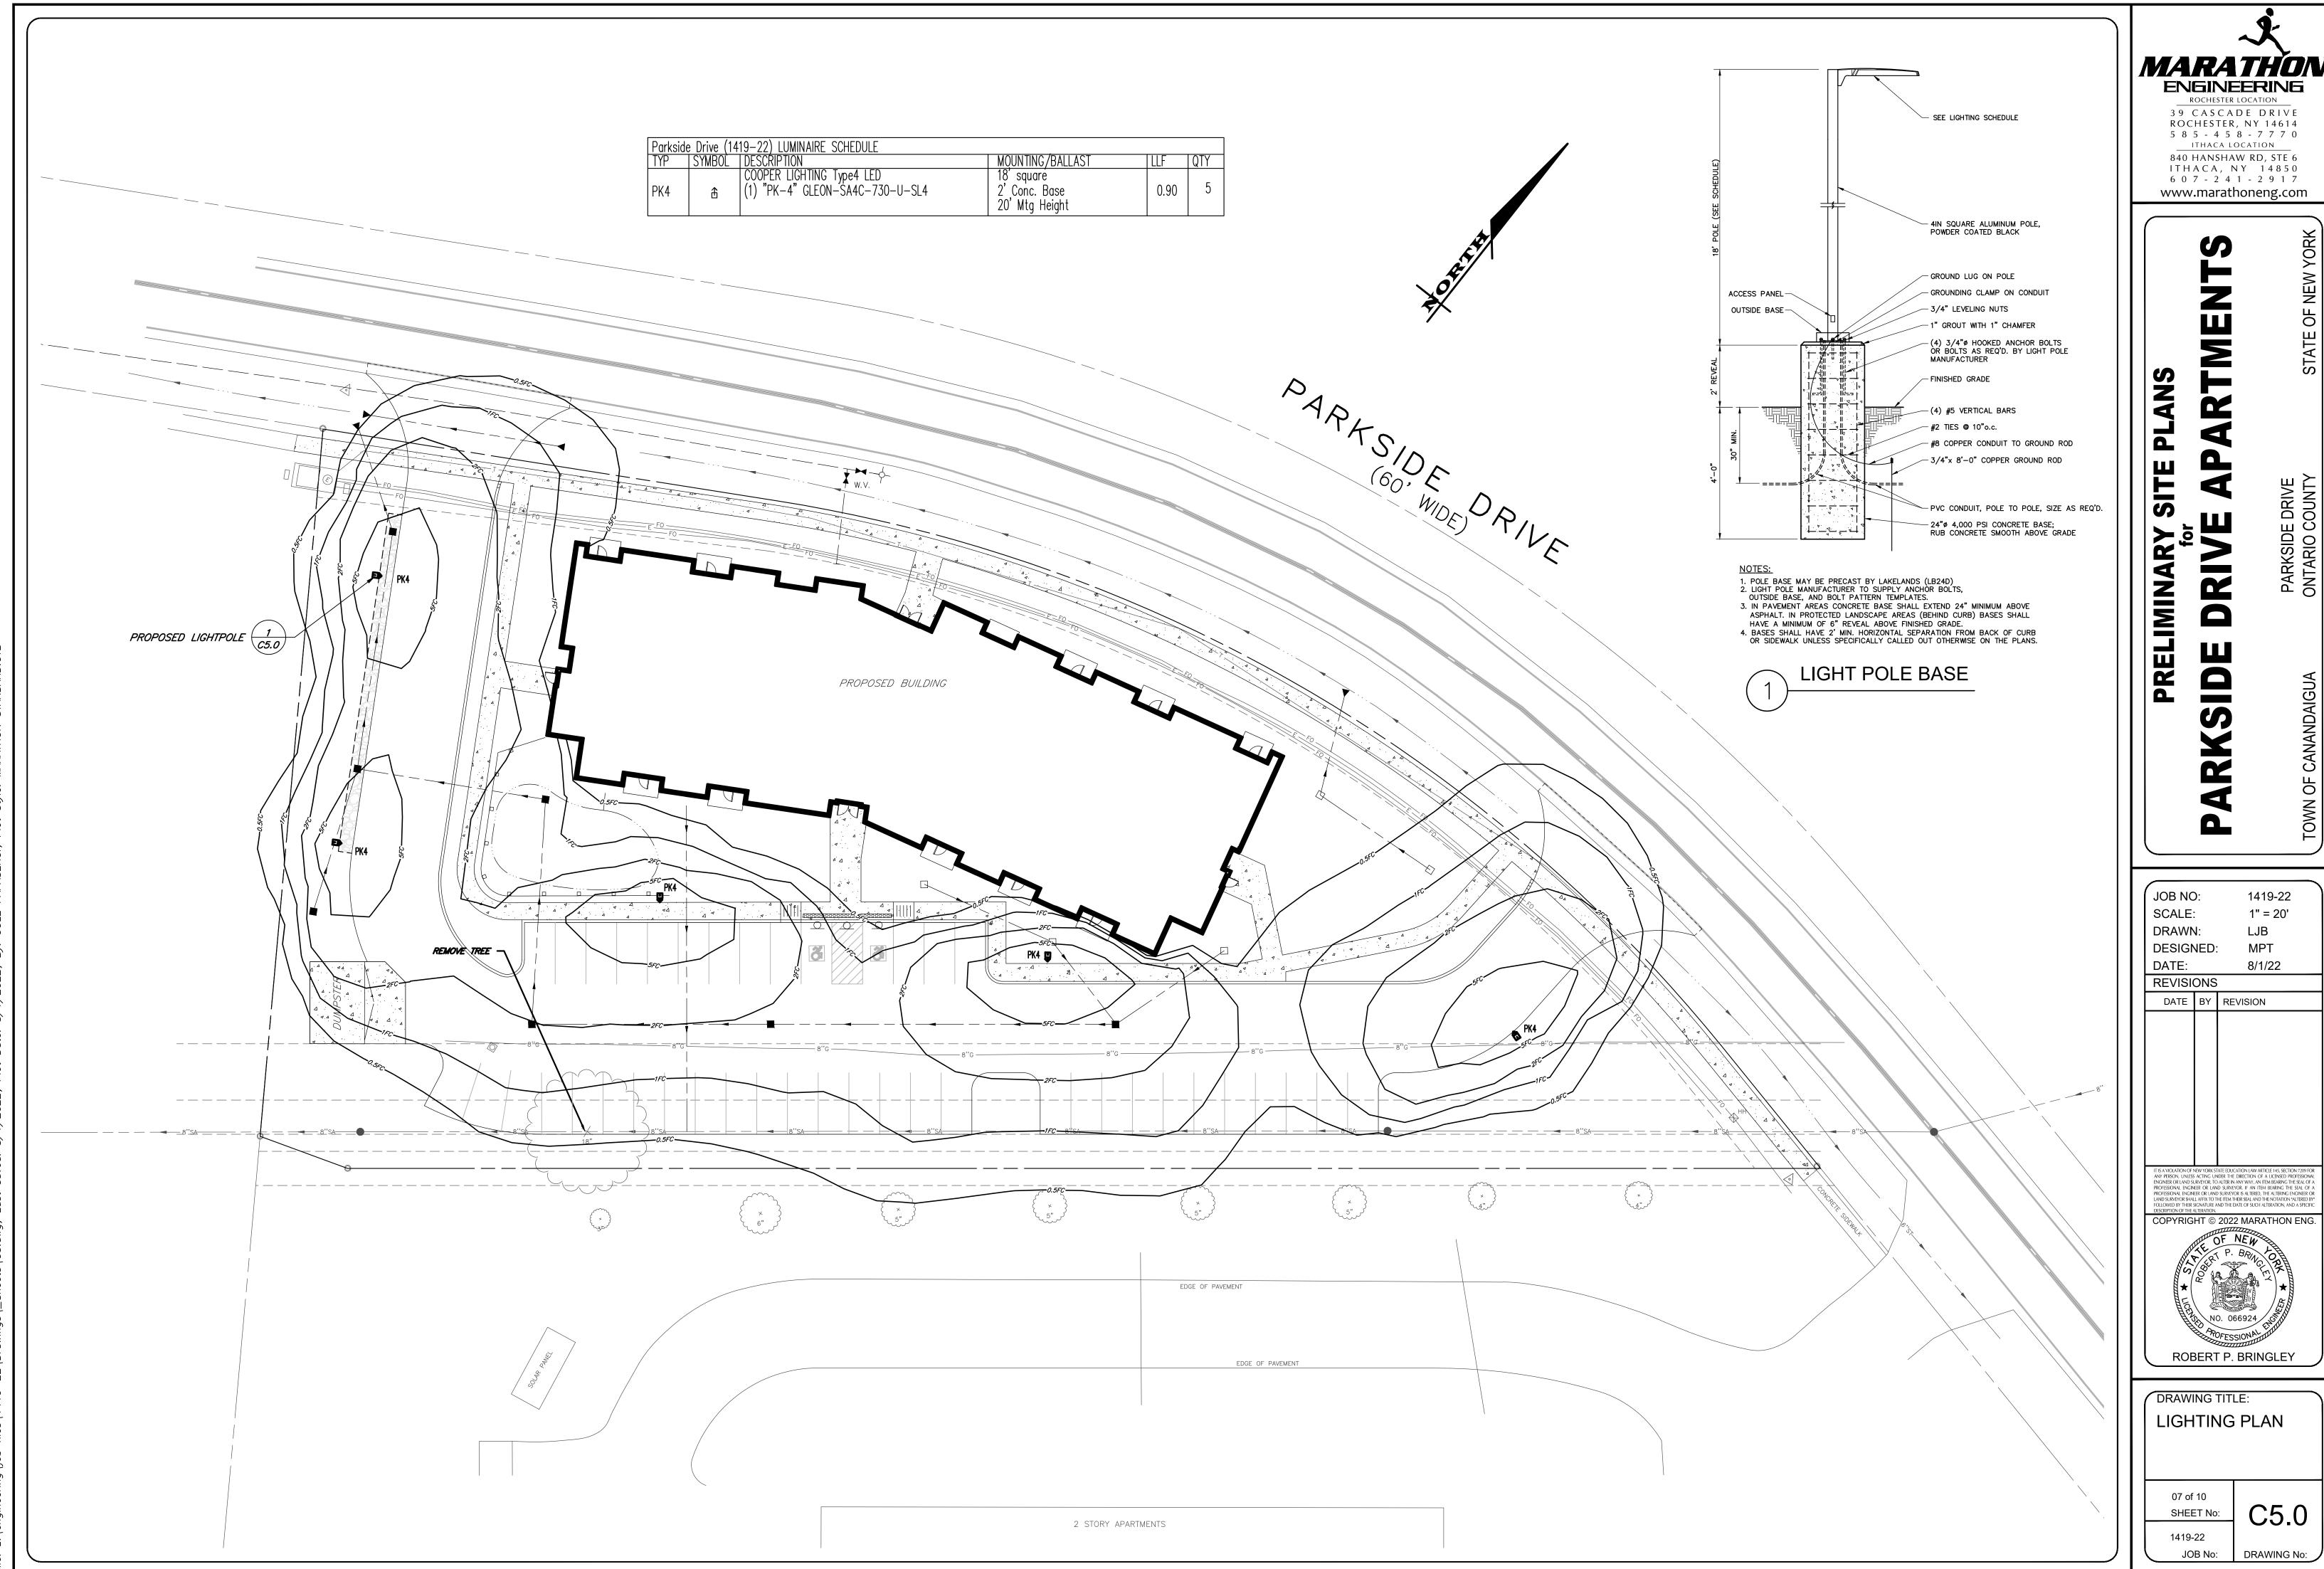
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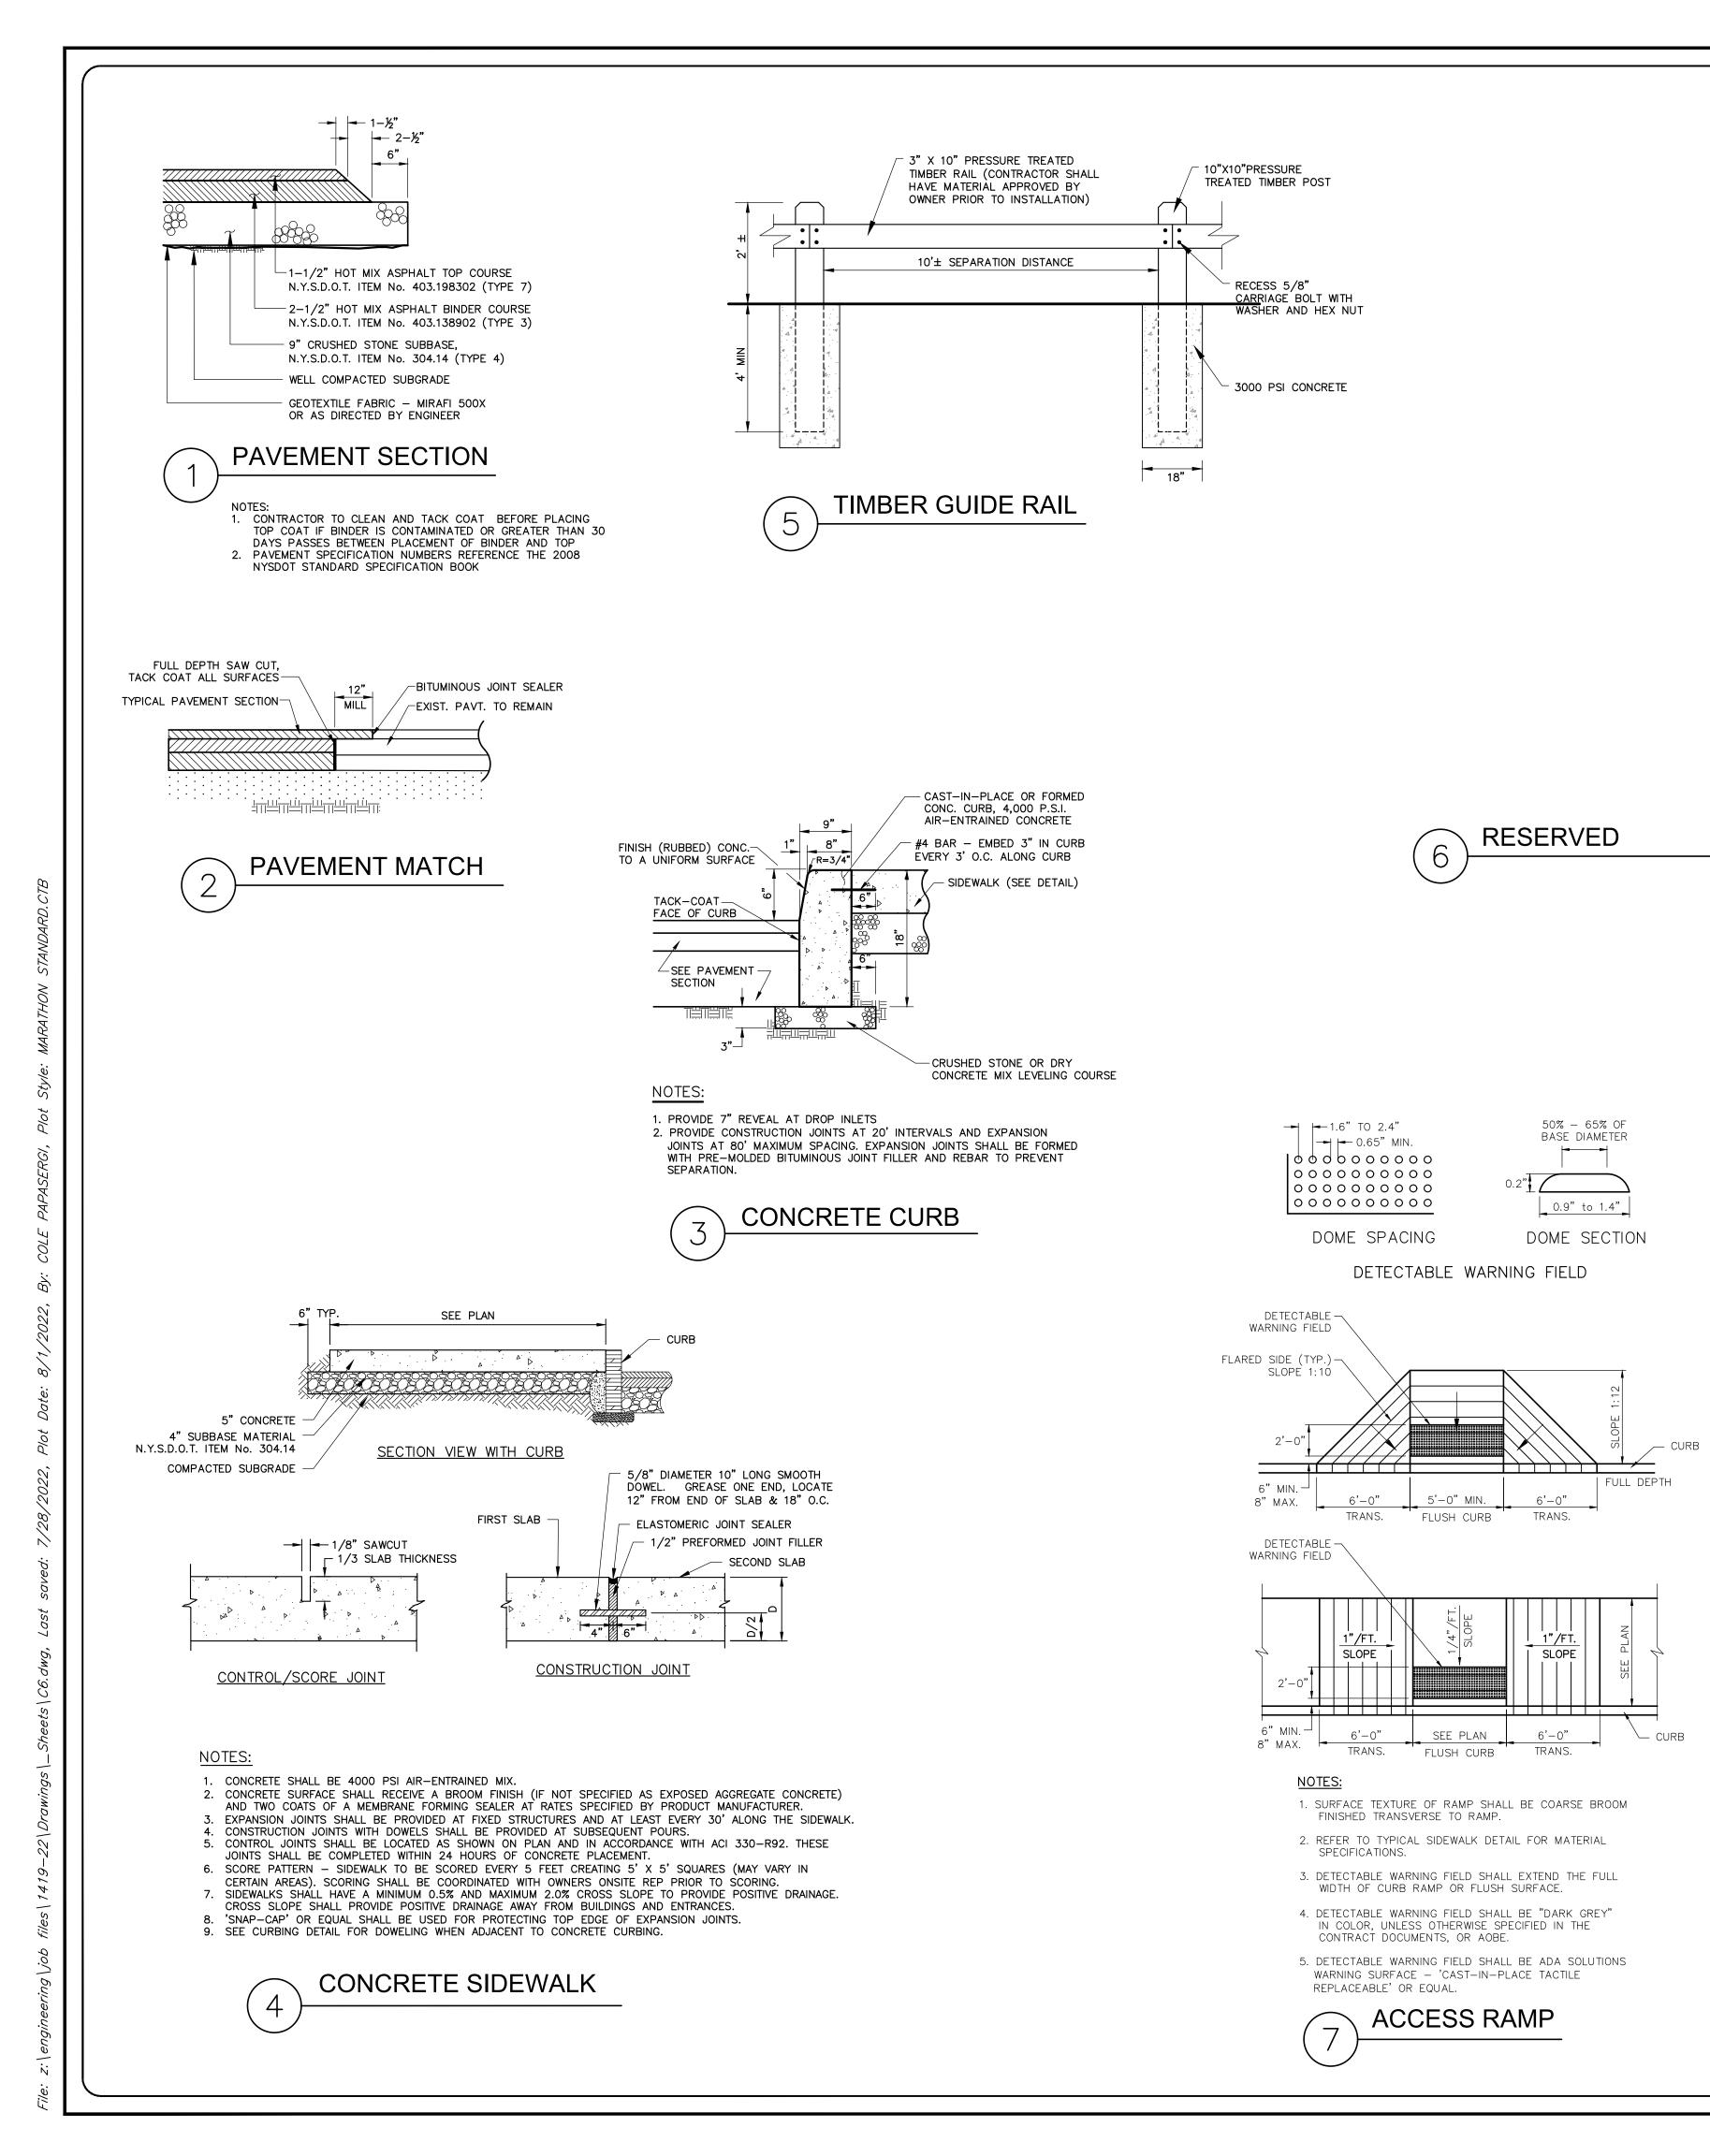



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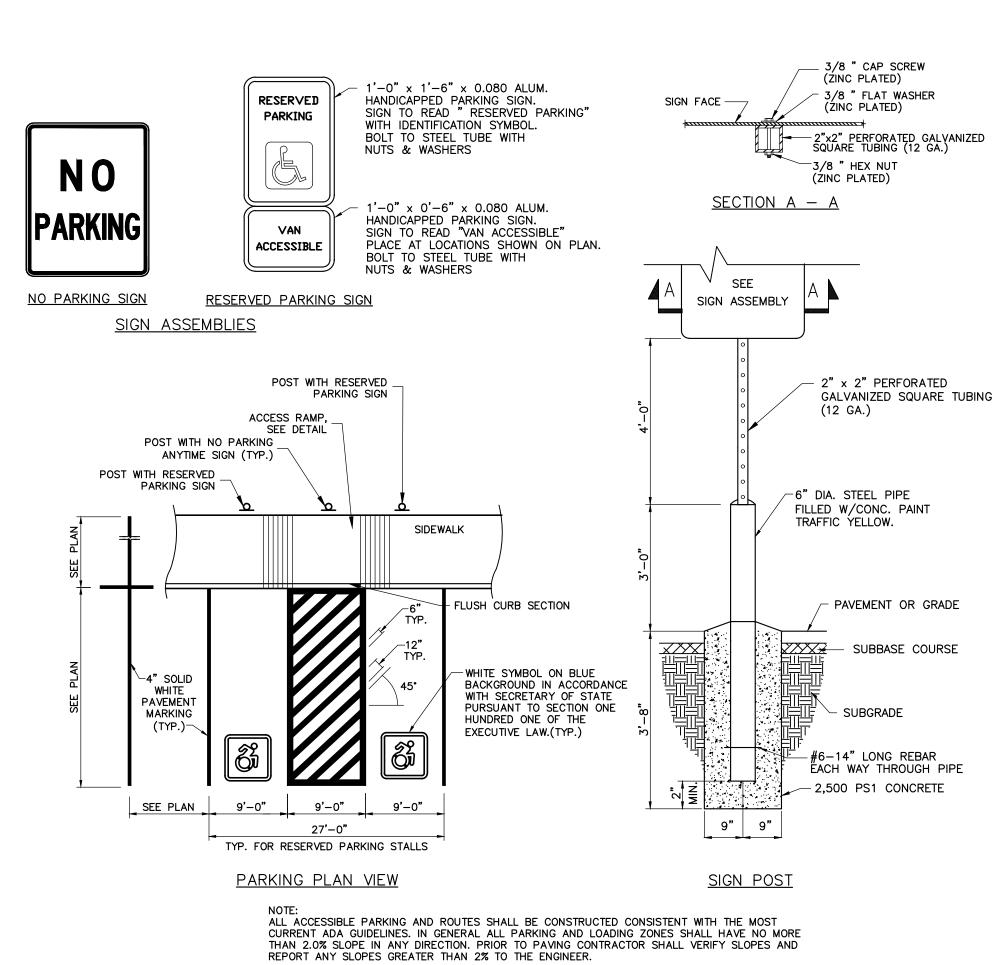
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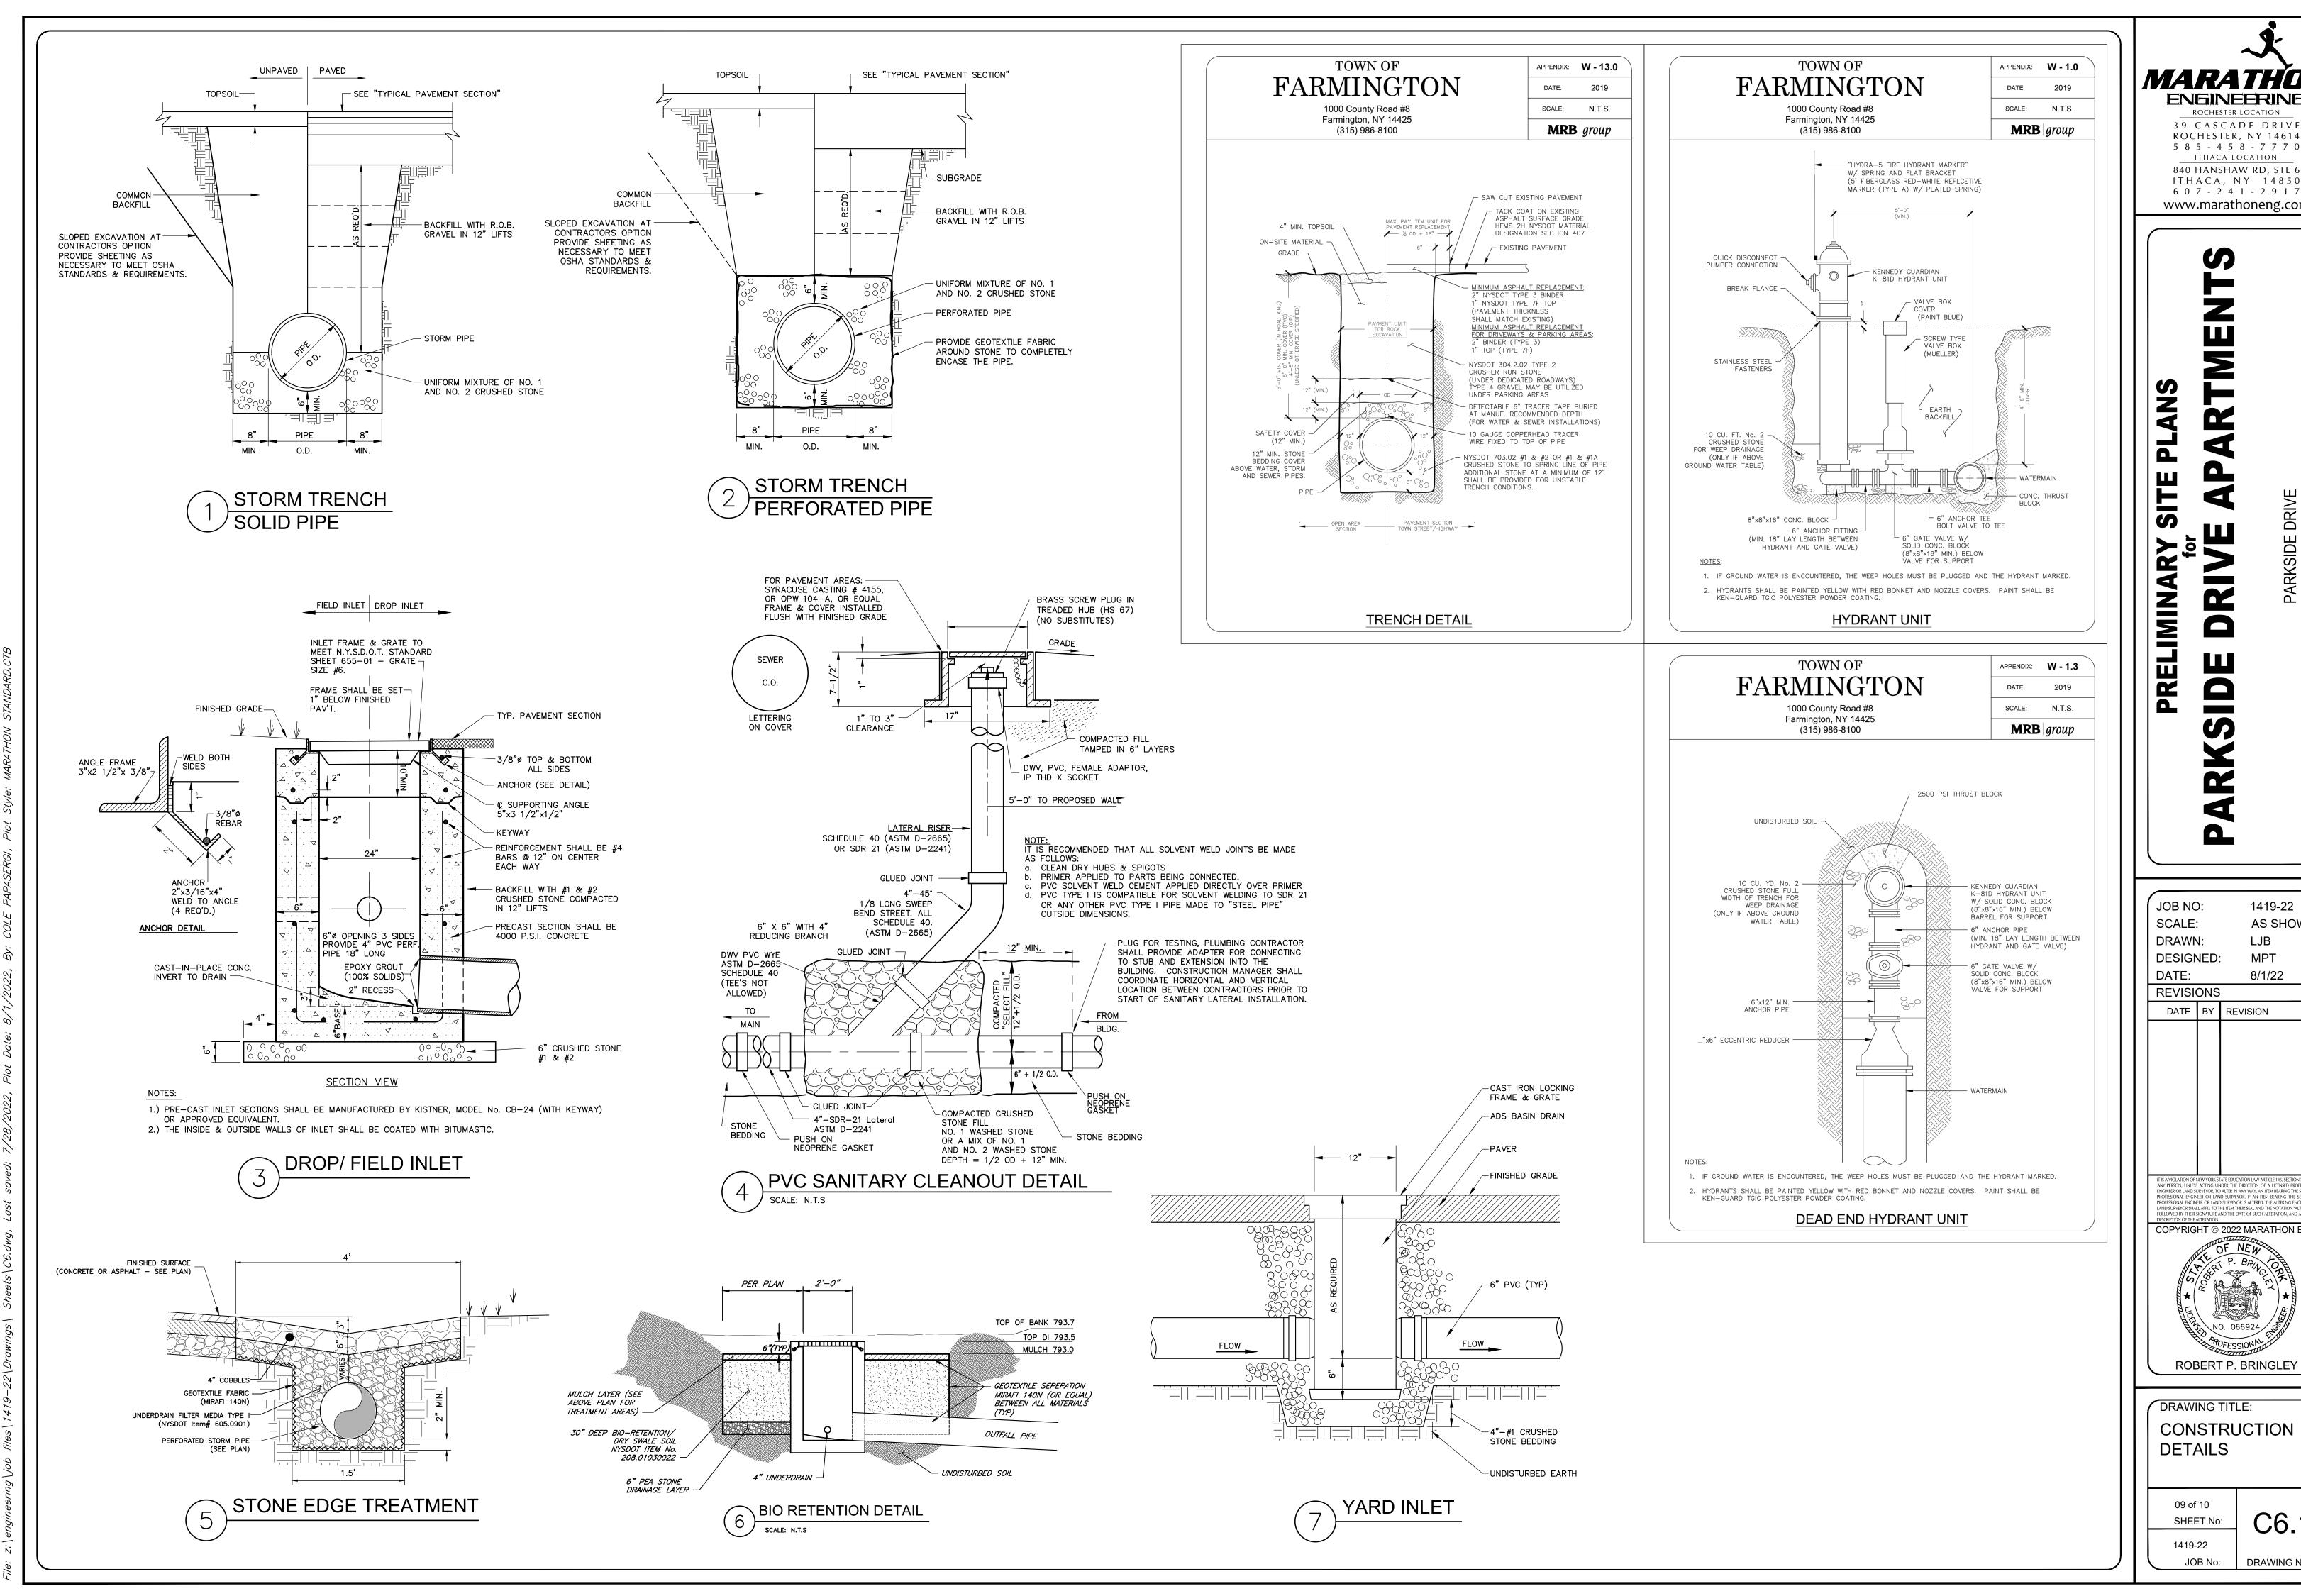
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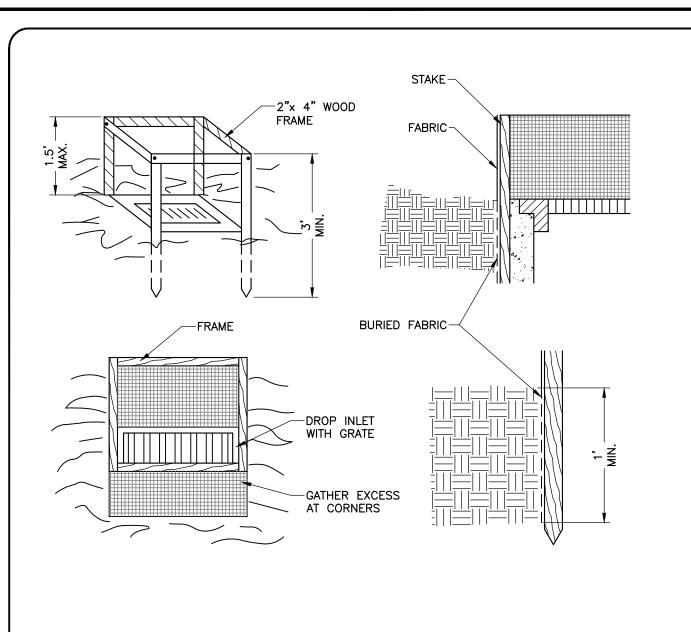
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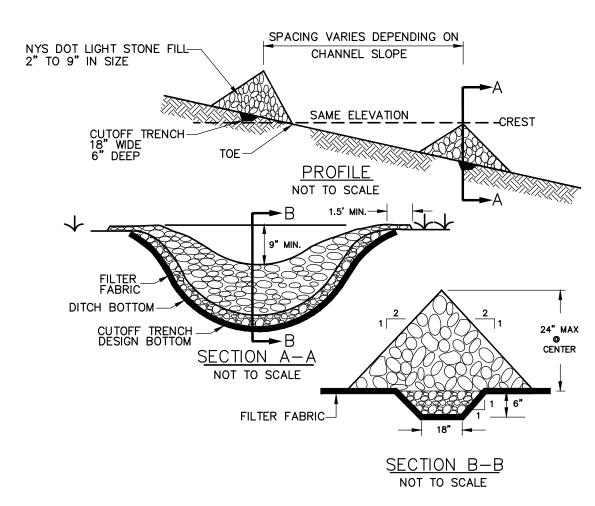
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### CONSTRUCTION SPECIFICATIONS

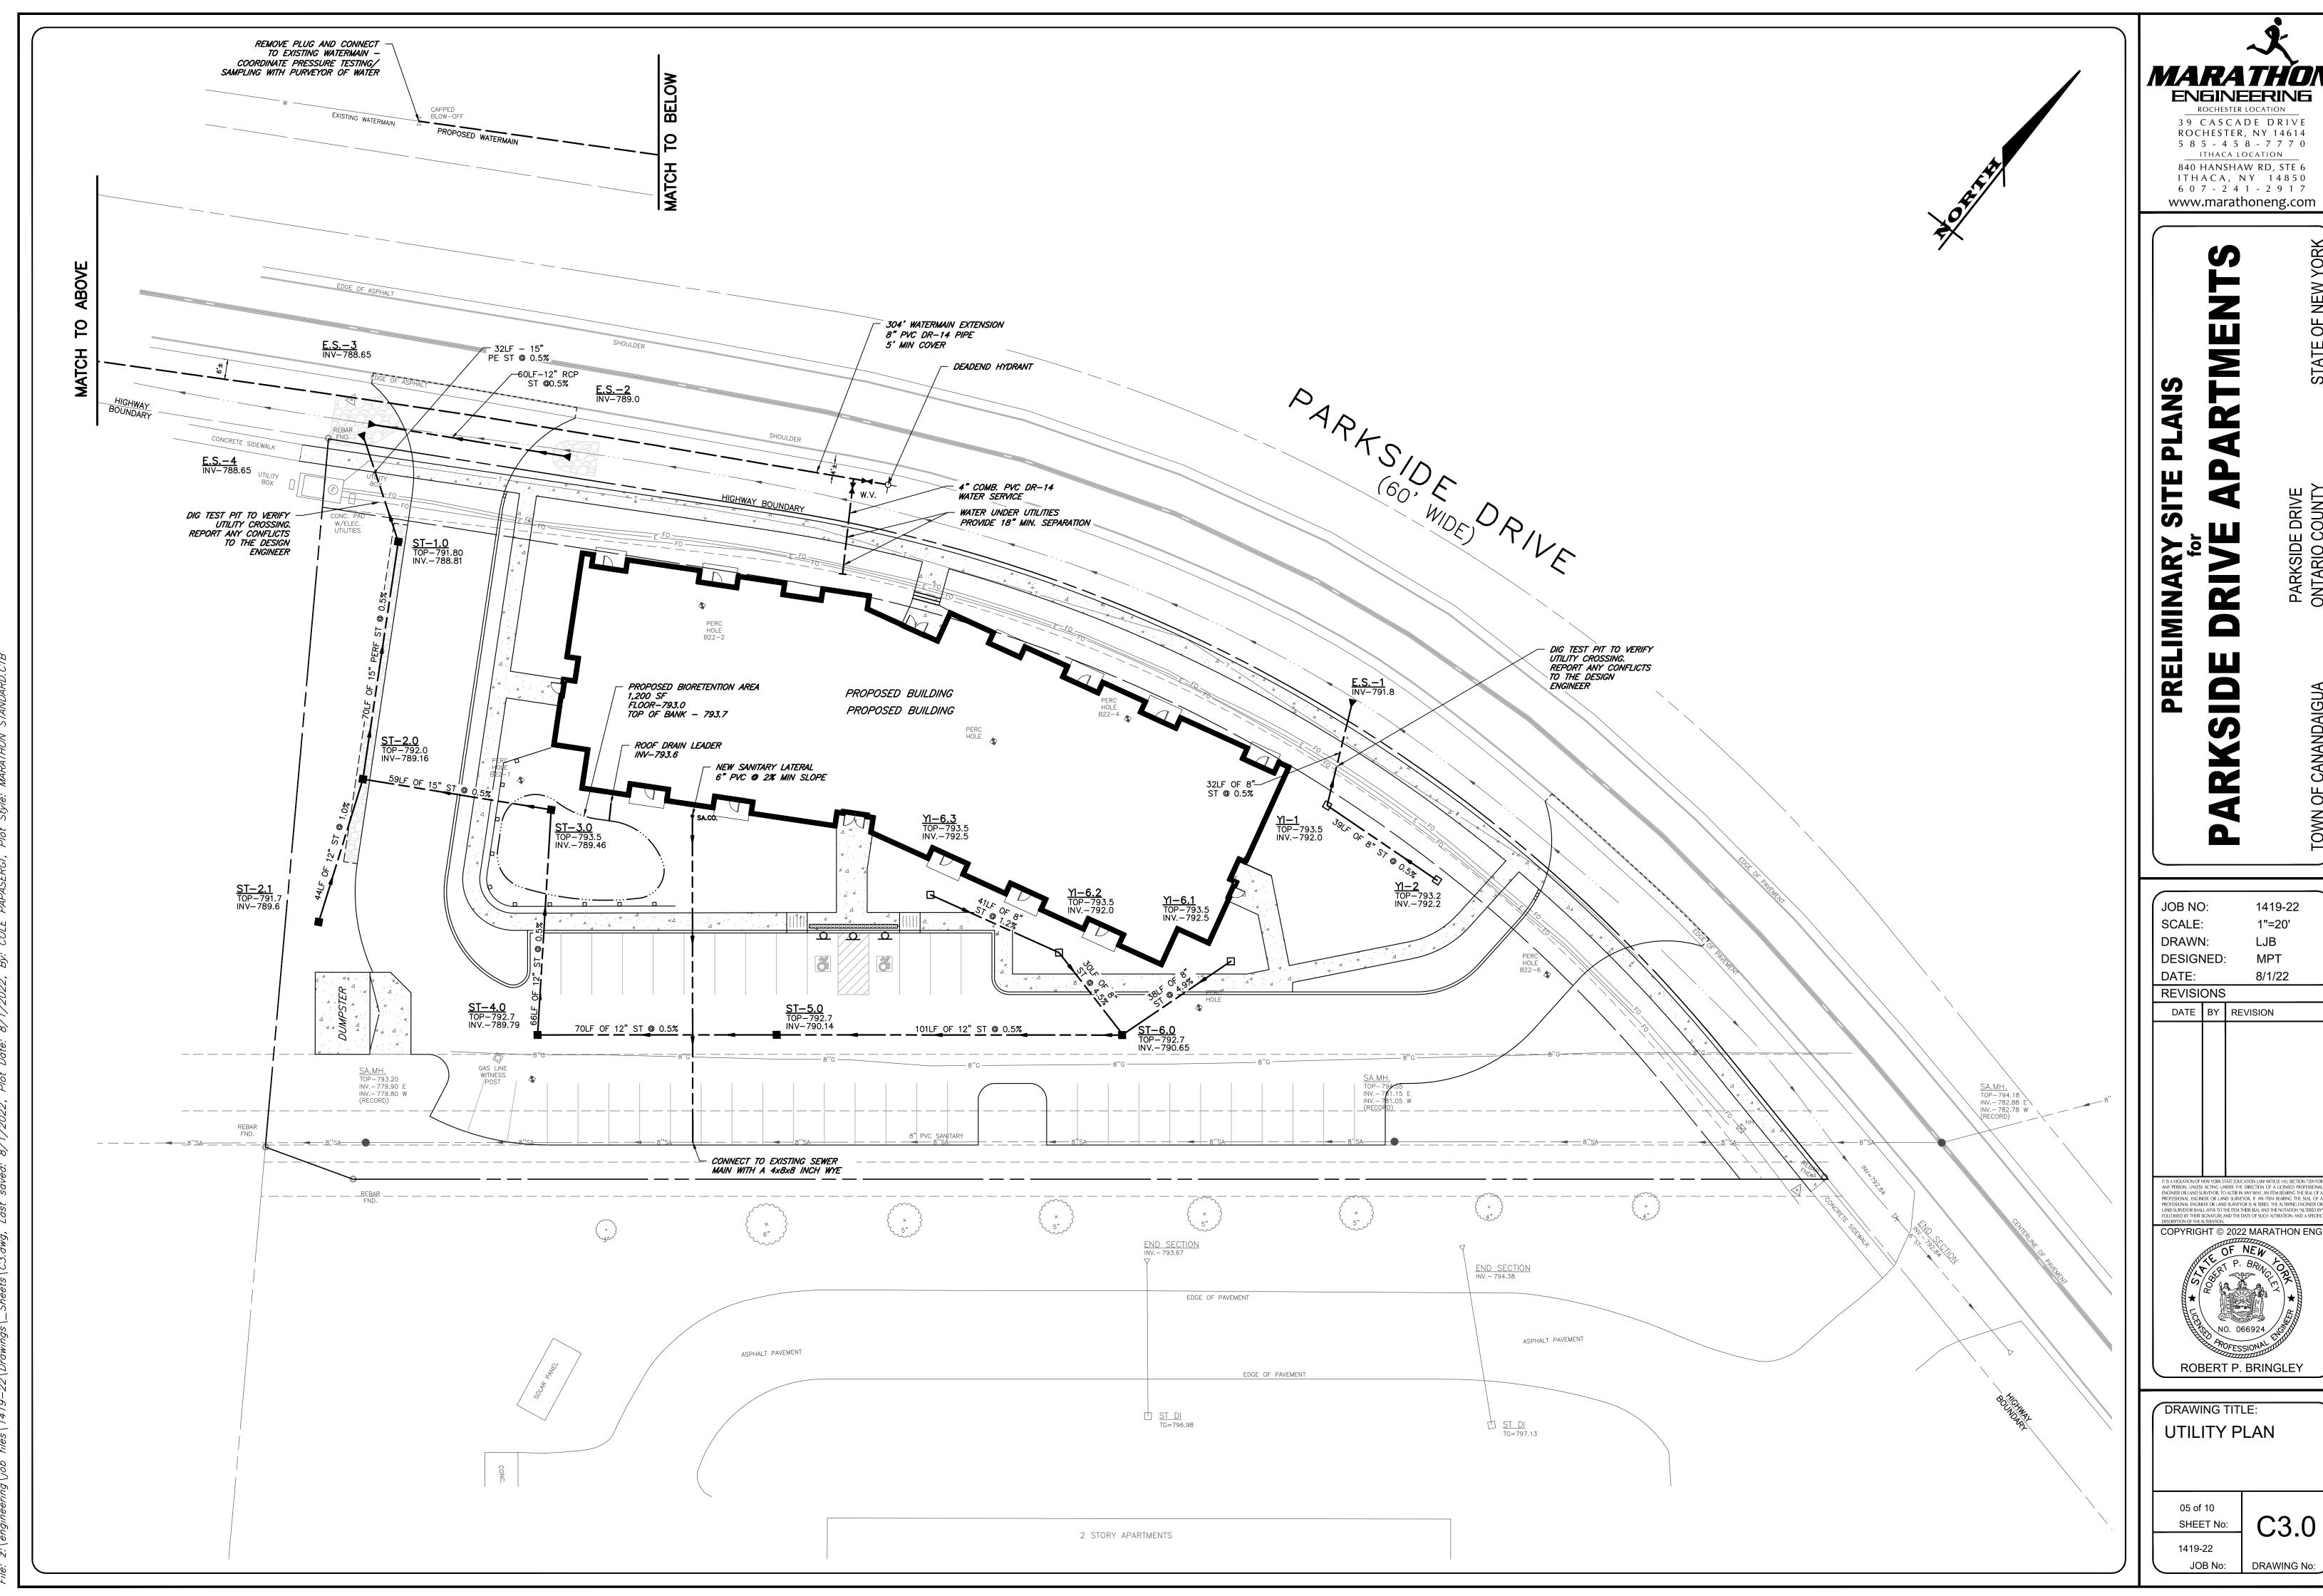
- 1. FILTER FABRIC SHALL HAVE AN EOS OF 40-85. BURLAP MAY BE USED FOR SHORT
- TERM APPLICATIONS. 2. CUT FABRIC FROM A CONTINUOUS ROLL TO ELIMINATE JOINTS. IF JOINTS ARE
- NEEDED THEY WILL BE OVERLAPPED TO THE NEXT STAKE. 3. STAKE MATERIALS WILL BE STANDARD 2" x 4" WOOD OR EQUIVALENT METAL WITH A MINIMUM
- LENGTH OF 3 FEFT 4. SPACE STAKES EVENLY AROUND INLET 3 FEET APART AND DRIVE A MINIMUM OF 18 INCHES DEEP. SPANS GREATER THAN 3 FEET MAY BE BRIDGED WITH THE USE OF WIRE MESH BEHIND THE
- 5. FABRIC SHALL BE EMBEDDED 1 FOOT MINIMUM BELOW GROUND AND BACKFILLED. IT SHALL
- BE SECURELY FASTENED TO THE STAKES AND FRAME. 6. A 2" x 4" WOOD FRAME SHALL BE COMPLETED AROUND THE CREST OF THE FABRIC FOR OVER FLOW STABILITY.




# **CONSTRUCTION SPECIFICATIONS**


- 1. STONE WILL BE PLACED ON A FILTER FABRIC FOUNDATION TO THE LINES, GRADES AND LOCATION SHOWN ON IN THE PLAN
- 2. SET SPACING OF CHECK DAMS TO ASSUME THAT THE ELEVATIONS OF THE CREST OF THE DOWNSTREAM DAM IS AT THE SAME ELEVATION OF THE UPSTREAM DAM.
- 3. EXTEND THE STONE A MINIMUM OF 1.5 FEET BEYOND THE DITCH BANKS TO PREVENT CUTTING AROUND THE DAM,
- 4. PROTECT THE CHANNEL DOWNSTREAM OF THE LOWEST CHECK DAM FROM SCOUR AND EROSION WITH STONE OR LINER AS APPROPRIATE.
- 5. ENSURE THAT CHANNEL APPURTENANCES SUCH AS CULVERT ENTRANCES BELOW CHECK DAMS ARE NOT SUBJECT TO DAMAGE OF BLOCKAGE FROM DISPLACED STONES. MAXIMUM DRAINAGE AREA - 2 ACRES

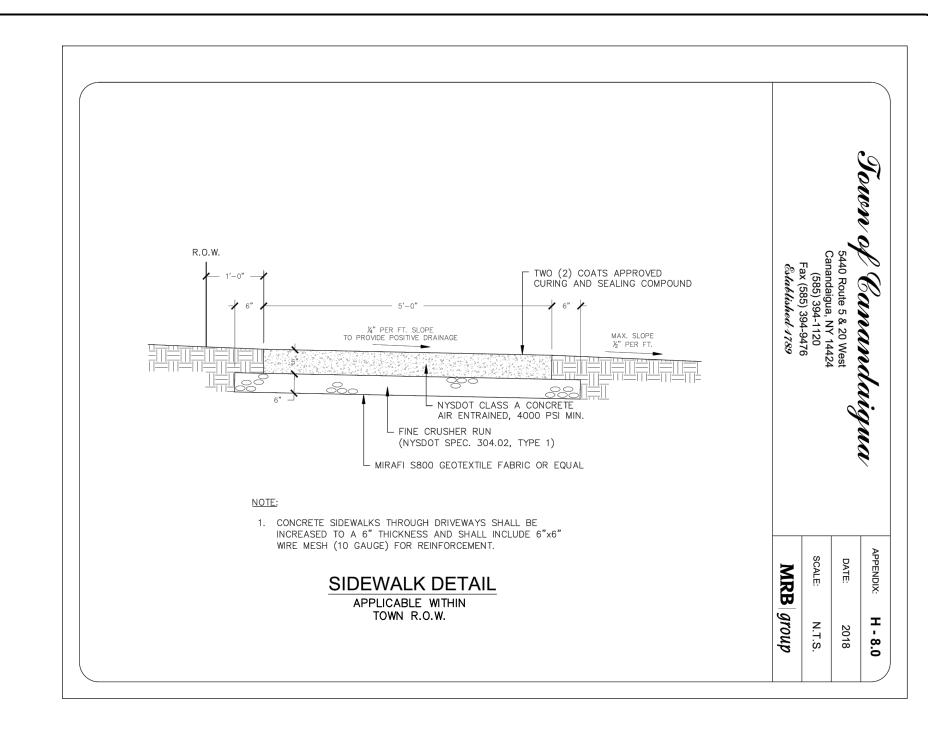

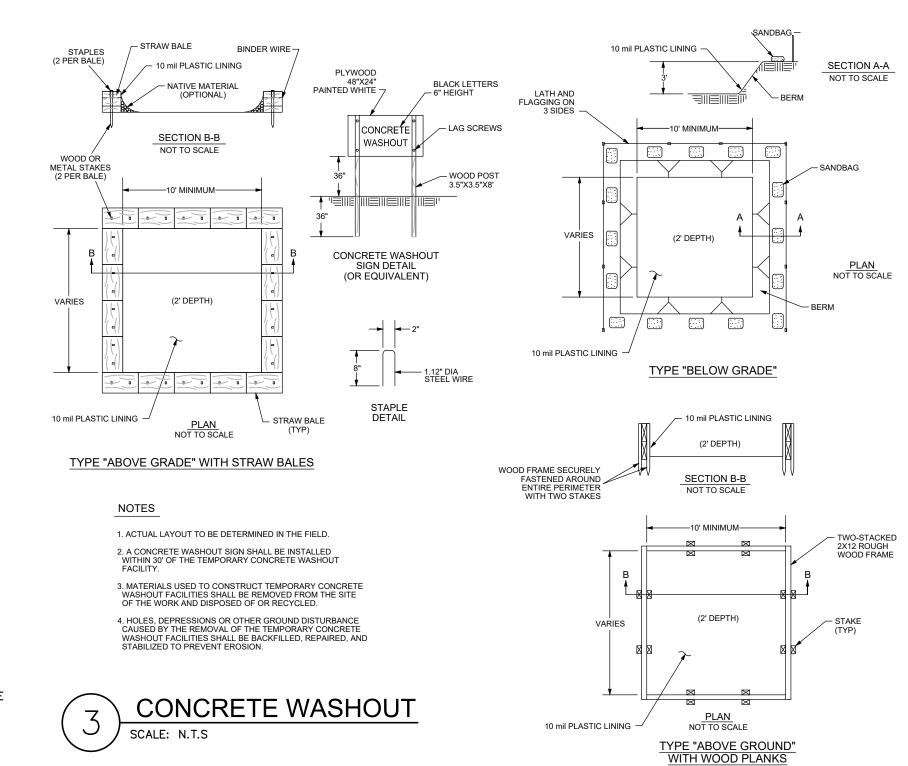

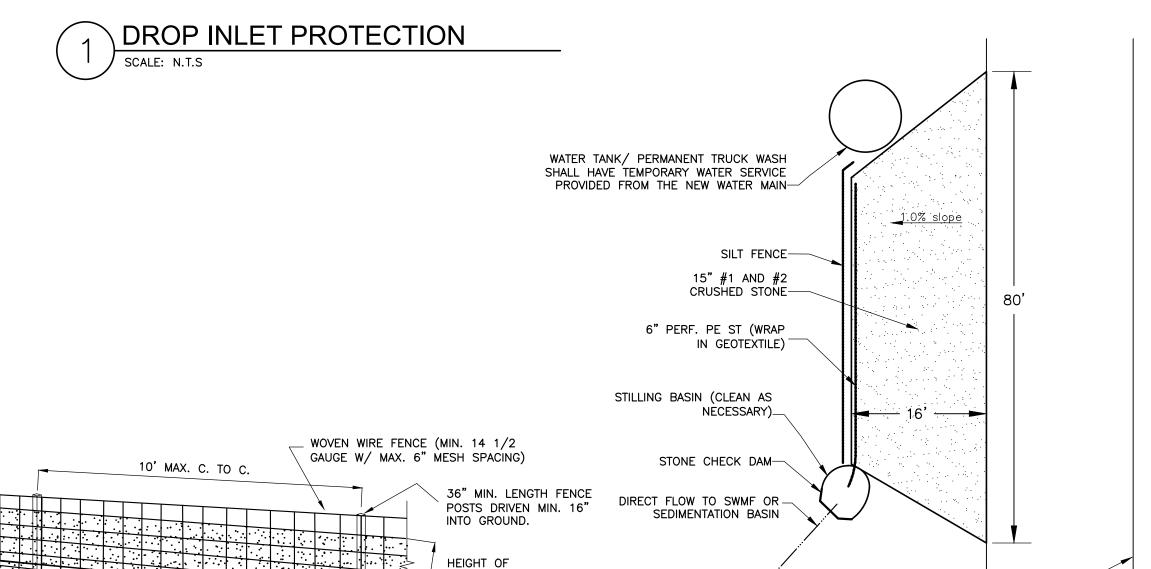

FILTER = 16"

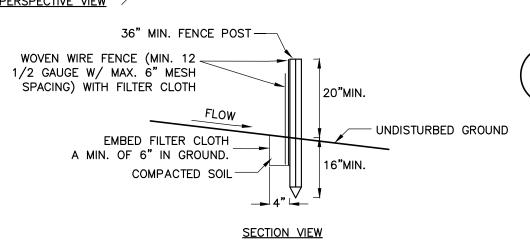

TRUCK WASH AND CONCRETE WASHOUT SCALE: N.T.S


STABILIZED CONSTRUCTION


ENTRANCE-

# CONSTRUCTION SPECIFICATIONS

- 1. WOVEN WIRE FENCE TO BE FASTENED SECURELY TO FENCE POSTS WITH WIRE TIES OR STAPLES, POSTS SHALL BE STEEL "T" OF "U" TYPE OF HARDWOOD.
- 2. FILTER CLOTH TO BE FASTENED SECURELY TO WOVEN WIRE FENCE WITH TIES SPACED EVERY 24" AT TOP AND MID SECTION. FENCE SHALL BE WOVEN WIRE, 12 1/2 GAUGE, 6" MAXIMUM MESH
- 3. WHEN TWO SECTIONS OF FILTER CLOTH ADJOIN EACH OTHER THEY SHALL BE OVERLAPPED BY SIX INCHES AND FOLDED. FILTER CLOTH SHALL BE EITHER FILTER X, MIRAFI 100X, STABLINKKA T140N, OR APPROVED EQUIVALENT.
- 4. PREFABRICATED UNITS SHALL BE GEOFAB, ENVIROFENCE, OR APPROVED EQUIVALENT.
- 5. MAINTENANCE SHALL BE PERFORMED AS NEEDED AND MATERIAL REMOVED WHEN "BULGES" DEVELOP IN THE SILT FENCE.
- 6. ENVIRO-FENCE WITH INTEGRAL MESH IS ACCEPTABLE SUBSTITUTE.



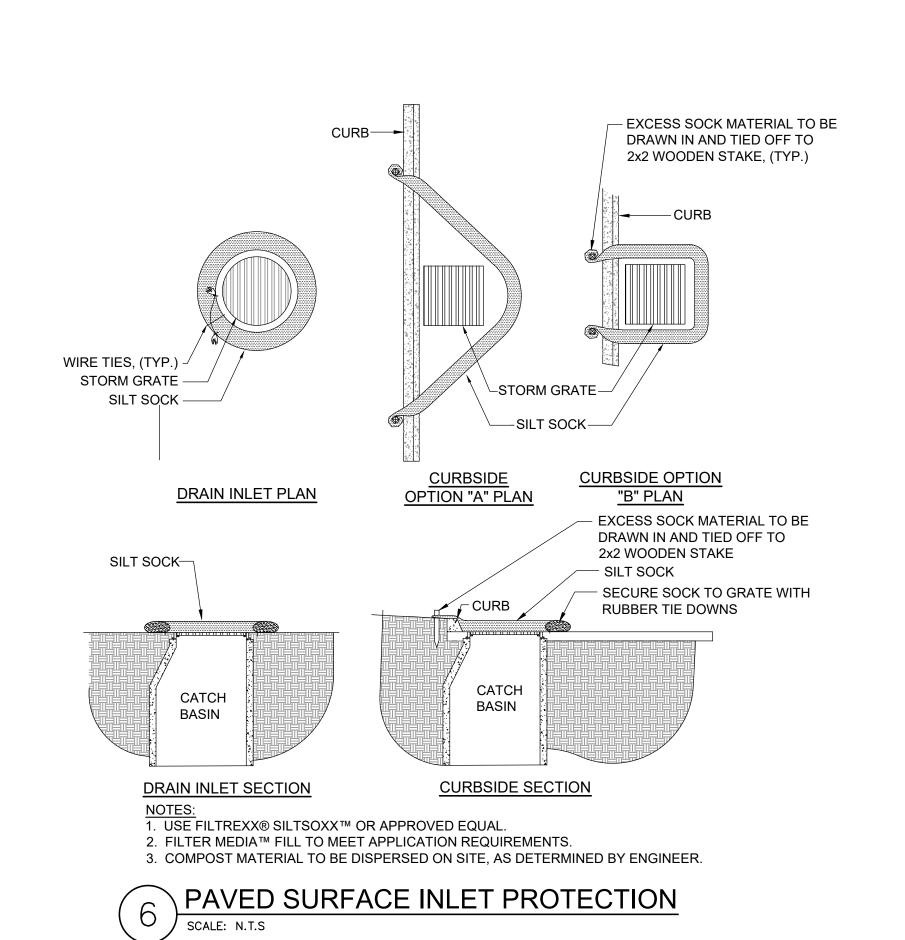

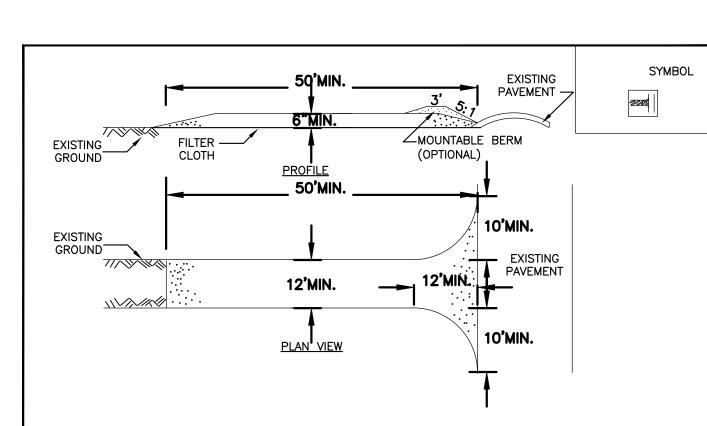

# **CONSTRUCTION SPECIFICATIONS**

- 1. STONE SIZE USE 2" STONE, OR RECLAIMED OR RECYCLED CONCRETE EQUIVALENT.
- 2. LENGTH NOT LESS THAN 50 FEET (EXCEPT ON A SINGLE RESIDENCE LOT WHERE A 30 FOOT MIN. LENGTH WOULD APPLY).
- 3. THICKNESS NOT LESS THAN SIX (6) INCHES.
- 4. WIDTH TWELVE (12) FOOT MINIMUM, BUT NOT LESS THAN THE FULL WIDTH AT POINTS WHERE INGRESS OR EGRESS OCCURS, TWENTY-FOUR (24) FOOT IF SINGLE ENTRANCE TO SITE.
- 5. FILTER CLOTH WILL BE PLACED OVER THE ENTIRE AREA PRIOR TO PLACING OF STONE.
- 6. SURFACE WATER ALL SURFACE WATER FLOWING OR DIVERTED TOWARD CONSTRUCTION ENTRANCES SHALL BE PIPED ACROSS THE ENTRANCE. IF PIPING IS IMPRACTICAL, A MOUNTABLE BERM WITHI 5:1 SLOPES WILL BE PERMITTED.
- 7. MAINTENANCE THE ENTRANCE SHALL BE MAINTAINED IN A CONDITION WHICH WILL PREVENT TRACKING OR FLOWING OF SEDIMENT ONTO PUBLIC RIGHTS-OF-WAY, ALL SEDIMENT SPILLED, DROPPED, TACKED, OR WASHED ONTO PUBLIC RIGHTS-OF-WAY MUST BE REMOVED IMMEDIATELY.
- 8. WHEN WASHING IS REQUIRED, IT SHALL BE DONE ON AN AREA STABILIZED WITH STONE AND WHICH DRAINS INTO AN APPROVED SEDIMENT TRAPPING DEVICE.
- 9. PERIODIC INSPECTION AND NEEDED MAINTENANCE SHALL BE PROVIDED AFTER EACH RAIN.

U.S. DEPARTMENT OF AGRICULTURE
NATURAL RESOURCES CONSERVATION SERVICE
NEW YORK STATE DEPARTMENT OF ENVIRONMENTAL CONSERVATION
NEW YORK STATE SOIL & WATER CONSERVATION COMMITTEE

STABILIZED CONSTRUCTION **ENTRANCE** 

ENGINEERING ROCHESTER LOCATION

39 CASCADE DRIVE

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