# PRELIMINARY OVERALL PLANS PIERCE BROOK SUBDIVISION

STATE ROUTE 21 SOUTH, T.A. NO. 97.02-1-52.1 PARRISH STREET EXTENSION, T.A.NO. 97.00-2-2 SITUATE IN:

TOWN OF CANANDAIGUA - ONTARIO COUNTY - STATE OF NEW YORK

# (1.0) GENERAL (1.1) APPLICANT: RIGHT-OF-WAY. MORRELL BUILDERS, INC. MILLER PARCEL WILKIN PARCEL 97.00-2-2.000 54.4 +/- ACRES 40.4 +/- ACRES (2.0) ZONING REGULATIONS: THE FOLLOWING SYNOPSIS IS COMPILED FROM THE TOWN CODE AND IS BASED ON THE APPLICABLE ZONING REGULATIONS FOR THIS APPLICATION: SOUTHERN CORRIDOR RESIDENTIAL SCR-1.....93.6 +/- ACRES RESIDENTIAL R1-20 .. ... 1.2 +/- ACRES TOTAL 94.8 +/- ACRES (2.2) PERMITTED DENSITY: SCR-1 1 UNIT / ACRE (5.1) OPEN SPACE R1-20 1 UNIT / 20,000 SQUARE FEET (2.3) DIMENSIONAL REQUIREMENTS FOR SCR-1 ZONING: a. MINIMUM LOT WIDTH (FT) ... b. MINIMUM SETBACKS (FT): • FRONT .. • REAR.... • SIDE ..... (5.2) NATURAL RESOURCES c. MAXIMUM BUILDING HEIGHT (FT) ..... d. MAXIMUM BUILDING COVERAGE ON LOT .......... 20%

## (3.0) CONSERVATION SUBDIVISION WE ARE REQUESTING THIS DEVELOPMENT BE CONSIDERED AS A CONSERVATION SUBDIVISION WITH INCREASED DENSITY AS ALLOWED UNDER CHAPTER 174 OF THE CODE. THE FOLLOWING

IS A SUMMARY SUPPORTING THIS REQUEST. (3.1) BASE DENSITY

CALCULATED AS (TOTAL ACREAGE – CONSTRAINED LANDS) / ALLOWABLE DENSITY

93.5 – 13.5 = 80.0 ACRES / 1 UNIT PER ACRE =

**TOTAL BASE DENSITY = 82.4 = 82 UNITS** 

80.0 UNITS

55,492 - 5,958 = 49,534 SF / 1 UNIT PER 20,000 SF =

(3.2) ADDITIONAL DENSITY:

PARAGRAPH C(1)(B) OF CHAPTER 174-16 ALLOWS FOR A 15% INCREASE BY THE TOWN BOARD WHEN "SERVED BY PUBLIC WATER AND SEWER, IF PERMANENT PUBLIC ACCESS WILL BE GRANTED TO THE PROTECTED OPEN SPACE LAND AND ANY ASSOCIATED IMPROVEMENTS".

15% OF 82 UNITS IS 12 ADDITIONAL UNITS RESULTING IN A TOTAL ALLOWABLE DENSITY OF 94 UNITS

\* ON APRIL 19, 2021, THE TOWN BOARD AUTHORIZED THE PLANNING BOARD TO

TOTAL = 92 UNITS

APPROVE UP TO A 15% DENSITY INCREASE

(4.0) PLAN DATA:

SIGNIFICANT FEATURES OF THIS FOR SALE SINGLE-FAMILY TOWN HOME DEVELOPMENT (4.1) BUILDING TYPES:

TWO-UNIT BUILDING (TYPE A) 25 = 50 UNITS

THREE-UNIT BUILDING (TYPE B) 14 = 42 UNITS

(4.2) SITE ALLOCATION

DEVELOPMENT AREA 23 +/- ACRES (24 %)

72 +/- ACRES (76%) TOTAL 95+/- ACRES (100%) (4.3) DIMENSIONAL CONTROL

MINIMUM SETBACK FROM RIGHT-OF-WAY. MINIMUM DISTANCE PRINCIPAL STRUCTURE TO EXTERNAL PROPERTY LINE...... 40 FT

(4.4) ROADWAY FRONTAGE

ALONG BUILDINGS 3,750 +/- FT (TOWN DETAIL H-2.2 "SUBDIVISION ROAD"; 22 FT WIDE WITH 30" GUTTERS

PUBLIC WATER TO TOWN OF CANANDAIGUA, LOOPED PUBLIC STORM SYSTEMS TO TOWN OF CANANDAIGUA

GAS SERVICE TO NYSEG / GENEVA GAS

- SIDEWALKS (ONE SIDE)
- TRAILS NATURAL SURFACE (I.E. GRASS) LOCATION DEFINED WITH TOWN INPUT
- OPEN SPACE (DEDICATED OR MAINTAINED BY HOA)


# (5.0) CONSERVATION SUBDIVISION SUPPORTING DATA:

THIS PLAN OFFERS 80 +/- ACRES OF TOTAL OPEN SPACE (84%) WHEREAS THE MINIMUM REQUIRED OPEN SPACE UNDER CONSERVATION EASEMENT IS 48 +/-ACRES; AN INCREASE OF 32 +/- ACRES OR 66% ABOVE REQUIREMENT

(MINIMUM OPEN SPACE IS CONSTRAINED LANDS PLUS 40% OF DEVELOPABLE

THE LONG-TERM PRESERVATION OF THESE PARCELS' NATURAL RESOURCES WITHIN THE OPEN SPACE IS ONE OF THIS APPLICATION'S MOST BENEFICIAL ASPECTS; A STANDARD SCR-1 PROPOSAL DOES NOT ACCOUNT OR ALLOW FOR THIS PROTECTION. THE TOWN'S UPDATED "NATURAL RESOURCES INVENTORY" (NRI, DATED NOV 2020) IDENTIFIES THESE RESOURCES; THE FOLLOWING SUMMARIZES HOW THIS CONSERVATION SUBDIVISION APPLICATION ADDRESSES THIS PRESERVATION.

- FARMLAND PORTIONS OF THESE PARCELS HAVE THE POTENTIAL TO BE PLANTED BY THE LOCAL FARMING COMMUNITY.
- WOODLANDS THE EXISTING 7.5 ACRES OF WOODLANDS WILL BE PROTECTED.
- LAND COVER THIS "CLUSTER" DEVELOPMENT APPROACH PRESERVES A SUBSTANTIAL AMOUNT OF NATURAL LAND COVER. FOR EXAMPLE, SCR-1 ZONING ALLOWS FOR UP TO 20% IMPERVIOUS AREA, THIS PLAN HAS ONLY APPROXIMATELY 6 – 7% IMPERVIOUS AREA.
- ENDANGERED/THREATENED SPECIES THERE ARE NO KNOWN ENDANGERED OR THREATENED SPECIES ON THESE PARCELS. A CONSERVATION SUBDIVISION WILL ALLOW FOR SIGNIFICANTLY GREATER AREA FOR THE INDIGENOUS WILDLIFE AND THE INTERCONNECTION IS BETTER THEREBY FACILITATING MOVEMENT WITHIN
- WATER RESOURCES THIS PLAN PRESERVES THE FEDERALLY PROTECTED WETLAND, STREAM CORRIDOR AND FARM POND. STORMWATER FACILITIES WILL BE DESIGNED TO MEET REGILLATIONS WHETHER THIS AREA IS DEVELOPED UNDER THE SCR-1 OR A CONSERVATION ZONING.
- PUBLIC OR PROTECTED LAND A TOWN PARK IS ADJACENT TO THIS DEVELOPMENT IMMEDIATELY TO THE WEST. THIS PROVIDES A UNIQUE OPPORTUNITY FOR CONNECTION OF THE OPEN SPACE AND THE TOWN PARK. THE APPLICANT LOOKS FORWARD TO WORKING WITH TOWN STAFF AND BOARDS TO IDENTIFY THE BEST WAY TO LEVERAGE THIS OPPORTUNITY.
- SCENIC VIEWS NO VISIBILITY OF THE DEVELOPMENT EXISTS FROM EASTERLY LOCATIONS TO THE SITE. THE ENTIRE DEVELOPMENT IS LESS THAN ELEVATION 1000. THE AREA HIGH POINT IS LOCATED FURTHER WEST APPROACHING THE PARRISH STREET EXTENSION AND RT. 21 INTERSECTION. THE EASTERN PROPERTY LINE OF THE DEVELOPMENT IS BUFFERED/HIDDEN BY THE STEEP GRADE AND MATURE TREE LINE WHICH WILL BE PRESERVED AND ENHANCED WITH THIS APPLICATION.
- STEEP SLOPES THIS SITE CONTAINS AN AREA OF 1.2 ACRES WHERE THE GRADE MEETS OR EXCEEDS 15%; THIS AREA WILL BE FULLY WITHIN THE OPEN SPACE AND THEREFORE PROTECTED.

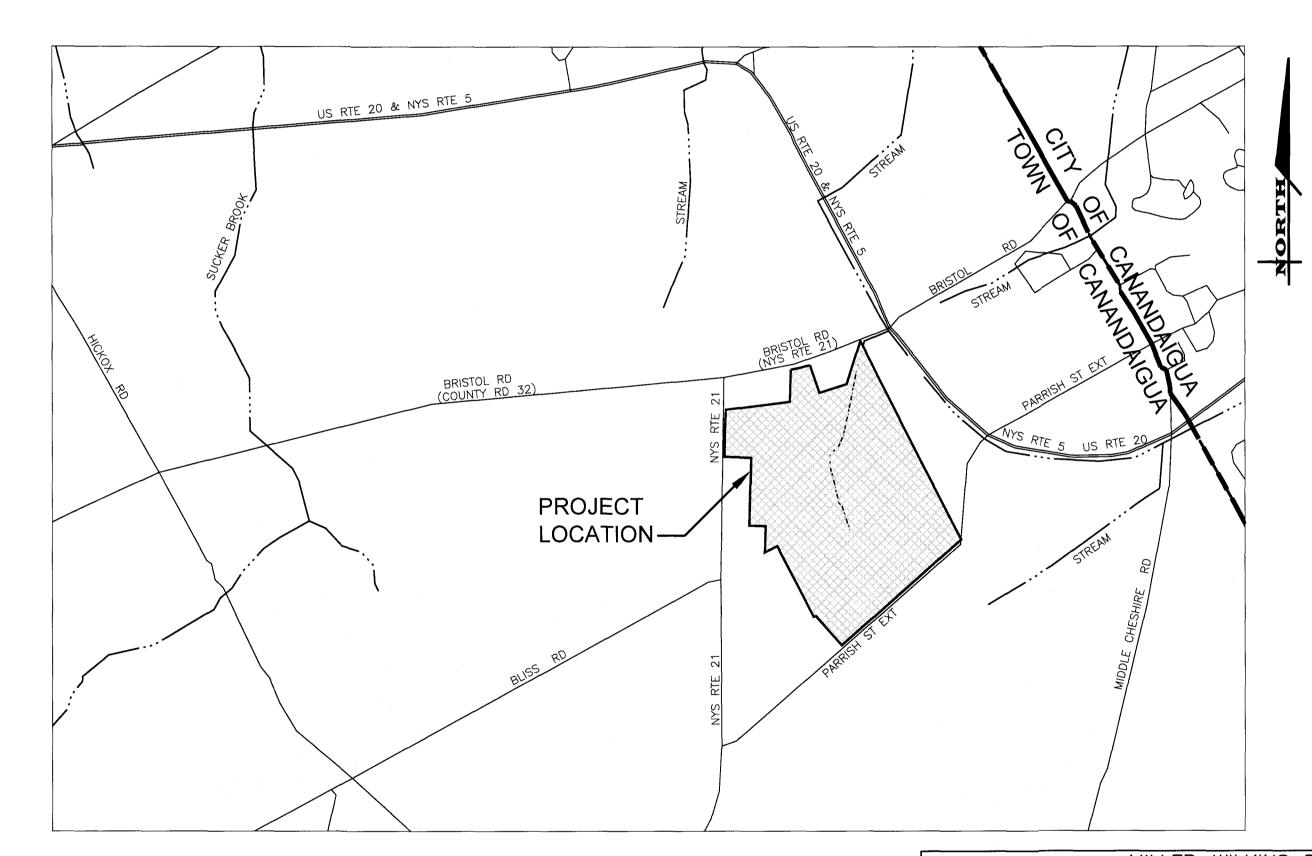

# LOCATION MAP NOT TO SCALE



ROCHESTER LOCATION 39 CASCADE DRIVE ROCHESTER, NY 14614 5 8 5 - 4 5 8 - 7 7 7 0 ITHACA LOCATION 840 HANSHAW RD, STE 12 ITHACA, NY 14850 6 0 7 - 2 4 1 - 2 9 1 7

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| MILLER-WILKINS SUBDIVISION |                |                                               |
|----------------------------|----------------|-----------------------------------------------|
|                            | LIST           | OF DRAWINGS                                   |
| SHEET NUMBER               | DRAWING NUMBER | DRAWING TITLE                                 |
| _                          | COVER          | COVER                                         |
| 1                          | C0.1           | NOTE, ABBREVIATIONS, AND SPECIFICATIONS       |
| 2                          | C1.0           | OVERALL PLAN                                  |
| 3                          | C2.0           | SUBDIVISION PLAN (SHEET 1 OF 3)               |
| 4                          | C2.1           | SUBDIVISION PLAN (SHEET 2 OF 3)               |
| 5                          | C2.2           | SUBDIVISION PLAN (SHEET 3 OF 3)               |
| 6                          | C3.0           | UTILITY PLAN (SHEET 1 OF 3)                   |
| 7                          | C3.1           | UTILITY PLAN (SHEET 2 OF 3)                   |
| 8                          | C3.2           | UTILITY PLAN (SHEET 3 OF 3)                   |
| 9                          | C4.0           | GRADING PLAN (SHEET 1 OF 3)                   |
| 10                         | C4.1           | GRADING PLAN (SHEET 2 OF 3)                   |
| 11                         | C4.2           | GRADING PLAN (SHEET 3 OF 3)                   |
| 12                         | C5.0           | EROSION AND SEDIMENT CONTROL PLAN             |
| 13                         | C5.1           | EROSION AND SEDIMENT CONTROL DETAILS          |
| 14                         | C6.0           | CENTERLINE PROFILE (SHEET 1 OF 3)             |
| 15                         | C6.1           | CENTERLINE PROFILE (SHEET 2 OF 3)             |
| 16                         | C6.2           | CENTERLINE PROFILE (SHEET 3 OF 3)             |
| 17                         | C7.0           | LANDSCAPING PLAN                              |
| 18                         | C8.0           | EXISTING CONDITIONS AND NATURAL FEATURES PLAN |
| 19                         | C9.0           | CONSTRUCTION DETAILS                          |
| 20                         | C9.1           | CONSTRUCTION DETAILS                          |
| 21                         | C9.2           | CONSTRUCTION DETAILS                          |
|                            |                |                                               |

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## **GENERAL NOTES**

- 1. MAPPING THE EXISTING UNDERGROUND UTILITIES WERE PLOTTED BASED ON RECORD MAPPING SUPPLIED BY OTHERS. THE ENGINEER MAKES NO WARRANTY AS TO THE LOCATION, SIZE, TYPE, ELEVATION, AND/OR NUMBER OF EXISTING UTILITIES. THE CONTRACTOR SHALL BE RESPONSIBLE FOR DETERMINING THE HORIZONTAL AND VERTICAL LOCATION OF UTILITIES IN THE VICINITY OF THE NEW INFRASTRUCTURE.
- 2. UTILITY STAKEOUT THE CONTRACTOR SHALL NOTIFY DIG SAFELY NEW YORK (1-800-962-7962) FOR A UTILITY STAKEOUT 48 HOURS IN ADVANCE OF COMMENCING WORK. STAKEOUT OF PRIVATE UTILITIES SHALL BE COORDINATED
- 3. PROPERTY PROTECTION THE CONTRACTOR IS RESPONSIBLE FOR DAMAGE TO EXISTING PAVEMENT, CURBS. WALKS, LAWNS, TREES, ETC. CAUSED BY THEIR CONSTRUCTION OPERATIONS. ALL DAMAGE SHALL BE REPAIRED OR REPLACED BY THE CONTRACTOR TO THE OWNER'S SATISFACTION AT NO ADDITIONAL EXPENSE.
- 4. ACCESS THE CONTRACTOR SHALL PROVIDE SATISFACTORY VEHICULAR ACCESS TO ALL ADJOINING PROPERTIES, PRIVATE ROADWAYS, PARKING FACILITIES, AND PUBLIC STREETS DURING CONSTRUCTION.
- 5. SITE SAFETY PRIOR TO AND THROUGHOUT CONSTRUCTION, THE CONTRACTOR SHALL POST SIGNAGE IN CONFORMANCE WITH THE REQUIREMENTS OF THE LOCAL MUNICIPALITY AND OCCUPATIONAL HEALTH AND SAFETY ACT (OHSA). JOB SAFETY AND MAINTENANCE AND PROTECTION OF TRAFFIC IS THE RESPONSIBILITY OF THE CONTRACTOR.
- 6. **EXCAVATIONS** ALL EXCAVATIONS SHALL BE BACKFILLED/BARRICADED TO THE SATISFACTION OF THE OWNER'S REPRESENTATIVE AT THE CONCLUSION OF EACH WORKING DAY.
- 7. MAINTENANCE PUBLIC STREETS, PRIVATE DRIVES AND PARKING FACILITIES SHALL BE KEPT FREE OF FOREIGN MATERIALS. ALL AREAS SHALL BE SWEPT CLEAN AT THE END OF EACH WORKING DAY AND/OR AS DIRECTED BY THE OWNER'S ON-SITE REPRESENTATIVE.
- 8. CONSTRUCTION STORAGE STORAGE OF EQUIPMENT AND MATERIALS SHALL BE WITHIN A SPECIFIED AND SECURED AREA AS DETERMINED IN CONTRACT DOCUMENTS OR AS SPECIFIED BY THE OWNER'S ON-SITE
- 9. PERMIT(S) PRIOR TO CONSTRUCTION. THE CONTRACTOR SHALL OBTAIN THE NECESSARY PERMITS FROM THE APPLICABLE MUNICIPALITY OR AGENCY. THE CONTRACTOR IS RESPONSIBLE FOR ALL BONDS AND INSURANCES AND THE OWNER IS RESPONSIBLE FOR PERMIT FEES UNLESS OTHERWISE STATED IN THE OWNER/ CONTRACTOR
- 10. INTERIM CONDITIONS THE CONTRACTOR IS RESPONSIBLE TO MAINTAIN POSITIVE DRAINAGE AWAY FROM BUILDINGS AND WITHIN PROJECT AREA TO A STABILIZED OUTLET THROUGHOUT THE CONSTRUCTION PERIOD. THIS MAY REQUIRE INTERIM GRADING, SHIMMING OF PAVEMENT ETC. THAT IS NOT SPECIFICALLY SHOWN ON THE PLANS AND SHALL BE THE RESPONSIBILITY OF THE CONTRACTOR

## **CONSTRUCTION NOTES**

- 1. STAKEOUT THE CONSTRUCTION STAKEOUT SHALL BE PERFORMED BY A LICENSED LAND SURVEYOR USING CONTROL PROVIDED ON THESE PLANS. ANY DISCREPANCIES SHALL BE REPORTED TO THE DESIGN ENGINEER (PRIOR TO THE INSTALLATION OF IMPROVEMENTS) FOR COORDINATION AND CLARIFICATION.
- 2. DEMOLITION CLEARING AND GRUBBING SHALL BE LIMITED TO THE SITE BOUNDARIES OR WITHIN THE "WORK LIMIT LINE" AS DEFINED ON THE PLAN. TREES AND OBJECTS DESIGNATED FOR REMOVAL SHALL BE COORDINATED AND FIELD VERIFIED WITH PROJECT ON-SITE REPRESENTATIVE. ALL MATERIALS SHALL BE LEGALLY DISPOSED OF OFF-SITE OR RETURNED TO OWNER AS DIRECTED BY CONTRACT DOCUMENTS. ALL ITEMS NOT SPECIFICALLY CALLED OUT TO BE
- 3. COORDINATION THE CONTRACTOR SHALL COORDINATE INSTALLATION OF UTILITY WORK WITH OTHER SITE UTILITIES (I.E. GAS, ELECTRIC, LIGHTING, COMMUNICATIONS) TO AVOID POTENTIAL INSTALLATION CONFLICTS.
- 4. STAGING AS DEFINED BY THE CONTRACT DOCUMENTS THE CONTRACTOR SHALL CONSTRUCT A SECURE STAGING AREA FOR STORAGE OF EQUIPMENT, MATERIALS, EMPLOYEE PARKING AND OFFICE SPACE. IF THE AREA/METHOD IS NOT SPECIFICALLY DEFINED ON THE DOCUMENTS THEN IT SHALL BE COORDINATED WITH THE OWNER'S ON-SITE
- 5. CLOSE-OUT THE CONTRACTOR'S WORK SCOPE INCLUDES BUT IS NOT LIMITED TO THE FOLLOWING AT PROJECT
- CLOSE-OUT TO THE SATISFACTION OF OWNER'S ON-SITE REPRESENTATIVE:
- REMOVAL OF ANY CONSTRUCTION DEBRIS
- CLEANING PAVEMENT AND WALKWAY SURFACES. RESTORATION OF ALL DISTURBED GRASS AND LANDSCAPED AREAS.
- PROVIDING BONDS, GUARANTEES, CERTIFICATIONS, ETC. AS REQUIRED BY CONTRACT DOCUMENTS.
- PROVIDING A RECORD DRAWING
- COMPLETION OF FINAL PUNCH LIST ITEMS

# **UTILITY NOTES**

- 1.1 REGULATIONS STORM SEWERS AND APPURTENANCES SHALL BE CONSTRUCTED IN CONFORMANCE WITH THE LATEST REGULATIONS OF THE MUNICIPALITY.
- 1.2 MATERIALS THE CONTRACTOR MAY USE THE FOLLOWING PIPE MATERIAL FOR THE MAIN SEWER AS ALLOWED BY THE MUNICIPALITY, PROVIDING THAT THE ROUGHNESS COEFFICIENT ("N" FACTOR) IS 0.013 OR
  - REINFORCED CONCRETE PIPE (RCP), CLASS III • HIGH DENSITY CORRUGATED POLYETHYLENE PIPE (PE), AASHTO M-29, TYPE S, ASTM D-3350.
- 1.3 ROOF DRAINAGE ALL ROOF DRAINAGE AND SUMP PUMPS SHALL BE DISCONNECTED TO THE REAR OF THE LOT OR CONNECTED TO STORM SEWERS AS INDICATED ON THE PLANS.
- 1.4 TESTING UPON COMPLETION OF SYSTEM INSTALLATION, THE MAIN SEWER SYSTEM AND LEADS TO
- STRUCTURES SHALL BE FLUSHED AND LAMPED TO THE SATISFACTION OF THE MUNICIPALITY.
- 2. PUBLIC WATER EXTENSION NOTES CANANDAIGUA CONSOLIDATED WATER DISTRICT AND NEW YORK STATE DEPARTMENT OF HEALTH
- 2.1 SPECIFICATIONS WATER MAINS AND APPURTENANCES TO BE CONSTRUCTED IN ACCORDANCE WITH THE REGULATIONS AND SPECIFICATIONS OF THE TOWN OF CANANDAIGUA WATER DEPARTMENT AND NYSDOH. 2.2 MATERIAL:
- WATER MAIN(S) SHALL BE 8" DR-14 PVC PLASTIC.
- WATER SERVICE(S)
- A. CORPORATIONS STOP SHALL BE MUELLER H-1500B COMPRESSION TYPE. B. CURB STOPS SHALL BE MUELLER H-15209 MARK ILCOMPRESSION TYPE
- C. CURB BOXES SHALL BE MUELLER H-10334, 5 FEET JONG WITH STAINLESS STEEL RODS AND STAINLESS STEEL KEYS. CURB BOXES SHALL NOT BE LOCATED WITHIN DRIVEWAYS. D. COPPER SERVICES SHALL BE TYPE "K" ASTM BBB
- E. PLASTIC SERVICES SHALL BE COPPER TUBE SIZE {CTS} AT 200 PSI, WITH A MINIMUM 1 INCH PIPE DIAMETER (ONLY
- USED FROM CURB BOX TO UNIT AND A CONTINUOUS #10 GAUGE COPPER TRACER WIRE SHALL BE INCLUDED FROM THE CURB BOX TO THE STRUCTURE]. SAND BEDDING SHALL BE PROVIDED AS APPROPRIATE. F. POLYETHYLENE ASTM 0-2737, PE 340B PER AWWA C-901 (MINIMUM 5'-0" DEPTH AND SAND ENCASEMENT REQUIRED)
- G. ALL SERVICES TAPPED INTO MAINS SHALL UTILIZE DOUBLE STRAP SS SADDLE (MUELLER) WITH A MUELLER H. ANY SERVICES LARGER THAN 1" SHALL MEET THE MINIMUM SPECIFICATIONS OF THE WATER SUPERINTENDENT. I. REFER TO TYPICAL WATER SERVICE DETAIL ON SHEET C9.2.
- WATER METER(S) SHALL BE LOCATED ON THE INTERIOR OF EXTERIOR WALLS IMMEDIATELY UPON SERVICE ENTRANCE INTO THE BUILDING(S). ON METERED SERVICES REQUIRING A 1 1/2-INCH OR LARGER METER A BYPASS AROUND THE METER IS REQUIRED.
- ALL GATE VALVES SHALL HAVE STAINLESS STEEL BODY AND BONNET BOLTS.
- ALL WATERMAIN MATERIALS AND GATE VALVES ARE TO BE MUELLER AND ALL CAST IRON FITTINGS ARE TO BE TYLER.
- HYDRANTS ARE TO BE PAINTED RED WITH BONNETS PAINTED AS PER THE AWWA HYDRANT COLOR CODE AS SHOWN IN THE HYDRANT UNIT DETAIL ON SHEET C9.2. ALL VALVE BOX COVERS SHALL BE PAINTED BLUE.

#### 2. PUBLIC WATER EXTENSION NOTES (CON'T)

• PRESSURE - THE WATER MAIN SHALL BE PRESSURE/LEAKAGE TESTED IN ACCORDANCE WITH THE MINIMUM REQUIREMENTS OF THE AWWA STANDARD C605 (LATEST REVISION) OR IN ACCORDANCE WITH MORE STRINGENT REQUIREMENTS IMPOSED BY THE CANANDAIGUA WATER DEPARTMENT.

## • HEALTH SAMPLE

- THE WATER MAIN SHALL BE DISINFECTED EQUAL TO AWWA STANDARD SPECIFICATIONS, DESIGNATION C-651, BY USING THE CONTINUOUS FEED METHOD. AFTER FLUSHING AND DISINFECTING THE WATER MAIN, WATER SAMPLES SHALL BE COLLECTED FROM THE MAIN BY THE TOWN OF CANANDAIGUA WATER DEPARTMENT AND RESULTS PROVIDED TO NYSDOH.
- TWO CONSECUTIVE DAYS OF ACCEPTABLE BACTERIOLOGICAL SAMPLE RESULTS ARE REQUIRED. FIRE HYDRANTS ARE NOT ACCEPTABLE SAMPLING POINTS. APPROVAL AND NOTIFICATION BY THE HEALTH DEPARTMENT MUST BE RECEIVED BEFORE THE MAIN IS PLACED IN SERVICE.

- WATER MAINS AND ALL WATER SERVICE LINES SHALL HAVE A MINIMUM OF FIVE FEET OF COVER FROM FINISHED GRADE IN LAWN AREAS AND A MINIMUM OF SIX FEET OF COVER FROM FINISHED GRADE IN
- TRACER WIRE IS TO BE PLACED WITH THE WATERMAIN AND LOOPED AT THE FIRE HYDRANTS.
- MINIMUM VERTICAL SEPARATION BETWEEN WATER MAINS AND SEWER PIPELINES SHALL BE 18 INCHES MEASURED FROM THE OUTSIDE OF THE PIPES AT THE POINT OF CROSSING. ONE FULL STANDARD LAYING LENGTH OF WATER MAIN SHALL BE CENTERED UNDER OR OVER THE SEWER SO THAT BOTH JOINTS WILL BE AS FAR FROM THE SEWER AS POSSIBLE. IN ADDITION, WHEN THE WATER MAIN PASSES UNDER A SEWER, ADEQUATE STRUCTURAL SUPPORT (COMPACTED SELECTED FILL) SHALL BE PROVIDED FOR THE SEWER TO PREVENT EXCESSIVE DEFLECTIONS OF JOINTS AND SETTLING OF THE SEWER ON THE WATER MAIN. MINIMUM HORIZONTAL SEPARATION BETWEEN PARALLEL WATER MAINS AND SEWER PIPES (INCLUDING MANHOLES AND VAULTS) SHALL BE 10 FEET MEASURED FROM THE OUTSIDE OF THE PIPES, MANHOLES, OR VAULTS.
- FIRE HYDRANT WEEP HOLES (DRAINS) SHALL BE PLUGGED WHEN GROUND WATER IS ENCOUNTERED WITHIN SEVEN FEET OF THE FINISHED GRADE.
- ALL MECHANICAL JOINT FITTINGS (TEES, BENDS, PLUGS, ETC.) SHALL BE BACKED WITH 3000 PSI CONCRETE THRUST BLOCKS AS SHOWN IN THE WATERMAIN THRUST BLOCK SCHEDULE ON SHEET C9.2.
- THERE ARE NO KNOWN SOIL CHARACTERISTICS REQUIRING SPECIAL INSTALLATION MEASURES (WRAPPING PIPE, ETC.). IF CONTRACTOR ENCOUNTERS SOILS DURING INSTALLATION THAT MAY REQUIRE SPECIAL INSTALLATION MEASURES NOT INCLUDED IN THIS DOCUMENT, THE CONTRACTOR SHALL CONTACT THE ENGINEER FOR OBSERVATION AND
- THE TOWN OF CANANDAIGUA WATER SUPERINTENDANT IS TO BE CONTACTED TO INSPECT WATERMAIN MATERIALS
- 2.5 FLUSHING WATER MAINS DESIGNATION C651 (LATEST REVISION). FOLLOWING DISINFECTION, THE WATER MAIN SHALL BE FLUSHED UNTIL THE CHLORINE CONCENTRATION IN THE WATER LEAVING THE MAIN IS NO HIGHER THAN THAT GENERALLY PREVAILING IN THE SYSTEM. FLUSHING OF THE WATER MAIN MUST BE WITNESSED BY THE TOWN OF CANANDAIGUA WATER DEPARTMENT EMPLOYEES. THE TOWN OF CANANDAIGUA WILL PROVIDE A DE-CHLORINATION DEVICE FOR THE SUPER-CLORINATED WATER.

- THE WATER MAIN SHALL BE DISINFECTED EQUAL TO AWWA STANDARD FOR DISINFECTING WATER MAINS DESIGNATION C651 (LATEST REVISION), FOLLOWING DISINFECTION, THE WATER MAIN SHALL BE FLUSHED UNTIL THE CHLORINE CONCENTRATION IN THE WATER LEAVING THE MAIN IS NO HIGHER THAN THAT GENERALLY PREVAILING IN THE SYSTEM
- ALL WATER MAIN FITTINGS NOT RECEIVING 24-HOUR CHLORINE DISINFECTION CONTACT TIME MUST BE SWAB DISINFECTED 30 MINUTES PRIOR TO INSTALLATION.
- FIRE HYDRANTS ARE NOT ACCEPTABLE SAMPLING POINTS

## 2.7 SAMPLING - THE SAMPLING POINT(S) MUST BE DECONTAMINATED BY FLAMING.

- SAMPLING SHALL NOT BE PERFORMED PRIOR TO RECEIPT FROM A NEW YORK STATE LICENSED OR REGISTERED DESIGN PROFESSIONAL (ENGINEER, ARCHITECT OR LAND SURVEYOR WITH A SPECIAL EXEMPTION UNDER SECTION 7208(N) OF THE EDUCATION LAW) CERTIFYING THAT THE WATER SUPPLY IMPROVEMENTS. TESTING AND DISINFECTION PROCEDURES WERE COMPLETED IN ACCORDANCE WITH THE APPROVED PLANS. REPORTS. SPECIFICATIONS AND ANY APPROVED AMENDMENTS. SAMPLES SHALL BE COLLECTED FOR FREE CHLORINE RESIDUAL, TOTAL COLIFORM, ESCHERICHIA COLI (E. COLI) AND TURBIDITY.
- THE WATER MAIN SHALL NOT BE PLACED INTO SERVICE UNTIL SO AUTHORIZED BY THE NEW YORK STATE DEPT
- TOWN OF CANANDAIGUA WATER DEPARTMENT WILL COLLECT SAMPLES.

# **EARTHWORK NOTES**

- 1. PREPARATION PRIOR TO START OF EARTHWORK OPERATIONS THE CONTRACTOR SHALL COMPLETE THE FOLLOWING APPLICABLE ITEMS AS DEFINED BY CONTRACT DOCUMENTS:
- SITE DEMOLITION REMOVAL AND DISPOSAL OFF-SITE IN A LEGAL MANNER; STRUCTURES, UTILITIES,
- CLEARING AND GRUBBING REMOVAL AND DISPOSAL OFF-SITE IN A LEGAL MANNER; TREES, BRUSH,
- TOPSOIL STRIPPING STRIP AND STOCKPILE TOPSOIL FOR REUSE. EXCESS TOPSOIL MAY BE REMOVED FROM SITE WITH APPROVAL BY OWNER AND MUNICIPALITY.
- 2. **RESPONSIBILITY** THE CONTRACTOR IS RESPONSIBLE FOR:
- ESTIMATE COMPLETION OF A QUANTITY TAKEOFF TO DETERMINE THE VOLUME OF CUT, FILL, AND TOPSOIL.
- COMPARE AND COORDINATE WITH INFORMATION PROVIDED BY THE DESIGN ENGINEER. • GRADE TOLERANCES - ESTABLISHING DESIGN SUBGRADE ELEVATIONS TO WITHIN ONE TENTH OF ONE FOOT (0.10') IN PAVEMENT AREAS (INCLUDING WALKS) AND TO WITHIN THIRTY-THREE HUNDREDTHS OF ONE FOOT (0.33')
- FOR ALL REMAINING AREAS. • COMPACTION - ACHIEVING THE SPECIFIED MINIMUM COMPACTION VALUES FOR EMBANKMENT/FILL AREAS. THE
- TERMS "FILL" AND EMBANKMENT" ARE INTERCHANGEABLE. • CUTS - ONCE EXCAVATIONS ARE SHAPED TO THE DESIGN GRADES THE AREAS SHALL BE PROTECTED TO ASSURE THAT THE INTEGRITY OF MATERIAL IS NOT COMPROMISED BY CONSTRUCTION VEHICLES AND/OR IMPROPER DRAINAGE. AREAS DETERMINED BY CONTRACTOR TO BE NOT SUITABLE FOR SUBGRADE PLACEMENT SHALL BE
- IMMEDIATELY REPORTED WHEN THE SUBGRADE IS ESTABLISHED TO OWNER'S REPRESENTATIVE. STABILIZATION MEASURES FOR CUT AREAS MAY BE CONSIDERED BY OWNER'S REPRESENTATIVE AS A CHANGE TO THE BASE
- 3. **TESTING** THE FOLLOWING MAXIMUM DRY DENSITIES SHALL BE ACHIEVED AS MEASURED BY THE MODIFIED PROCTOR METHOD ASTM D-1557:
- 95% UNDER PAVEMENTS, WALKS, AND IN STRUCTURAL FILL AREAS 85% IN REMAINING AREAS
- THE AGREEMENT BETWEEN THE OWNER AND CONTRACTOR SHALL DEFINE THE NUMBER OF TESTS AND RESPONSIBILITY. WE RECOMMEND IN EMBANKMENT AREAS ONE PER LIFT AND/OR ONE PER 1,000 CUBIC YARDS.
- THE TOWN OF CANANDAIGUA HAS THE FOLLOWING ADDITIONAL REQUIREMENTS:

COMPACTION DENSITIES SPECIFIED HEREIN SHALL BE THE PERCENTAGE OF THE MAXIMUM DENSITY OBTAINABLE AT OPTIMUM MOISTURE CONTENT AS DETERMINED AND CONTROLLED, IN ACCORDANCE WITH ASTM D1557. FIELD DENSITY TESTS SHALL BE MADE IN ACCORDANCE WITH ASTM D6938. EACH LAYER OF BACKFILL SHALL BE MOISTENED OR DRIED AS REQUIRED AND SHALL BE COMPACTED TO THE FOLLOWING DENSITIES, UNLESS OTHERWISE SPECIFIED.

UNDER ALL EXISTING OR PROPOSED ROADS, DRIVEWAYS, PARKING AREAS: 95% MAXIMUM MODIFIED PROCTOR DRY

#### ALL OTHER AREAS: 92% MAXIMUM MODIFIED PROCTOR DRY DENSITY (ASTM D1557). METHODS AND EQUIPMENT METHODS AND EQUIPMENT PROPOSED FOR COMPACTION SHALL BE SUBJECT TO THE APPROVAL OF THE TOWN.

- COMPACTION BY ROLLING OR OPERATING HEAVY EQUIPMENT OVER FILL AREAS SHALL BE CONDUCTED IN A MANNER BY WHICH DAMAGE TO EXISTING UTILITIES AND STRUCTURES SHALL BE AVOIDED. ANY PIPE OR STRUCTURE DAMAGED THEREBY SHALL BE REPLACED OR REPAIRED AS DIRECTED BY THE TOWN AT THE EXPENSE OF THE DEVELOPER. TESTING 1. FIELD DENSITY TESTS WILL BE PAID FOR BY THE DEVELOPER.
- 2. THE DEVELOPER SHALL FURNISH ALL NECESSARY SAMPLES FOR LABORATORY TESTS AND SHALL PROVIDE ASSISTANCE AND COOPERATION DURING FIELD TESTS. THE DEVELOPER SHALL PLAN HIS OPERATIONS TO ALLOW ADEQUATE TIME FOR LABORATORY TESTS AND TO PERMIT TAKING OF FIELD DENSITY TESTS DURING COMPACTION. 3. A QUALIFIED TESTING AGENCY SHOULD BE RETAINED DURING THE CONSTRUCTION PHASE OF THE PROJECT TO
- PROOF-ROLLING; PLACEMENT AND COMPACTION OF CONTROLLED COMPACTED FILLS; BACKFILLING OF EXCAVATIONS 4. EACH LIFT OF COMPACTED FILL SHOULD BE TESTED, EVALUATED, AND REWORKED AS NECESSARY UNTIL APPROVED BY THE GEOTECHNICAL ENGINEER PRIOR TO PLACEMENT OF ADDITIONAL LIFTS. EACH LIFT OF FILL SHOULD BE TESTED FOR DENSITY AND WATER CONTENT AT A FREQUENCY OF AT LEAST ONE TEST FOR EVERY 5,000 SQUARE FEET OF

OBSERVE EARTHWORK AND TO PERFORM NECESSARY TESTS AND OBSERVATIONS DURING SUBGRADE PREPARATION;

- COMPACTED FILL IN OPEN AREAS AND EVERY 50 LINEAR FEET OF COMPACTED UTILITY TRENCH BACKFILL. 5. ANY AREAS FOUND TO BE BELOW REQUIRED COMPACTION DENSITIES SHALL BE REMOVED AND REPLACED WITH NEW MATERIAL AT THE DEVELOPER'S EXPENSE. THE METHODS OF OPERATION AND/OR THE BACKFILL MATERIALS SHALL BE CHANGED TO MEET REQUIRED COMPACTIONS.
- 6. INADEQUATE COMPACTION SHALL BE CAUSE FOR THE TOWN TO ISSUE A STOP WORK ORDER ON A PROJECT.

## **EARTHWORK NOTES (CON'T)**

- 4. LIFT THICKNESS THE MAXIMUM LIFT THICKNESS UNDER PAVEMENTS, WALKS, AND STRUCTURAL FILLS SHALL BE 12 INCHES. HAND OPERATED COMPACTION FILLS SHALL NOT EXCEED 6 INCHES.
- 5. PROOF ROLLING THE TOWN OF CANANDAIGUA HIGHWAY DEPARTMENT SHALL BE NOTIFIED PRIOR TO A PROOF ROLL (I.E. LOADED TEN WHEELER) OF SUBGRADE AREAS BEING PERFORMED PRIOR TO PLACEMENT OF SUBBASE MATERIALS. AREAS THAT "FAIL" SHALL BE REMOVED AND REPLACED TO ACHIEVE A PASSING SUBGRADE.
- 6. EXISTING SOIL CONDITIONS NO EXISTING SOIL INFORMATION HAS BEEN PROVIDED BY THE OWNER/ DEVELOPER. IT IS ASSUMED THAT SOILS ARE SUITABLE FOR CUTS AND FILLS. FOR PURPOSES OF DESIGN 12" OF TOPSOIL WAS ASSUMED TO BE PRESENT ON AVERAGE THROUGHOUT THE SITE.
- 7. DEWATERING THE CONTRACTOR IS RESPONSIBLE FOR ALL DEWATERING PRACTICES INCLUDING DRYING OF MATERIAL TO 6. UTILITY LOCATIONS SHOWN ARE APPROXIMATE ONLY. THE CONTRACTOR SHALL DETERMINE EXACT LOCATION OF ACCOMPLISH COMPACTION IN FILL AREAS AND DEMONSTRATING SUITABILITY OF SUBGRADE. - CONTRACTOR IS RESPONSIBLE FOR DEWATERING THE EXISTING POND PRIOR TO EXCAVTION/GRADING TO PROPOSED GRADES SHOWN ON THE PLANS. DEWATERING OUTFLOW SHALL BE PUMPED TO A STONE FILTER EXITING TO THE EXISTING

## **EROSION CONTROL NOTES**

- 1. CERTIFICATION THE STORM WATER POLLUTION PREVENTION PLAN (SWPPP), WHICH INCLUDES THE "GRADING PLAN", "EROSION CONTROL PLAN", "EROSION CONTROL NOTES", ALONG WITH THE "DRAINAGE REPORT". DEFINES AND MEETS THE REQUIREMENTS OF THE NEW YORK STATE DEPARTMENT OF ENVIRONMENTAL CONSERVATION (NYSDEC) LATEST STORM WATER REGULATIONS.
- 2. CONTRACTOR RESPONSIBILITY ALL CONTRACTORS AND SUB-CONTRACTORS SHALL CERTIFY WITHIN THE SWPPP THAT THEY WILL IMPLEMENT AND MAINTAIN STORM WATER MANAGEMENT PRACTICES.
- 3. INSPECTION EROSION CONTROL (EC) MEASURES INSTALLED AND MAINTAINED BY THE SITE WORK CONTRACTOR ARE SUBJECT TO THE REVIEW AND APPROVAL OF THE: MUNICIPALITY, DESIGN ENGINEER, NYSDEC, AND OWNER'S REPRESENTATIVE. IMMEDIATE ACTION BY THE CONTRACTOR SHALL BE TAKEN IF ADDITIONAL OR CORRECTIVE MEASURES ARE REQUIRED BY ANY ONE OF THESE CITED REVIEWERS. EROSION CONTROL MEASURES NOT SPECIFICALLY SHOWN ON CONTRACT DRAWINGS (I.E., STRAW BALES, COLLARS, FABRICS, ETC.) SHALL BE INSTALLED AS WARRANTED BY FIELD CONDITIONS, AND AS DIRECTED BY THE AFOREMENTIONED REVIEWERS.
- 4. NOTIFICATION AS DESIGN ENGINEER, OUR OFFICE HAS NOTIFIED THE OWNER OF THE INSPECTION REQUIREMENTS UNDER GP-20-01. DISTURBANCES OF 1.0 ACRE OR GREATER REQUIRE THAT THE OWNER FILE A NOTICE OF INTENT (NOI) AND A SWPPP WITH THE NYSDEC UNDER STATE POLLUTANT DISCHARGE ELIMINATION SYSTEM (SPDES) GENERAL PERMIT #GP-20-01. SWPPP INSPECTIONS ARE TO BE COMPLETED BY A LICENSED PROFESSIONAL AND INSPECTION REPORTS ARE TO BE PROVIDED TO THE TOWN DEVELOPMENT OFFICE UNTIL THE SITE IS PERMANENTLY STABILIZED AND
- 5. PRE-CONSTRUCTION THE APPROPRIATE EROSION CONTROL MEASURES AS DEFINED BY THE CONSTRUCTION DOCUMENTS SHALL BE INSTALLED PRIOR TO THE START OF ANY CONSTRUCTION ACTIVITIES.
- 6. TOPSOIL UPON COMPLETION OF THE STOCKPILE STRIPPING OPERATION, STOCKPILES SHALL BE STABILIZED IN ACCORDANCE TO NYSDEC REGULATIONS
- 8. DUST THE CONTRACTOR SHALL APPLY WATER AND/OR CALCIUM CHLORIDE, AS CONDITIONS WARRANT, TO CONTROL WIND BORN EROSION. THIS MEASURE APPLIES TO: HAUL ROADS, CUT AND FILL OPERATIONS, SUB-BASE AND ANY
- 9. OPERATION & MAINTENANCE THROUGHOUT THE PERIOD OF CONSTRUCTION AND PRIOR TO ESTABLISHING FINAL GROUND COVER THE SITE CONTRACTOR IS RESPONSIBLE FOR THE OPERATION AND MAINTENANCE OF THE TEMPORARY EROSION CONTROL MEASURES. FOR EXAMPLE, THE SILTATION FACILITIES SHALL BE RE-EXCAVATED WHEN THE VOLUME (3600 CUBIC FEET/DISTURBED ACRE) IS REDUCED BY ONE-HALF OR MORE OF ITS SPECIFIED
- 10. WORK STOPPAGE IN AREAS WHERE DISTURBANCE ACTIVITIES HAVE TEMPORARILY OR PERMANENTLY CEASED. STABILIZATION MEASURES SHOULD BE INITIATED BY THE END OF THE NEXT BUSINESS DAY AND COMPLETED WITHIN 14 DAYS (WITHIN 7 DAYS FOR SITES WITH OVER 5 ACRES OF DISTURBANCE OR DISCHARGES TO A 303D WATERBODY, OR WITHIN 3 DAYS IF BETWEEN NOVEMBER 15TH AND APRIL 1ST)

## 11. TOWN OF CANANDAIGUA REQUIREMENTS -

- DEVELOPMENT WITHIN THE CANANDAIGUA LAKE WATERSHED THAT REQUIRES POST CONSTRUCTION WATER QUALITY MEASURES SUCH AS STORMWATER MANAGEMENT FACILITIES, THE DEVELOPER IS REQUIRED TO PROVIDE DAILY OBSERVATION OF THE SITE BY A LICENSED PROFESSIONAL OR A CERTIFIED PERSONS IN EROSION AND SEDIMENT CONTROL (CPESC) UNTIL SUCH TIME THAT THE MASS GRADING OF THAT SECTION OR PHASE IS COMPLETED AND ALL STORMWATER MANAGEMENT COMPONENTS OF THE SWPPP ARE INSTALLED AND FUNCTIONING. • DEVELOPMENT WITHIN THE CANANDAIGUA LAKE WATERSHED THAT WILL DISTURB MORE THAN 5-ACRES AT ONE TIME, SHALL
- BE REQUIRED TO COORDINATE THE REGULAR STORMWATER OBSERVATIONS (REQUIRED BY SPDES GENERAL PERMIT) WITH THE WATERSHED INSPECTOR AND THE WATERSHED PROGRAM MANAGER
- 12. TEMPORARY SEED TEMPORARY SEEDING OF DISTURBED AREAS SHALL BE PROVIDED AS FOLLOWS:
- THE SURFACE TWO INCHES OF SOIL SHOULD BE LOOSENED BY DISKING, RAKING, OR BACK-BLADING WITH A BULLDOZER. IMMEDIATELY FERTILIZE WITH 300 LBS. PER ACRE (OR 7 LBS. PER 1.000 SQ. FT.) OF 10-0-10 FERTILIZER (CONTAINING NO PHOSPHORUS). IMMEDIATELY SEED WITH THE FOLLOWING MIX:

| Thousand the second sec | , which the role of the or | Mil/C.         |
|--------------------------------------------------------------------------------------------------------------------------------------------------------------------------------------------------------------------------------------------------------------------------------------------------------------------------------------------------------------------------------------------------------------------------------------------------------------------------------------------------------------------------------------------------------------------------------------------------------------------------------------------------------------------------------------------------------------------------------------------------------------------------------------------------------------------------------------------------------------------------------------------------------------------------------------------------------------------------------------------------------------------------------------------------------------------------------------------------------------------------------------------------------------------------------------------------------------------------------------------------------------------------------------------------------------------------------------------------------------------------------------------------------------------------------------------------------------------------------------------------------------------------------------------------------------------------------------------------------------------------------------------------------------------------------------------------------------------------------------------------------------------------------------------------------------------------------------------------------------------------------------------------------------------------------------------------------------------------------------------------------------------------------------------------------------------------------------------------------------------------------|----------------------------|----------------|
|                                                                                                                                                                                                                                                                                                                                                                                                                                                                                                                                                                                                                                                                                                                                                                                                                                                                                                                                                                                                                                                                                                                                                                                                                                                                                                                                                                                                                                                                                                                                                                                                                                                                                                                                                                                                                                                                                                                                                                                                                                                                                                                                | LBS./ACRE                  | LBS./1,000 SQ. |
| ANNUAL RYEGRASS                                                                                                                                                                                                                                                                                                                                                                                                                                                                                                                                                                                                                                                                                                                                                                                                                                                                                                                                                                                                                                                                                                                                                                                                                                                                                                                                                                                                                                                                                                                                                                                                                                                                                                                                                                                                                                                                                                                                                                                                                                                                                                                | 40                         | 1              |
| PERENNIAL RYEGRASS                                                                                                                                                                                                                                                                                                                                                                                                                                                                                                                                                                                                                                                                                                                                                                                                                                                                                                                                                                                                                                                                                                                                                                                                                                                                                                                                                                                                                                                                                                                                                                                                                                                                                                                                                                                                                                                                                                                                                                                                                                                                                                             | 40                         | 1              |
| OATS                                                                                                                                                                                                                                                                                                                                                                                                                                                                                                                                                                                                                                                                                                                                                                                                                                                                                                                                                                                                                                                                                                                                                                                                                                                                                                                                                                                                                                                                                                                                                                                                                                                                                                                                                                                                                                                                                                                                                                                                                                                                                                                           | 40                         | 1              |
| WHITE CLOVER (+ INNOCULANT)                                                                                                                                                                                                                                                                                                                                                                                                                                                                                                                                                                                                                                                                                                                                                                                                                                                                                                                                                                                                                                                                                                                                                                                                                                                                                                                                                                                                                                                                                                                                                                                                                                                                                                                                                                                                                                                                                                                                                                                                                                                                                                    | 4                          | 0.1            |

CAPACITY AND/OR THE MATERIAL IS WITHIN ONE FOOT OF THE DISCHARGE POINT.

- SEED SHOULD HAVE A GERMINATION RATE OF AT LEAST 85 PERCENT, AND MINIMAL INERT MATERIAL.
- 13. PERMANENT SEED UPON COMPLETION OF WORK WITHIN THE R.O.W., DISTURBED AREAS WITH IN THE R.O.W. SHALL BE STABILIZED USING THE FOLLOWING PERMANENT LAWN SEEDING MIX, UPON COMPLETION OF GRADING AND CONSTRUCTION OF EACH TOWNHOME BUILDING, ALL AREAS DISTURBED IN CONJUNCTION WITH THE TOWNHOME CONSTRUCTION SHALL BE STABILIZED WITH THE FOLLOWING LAWN SEEDING MIX.

|                                     | LBS./ACRE | % BY PURITY | % GERM. |
|-------------------------------------|-----------|-------------|---------|
| 'PENNFINE' PERENNIAL RYE GRASS      | 35        | 85          | 85      |
| 'PENNLAWN' RED FESCUE               | 35        | 97          | 80      |
| KENTUCKY BLUEGRASS                  | 30        | 85          | 80      |
| SEEDING RATE: 6.0 LBS. PER 1.000 SQ | . FT.     |             |         |

STARTING FERTILIZER (CONTAINING NO PHOSPHORUS): 5:0:10 AT 20 LBS. PER 1,000 SQ. FT.

MULCH: STRAW OR WOOD FIBER MULCH USED WITH A HYDROSEEDING METHOD,

AT TWO TONS PER ACRE WITH TACKIFIER

AT TWO TONS PER ACRE WITH TACKIFIER

14. SLOPES -UPON COMPLETION OF GRADING, SLOPES WITH A GRADIENT OF ONE FOOT VERTICAL TO THREE FEET HORIZONTAL (1 ON 3) OR GREATER SHALL BE: TOPSOILED, SEEDED, FERTILIZED, MULCHED AND STABILIZE WITH AN EROSION CONTROL BLANKET. RILLS SHALL BE IMMEDIATELY ADDRESSED AND STABILIZED AS NEEDED WITH JUTE MESH OR REAPPLICATION OF MULCH. ALL OTHER SLOPES SHALL TOPSOILED, SEEDED, FERTILIZED AND MULCHED. SLOPES SHALL BE FINE GRADED WITH A MINIMUM OF 6 INCHES OF TOPSOIL AND SEEDED WITH THE FOLLOWING SEED MIX:

|                      | LBS./ACRE | % BY PURITY | % GERM. |
|----------------------|-----------|-------------|---------|
| PENNGIFT' CROWNVETCH | 40        | 98          | 65      |
| BIRDSFOOT TREFOIL    | 16        | 98          | 90      |
| TALL FESCUE          | 20        | 90          | 85      |
|                      |           |             |         |

SEEDING RATE: 75 LBS, PER ACRE LIME: RATE OF 1,000 LBS. PER ACRE AS NECESSARY TO REACH PH OF 6.0 INOCULANT: RATE AS RECOMMENDED BY THE MANUFACTURER (FOR HYDROSEEDING, USE FOUR TIMES THE MANUFACTURER'S RECOMMENDED RATE.) MULCH: STRAW OR WOOD FIBER MULCH USED WITH A HYDROSEEDING METHOD.

- 15. MONITORING ALL SEEDED AREAS ARE TO BE MONITORED FOR GERMINATION AND EROSION. ERODED AREAS ARE TO BE BACKFILLED, FINE GRADED, AND RE-SEEDED. AREAS THAT FAIL TO GERMINATE A MINIMUM OF 75% SHALL BE RE-SEEDED.
- **16. BUILDER RESPONSIBILITY** THE HOME BUILDER SHALL BE RESPONSIBLE FOR IMPLEMENTING INDIVIDUAL LOT EROSION CONTROL MEASURES AS SHOWN ON THE PLAN DETAIL FOR INDIVIDUAL HOUSE CONSTRUCTION. THE MEASURES ARE TO REMAIN IN PLACE UNTIL HOUSE CONSTRUCTION IS COMPLETE AND THE LAWN IS ESTABLISHED.
- 17. 5-ACRE WAIVER IF THE TOTAL ACREAGE TO BE DISTURBED IS GREATER THAN 5 ACRES, THEN A 5-ACRE WAIVER FROM
- IF A 5-ACRE WAIVER HAS BEEN GRANTED AND THE SITE DISTURBANCE IS OVER 5 ACRES, IN AREAS WHERE SOIL DISTURBANCE HAS TEMPORARILY CEASED. TEMPORARY AND/OR PERMANENT SOIL STABILIZATION MEASURES SHALL BE
- INCREASED SITE INSPECTION FREQUENCY TO AT LEAST TWO (2) SITE INSPECTIONS EVERY SEVEN (7) CALENDAR DAYS FOR AS LONG AS THE DISTURBANCE EXCEEDS FIVE (5) ACRES. THE TWO (2) INSPECTIONS MUST BE SEPARATED BY AT LEAST TWO

INSTALLED AND/OR IMPLEMENTED WITHIN SEVEN (7) DAYS FROM THE DATE THE SOIL DISTURBANCE ACTIVITY CEASED.

## CANANDAIGUA LAKE COUNTY SEWER DISTRICT

BE SERVED BY GRAVITY LATERALS.

- 1. SEWER PERMITS AND PERMITS FOR WORK WITHIN ONTARIO COUNTY HIGHWAY RIGHTS OF WAY MUST BE PURCHASED IN ADVANCE AT THE ONTARIO COUNTY PUBLIC WORKS OFFICE LOCATED AT 2962 COUNTY ROAD 48 IN THE TOWN OF HOPEWELL. CALL 585-396-4000 FOR INFORMATION.
- 2. SANITARY SEWER CONSTRUCTION AND/OR IMPROVEMENTS SHALL BE IN ACCORDANCE WITH THE MOST RECENT STANDARDS AND SPECIFICATIONS OF THE CANANDAIGUA LAKE COUNTY SEWER DISTRICT, N.Y.S. DEPARTMENT OF ENVIRONMENTAL CONSERVATION, N.Y.S. DEPARTMENT OF HEALTH, THE LATEST EDITION OF RECOMMENDED STANDARDS FOR WASTEWATER FACILITIES AND ANY OTHER AGENCIES HAVING JURISDICTION.
- 3. SANITARY SEWER MAIN GRAVITY PIPE SHALL BE 8" DIA. OR LARGER PVC CLASS SDR-35 OR SDR-21 WITH ELASTOMERIC JOINTS. LATERALS SHALL BE 4" DIA. SDR-21 WITH ELASTOMERIC JOINTS. ACTUAL FIELD CONDITIONS MAY REQUIRE ADDITIONAL PIPE OR BACKFILL REINFORCEMENT. THE SANITARY SEWER WILL BE DESIGNED BY THE DEVELOPER'S ENGINEER. FIELD CHANGES MUST BE APPROVED BY THE SEWER DISTRICT. 4. THE SANITARY SEWER IS DESIGNED TO PROVIDE GRAVITY SERVICE TO ALL ADJACENT BUILDING BASEMENTS. EXCEPTIONS HAVE BEEN APPROVED BY THE SEWER DISTRICT AND ARE CLEARLY NOTED ON THE UTILITY PLAN. BASEMENT FLOOR ELEVATIONS WILL BE SHOWN ON THE SANITARY SEWER PROFILE FOR EACH LOT THAT WILL NOT
- 5. THE CONTRACTOR SHALL LOCATE, MARK AND PRESERVE ANY RIGHT OF WAY MONUMENTS OR SURVEY CONTROL IN THE AREA OF CONSTRUCTION.
- UTILITIES, EXCAVATING TO EXPOSE THE UTILITY, IF NECESSARY IN THE AREA OF CONSTRUCTION, BEFORE COMMENCING CONSTRUCTION. CONTACT U.F.P.O. AT 1-800-962-7962 AT LEAST 72 HOURS PRIOR TO
- 7. THE SANITARY SEWER SHALL BE LOCATED A MINIMUM HORIZONTAL DISTANCE OF 10' FROM ANY EXISTING OR PROPOSED WATER MAIN (AS MEASURED FROM THE OUTSIDE OF THE SEWER TO THE OUTSIDE OF THE WATER MAIN). IN CASES WHERE THE SANITARY SEWER CROSSES A WATER MAIN. THE MINIMUM VERTICAL SEPARATION SHALL BE 18" (MEASURED OUT-TO-OUT). THE CROSSING SHALL BE ARRANGED SO THAT THE SEWER JOINTS WILL
- BE EQUIDISTANT AND AS FAR AS POSSIBLE FROM THE WATER MAIN JOINTS. 8. A LETTER OF CREDIT, OR ENGINEER APPROVED EQUIVALENT, FOR AN AMOUNT EQUAL TO THE ESTIMATED COST OF CONSTRUCTION, INSPECTION, RECORD DRAWINGS, DEDICATION DOCUMENTS AND RELATED EXPENSES FOR THE SANITARY SEWER PLUS AN ADDITIONAL 10% FOR CONTINGENCIES MUST BE SUBMITTED TO THE

AND SUBMISSION TO THE DISTRICT FOR APPROVAL. PERMITS WILL NOT BE ISSUED PRIOR TO THE EASEMENT

- COMMISSIONER OF PUBLIC WORKS BEFORE A PERMIT IS ISSUED OR SEWER CONSTRUCTION MAY COMMENCE. 9. THE CONTRACTOR SHALL PROVIDE THE DISTRICT WITH SHOP DRAWINGS AND MATERIAL SPECIFICATIONS THAT HAVE BEEN PRE-APPROVED BY THE DESIGN ENGINEER BEFORE A PERMIT WILL BE ISSUED. 10. THE DEVELOPER IS RESPONSIBLE FOR THE PREPARATION OF ALL REQUIRED EASEMENT MAPS AND DESCRIPTIONS
- DOCUMENTS BEING SIGNED BY THE COMMISSIONER AND RECORDED IN THE COUNTY CLERK'S OFFICE. 11 THE CONTRACTOR IS RESPONSIBLE FOR COMPLIANCE WITH OSHA REQUIREMENTS IN ALL ASPECTS OF CONSTRUCTION, PAYING PARTICULAR ATTENTION TO REQUIREMENTS FOR OPEN TRENCH AND CONFINED SPACE. ENTRY INTO ANY DISTRICT STRUCTURE MUST COMPLY WITH ALL DISTRICT AND OSHA APPROVED PROCEDURES
- 12. WHEN SANITARY SEWER CONSTRUCTION ACTIVITIES BEGIN, THE CONTRACTOR SHALL PLUG THE MAIN AT THE CONNECTING MANHOLE. PLUGS SHALL NOT BE REMOVED UNTIL THE COMPLETED SEWER LINE IS TESTED AND
- 13. THE CONTRACTOR SHALL BE RESPONSIBLE FOR MAINTAINING SANITARY FLOWS AT ALL TIMES BY METHODS
- ACCEPTABLE TO THE DEVELOPER'S ENGINEER AND THE DISTRICT. 14. THE SEWER LINE SHALL BE LAID USING A PIPE LASER. GRADE SHALL BE CHECKED EVERY 100 FEET USING A SURVEYOR'S LEVEL TO INSURE THE CORRECT GRADE IS BEING MAINTAINED.
- 15. FLOOR DRAINS IN THE BASEMENT OR GARAGE ARE TO BE CONNECTED TO THE SANITARY SEWER. FLOOR DRAINS DO NOT INCLUDE FOUNDATION OR FOOTER DRAINS INSTALLED TO INTERCEPT UNCONTAMINATED GROUND WATER. ALL DISCHARGES TO THE SANITARY SEWER MUST COMPLY WITH EFFLUENT LIMITS OF THE ONTARIO COUNTY SEWER USE LAW. FOUNDATION AND FOOTER DRAINS SHALL BE CONSTRUCTED IN A MANNER THAT WILL PROHIBIT
- GROUND WATER FROM DRAINING INTO THE SANITARY SEWER PIPE CRADLE. 16. OPENINGS IN EXISTING MANHOLES SHALL BE MADE WITH A CORE SAW. A RUBBER, WATER-TIGHT PIPE-TO-MANHOLE BOOT ADAPTER OR OTHER DISTRICT APPROVED CONNECTOR CONFORMING TO ASTM C-923, SHALL BE USED TO MAKE THE CONNECTION TO THE EXISTING MANHOLE
- 17. THE CONTRACTOR SHALL PERFORM ALL EXISTING MANHOLE MODIFICATION OPERATIONS IN SUCH A MANNER TO ENSURE NO DEBRIS OR CONSTRUCTION MATERIALS ENTER THE SANITARY SEWER SYSTEM.
- 18. THE CONTRACTOR SHALL EXERCISE CAUTION WHEN PERFORMING EXISTING MANHOLE MODIFICATION OPERATIONS. ANY DAMAGE TO THE EXISTING SLAB, BARREL OR ANY OTHER PART OF THE STRUCTURE SHALL BE REPLACED IN KIND TO THE SATISFACTION OF THE CANANDAIGUA LAKE COUNTY SEWER DISTRICT REPRESENTATIVE AT THE CONTRACTOR'S EXPENSE.
- 20. CONNECTIONS REQUIRING OPENINGS IN ASBESTOS CEMENT PIPE WILL BE DESIGNED, INSPECTED AND CERTIFIED

19. EXISTING MANHOLES THAT ARE MODIFIED IN ANY MANNER SHALL BE SUBJECT TO VACUUM TESTING PER DISTRICT


- BY THE DESIGN ENGINEER OR REPRESENTATIVE THEREOF. 21. ALL PIPES ENTERING AND EXITING MANHOLES SHALL HAVE A FLEXIBLE WATER-TIGHT JOINT NO LESS THAN 1 FOOT
- AND NO GREATER THAN 3 FEET FROM THE OUTSIDE WALL OF THE MANHOLE. 22. MANHOLES DEEPER THAN 14 FEET, LESS THAN 5 FEET IN DEPTH, OR HAVING THREE OR MORE PIPE CONNECTIONS SHALL HAVE A MINIMUM INSIDE DIAMETER OF 5 FEET.
- 23. ANY EXCAVATION NOT BACKFILLED BY THE END OF THE WORKDAY SHALL BE FENCED, BARRICADED AND LIGHTED FOR SAFETY AND PROTECTION OF THE PUBLIC.

24. THE CONTRACTOR SHALL BE RESPONSIBLE FOR THE REMOVAL OF EXISTING SANITARY MAINS, STRUCTURES AND

- APPURTENANCES, IF ANY, NEEDED TO COMPLETE THE WORK. 25. EXISTING LATERALS TO BE DISCONNECTED MUST BE PERMANENTLY PLUGGED OR CAPPED AT THE EASEMENT OR RIGHT OF WAY LINE UNDER THE DIRECTION OF THE CANANDAIGUA LAKE COUNTY SEWER DISTRICT SUPERVISOR. THE CONTRACTOR IS REQUIRED TO OBTAIN A PERMIT PRIOR TO PERFORMING THE WORK. THE LOCATION OF THE
- PLUG OR CAP SHALL BE RECORDED FOR AS-BUILT DRAWING PURPOSES. 26. LATERAL CLEAN OUTS WILL BE PROVIDED AT THE RIGHT OF WAY LINE OR SANITARY SEWER EASEMENT LINE, WHICHEVER IS FURTHEST FROM THE SEWER MAIN, AND EVERY 90 LINEAR FEET THEREAFTER.
- PLUGS AS WELL AS LENGTHS OF RISERS AND DEPTHS AT LATERAL PLUGS. THE INFORMATION WILL BE GIVEN TO THE DEVELOPER'S ENGINEER FOR USE IN PREPARING RECORD DRAWINGS. 28. FOLLOWING PROJECT COMPLETION AND 30 DAYS AFTER THE BACKFILL HAS BEEN IN PLACE THE FOLLOWING TESTS

27. THE CONTRACTOR SHALL TAKE AND RECORD FIELD MEASUREMENTS TO ALL WYES, CLEAN OUTS AND LATERAL

- SHALL BE PERFORMED ON GRAVITY SANITARY SEWER MAIN: a. INFILTRATION/EX-FILTRATION TESTS ON SEWER MAIN AND MANHOLES. AIR PRESSURE TESTING FOR SEWER MAINS AND VACUUM TESTING FOR MANHOLES IS RECOMMENDED. TESTS ON MANHOLES MAY BE PERFORMED ONLY AFTER MANHOLE BENCHES AND INVERTS ARE COMPLETE. AIR PRESSURE TESTING OF PLASTIC PIPES HALL CONFORM TO ASTM F-1417 AND AIR PRESSURE TESTING OF CONCRETE MANHOLES
- b. A DEFLECTION TEST USING A RIGID BALL OR MANDREL HAVING A DIAMETER OF 95% OF THE INSIDE
- DIAMETER OF THE PIPE. MECHANICAL PULLING DEVICES WILL NOT BE USED. c. THE SEWER LINE WILL BE TELEVISED AND LAMPED AFTER ALL OTHER TESTS ARE COMPLETE. A GOOD QUALITY COPY OF THE DVD OR VIDEO-TAPE AND RELATED RECORDS WILL BE SUBMITTED FOR EVALUATION TO CANANDAIGUA LAKE COUNTY SEWER DISTRICT, PRIOR TO TELEVISING THE SEWER LINE SHALL BE FLUSHED AND CLEARED OF DIRT, STONES AND DEBRIS. IF PERMISSION IS GRANTED TO REMOVE THE PLUG AT THE CONNECTING MANHOLE PRIOR TO FLUSHING OPERATION, PROVIDEDOWNSTREAM SCREENS OR OTHER DEVICES TO PREVENT DEBRIS FROM ENTERING THE COUNTY'S SEWER SYSTEM. SECTIONS OF PIPE
- REPAIRED OR RE-FLUSHED WILL BE RE-TELEVISED UNTIL ACCEPTABLE. 29. UPON PROJECT COMPLETION AND DISTRICT APPROVAL. THE DEVELOPER'S ENGINEER WILL SUBMIT RECORD DRAWINGS ON MYLAR AND IN ELECTRONIC FORMAT, TIED TO NAD83 HORIZONTAL AND NAVD 88 VERTICAL DATUM. THE DRAWINGS WILL SHOW ACTUAL FIELD MEASURED LOCATIONS, LENGTHS, ELEVATIONS AND TYPES OF PIPE AND APPURTENANCES, INCLUDING WYES AND LATERALS, AS WELL AS PROFILES, EASEMENTS AND ANY OTHER RELATED INFORMATION REQUESTED BY THE DISTRICT. MYLAR DRAWINGS WILL BE STAMPED/SEALED AND SIGNED BY A PROFESSIONAL ENGINEER OR SURVEYOR, AND SHALL BE AT STANDARD ENGINEERING SCALE (L" = 50' MIN.), AND ON STANDARD SIZED DRAWINGS NO SMALLER THAN 11" X 17" AND NO LARGER THAN 24" X 36". PROJECT MONUMENTATION AND PERMANENT BENCHMARKS SHALL BE SHOWN WITH COORDINATE AND/OR ELEVATION
- 30. THE DEVELOPER IS RESPONSIBLE FOR PROVIDING EASEMENT MAPS AND DESCRIPTIONS AND SEWER DEDICATION DOCUMENTS. MAPS WILL BE RECORDED WITH DEDICATION DOCUMENTS IN THE ONTARIO COUNTY CLERK'S
- OFFICE, AND THEREFORE NEED TO BE SUBMITTED ON LEGAL SIZE (8 1/2" X 14") PAPER. 31. PRIOR TO RELEASING THE RETAINAGE FROM THE ORIGINAL LETTER OF CREDIT, A MAINTENANCE BOND FOR A MINIMUM OF 10% OF THE TOTAL SANITARY SEWER-RELATED COST OF THE PROJECT IN FAVOR OF THE CANANDAIGUA LAKE COUNTY SEWER DISTRICT WILL BE SUBMITTED TO THE COMMISSIONER. THE BOND WILL EXPIRE NO SOONER THAN ONE YEAR FROM THE DATE OF DEDICATION OF THE SEWER, OR THE RELEASE DATE OF THE RETAINAGE FROM THE LETTER OF CREDIT, WHICHEVER OCCURS LAST.

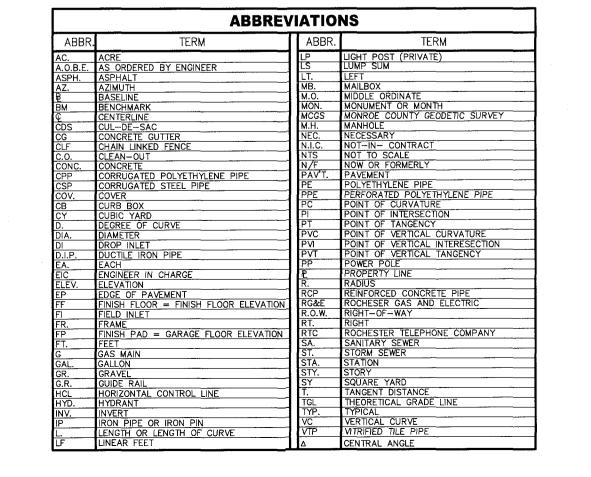

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ROCHESTER LOCATION

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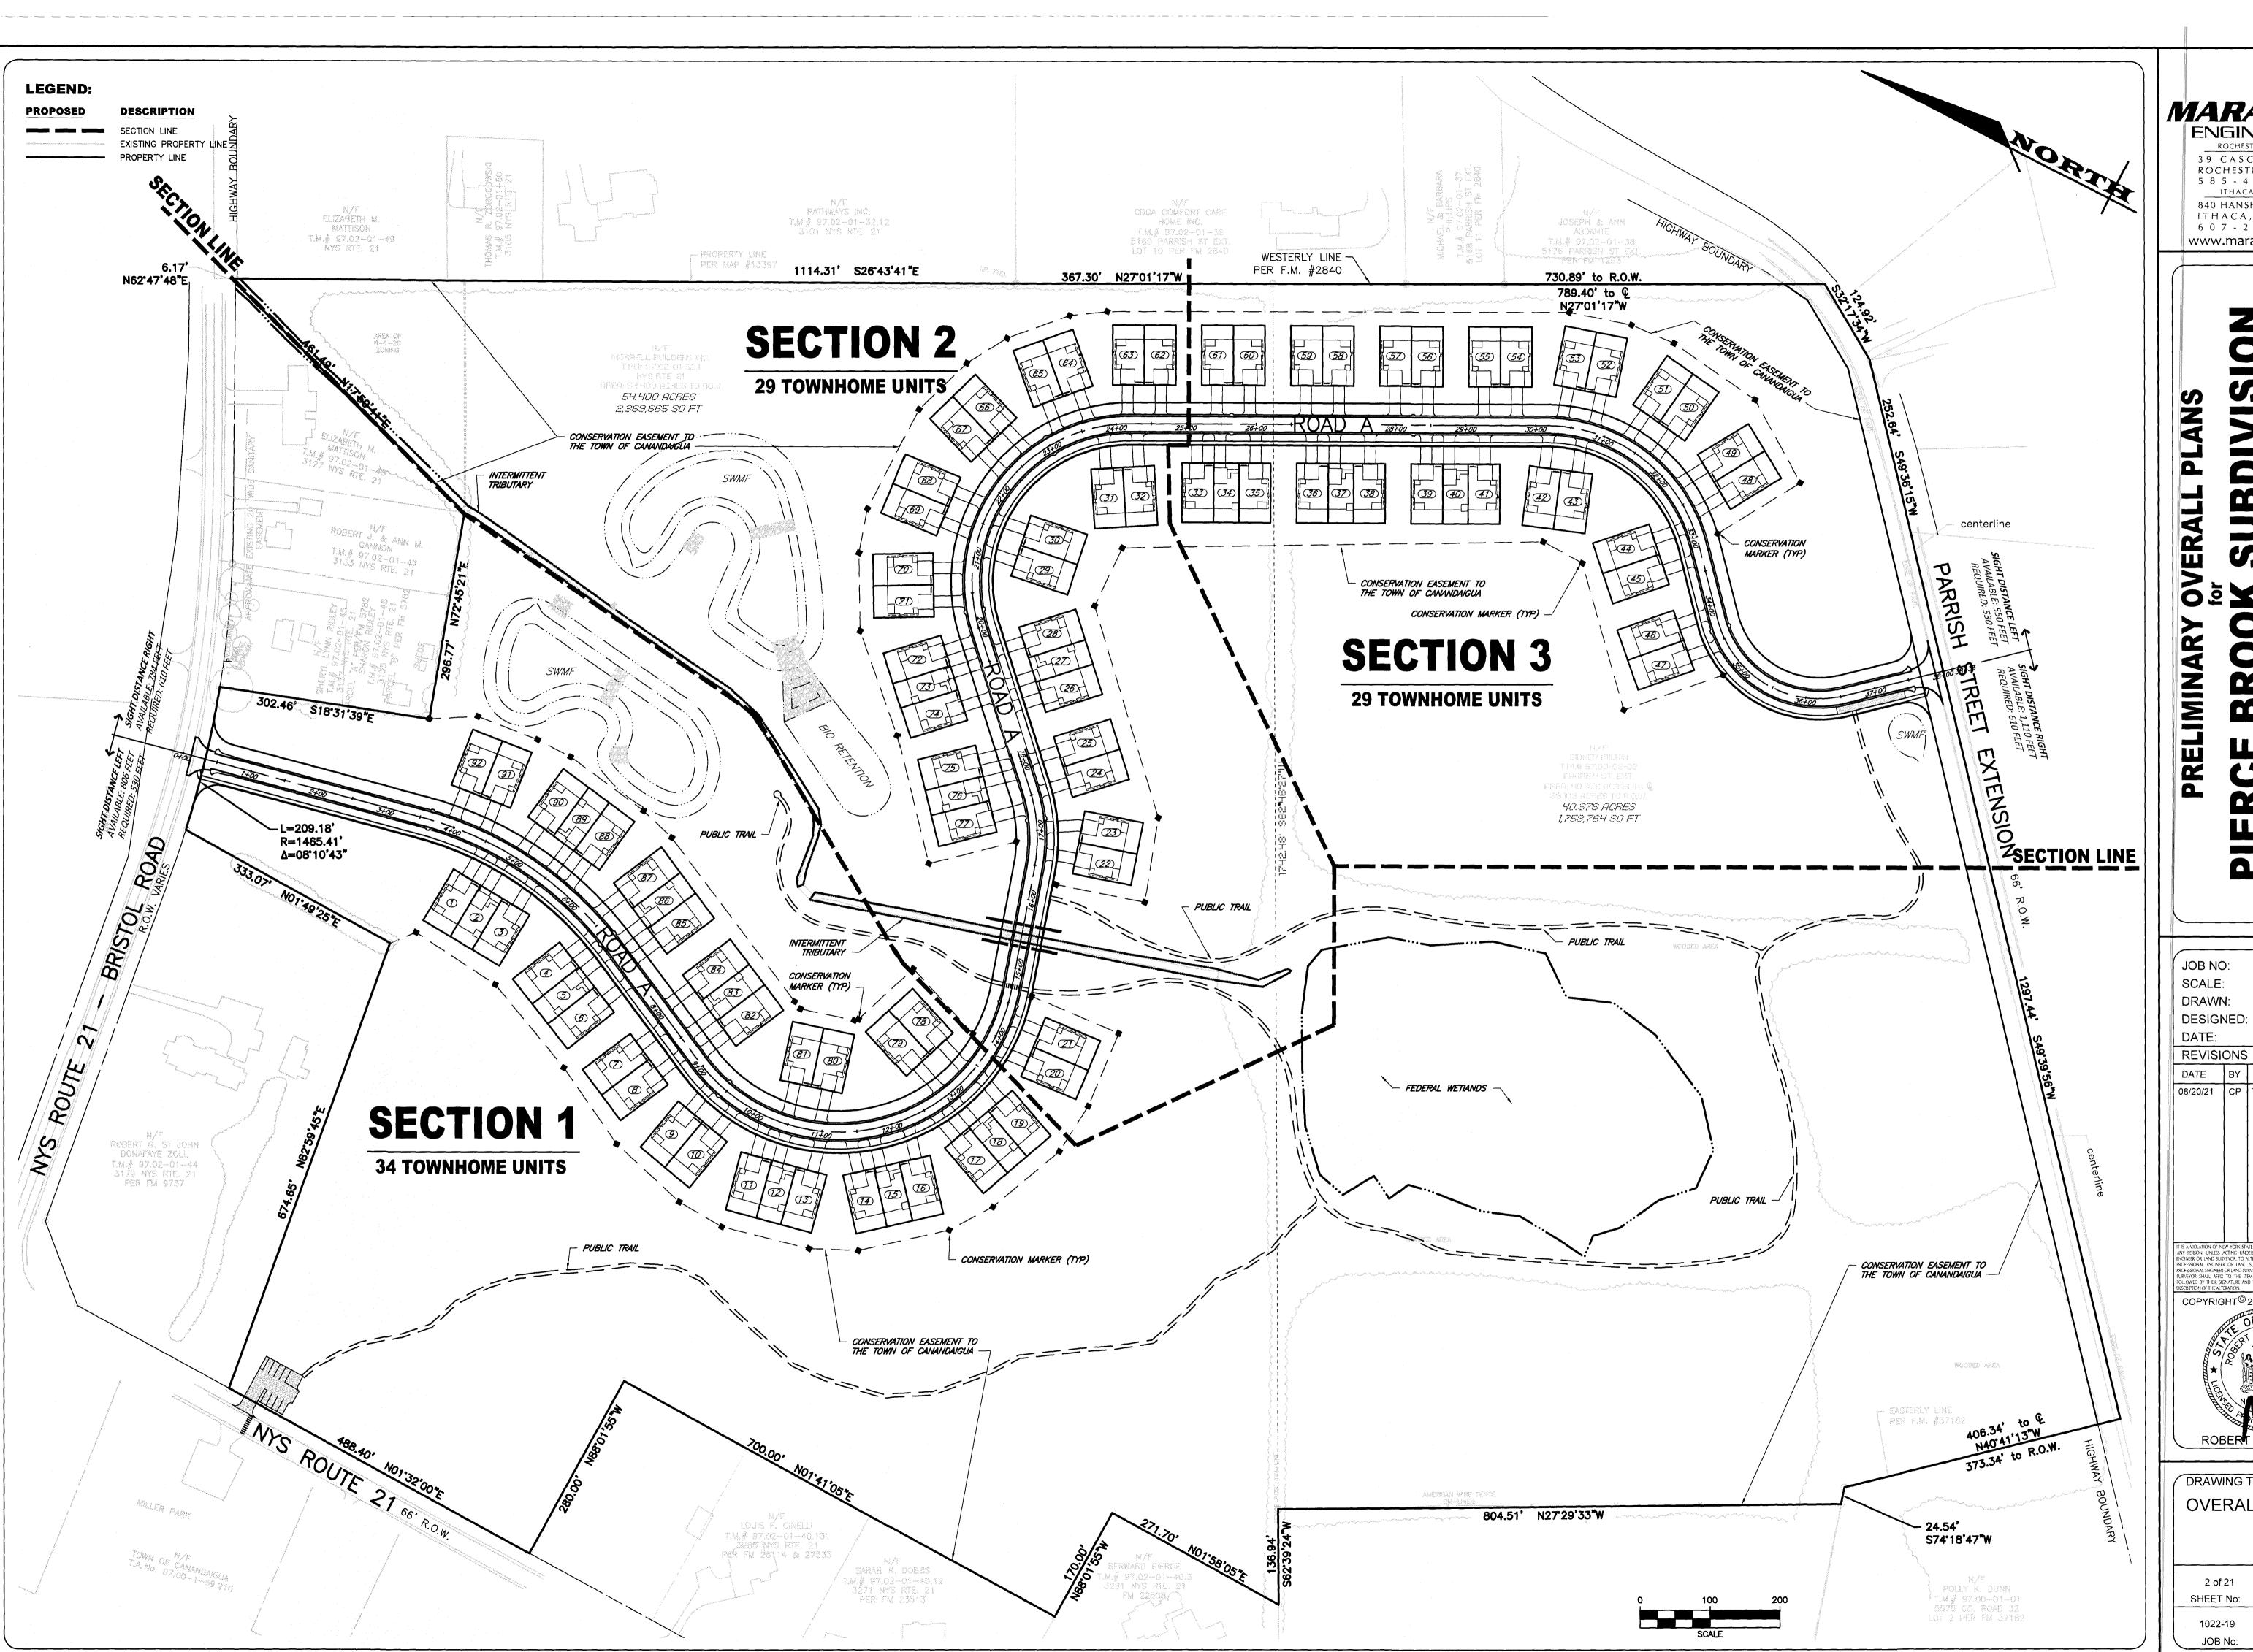
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JOB NO: SCALE: N/A DRAWN: CMP DESIGNED: DATE: **REVISIONS** DATE BY REVISION 08/20/21 CP TOWN COMMENTS INEER OR LAND SURVEYOR, TO ALTER IN ANY WAY, AN ITEM BEARING THE SEAL OF SIONAL ENGINEER OR LAND SURVEYOR, IF AN ITEM BEARING THE SEAL OF VED BY THEIR SIGNATURE AND THE DATE OF SUCH ALTERATION, AND A SPECIFI COPYRIGHT<sup>©</sup> 2021 MARATHON ENG.

> DRAWING TITLE: ABBREVIATIONS, AND **SPECIFICATIONS**

ROBERT P. BRINGLEY

SHEET No:





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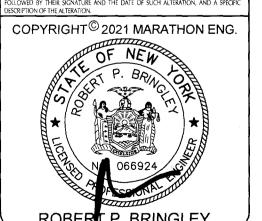
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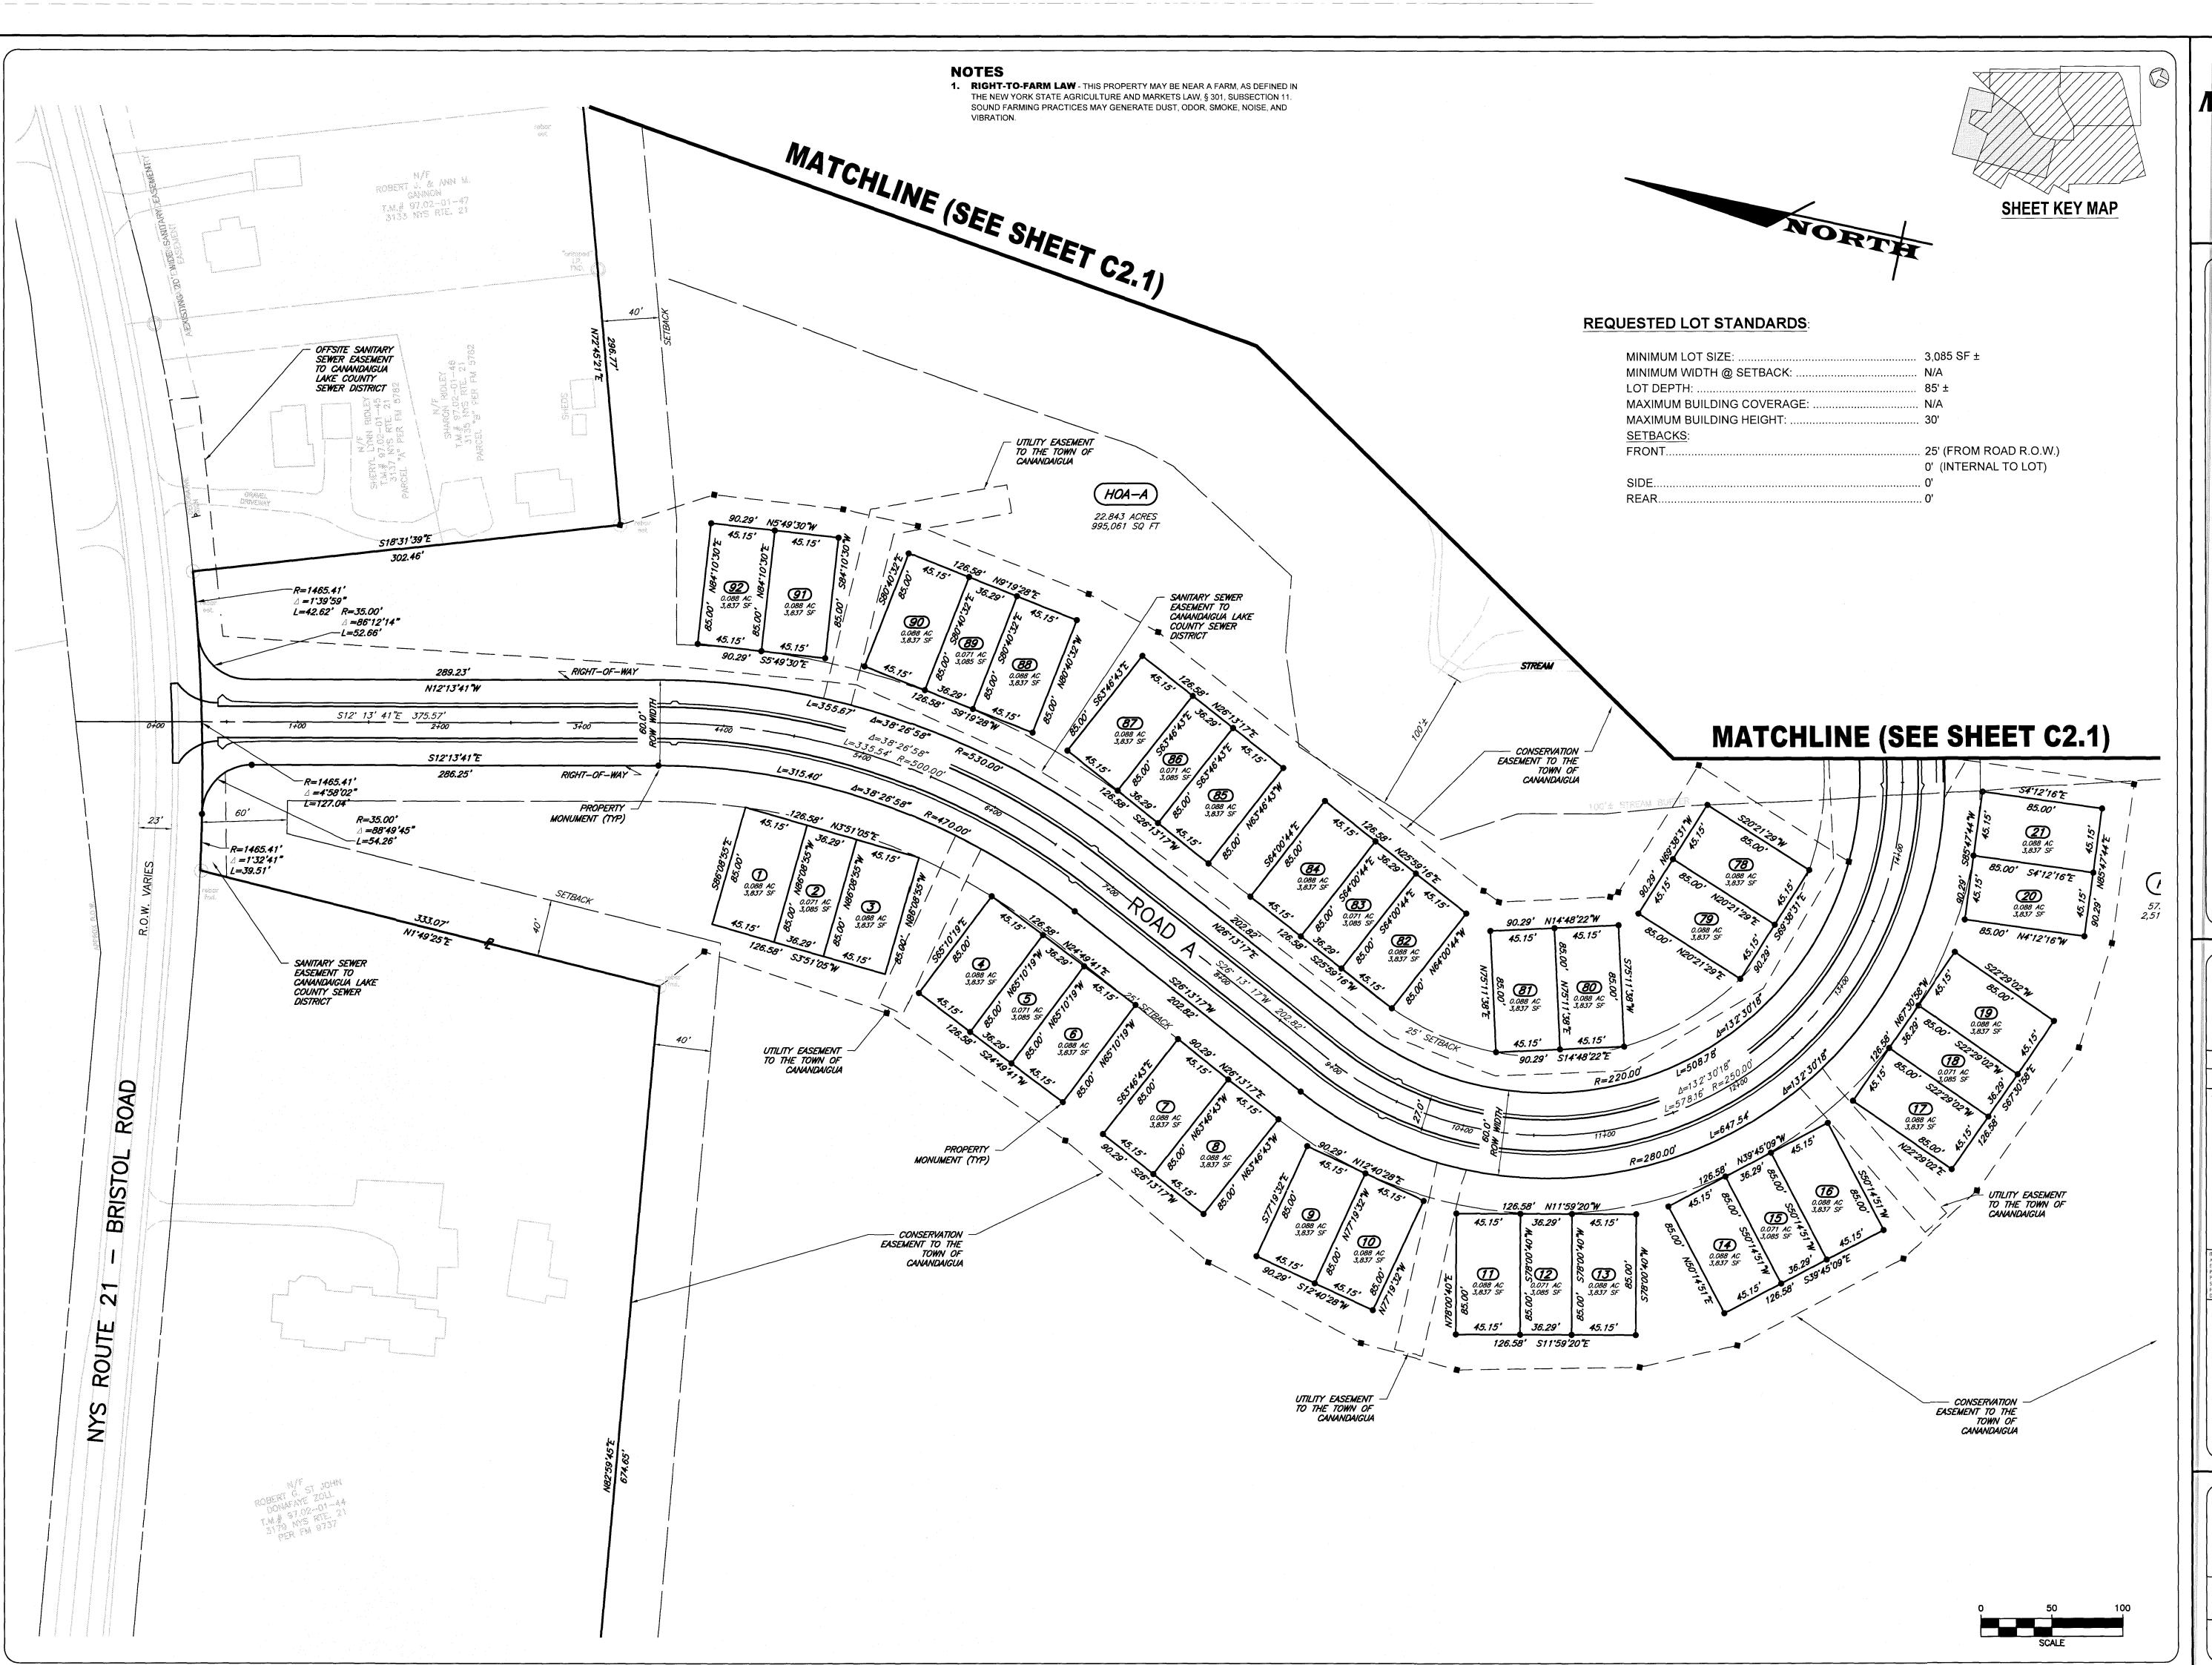
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DATE BY REVISION 08/20/21 CP TOWN COMMENTS



DRAWING TITLE: OVERALL PLAN

> 2 of 21 SHEET No: 1022-19





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ITHACA LOCATION

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ITHACA, NY 14850
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STATE OF NEW YORK

TOWN OF

PRELIMINARY OVERALL PLANS
for for SUBDIVISION
ERCE BROOK SUBDIVISION

JOB NO: 1022-19

SCALE: 1"=50'

DRAWN: CMP

DESIGNED: RJT

DATE: 5/21/21

REVISIONS

DATE BY REVISION

08/20/21 CP TOWN COMMENTS

TOWN COMMENTS

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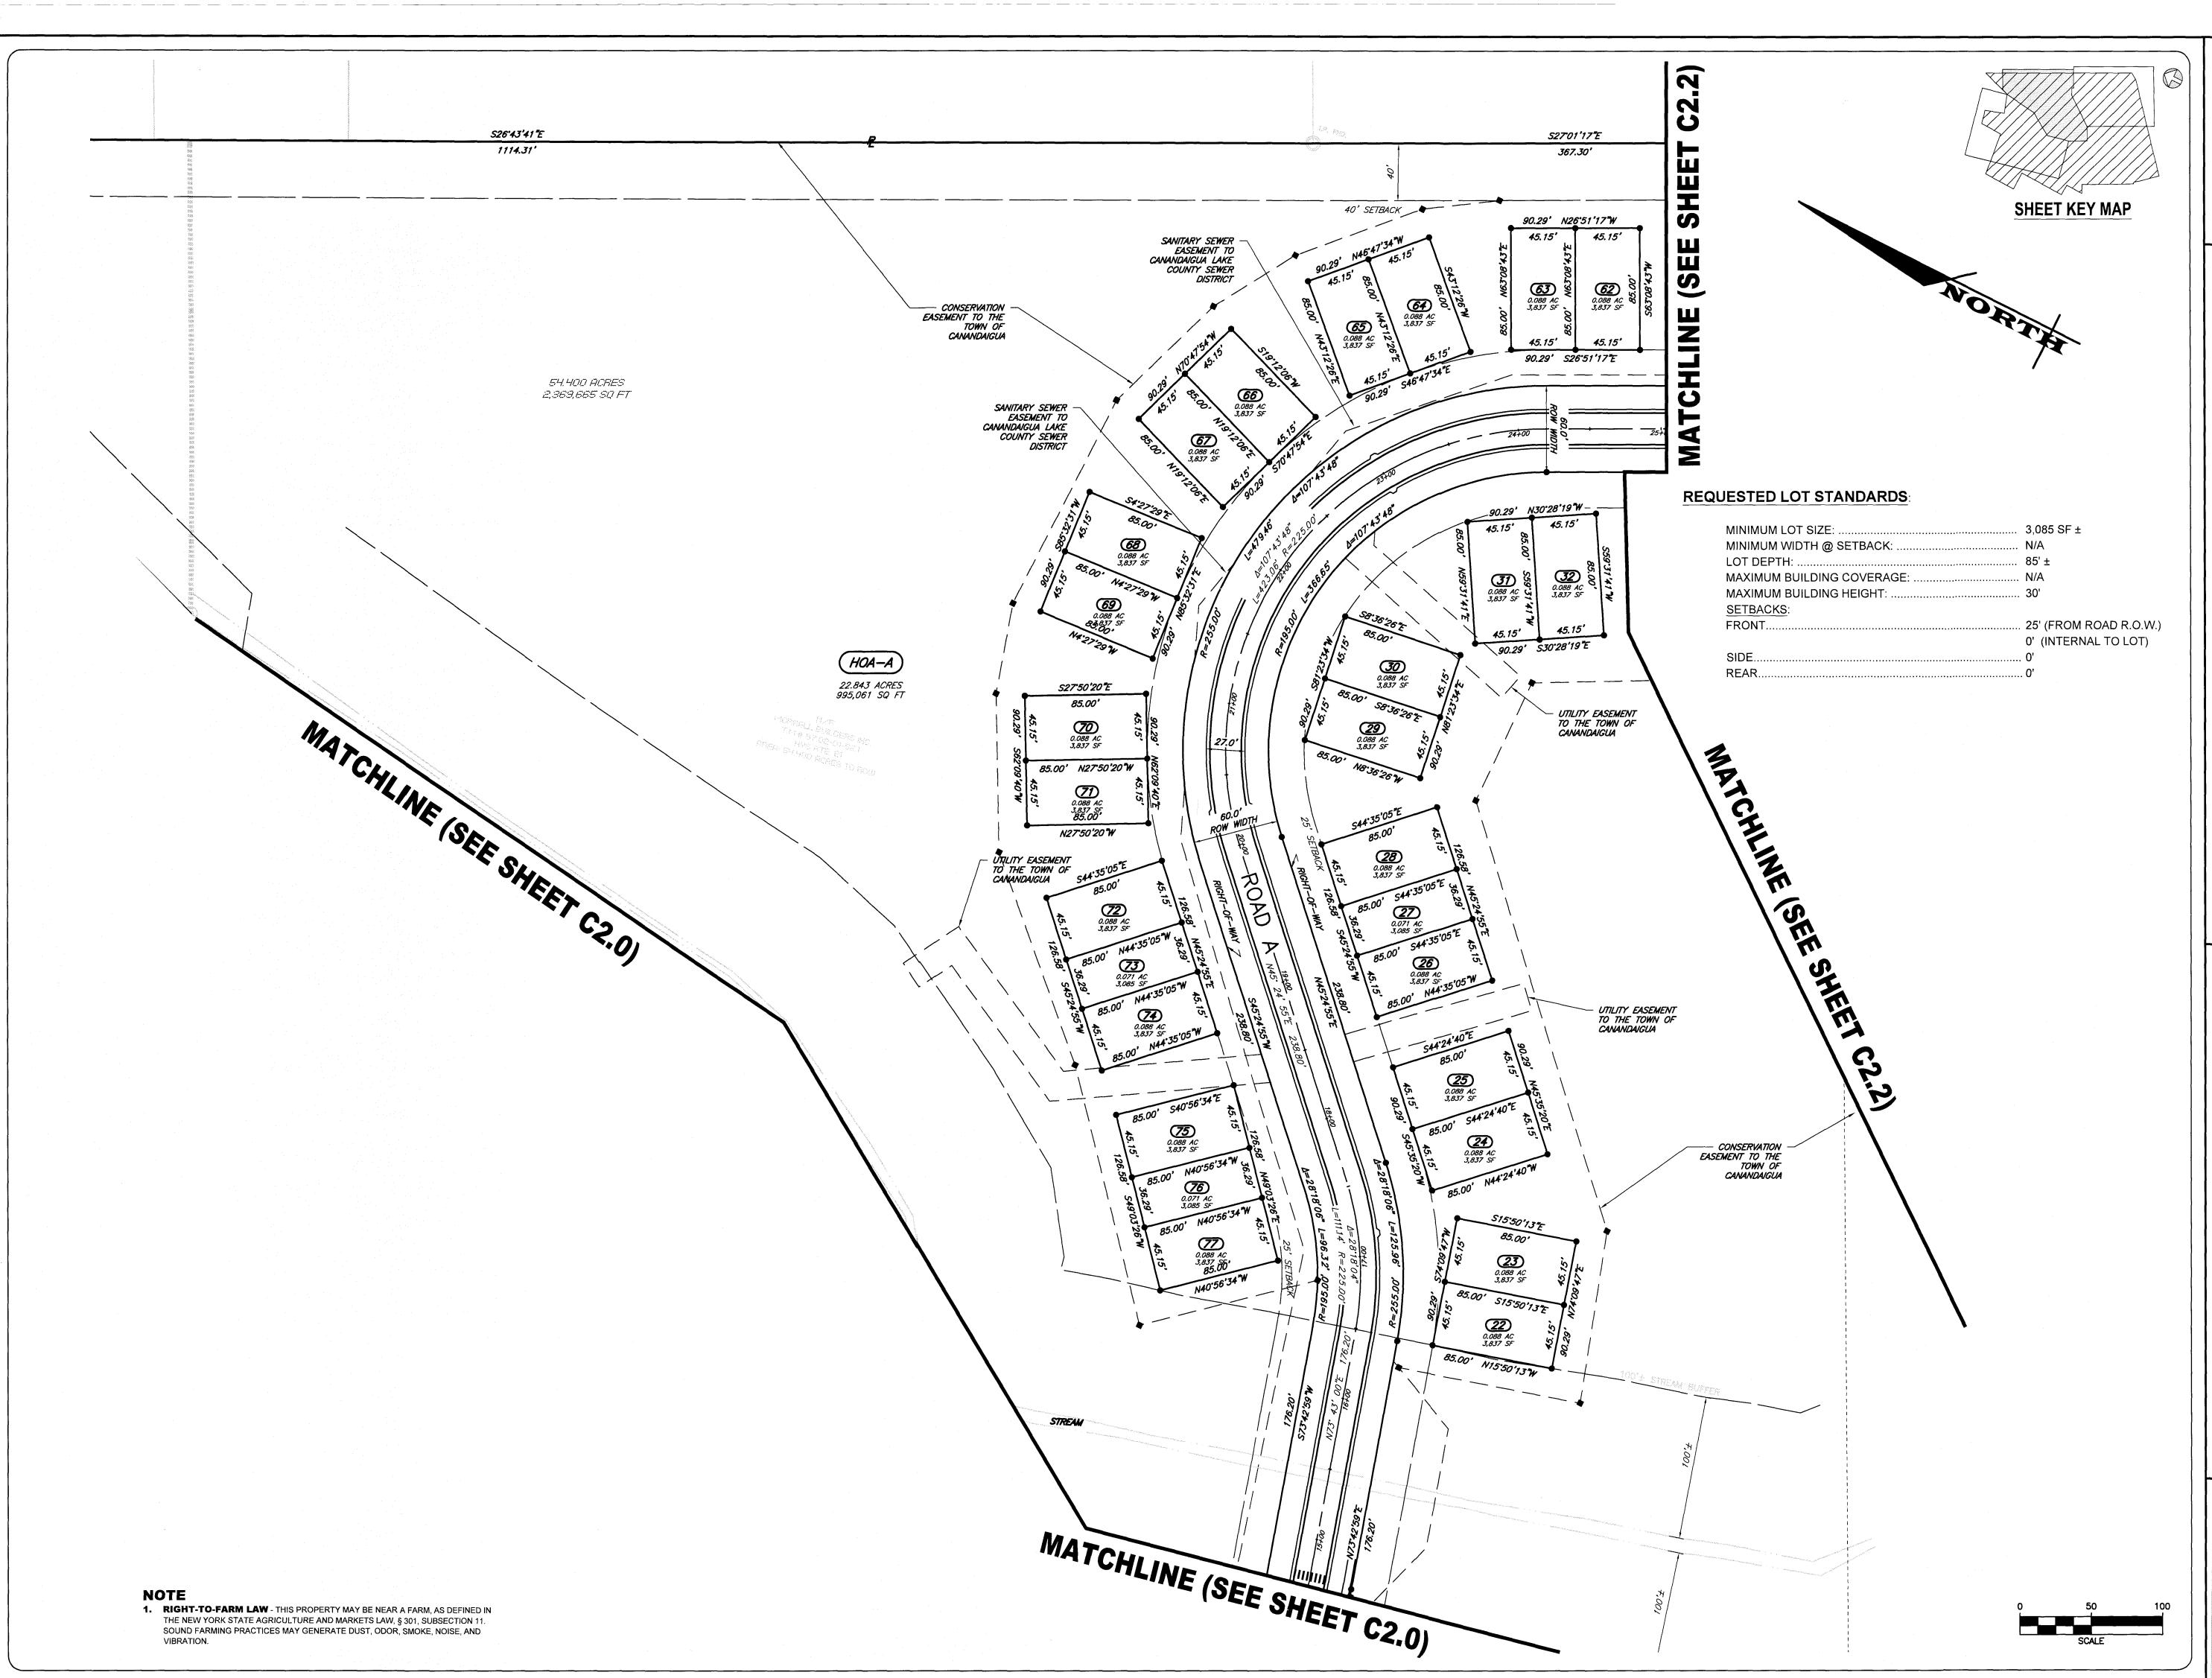
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DRAWING TITLE:
SUBDIVISION
PLAN (SHEET 1 OF 3)

ROBERT P. BRINGLEY

3 of 21 SHEET No:

1022-19
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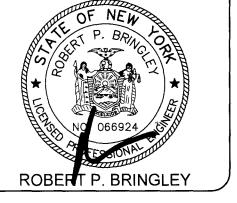
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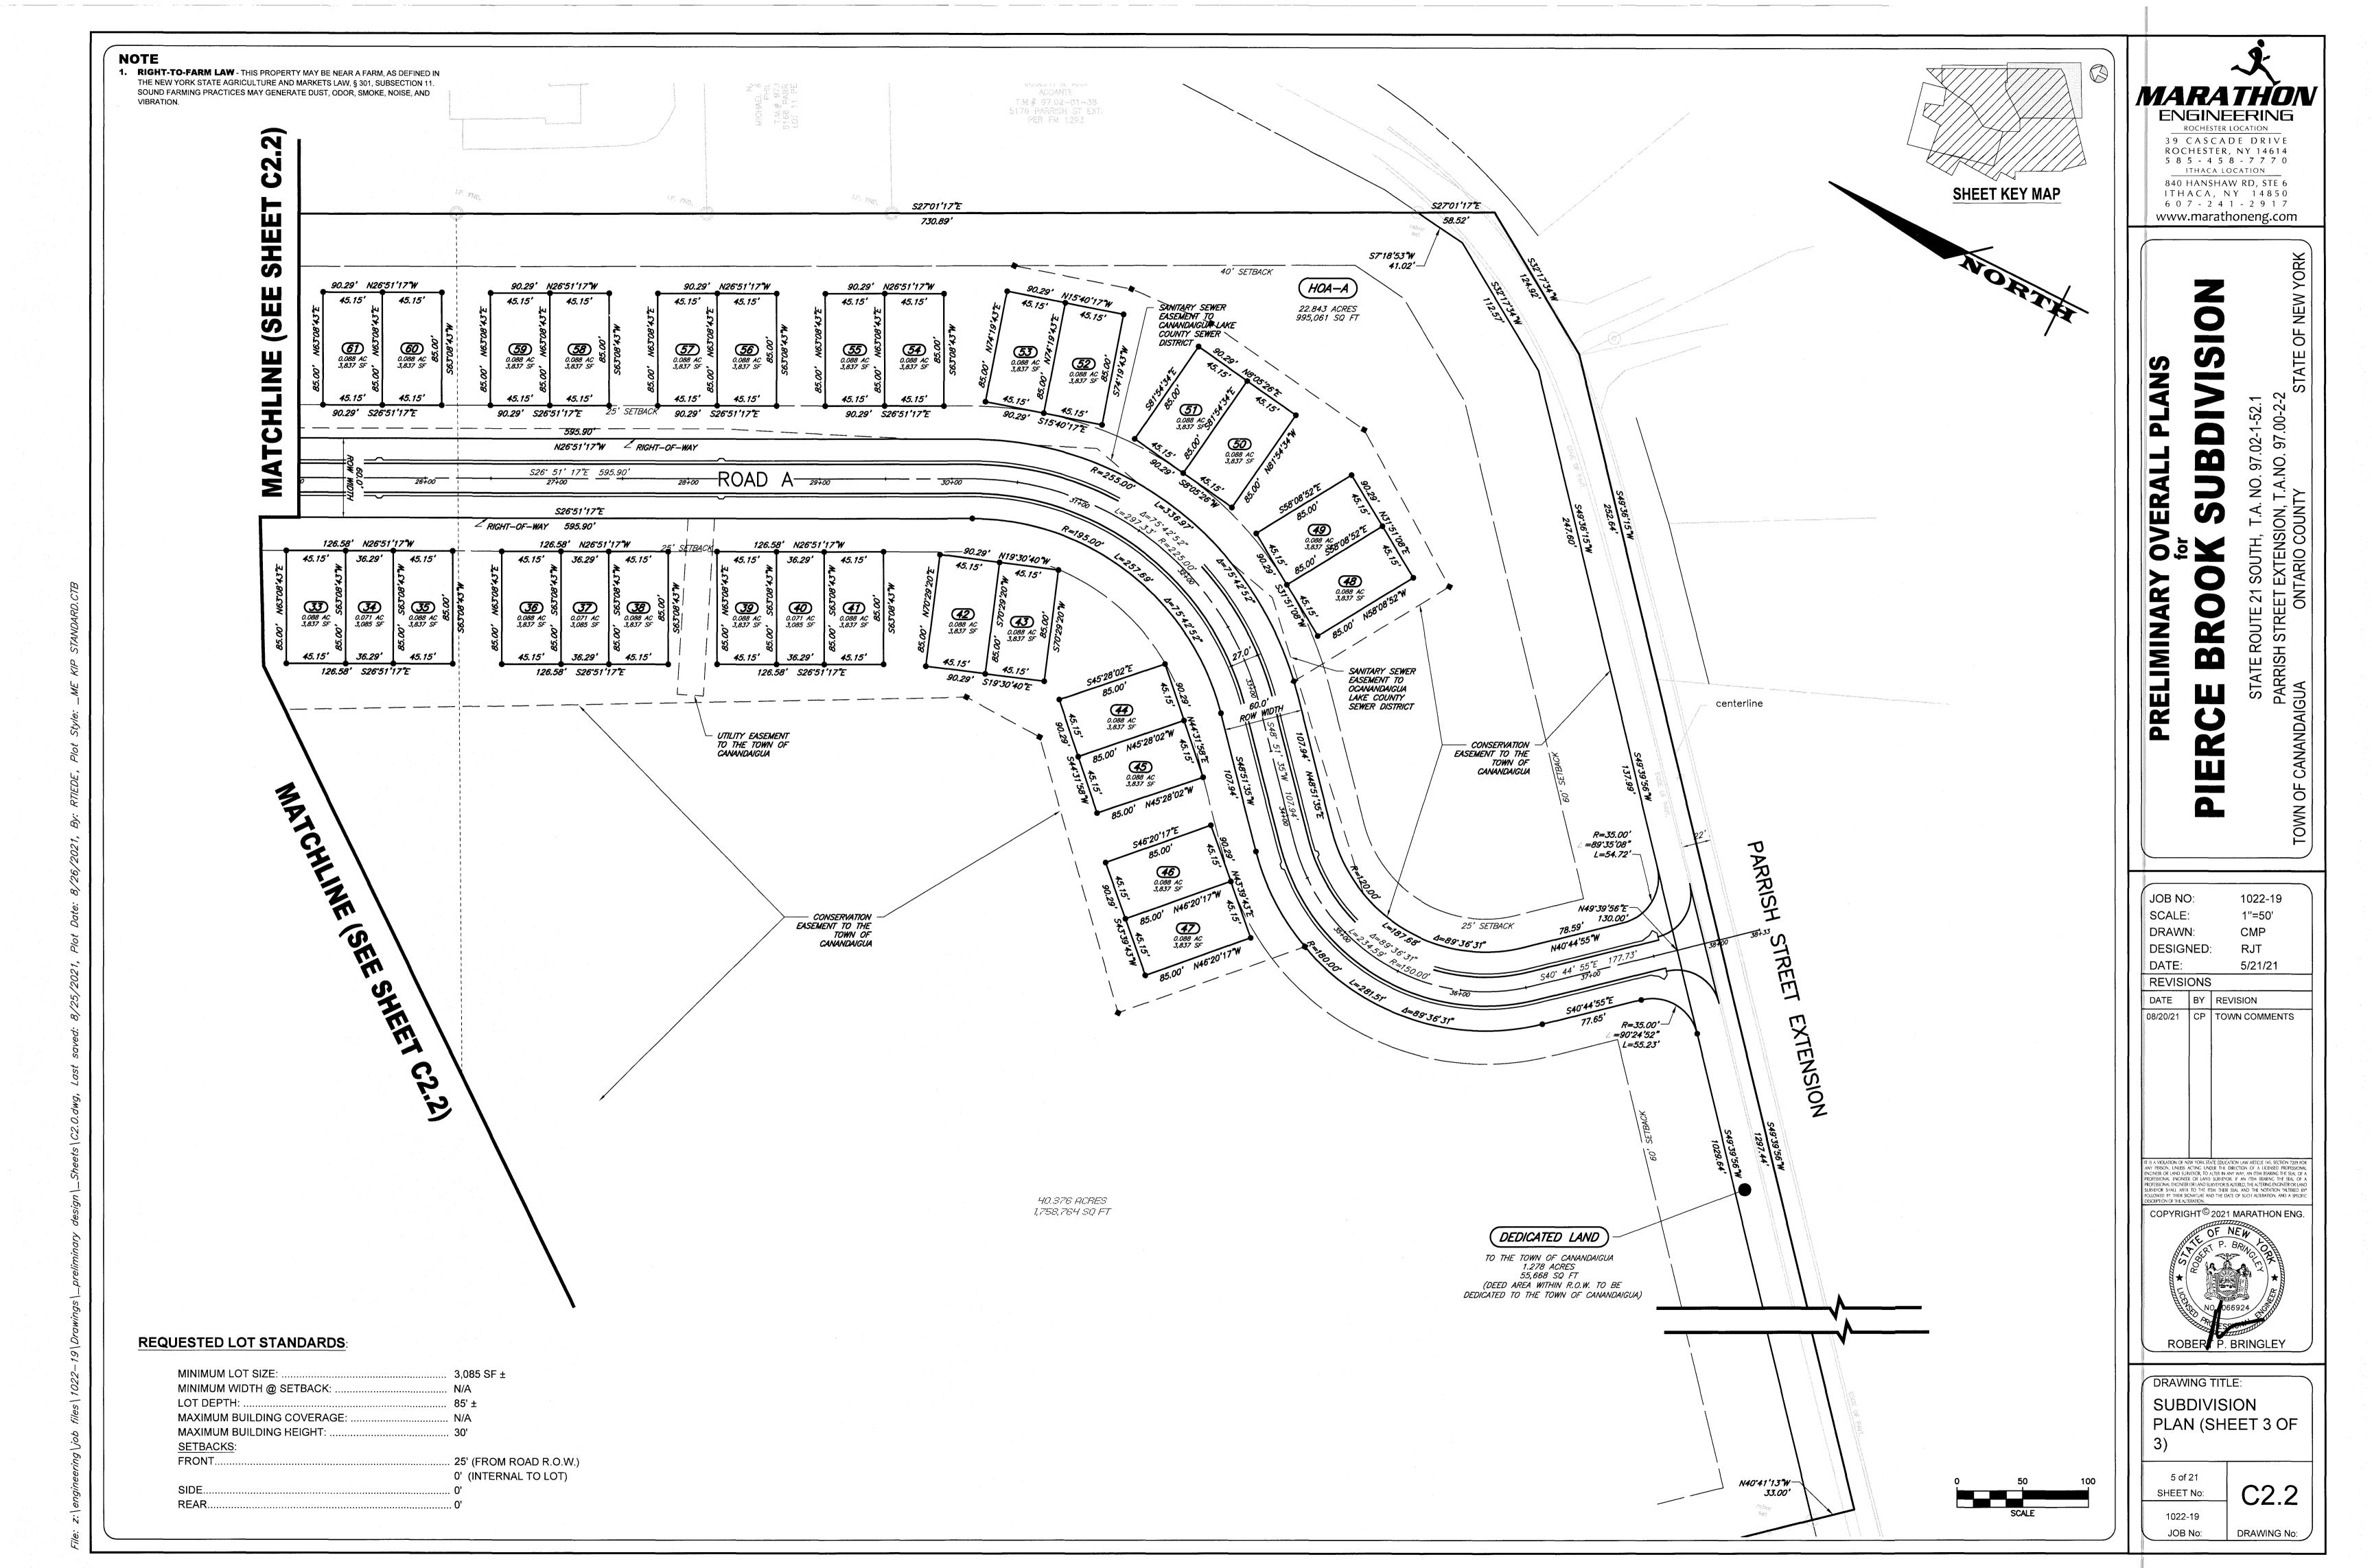
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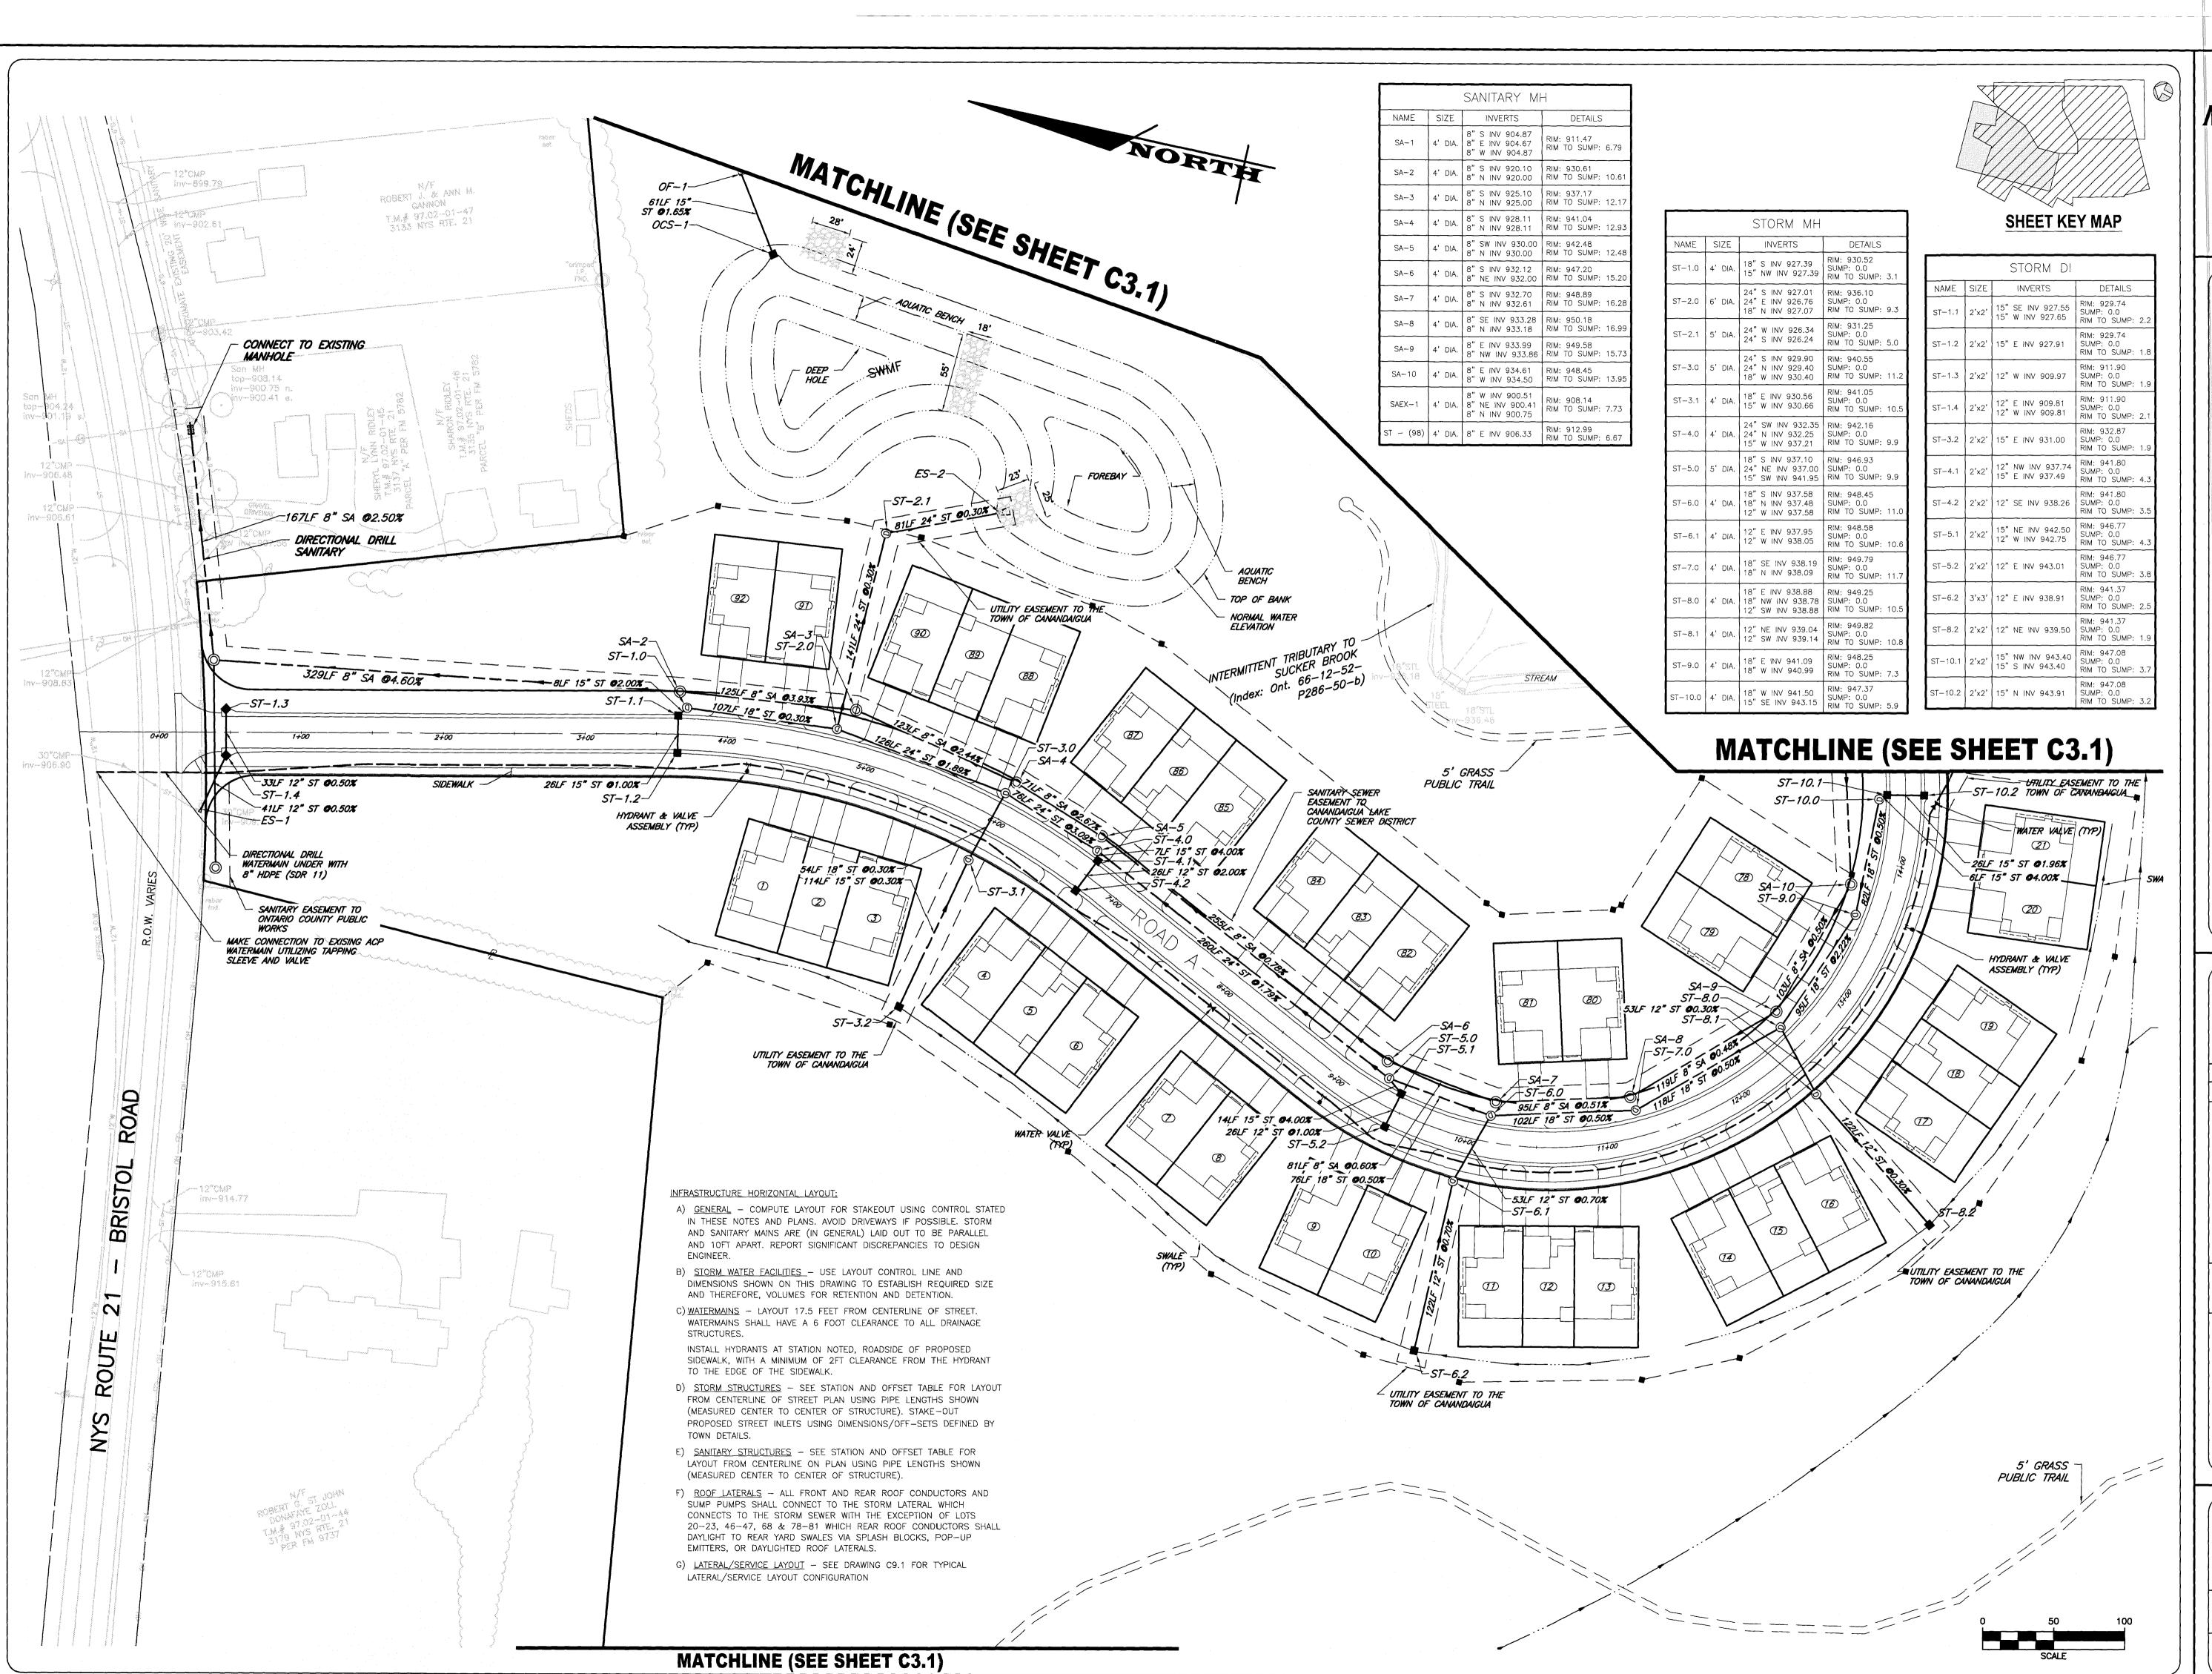
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DRAWING TITLE: SUBDIVISION PLAN (SHEET 2 OF

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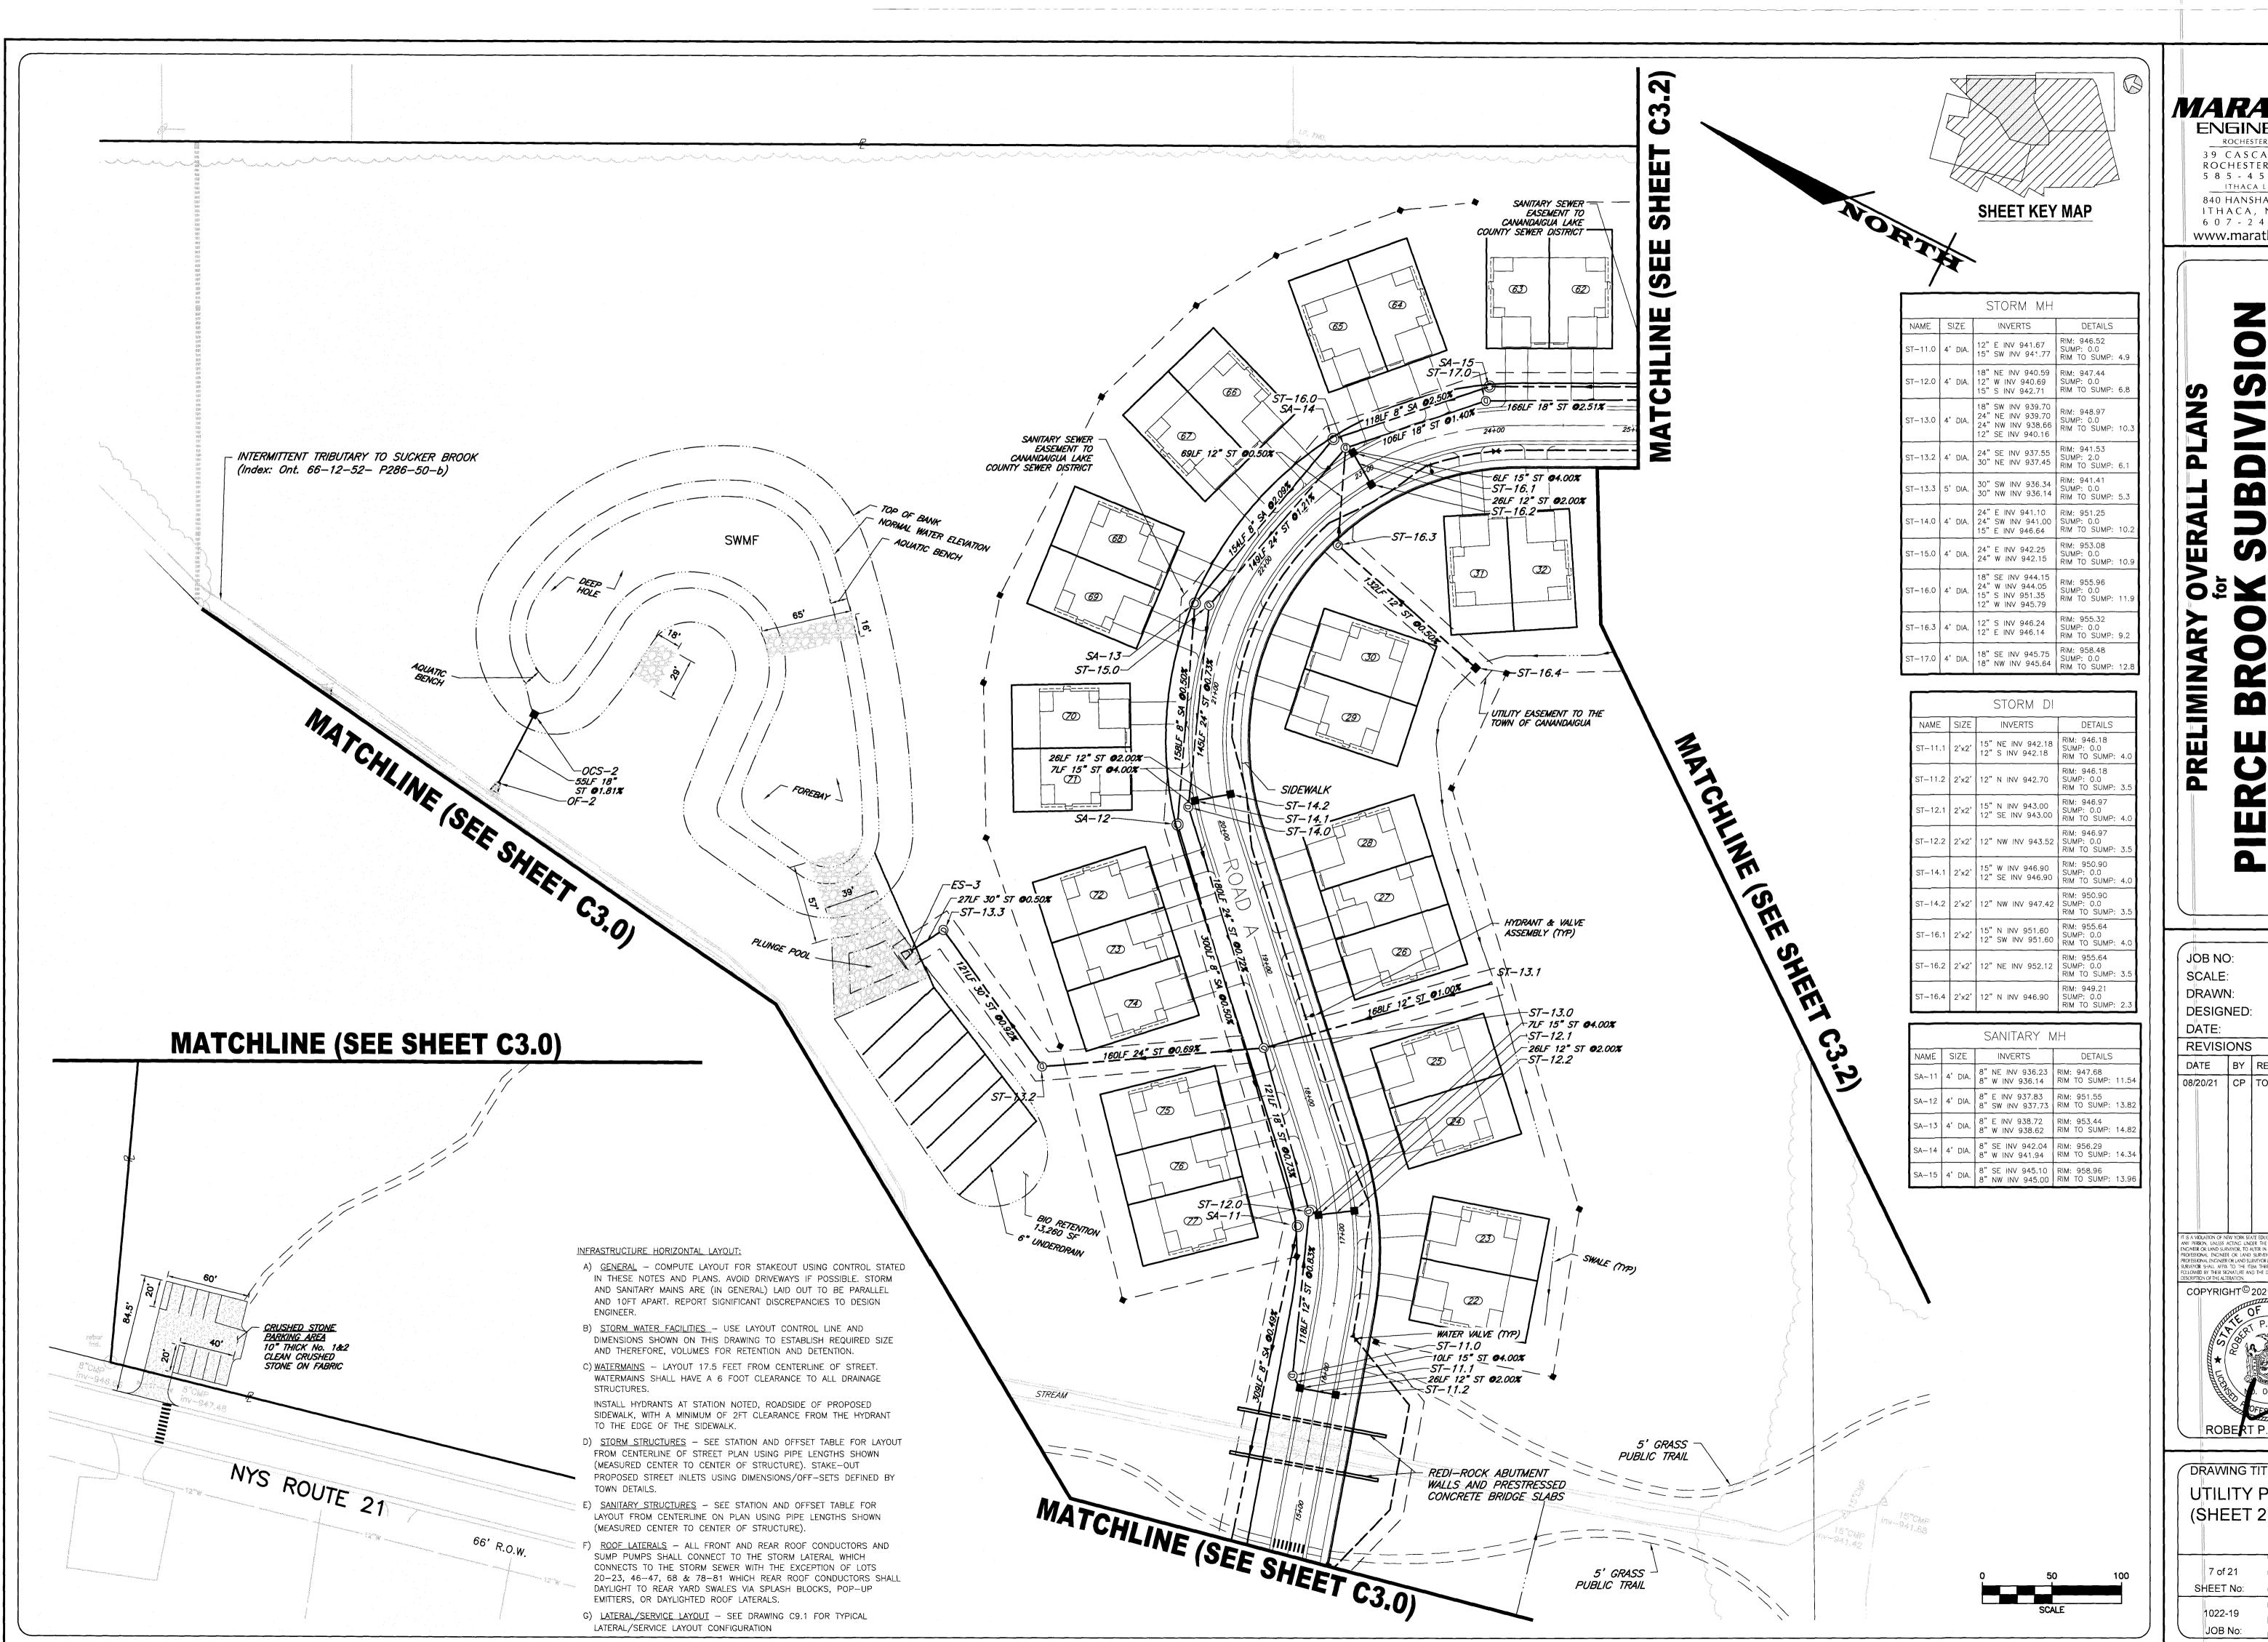
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DRAWING TITLE: UTILITY PLAN (SHEET 1 OF 3)

ROBERT P. BRINGLEY

6 of 21 SHEET No: 1022-19





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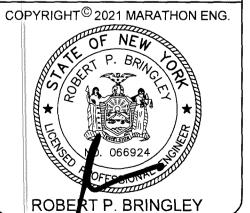
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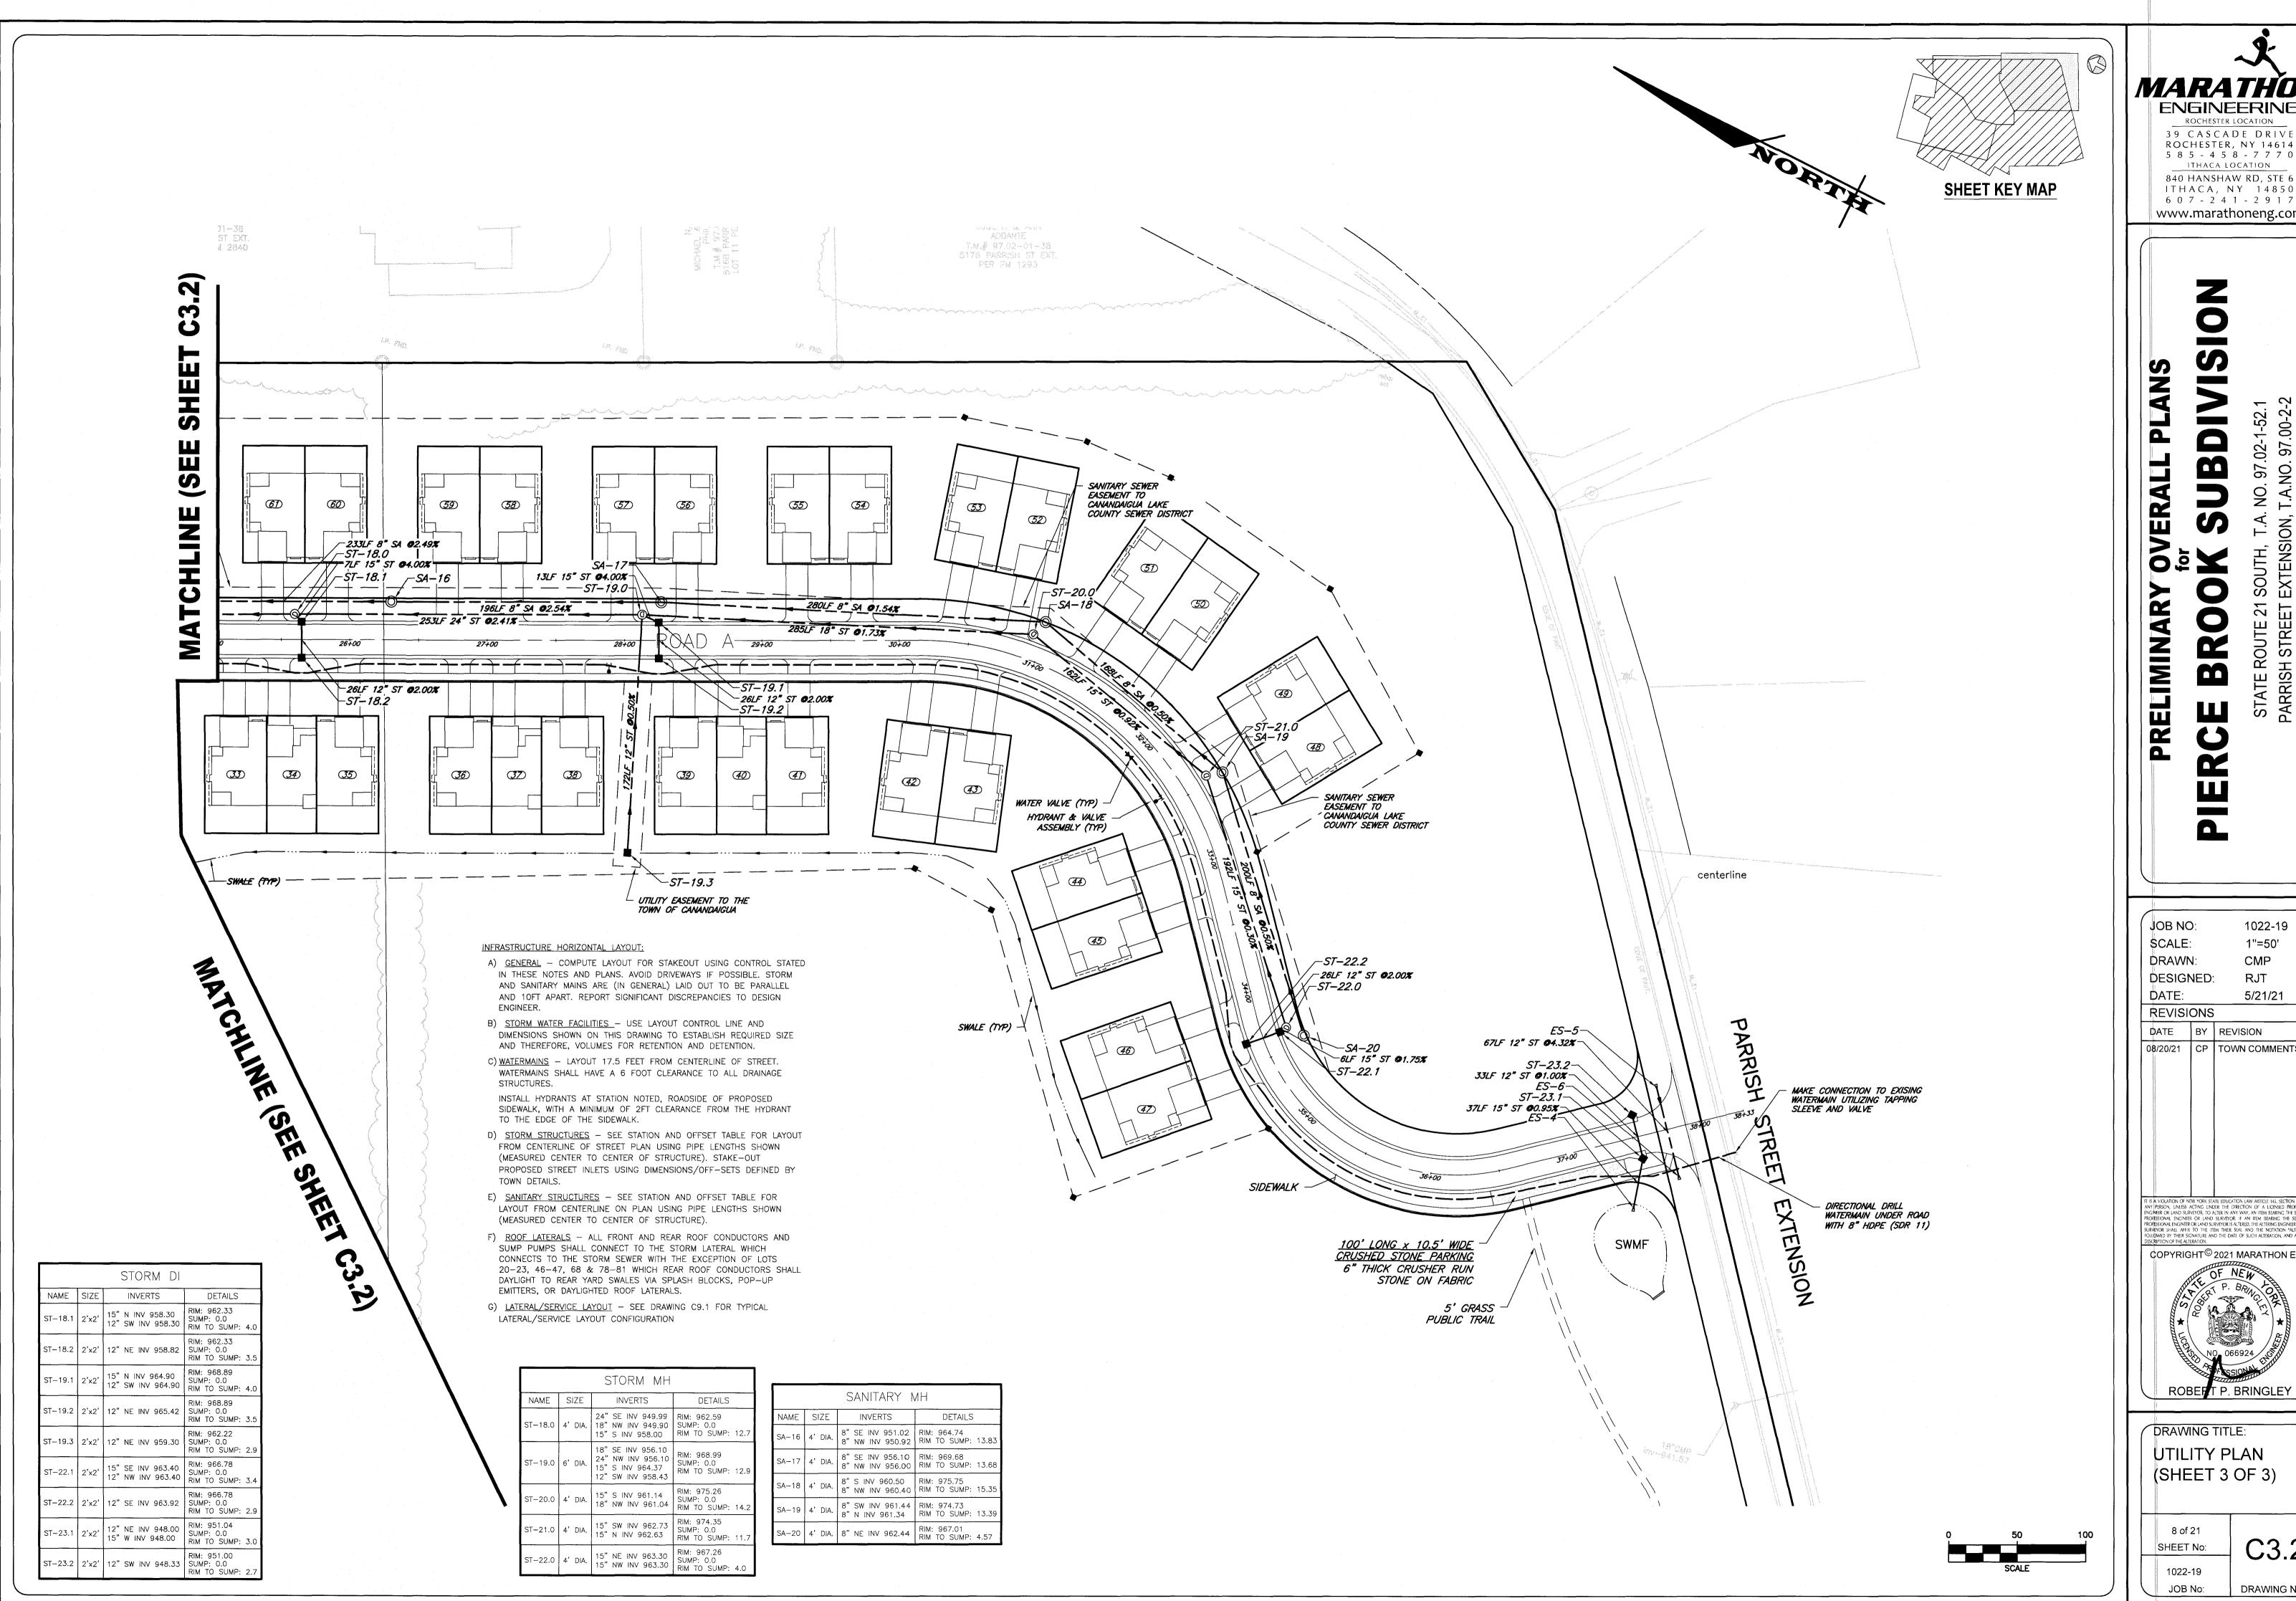
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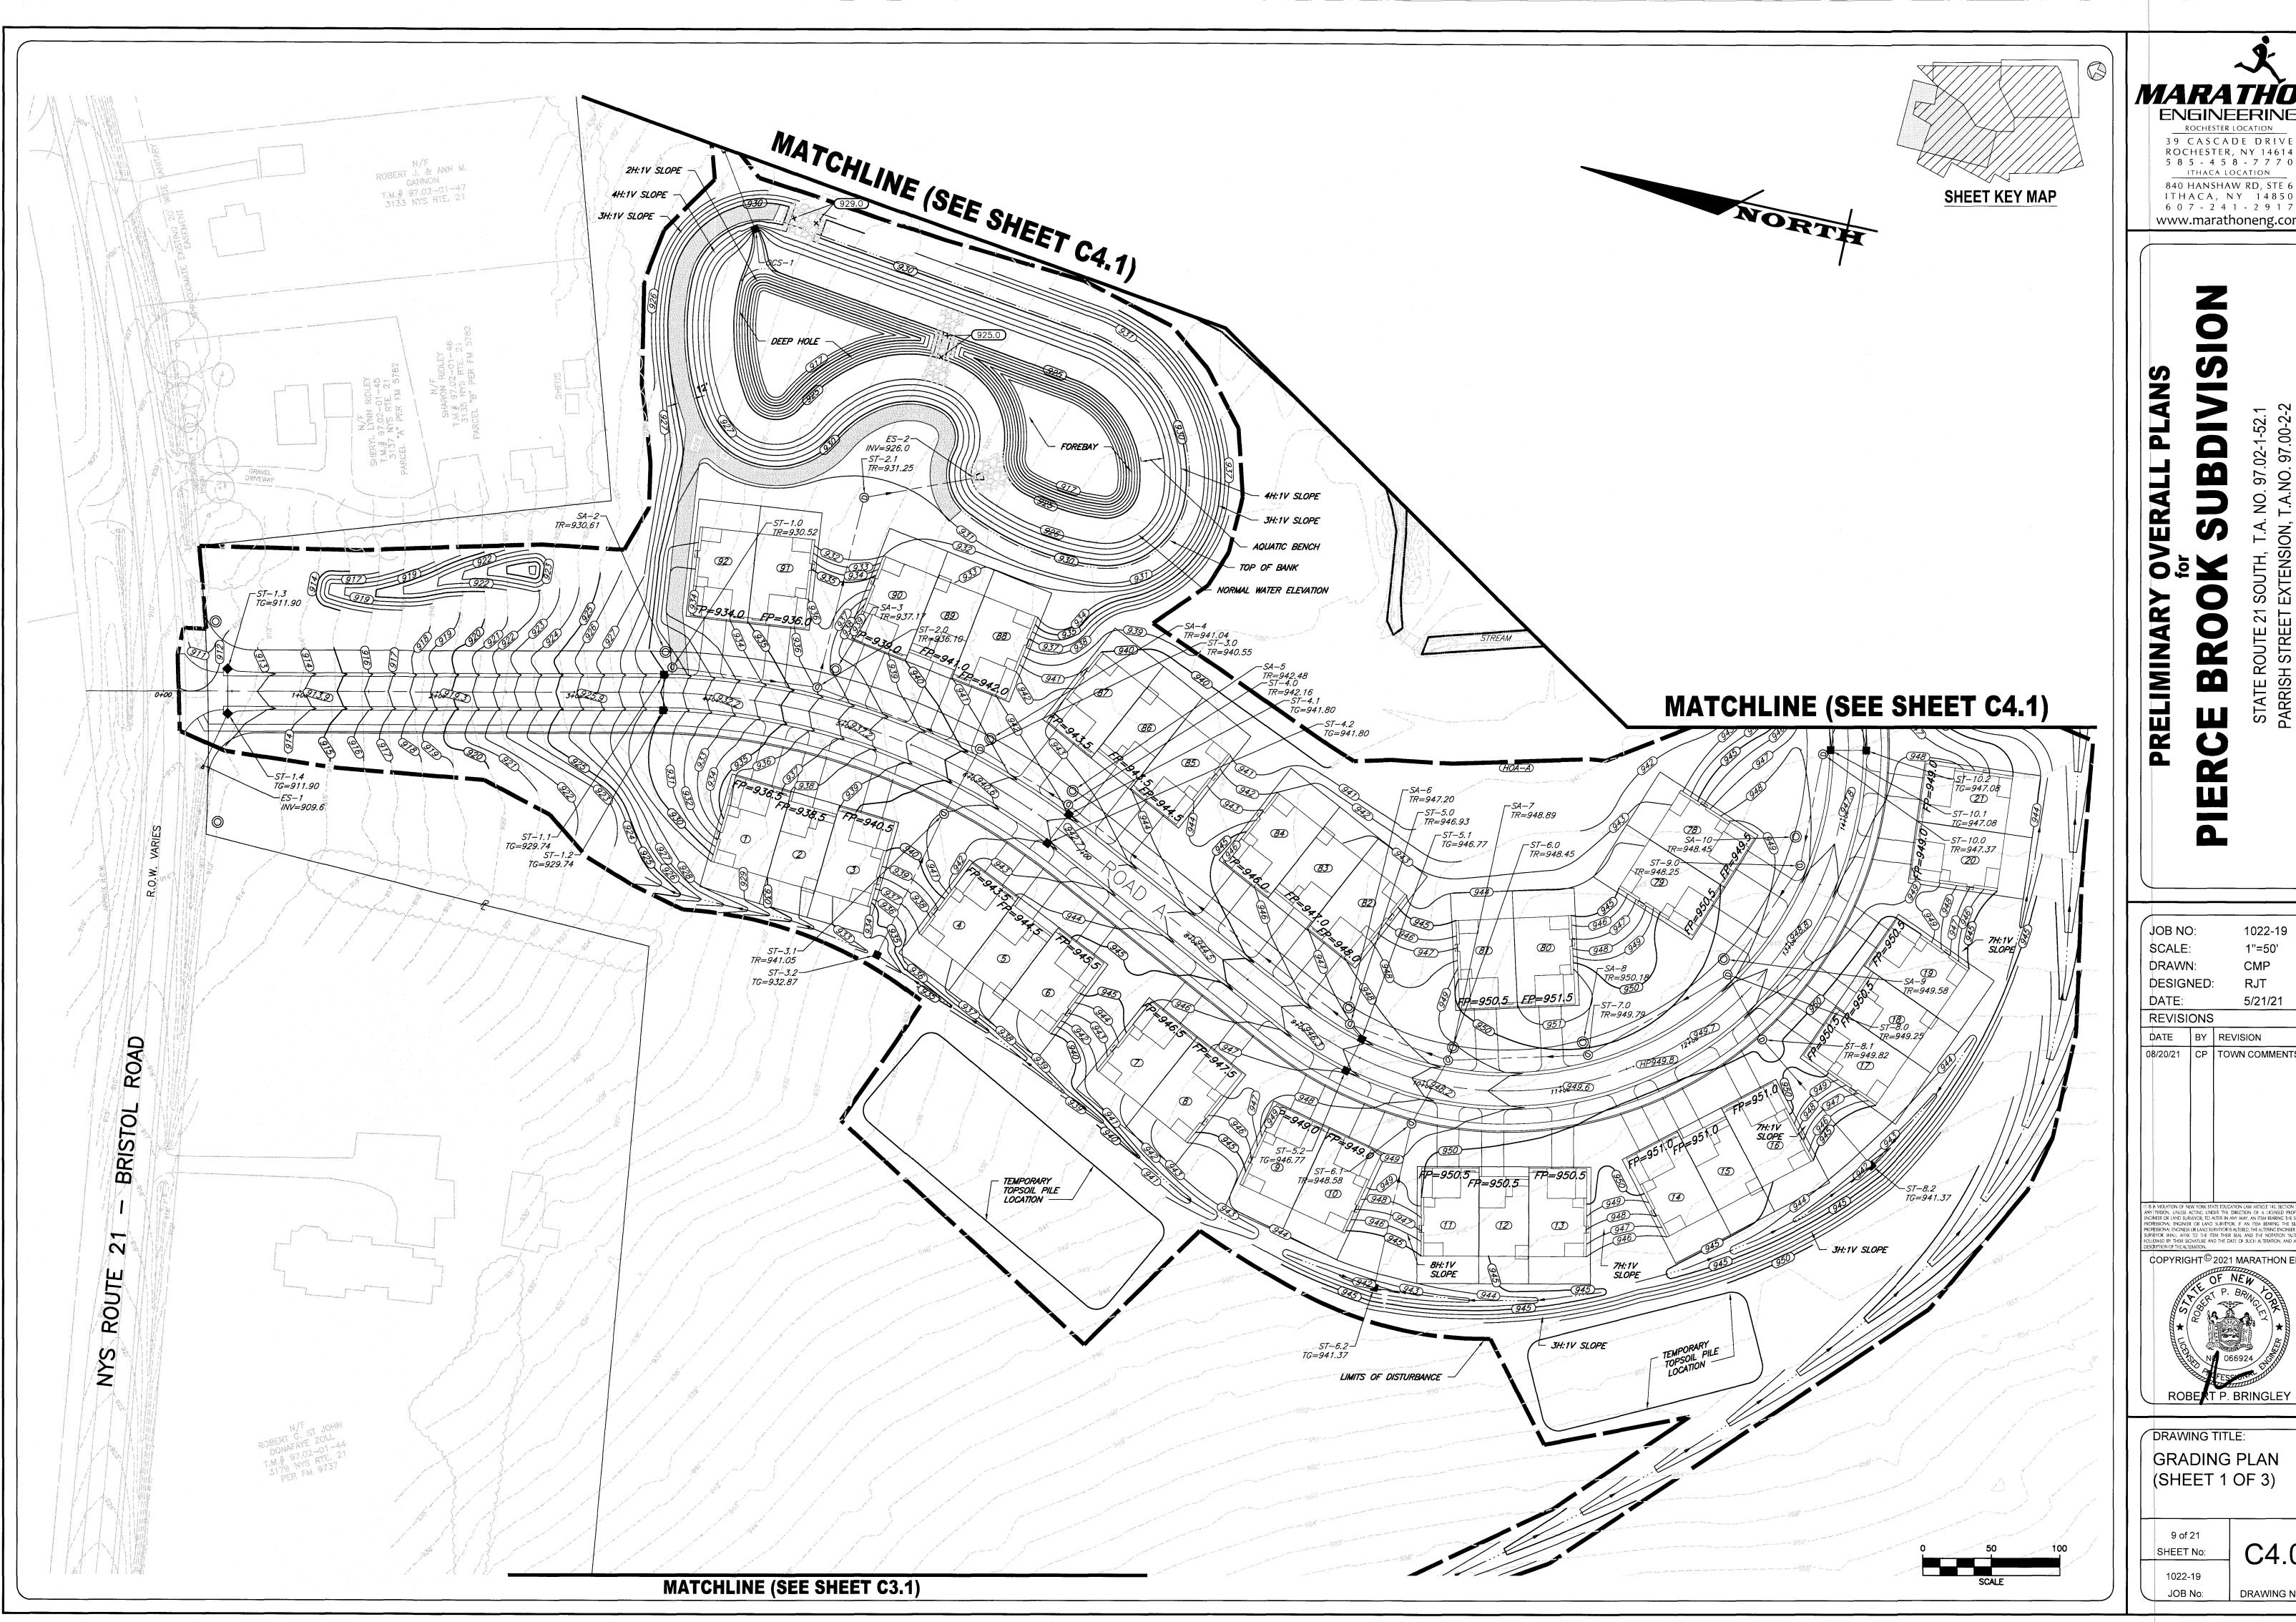
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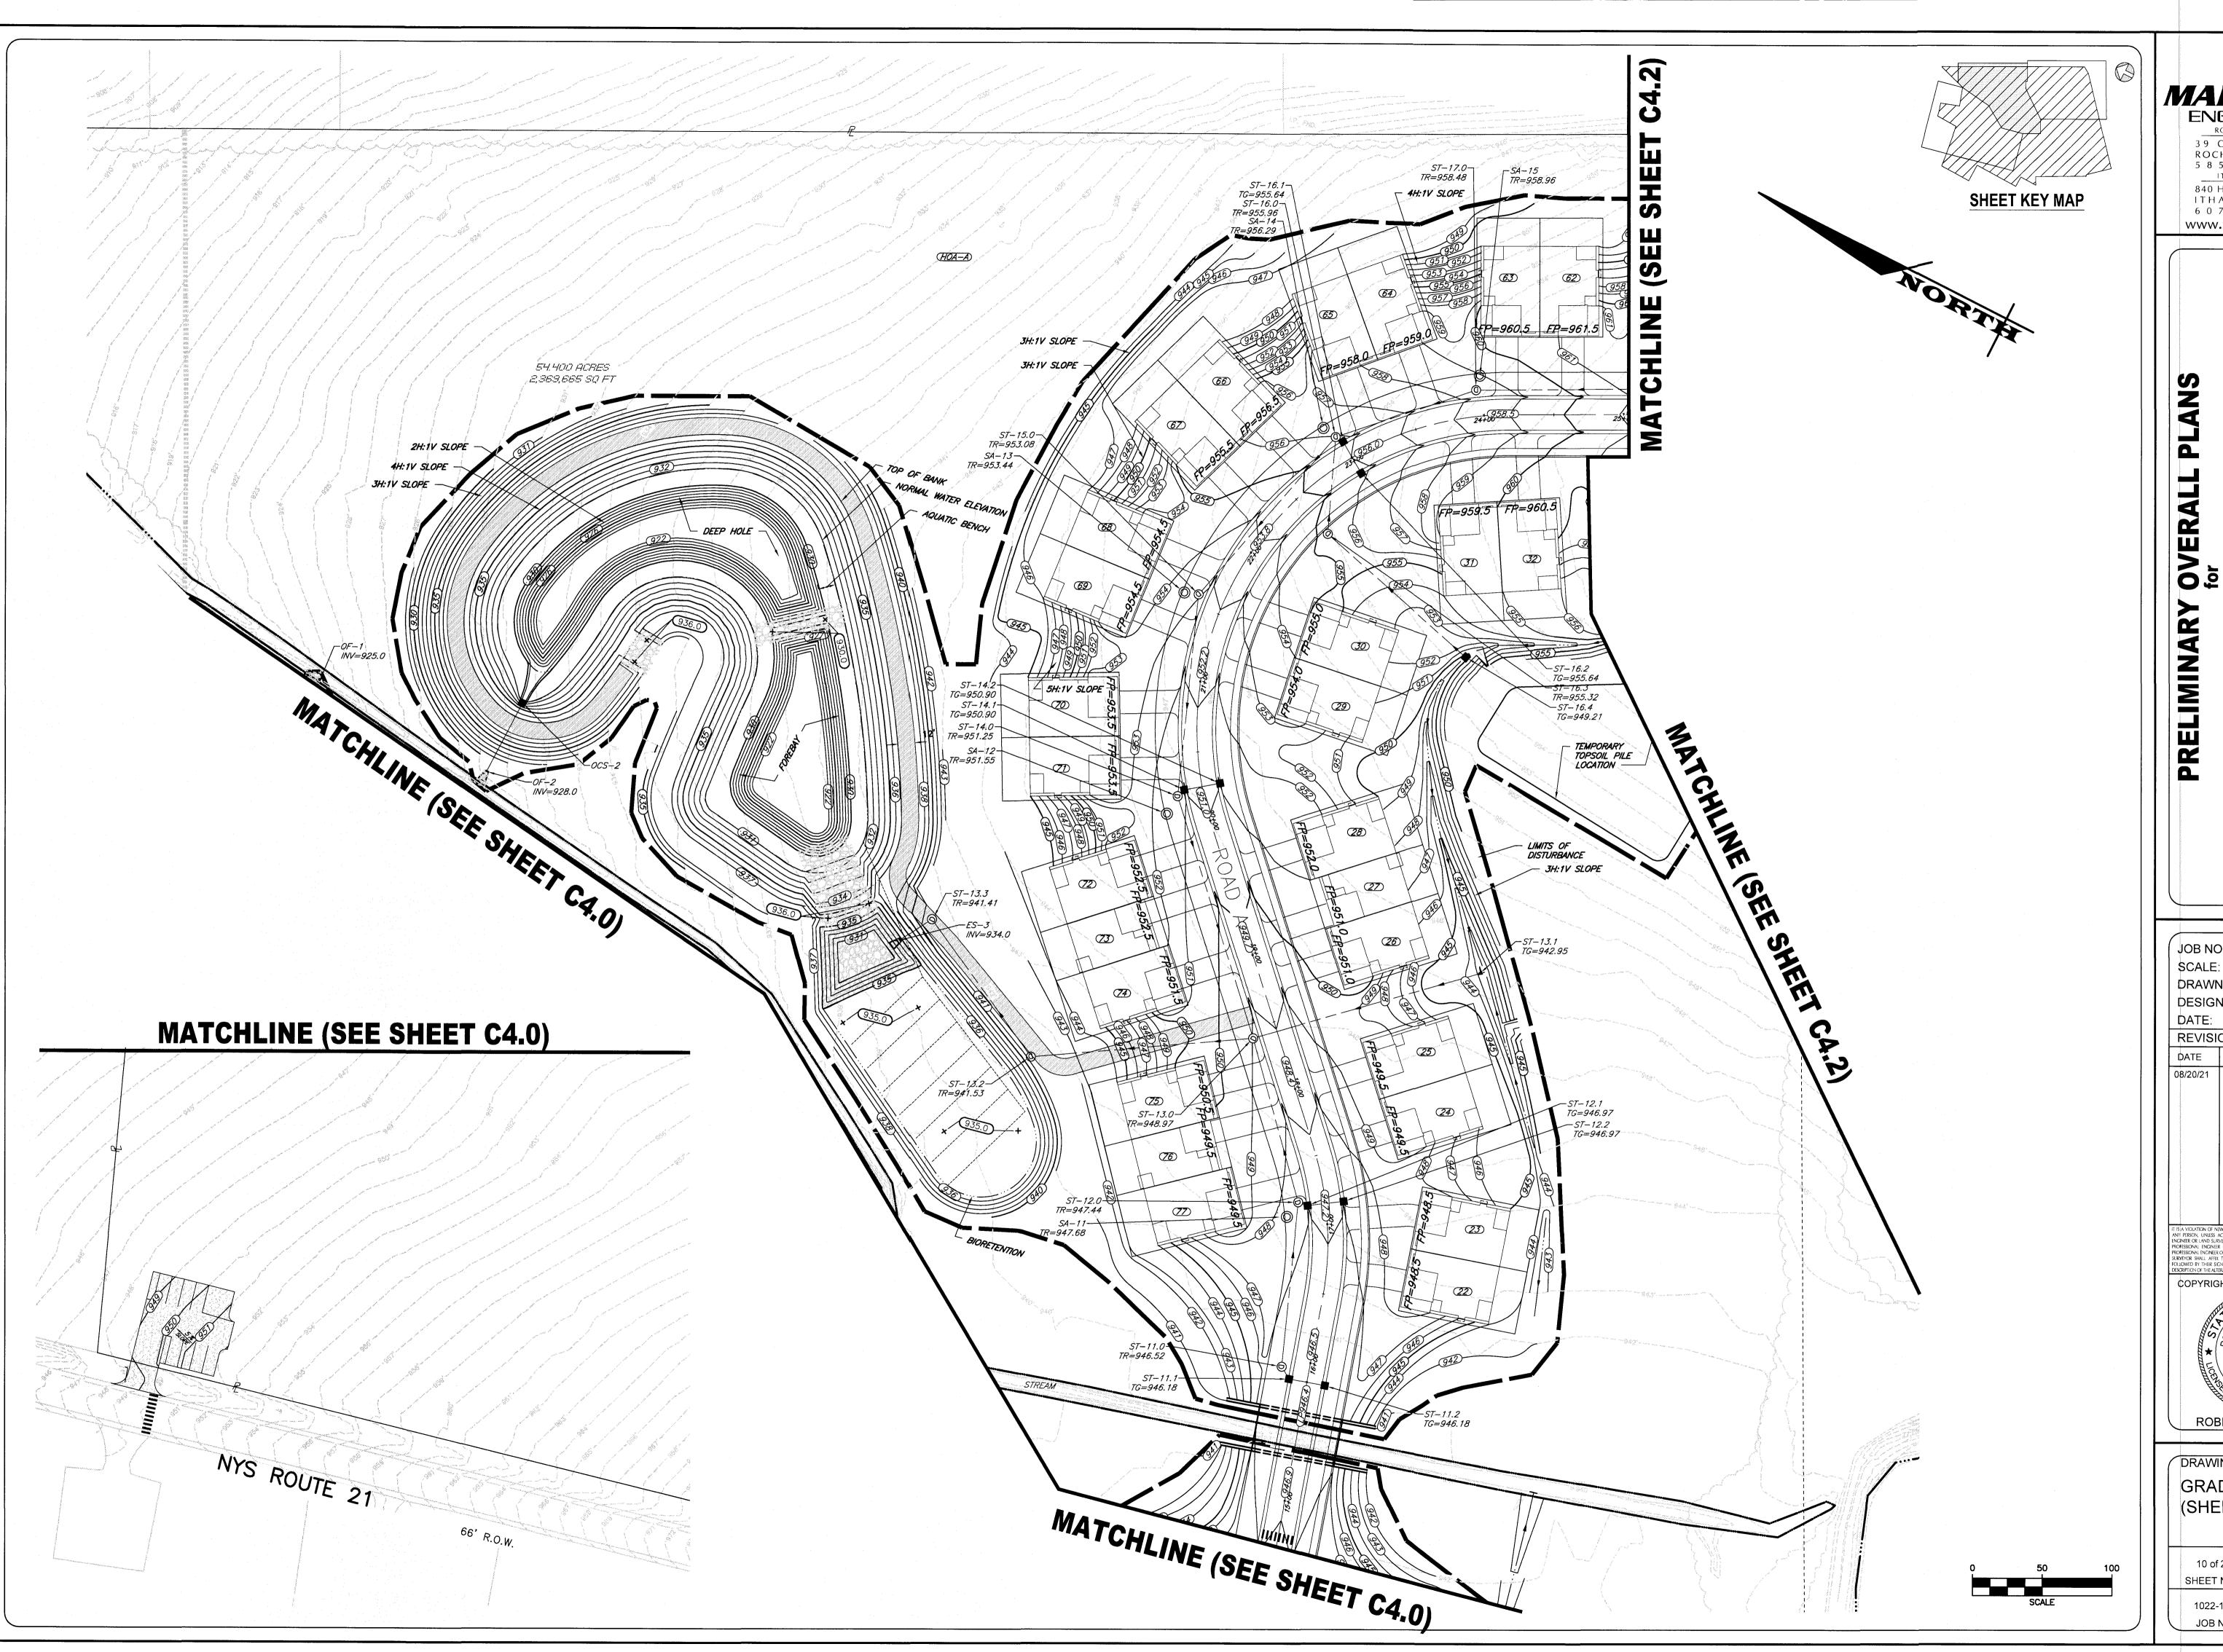
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JOB NO: 1022-19

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DRAWING TITLE:
GRADING PLAN
(SHEET 2 OF 3)

10 of 21
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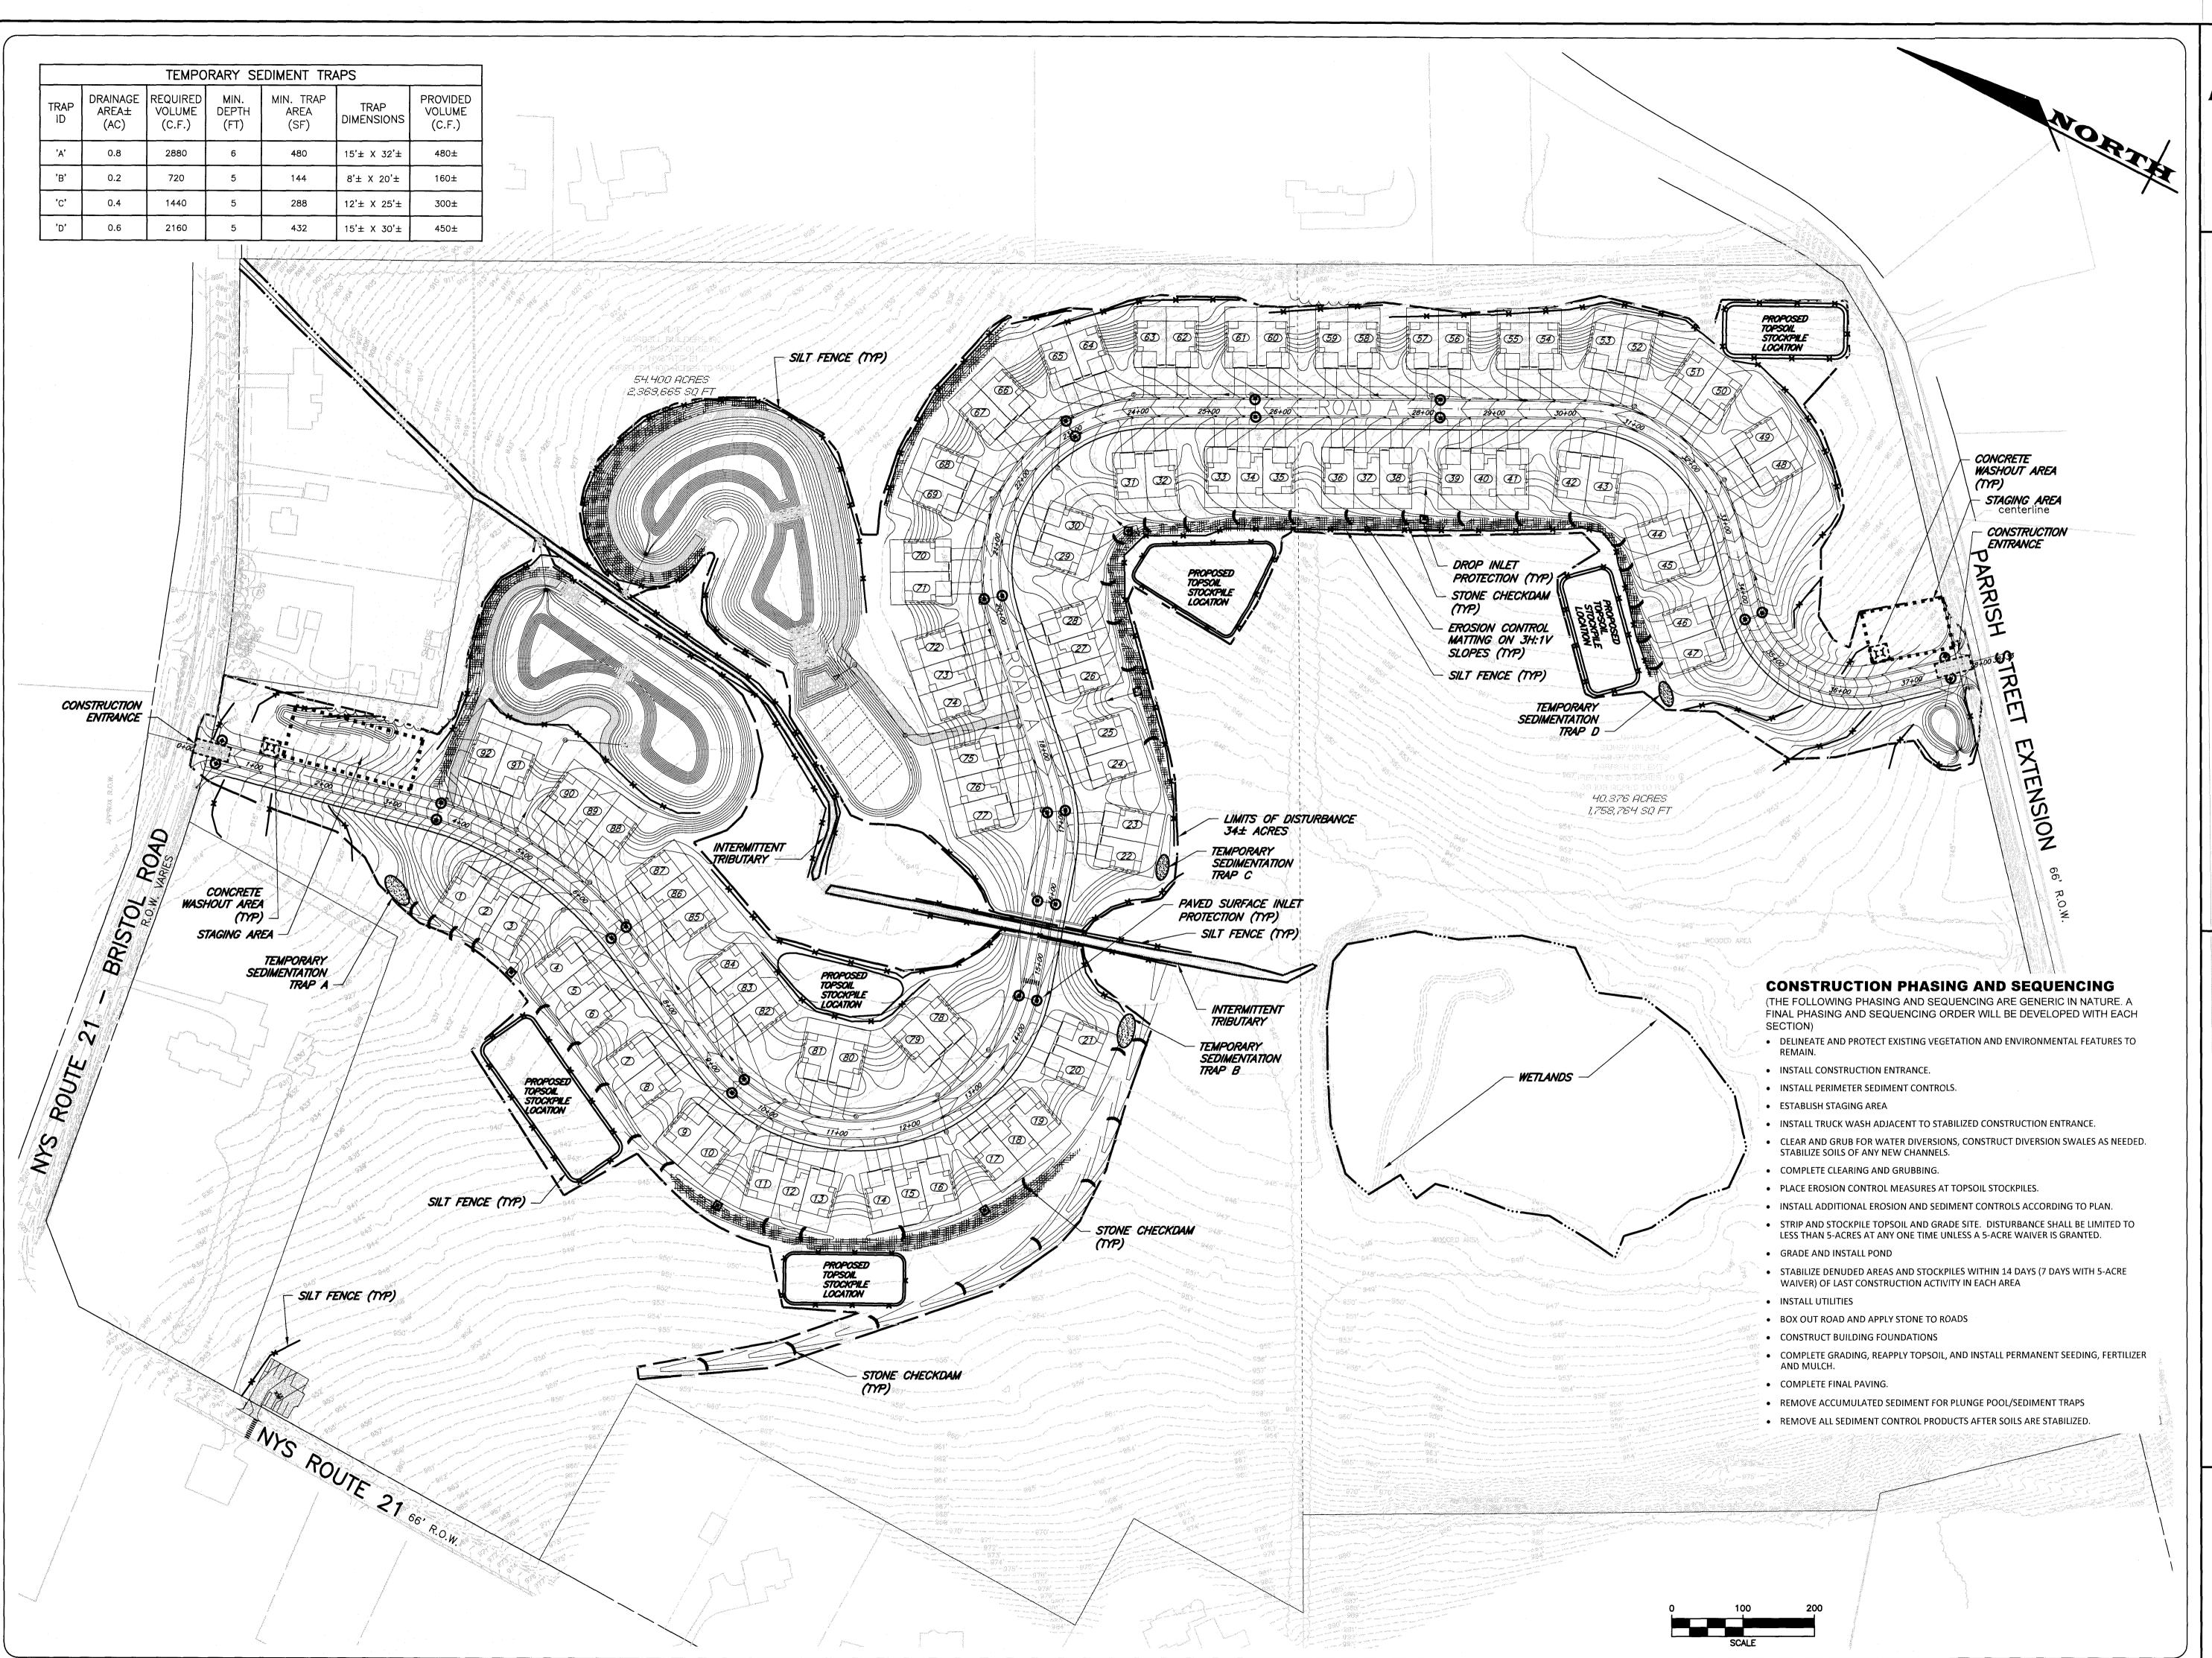
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DRAWING TITLE: **GRADING PLAN** (SHEET 3 OF 3)

11 of 21 SHEET No: 1022-19 JOB No: DRAWING No:





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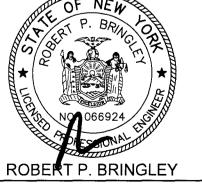
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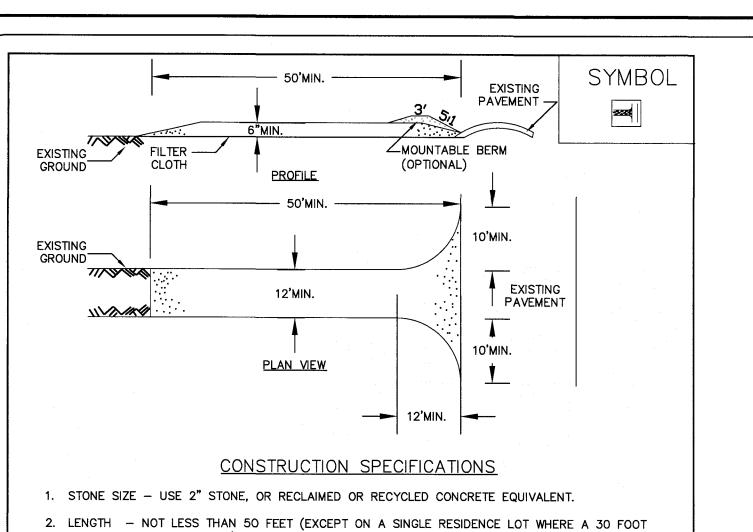


DRAWING TITLE: **EROSION AND** SEDIMENT **CONTROL PLAN** 

12 of 21 SHEET No: 1022-19

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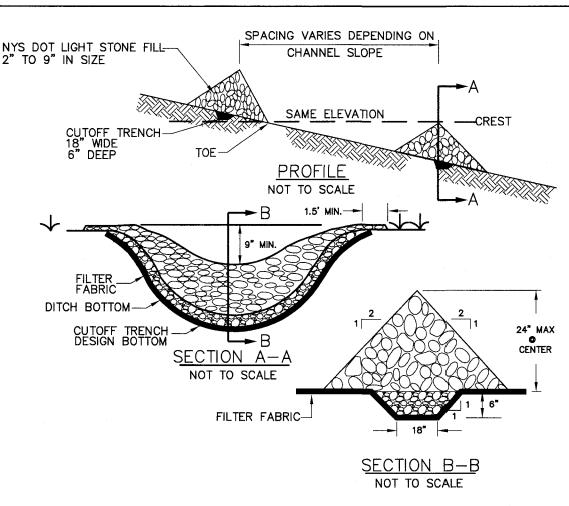


- MIN. LENGTH WOULD APPLY).
- 3. THICKNESS NOT LESS THAN SIX (6) INCHES.
- 4. WIDTH TWELVE (12) FOOT MINIMUM, BUT NOT LESS THAN THE FULL WIDTH AT POINTS WHERE INGRESS OR EGRESS OCCURS, TWENTY-FOUR (24) FOOT IF SINGLE ENTRANCE TO SITE.
- 5. FILTER CLOTH WILL BE PLACED OVER THE ENTIRE AREA PRIOR TO PLACING OF STONE.
- 6. SURFACE WATER ALL SURFACE WATER FLOWING OR DIVERTED TOWARD CONSTRUCTION ENTRANCES SHALL BE PIPED ACROSS THE ENTRANCE. IF PIPING IS IMPRACTICAL, A MOUNTABLE BERM WITH 5:1 SLOPES WILL BE PERMITTED.
- MAINTENANCE THE ENTRANCE SHALL BE MAINTAINED IN A CONDITION WHICH WILL PREVENT TRACKING OR FLOWING OF SEDIMENT ONTO PUBLIC RIGHTS-OF-WAY, ALL SEDIMENT SPILLED,
- DROPPED, TACKED, OR WASHED ONTO PUBLIC RIGHTS-OF-WAY MUST BE REMOVED IMMEDIATELY. 8. WHEN WASHING IS REQUIRED, IT SHALL BE DONE ON AN AREA STABILIZED WITH STONE AND WHICH
- 9. PERIODIC INSPECTION AND NEEDED MAINTENANCE SHALL BE PROVIDED AFTER EACH RAIN.

U.S. DEPARTMENT OF AGRICULTURE NATURAL RESOURCES CONSERVATION SERVICE NEW YORK STATE DEPARTMENT OF ENVIRONMENTAL CONSERVATION NEW YORK STATE SOIL & WATER CONSERVATION COMMITTEE

DRAINS INTO AN APPROVED SEDIMENT TRAPPING DEVICE.

STABILIZED CONSTRUCTION **ENTRANCE** 




# CONSTRUCTION SPECIFICATIONS

STONE CHECK DAM

SCALE: N.T.S


- 1. STONE WILL BE PLACED ON A FILTER FABRIC FOUNDATION TO THE LINES, GRADES AND LOCATION SHOWN ON IN THE PLAN
- 2. SET SPACING OF CHECK DAMS TO ASSUME THAT THE ELEVATIONS OF THE CREST OF THE DOWNSTREAM DAM IS AT THE SAME ELEVATION OF THE UPSTREAM DAM.
- 3. EXTEND THE STONE A MINIMUM OF 1.5 FEET BEYOND THE DITCH BANKS TO PREVENT CUTTING AROUND THE DAM,
- 4. PROTECT THE CHANNEL DOWNSTREAM OF THE LOWEST CHECK DAM FROM SCOUR AND EROSION WITH STONE OR LINER AS APPROPRIATE.
- 5. ENSURE THAT CHANNEL APPURTENANCES SUCH AS CULVERT ENTRANCES BELOW CHECK DAMS ARE NOT SUBJECT TO DAMAGE OF BLOCKAGE FROM DISPLACED STONES. MAXIMUM DRAINAGE AREA - 2 ACRES

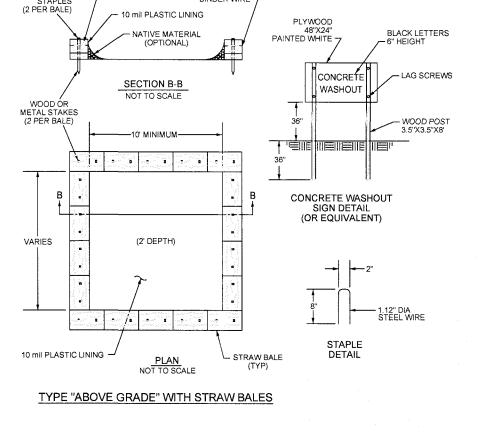

- STRAW BALE

1. ACTUAL LAYOUT TO BE DETERMINED IN THE FIELD. 2. A CONCRETE WASHOUT SIGN SHALL BE INSTALLED WITHIN 30' OF THE TEMPORARY CONCRETE WASHOUT 3. MATERIALS USED TO CONSTRUCT TEMPORARY CONCRET WASHOUT FACILITIES SHALL BE REMOVED FROM THE SITE OF THE WORK AND DISPOSED OF OR RECYCLED. 4. HOLES, DEPRESSIONS OR OTHER GROUND DISTURBANCE CAUSED BY THE REMOVAL OF THE TEMPORARY CONCRETE WASHOUT FACILITIES SHALL BE BACKFILLED, REPAIRED, AND STABILIZED TO PREVENT EROSION.



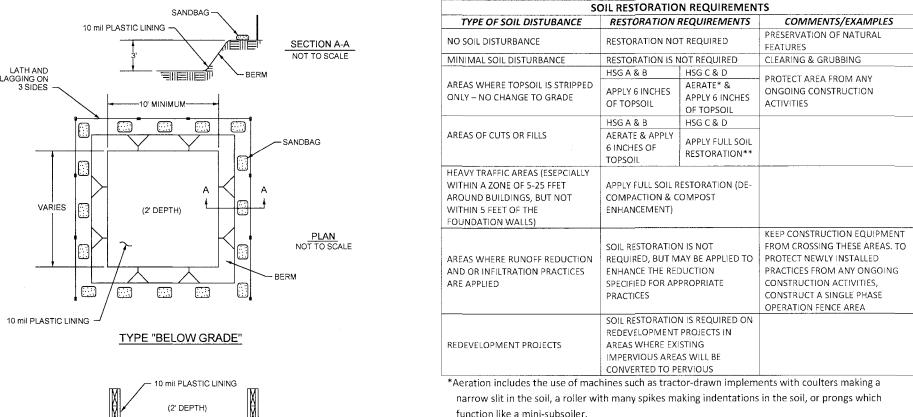

narrow slit in the soil, a roller with many spikes making indentations in the soil, or prongs which function like a mini-subsoiler.


\*\* Per "Deep Ripping and De-compaction, DEC 2008"

- 1. DURING PERIODS OF RELATIVELY LOW TO MODERATE SUBSOIL MOISTURE, THE DISTURBED SUBSOILS ARE RETURNED TO ROUGH GRADE AND THE FOLLOWING SOIL RESTORATION STEPS
- APPLY 3 INCHES OF COMPOST OVER SUBSOIL
- TILL COMPOST INTO SUBSOIL TO A DEPTH OF AT LEAST 12 INCHES USING A CAT-MOUNTED RIPPER, TRACTOR-MOUNTED DISC, OR TILLER, MIXING, AND CIRCULATING AIR AND COMPOST
- ROCK-PICK UNTIL UPLIFTED STONE/ROCK MATERIALS OF FOUR INCHES AND LARGER SIZE ARE CLEANED OFF THE SITE
- APPLY TOPSOIL TO A DEPTH OF 6 INCHES

\*\*SOIL RESTORATION APPLIES TO ALL DISTURBED AREAS THAT ARE TO REMAIN AS PERVIOUS AREAS AFTER FINAL CONSTRUCTION.

SOIL RESTORATION

SCALE: N.T.S

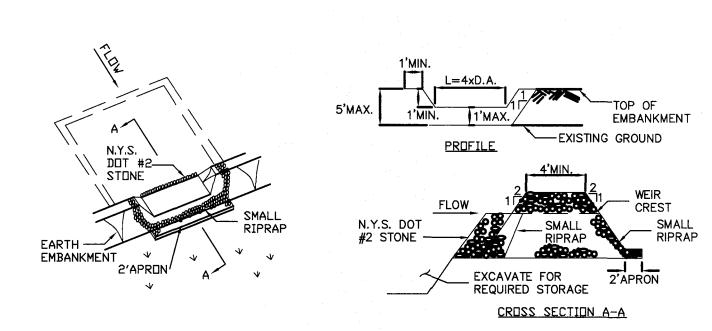

CONSTRUCTION SPECIFICATIONS

1. AREA UNDER EMBANKMENT SHALL BE CLEARED, GRUBBED AND STRIPPED OF ANY VEGETATION AND ROOT MAT. THE POOL AREA SHALL BE CLEARED. THE FILL MATERIAL FOR THE EMBANKMENT SHALL BE FREE OF ROOTS AND OTHER WOODY VEGETATION AS WELL AS OVER-SIZED STONES, ROCKS, ORGANIC MATERIAL OR OTHER OBJECTIONABLE MATERIAL. THE EMBANKMENT SHALL BE COMPACTED BY

- TRAVERSING WITH EQUIPMENT WHILE IT IS BEING CONSTRUCTED. 3. ALL CUT AND FILL SLOPES SHALL BE 2:1 OR FLATTER. THE STONE USED IN THE OUTLET SHALL BE SMALL RIPRAP 4"-8" ALONG WITH A 1' THICKNESS OF 2" AGGREGATE PLACED ON THE UP-GRADE SIDE ON THE SMALL RIPRAP OR EMBEDDED FILTER CLOTH IN THE RIPRAP.
   SEDIMENT SHALL BE REMOVED AND TRAP RESTORED TO ITS ORIGINAL DIMENSIONS WHEN THE SEDIMENT HAS ACCUMULATED TO
- 1/2 THE DESIGN DEPTH OF THE TRAP. IT SHALL BE PLACED ON SITE AND STABILIZED.


  6. THE STRUCTURE SHALL BE INSPECTED AFTER EACH RAIN AND REPAIRS MADE AS NEEDED.

  7. CONSTRUCTION OPERATIONS SHALL BE CARRIED OUT IN SUCH A MANNER THAT EROSION AND SEDIMENT ARE CONTROLLED.


  8. THE STRUCTURE SHALL BE REMOVED AND THE AREA STABILIZED WHEN THE DRAINAGE AREA HAS BEEN PROPERLY STABILIZED.

MAXIMUM DRAINAGE AREA 5 ACRES

TEMPORARY SEDIMENTATION TRAP SCALE: N.T.S

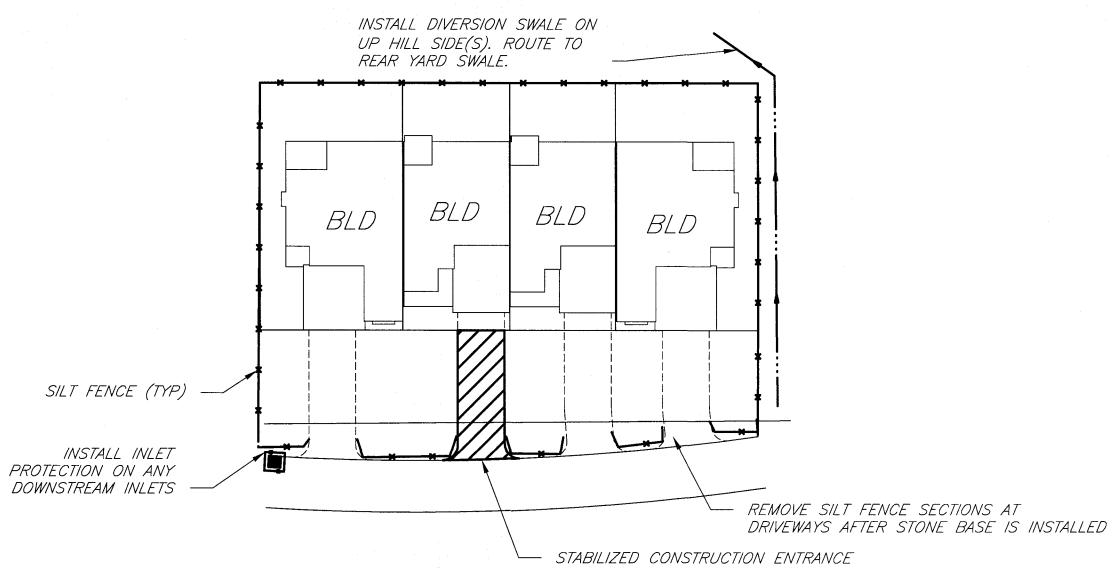

TYP. BUILDING CONSTRUCTION EROISION CONTROL DETAIL SCALE: N.T.S

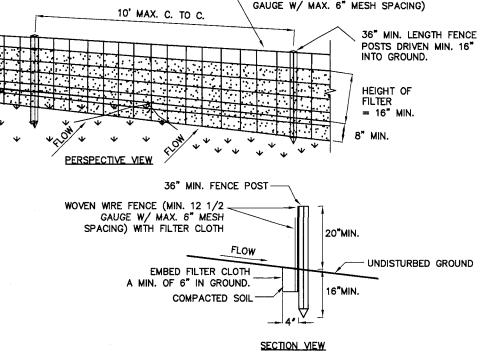


WOVEN WIRE FENCE (MIN. 14 1/2

OR APPROVED EQUIVALENT.

- 1. WOVEN WIRE FENCE TO BE FASTENED SECURELY TO FENCE POSTS WITH WIRE TIES OR STAPLES, POSTS SHALL BE STEEL "T" OF "U" TYPE OF HARDWOOD.
- 2. FILTER CLOTH TO BE FASTENED SECURELY TO WOVEN WIRE FENCE WITH TIES SPACED EVERY 24" AT TOP AND MID SECTION. FENCE SHALL BE WOVEN WIRE, 12 1/2 GAUGE, 6" MAXIMUM MESH
- 3. WHEN TWO SECTIONS OF FILTER CLOTH ADJOIN EACH OTHER THEY SHALL BE OVERLAPPED BY SIX INCHES AND FOLDED. FILTER CLOTH SHALL BE EITHER FILTER X, MIRAFI 100X, STABLINKKA T140N,
- 4. PREFABRICATED UNITS SHALL BE GEOFAB, ENVIROFENCE, OR APPROVED EQUIVALENT.
- 5. MAINTENANCE SHALL BE PERFORMED AS NEEDED AND MATERIAL REMOVED WHEN "BULGES" DEVELOP IN THE SILT FENCE.
- 6. ENVIRO-FENCE WITH INTEGRAL MESH IS AN ACCEPTABLE SUBSTITUTE.

SILT FENCE SCALE: N.T.S

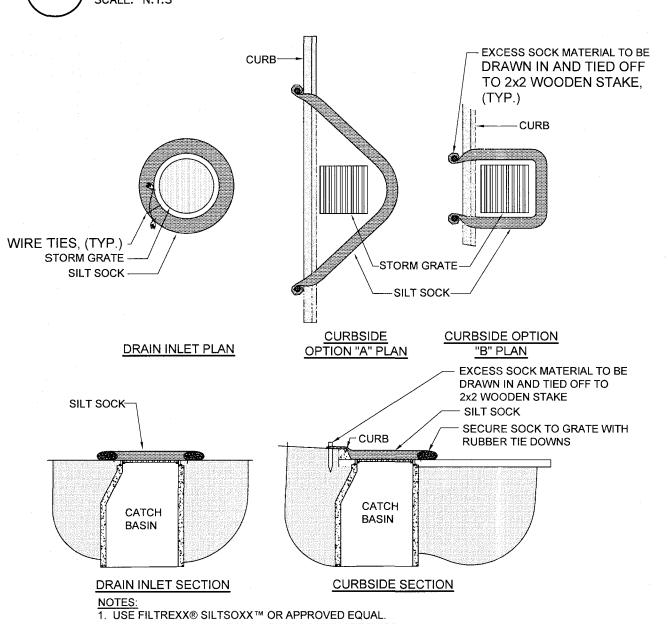

2. FILTER MEDIA™ FILL TO MEET APPLICATION REQUIREMENTS.

(9)

3. COMPOST MATERIAL TO BE DISPERSED ON SITE, AS DETERMINED BY ENGINEER.


\ PAVED SURFACE INLET PROTECTION


**UP-SLOPE TRENCH INSTALLATION DETAIL (DIAGRAM A)** 


(2' DEPTH)

WITH TWO STAKES

10 mil PLASTIC LINING

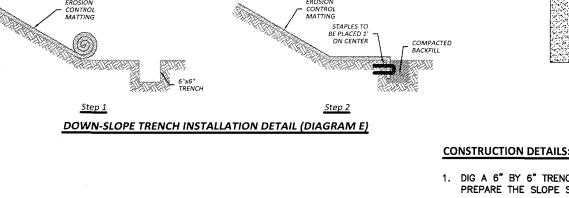

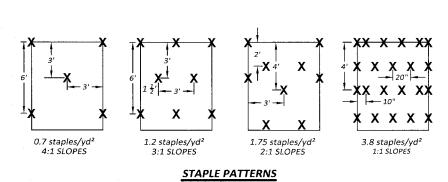

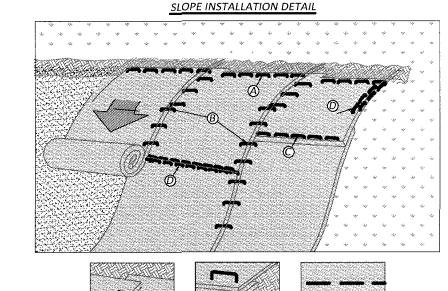

12" APART ACROSS THE WIDTH OF THE BLANKETS.

1. DIG A 6" BY 6" TRENCH BOTH UP-SLOPE AND DOWN-SLOPE OF THE AREA THE MATTING IS TO BE APPLIED.

PREPARE THE SLOPE SOIL SURFACE (RAKING, SEEDING AND FERTILIZING). 2. BEGIN BY PLACING THE BLANKET A MINIMUM OF 12" DOWN-SLOPE OF THE UP-SLOPE TRENCH. SECURE THE BLANKET AT THE BOTTOM OF THE TRENCH WITH STAPLES PLACED 12" APART. BACKFILL AND COMPACT THE TRENCH. APPLY SEED, AND FOLD THE BLANKET OVER SOIL, SECURE WITH A ROW OF STAPLES PLACED 12" APART ACROSS THE WIDTH OF THE BLANKET. (SEE DIAGRAM A)

3. ROLL THE BLANKET VERTICALLY DOWN THE SLOPE. SECURE USING THE APPROPRIATE STAPLE PATTERN BELOW,

- SPECIFIED BY SLOPE. (SEE STAPLE PATTERNS) PARALLEL BLANKETS MUST BE OVERLAPPED BY A MINIMUM OF 4", AND SECURED WITH A ROW OF STAPLES PLACED
- APPROXIMATELY 3'-0" APART. (SEE DIAGRAM B) 5. ADDITIONAL VERTICAL BLANKETS CAN BE JOINED USING A MINIMUM 4" OVERLAPPING OR SHINGLE STYLE (SEE DIAGRAMS C) IN THE DIRECTION OF WATER FLOW. CONNECT THE BLANKETS BY PLACING STAPLES APPROXIMATELY
- 6. FOR MAXIMUM PERFORMANCE A CHECK SLOT SHOULD BE PLACED AT 25'-40' INTERVALS. PLACE A ROW OF STAPLES 4" APART ALONG THE ENTIRE WIDTH OF THE SLOPE. A SECOND ROW SHOULD BE PLACED 4" BELOW IN A STAGGERED PATTERN. THEN CONTINUE WITH GENERAL INSTALLATION. (SEE DIAGRAMS D)
- 7. THE END OF BLANKET MUST BE SECURED IN A 6" X 6" TRENCH WITH A ROW OF STAPLES PLACED AT 12" INTERVALS. (DIAGRAM E)

**EROSION CONTROL BLANKET** 



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DRAWING TITLE: **EROSION AND** SEDIMENT **CONTROL DETAILS** 

13 of 21 SHEET No: 1022-19

V SCALE: 1"=5' H SCALE: 1"=50'



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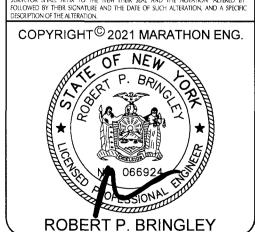
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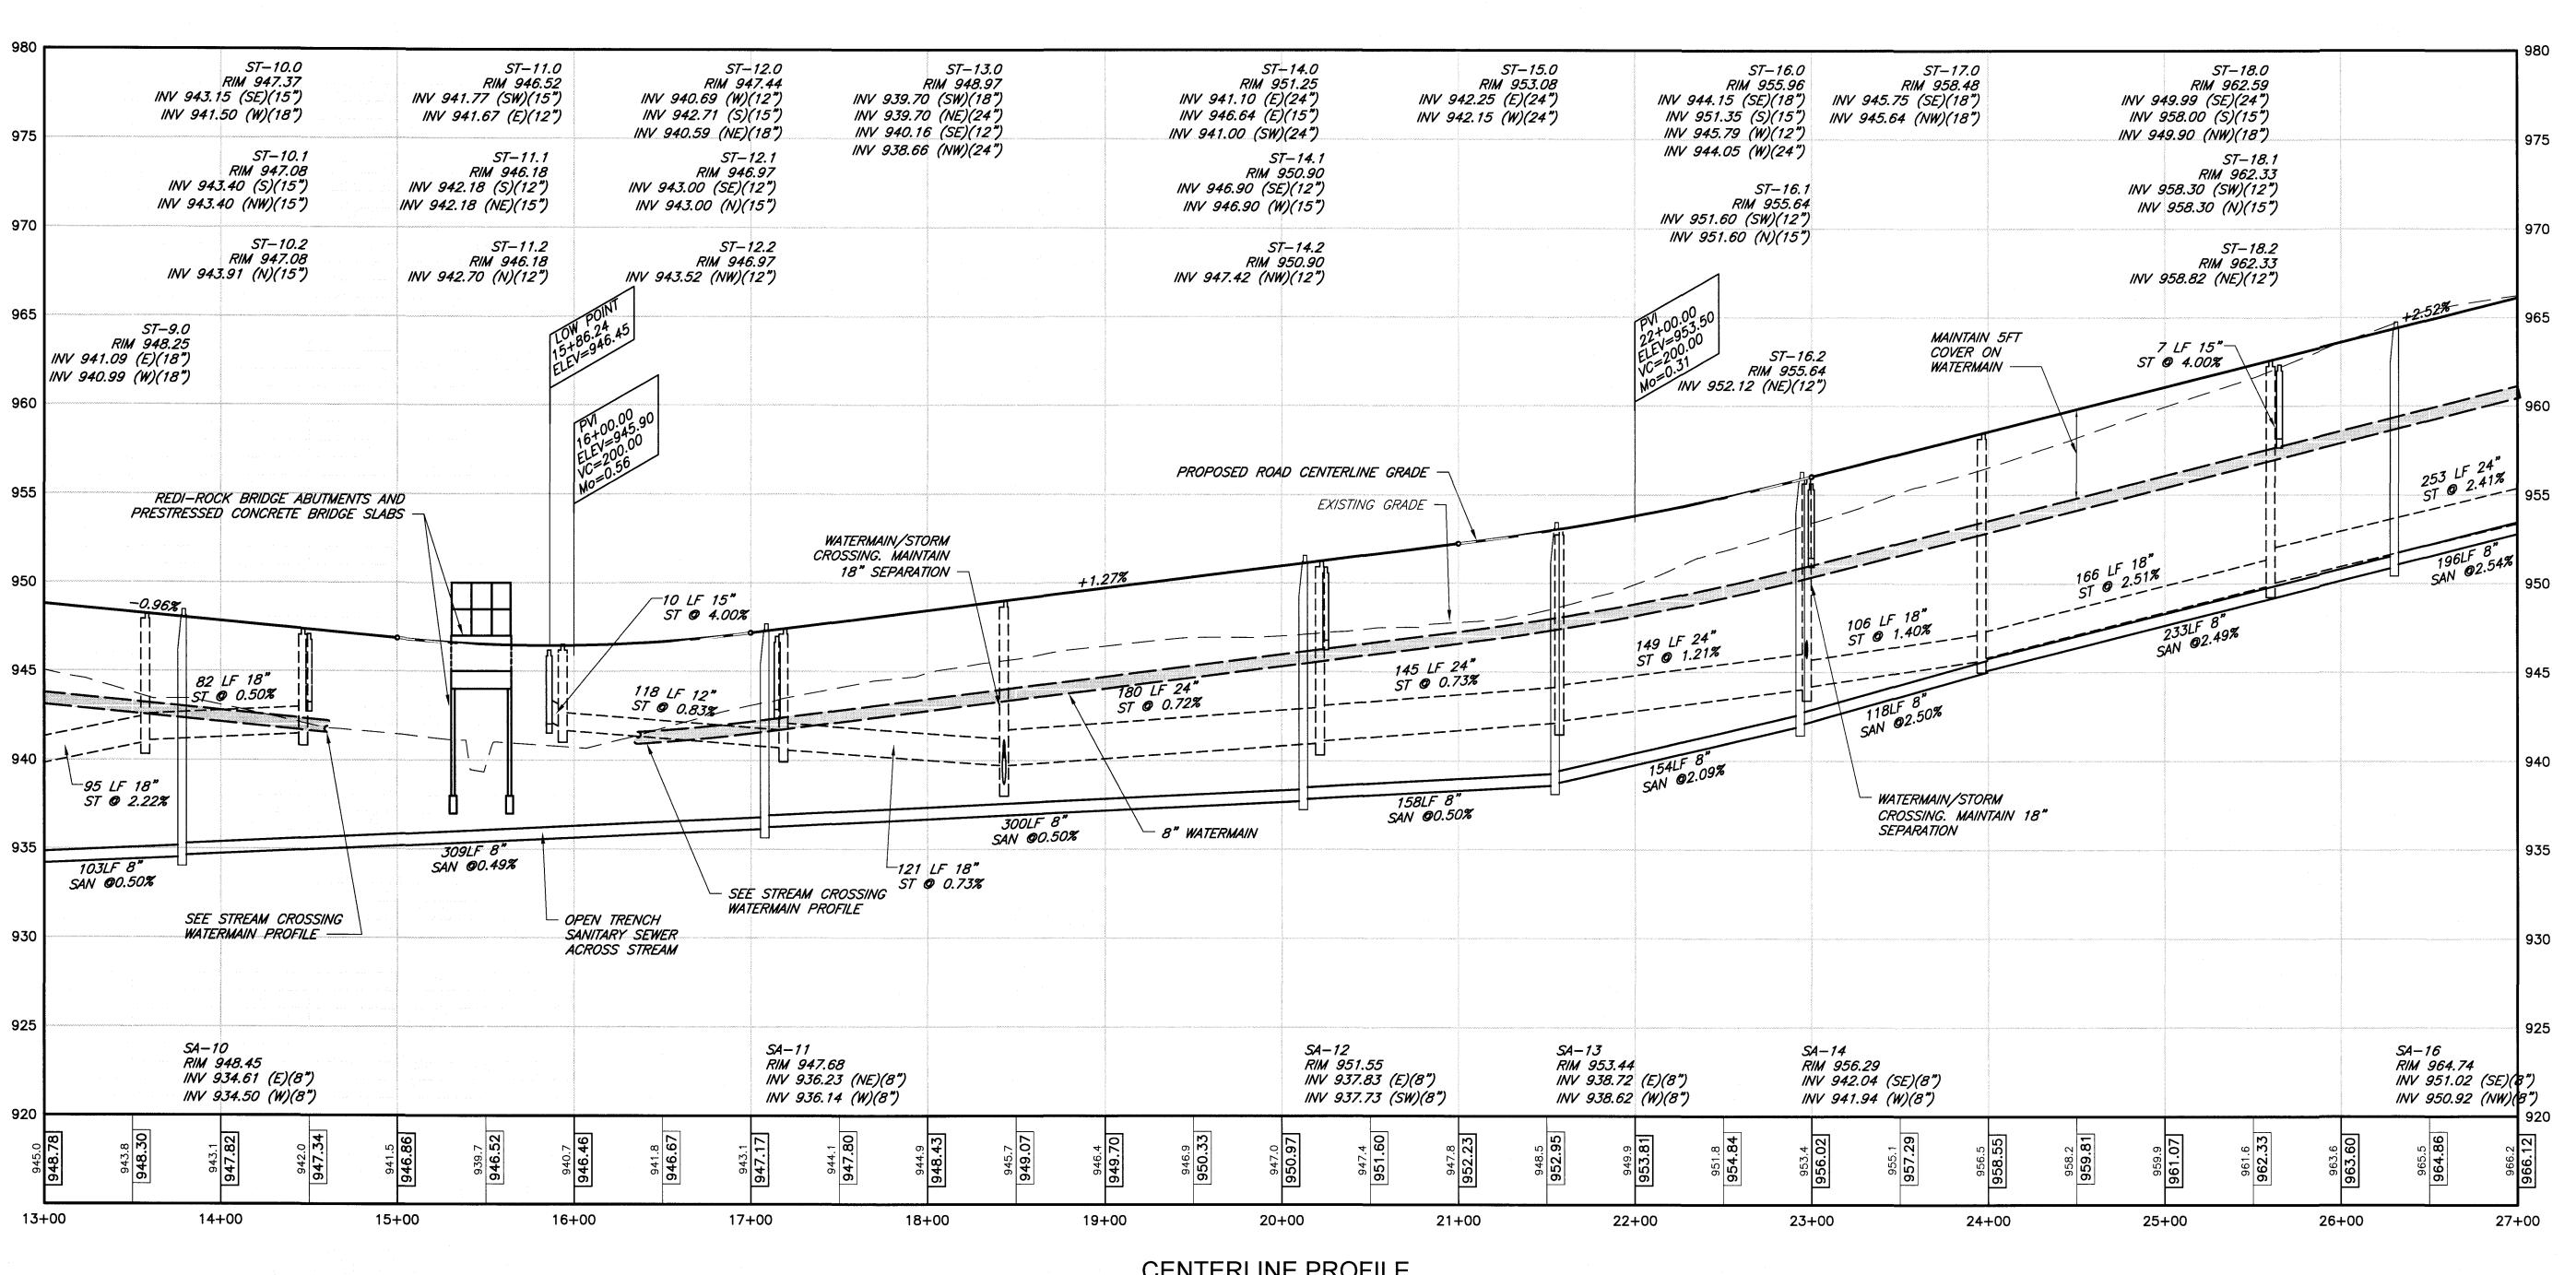
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DRAWING TITLE: CENTERLINE PROFILE (SHEET 1 OF 3)

14 of 21 SHEET No: 1022-19

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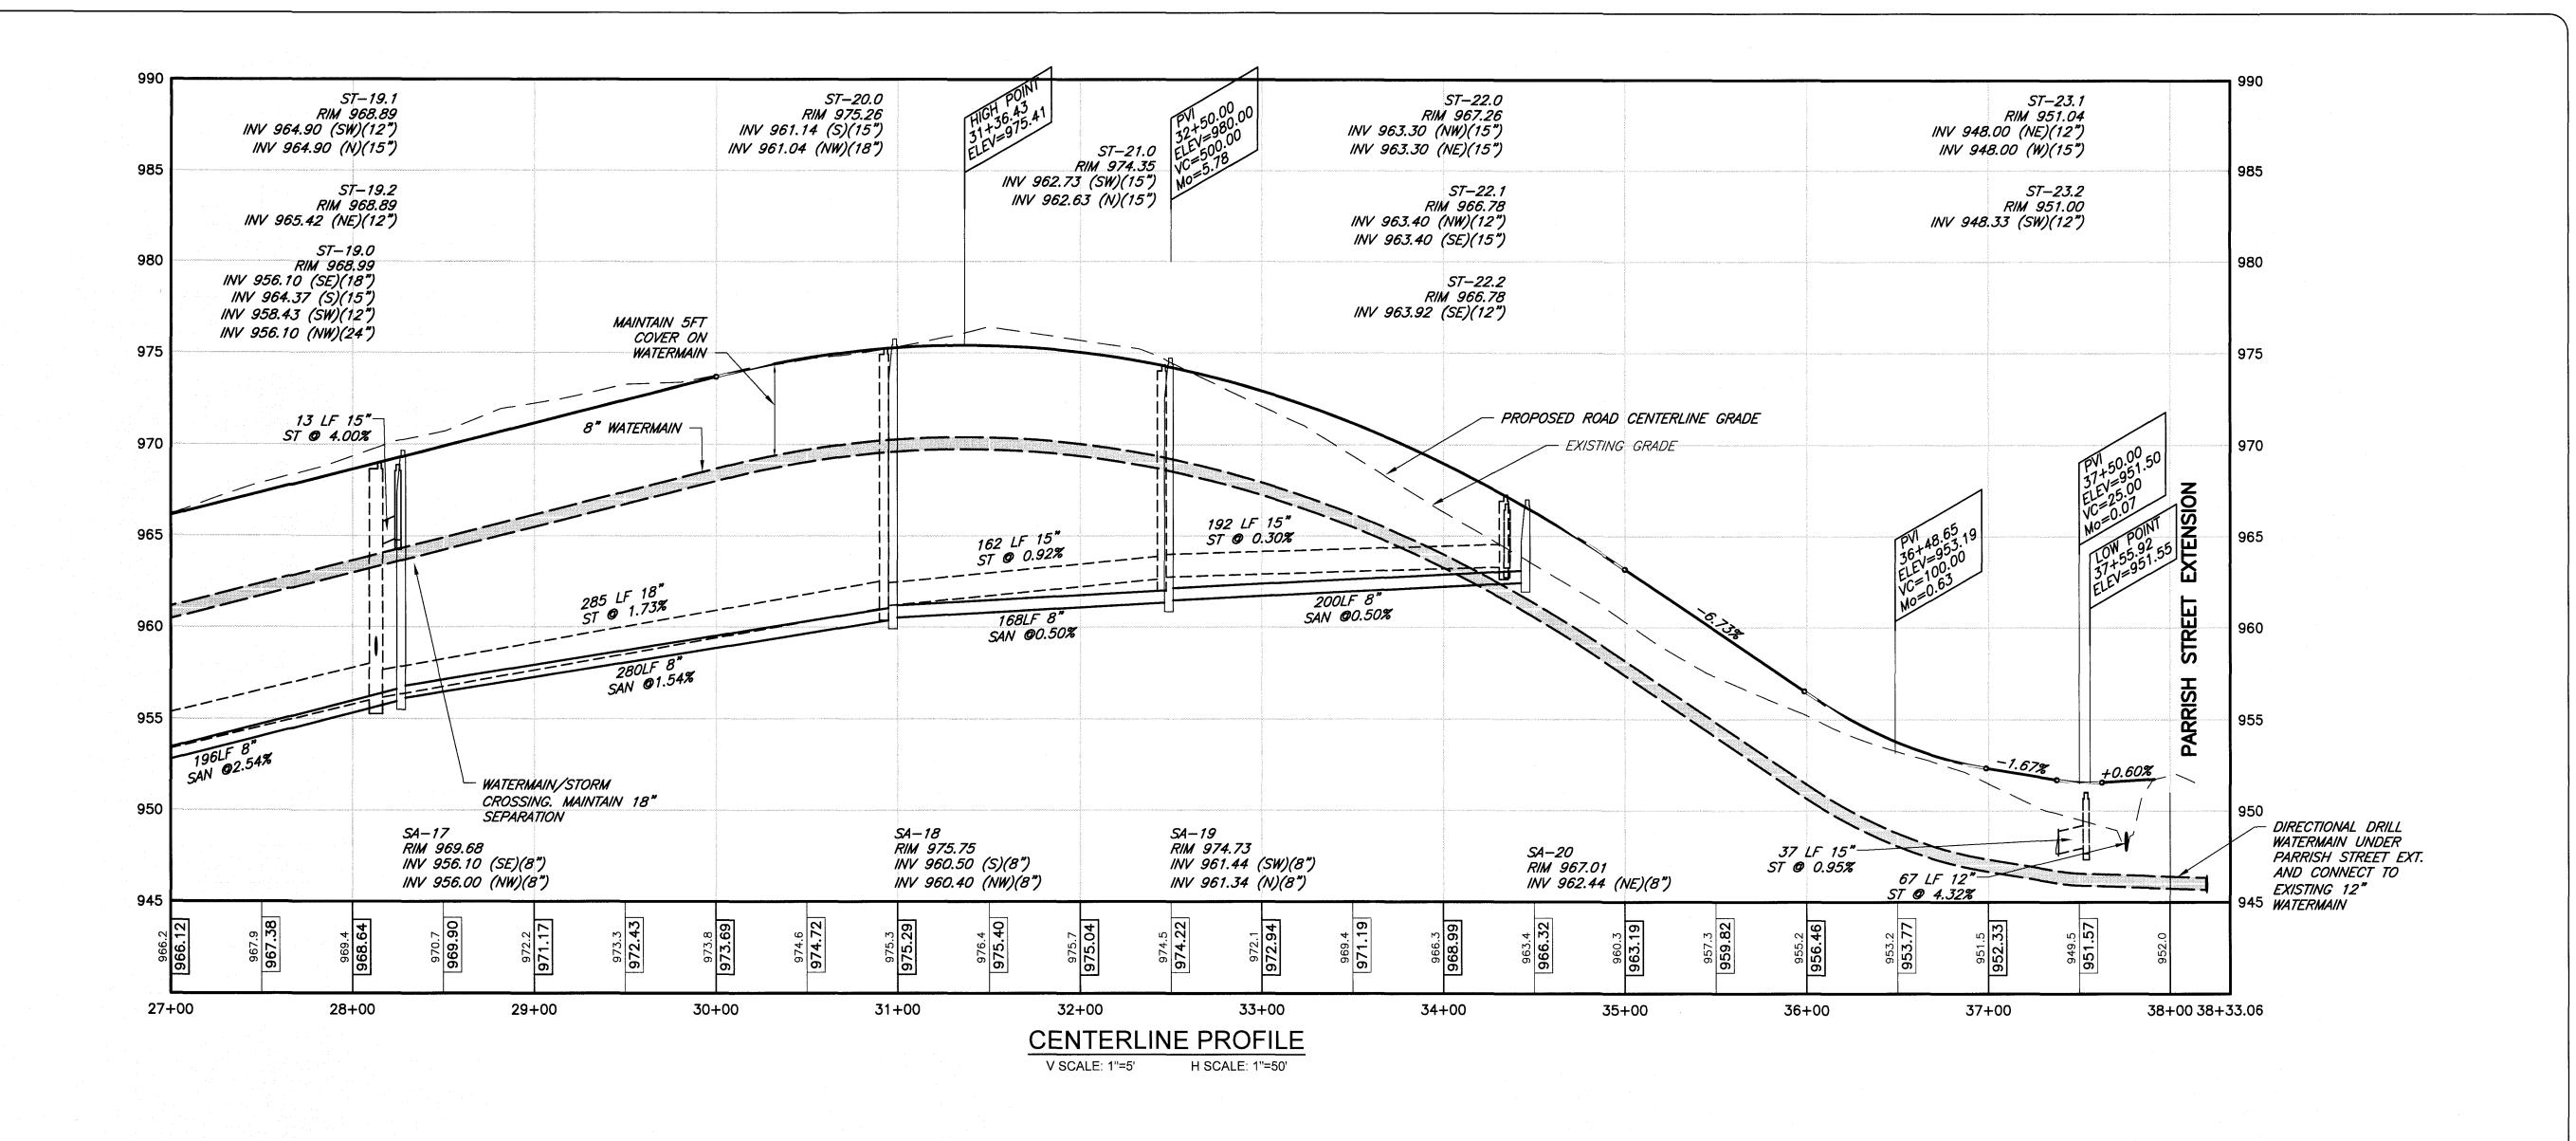
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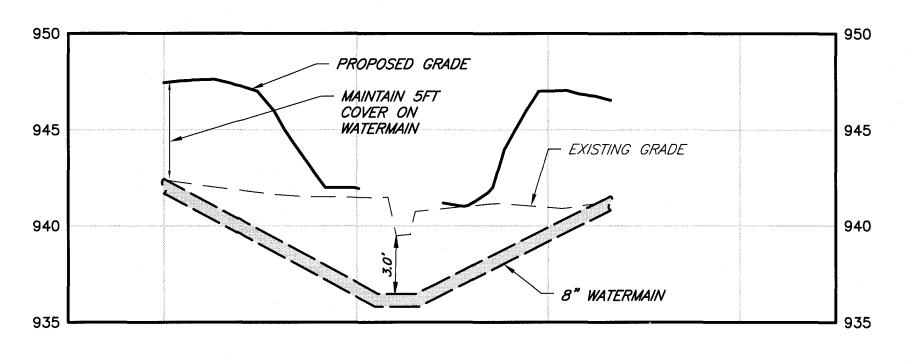
DRAWING TITLE: CENTERLINE PROFILE (SHEET 2 OF 3)

15 of 21 C6.1 SHEET No: 1022-19

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**CENTERLINE PROFILE** H SCALE: 1"=50' V SCALE: 1"=5"





WATERMAIN STREAM CROSSING V SCALE: 1"=5' H SCALE: 1"=50'

**ENGINEERING** ROCHESTER LOCATION

3 9 CASCADE DRIVE ROCHESTER, NY 14614 5 8 5 - 4 5 8 - 7 7 7 0 <u>ITHACA LOCATION</u> 840 HANSHAW RD, STE 6 1THACA, NY 14850 607-241-2917

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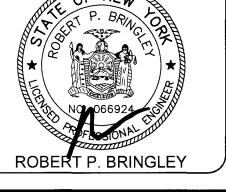
DATE: REVISIONS

DATE BY REVISION 08/20/21 CP TOWN COMMENTS

5/21/21

IT IS A VIOLATION OF NEW YORK STATE EDUCATION LAW ARTICLE 145, SECTION 7209 FOR ANY PERSON, UNLESS ACTING UNDER THE DIRECTION OF A LICENSED PROFESSIONAL ENGINEER OR LAND SURVEYOR, TO ALTER IN ANY WAY, AN ITEM BEARING THE SEAL OF A PROFESSIONAL ENGINEER OR LAND SURVEYOR. IS AN ITEM BEARING THE SEAL OF A PROFESSIONAL ENGINEER OR LAND SURVEYOR IS ALTERED, THE ALTERING ENGINEER OR LAND SURVEYOR SHALL AFFIX TO THE ITEM THEIR SEAL AND THE NOTATION "ALTERED BY" FOLLOWED BY THEIR SIGNATURE AND THE DATE OF SUCH ALTERATION, AND A SPECIFIC DESCRIPTION OF THE ALTERATION.


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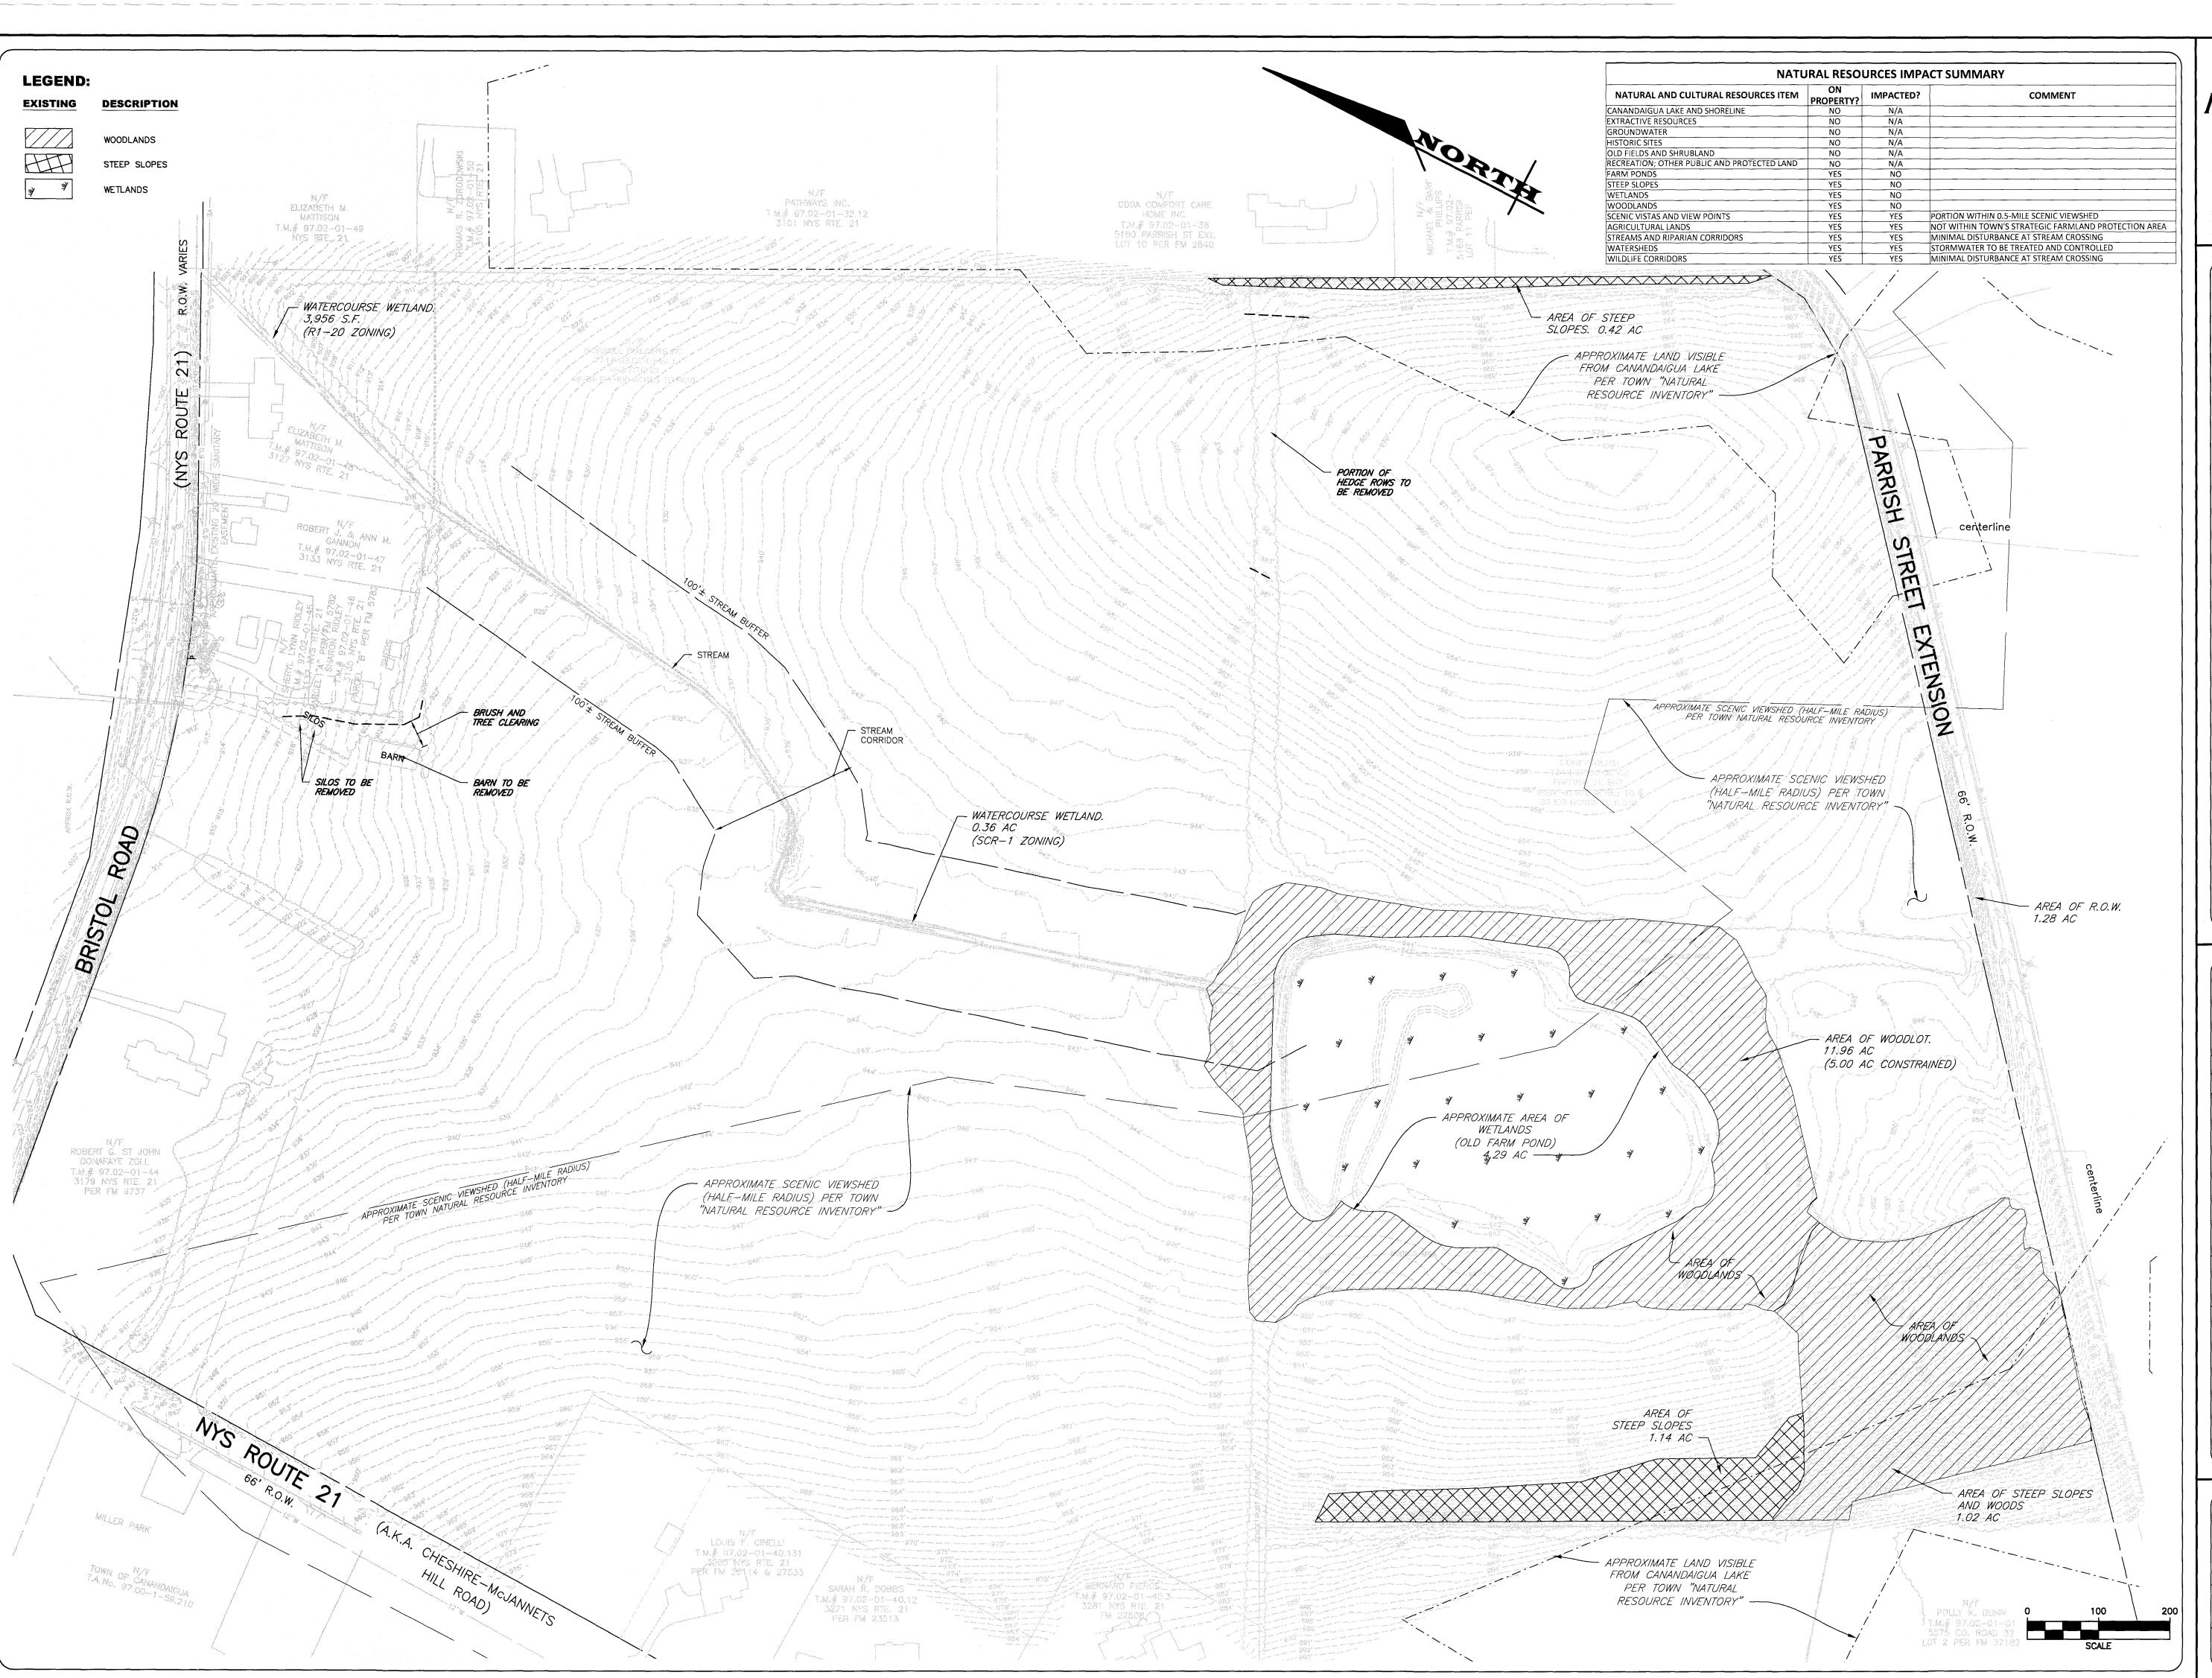


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> 16 of 21 SHEET No:

1022-19 JOB No: DRAWING No:





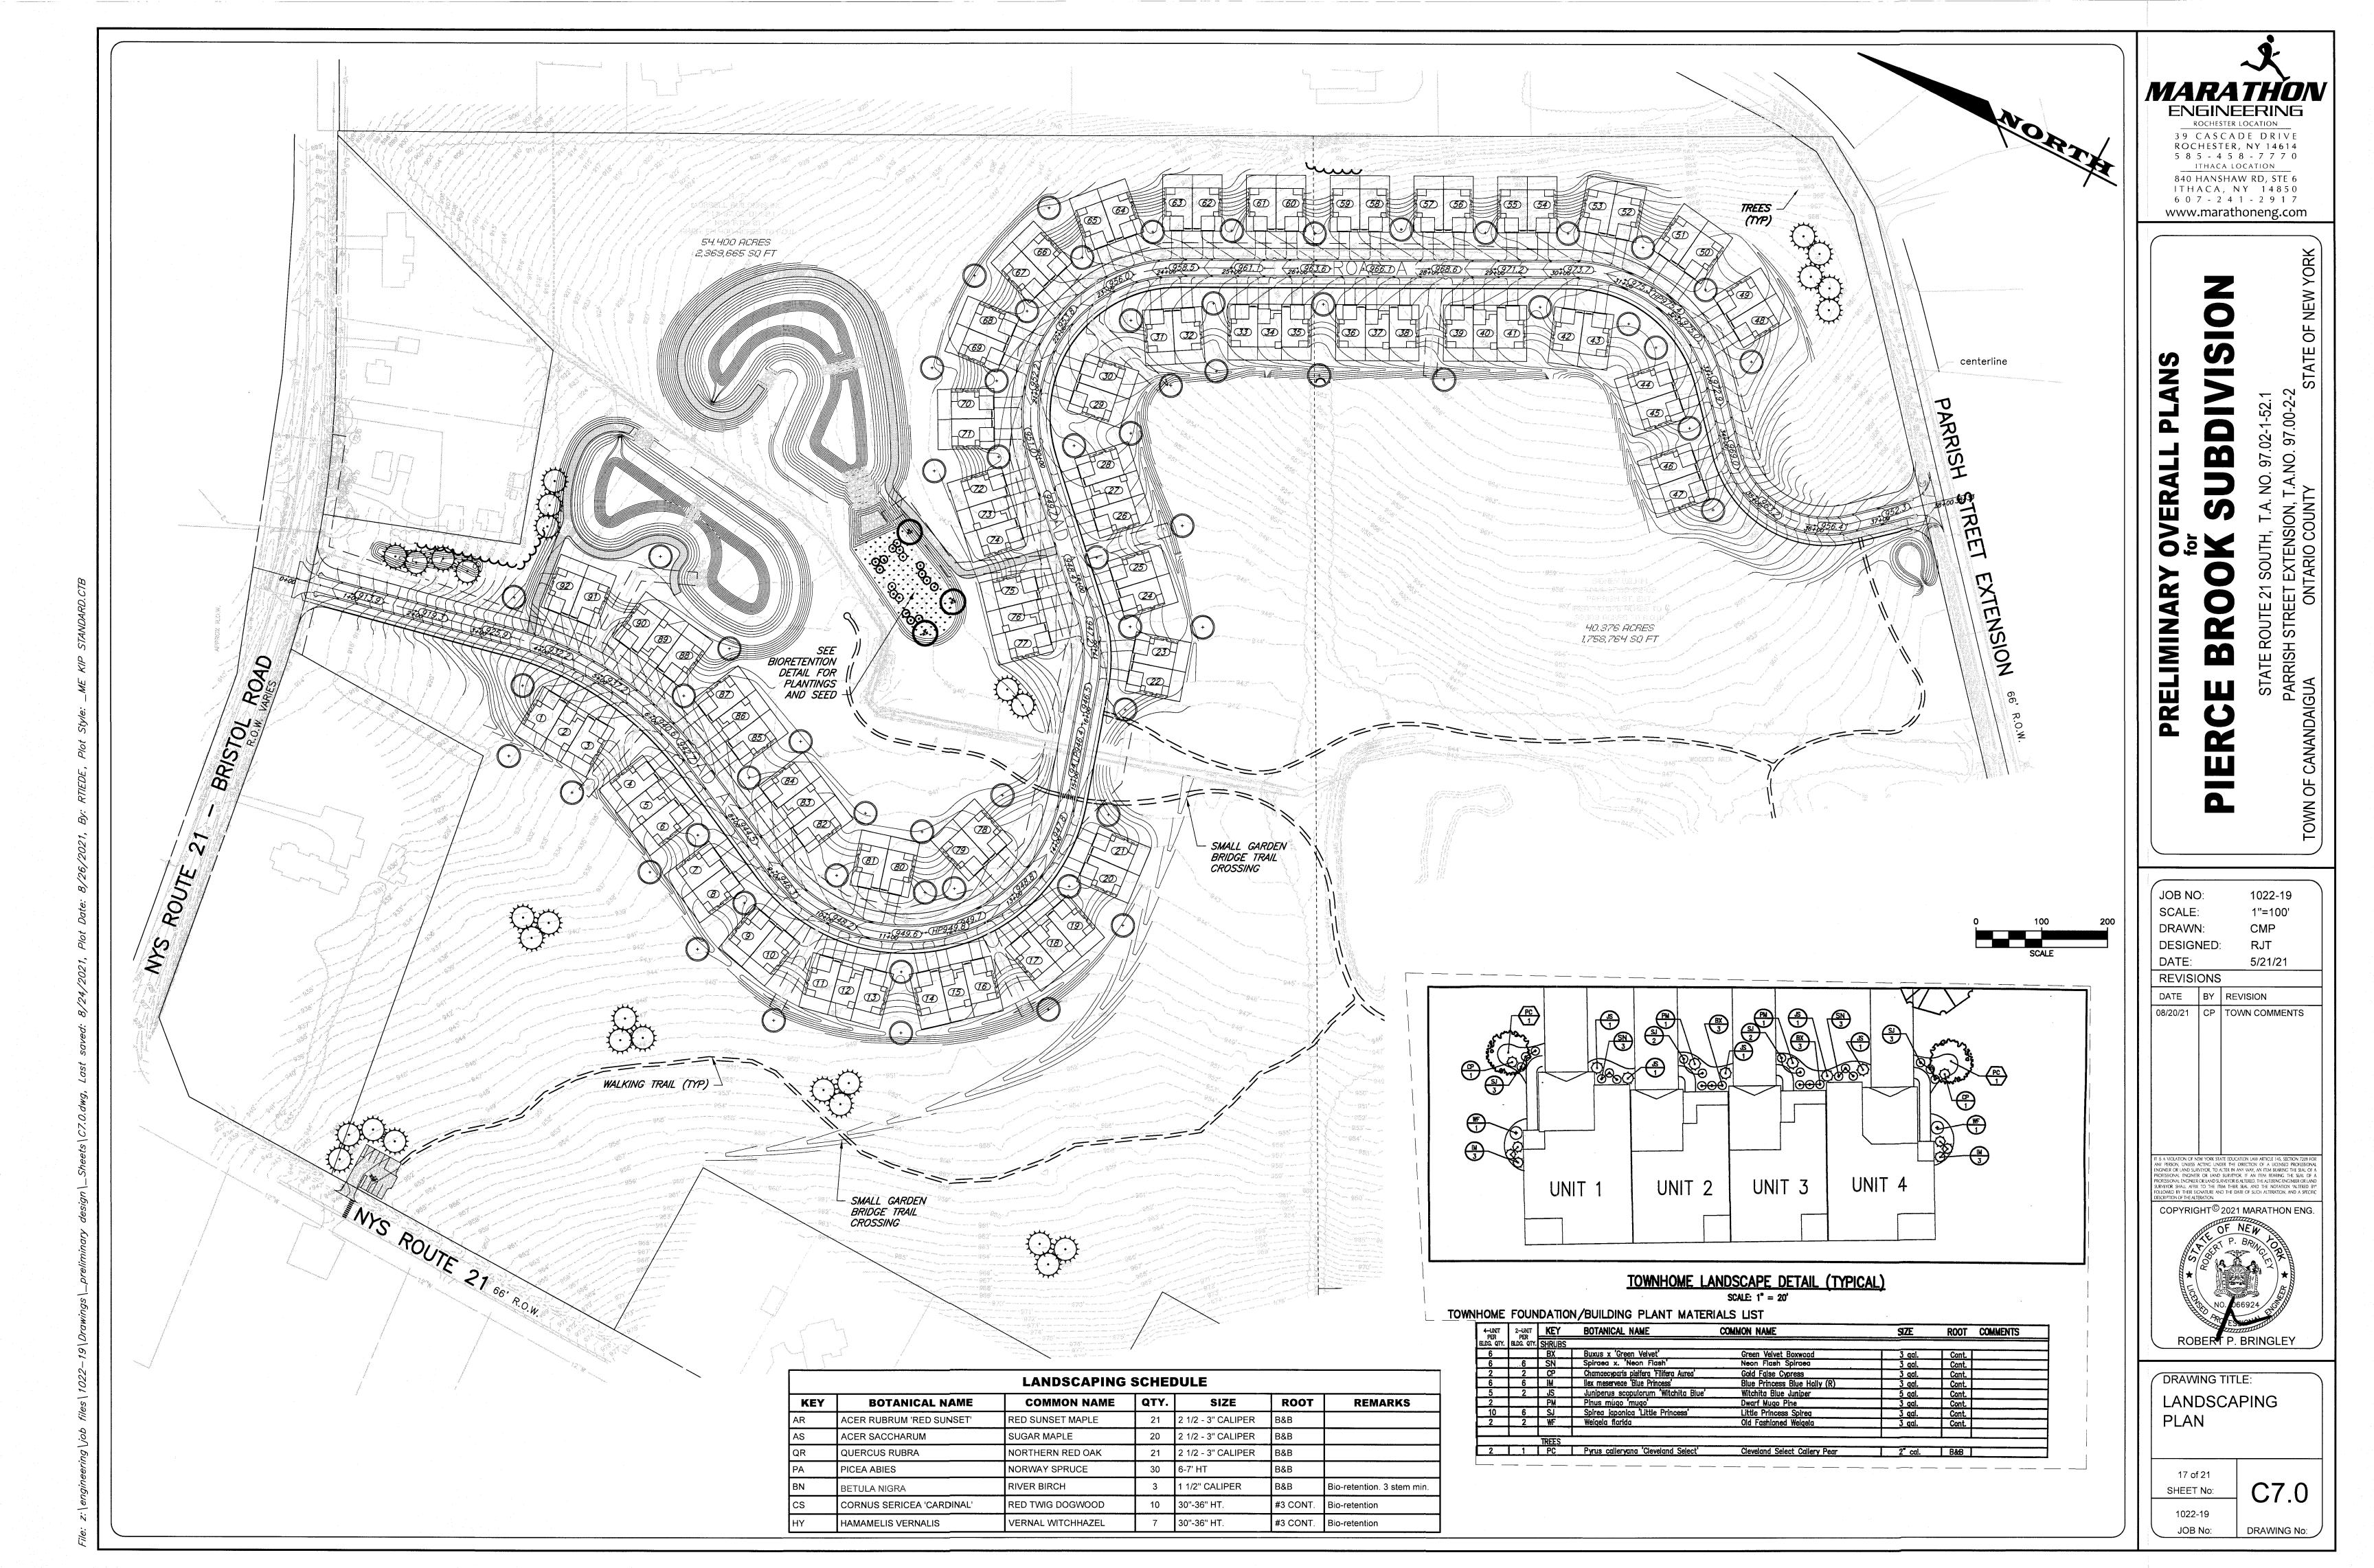

ROCHESTER LOCATION

3 9 CASCADE DRIVE
ROCHESTER, NY 14614
5 8 5 - 4 5 8 - 7 7 7 0
ITHACA LOCATION

840 HANSHAW RD, STE 6
LTHACA, NY 14850

1THACA, NY 14850 6 0 7 - 2 4 1 - 2 9 1 7 www.marathoneng.com

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STATE OF NEW YORK

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JOB NO: 1022-19

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DESIGNED: RJT

DATE: 5/21/21

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DATE BY REVISION

08/20/21 CP TOWN COMMENTS

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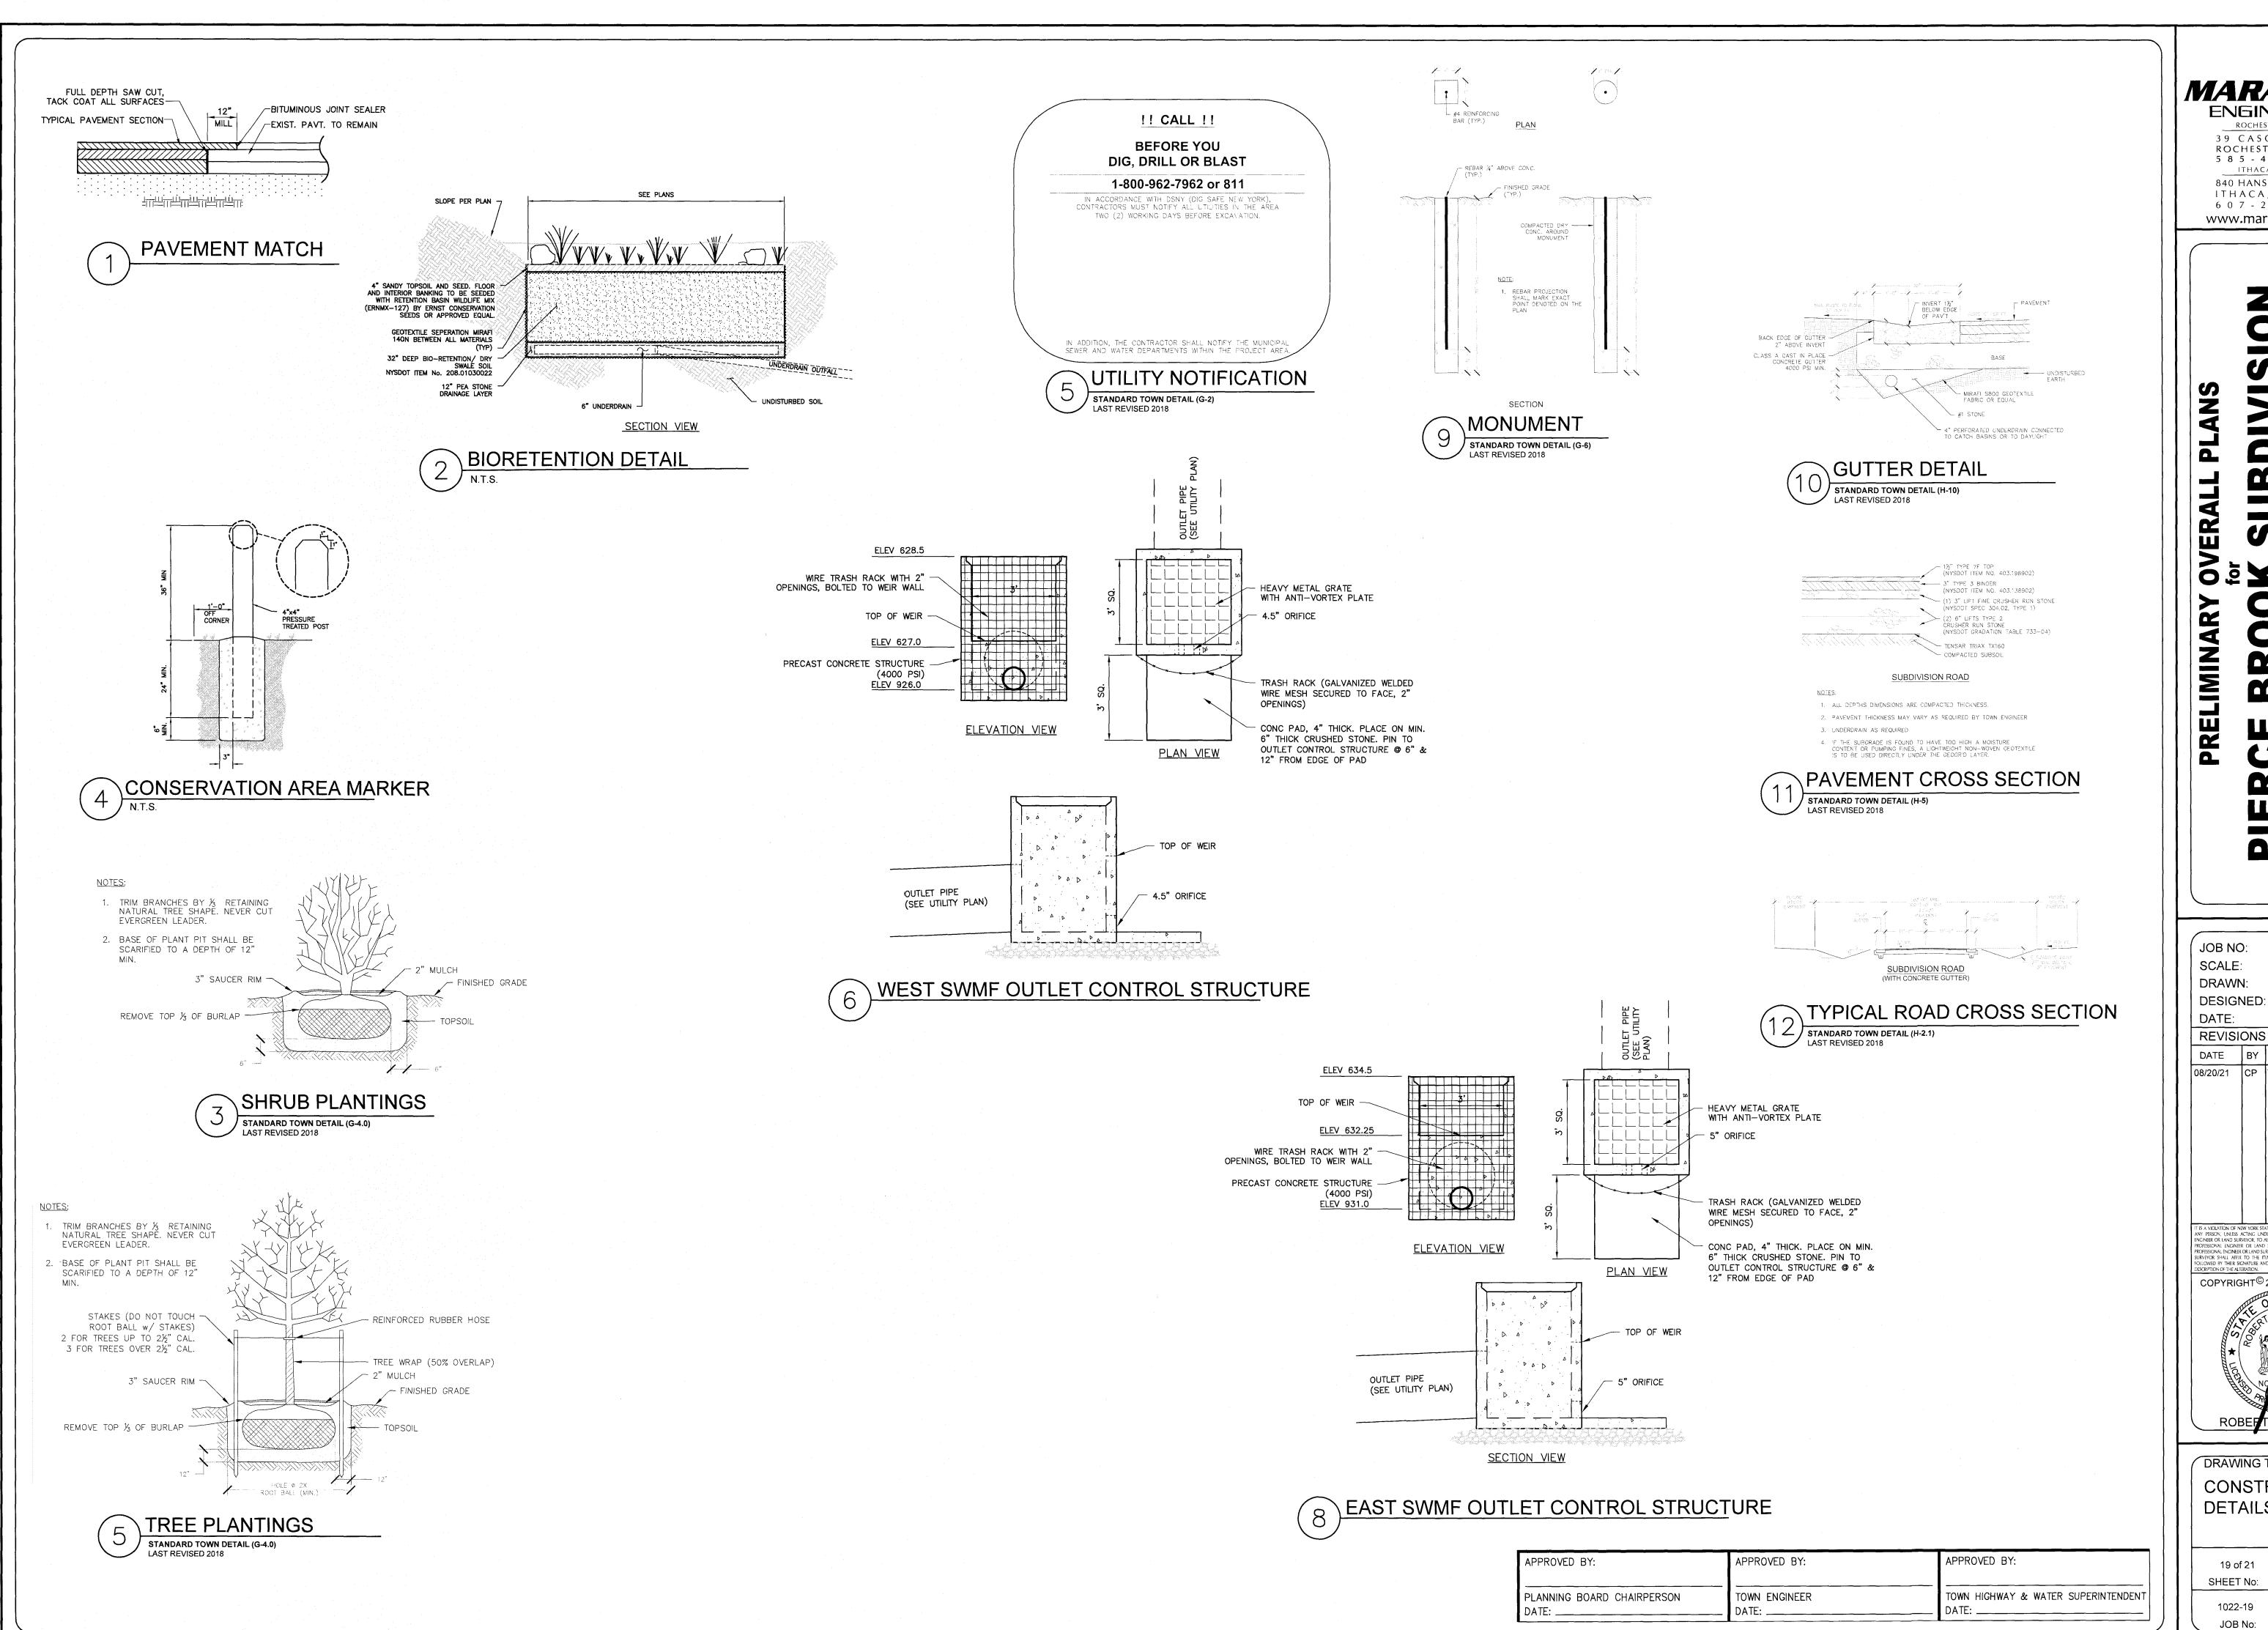
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18 of 21 SHEET No: 1022-19

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**ENGINEERING** 

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1022-19 AS SHOWN RJT 5/21/21

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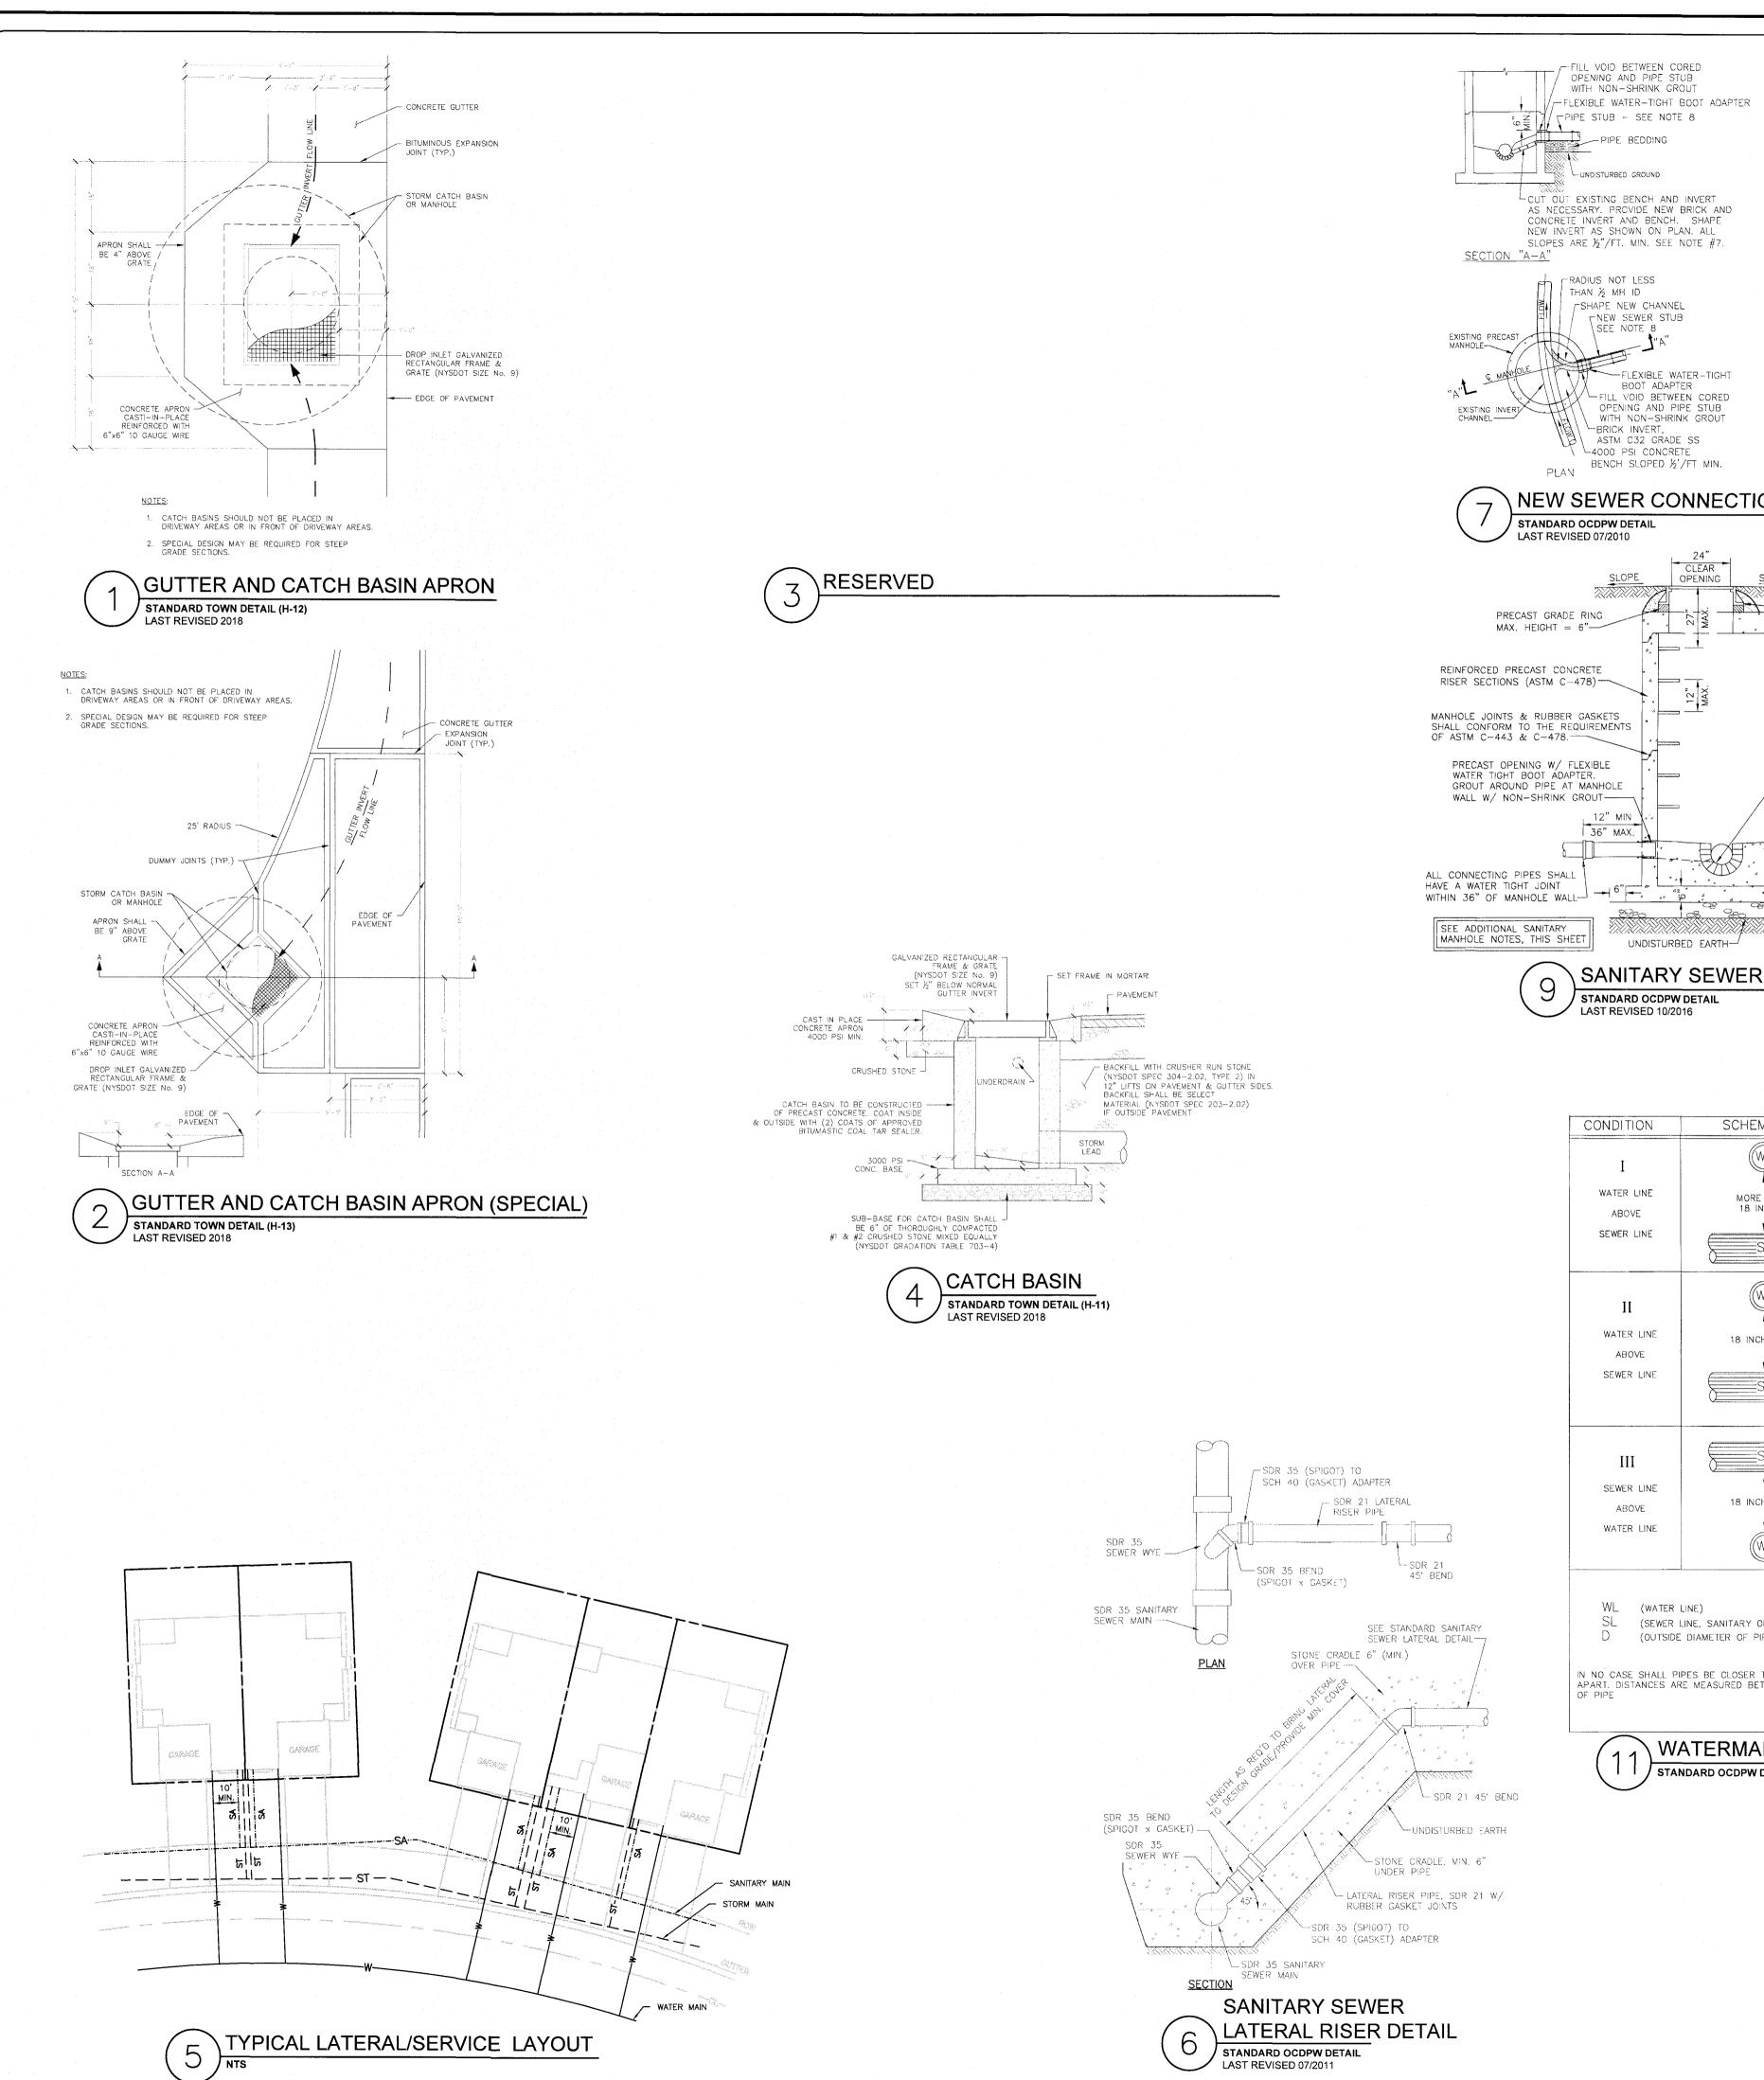
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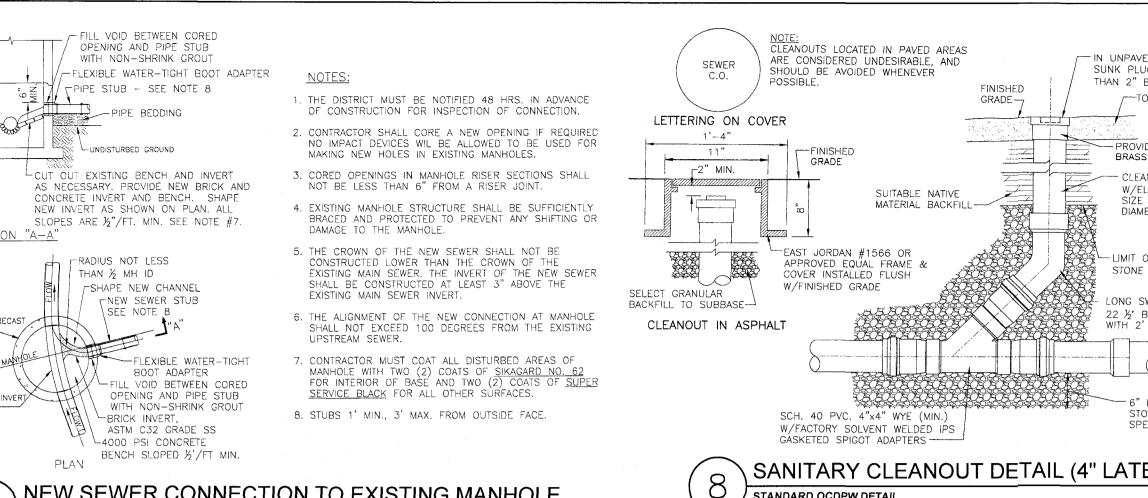
ROBERT P. BRINGLEY

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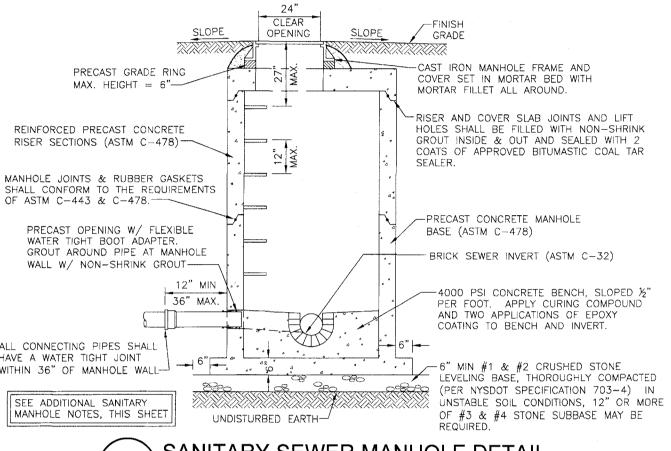
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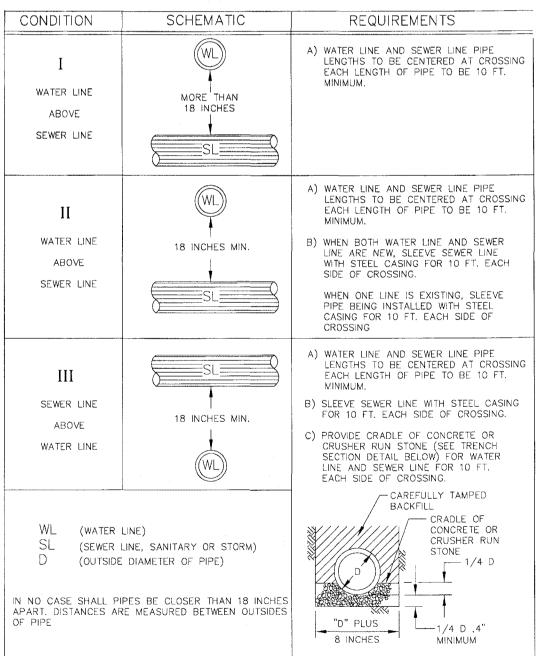





NEW SEWER CONNECTION TO EXISTING MANHOLE




SANITARY SEWER MANHOLE DETAIL




WATERMAIN/ SEWER CROSSING DETAIL STANDARD OCDPW DETAIL

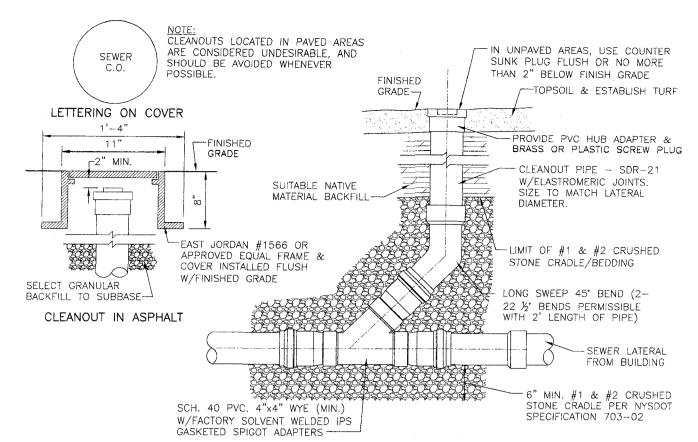

SANITARY CLEANOUT DETAIL (4" LATERAL) STANDARD OCDPW DETAIL LAST REVISED 09/2016

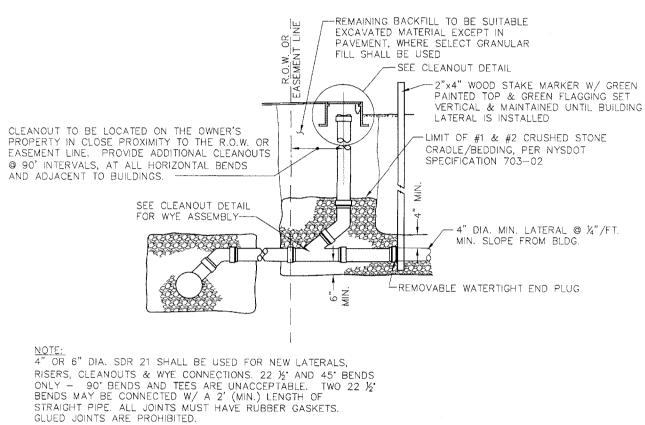

SANITARY SEWER LATERAL DETAIL DISTRICT OWNED SEWER MAIN STANDARD OCDPW DETAIL

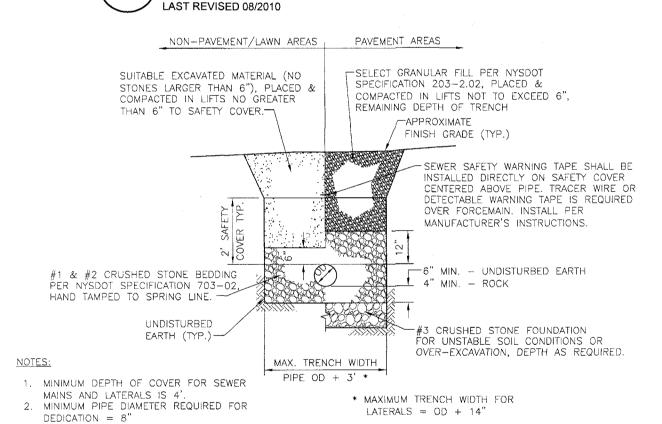


SANITARY SEWER MAIN AND LATERAL TRENCH AND BEDDING DETAIL ✓ STANDARD OCDPW DETAIL

MANHOLE NOTES:

LAST REVISED 08/2010

MANHOLES LESS THAN 5 FEET DEEP, GREATER THAN 14 FEET DEEP, OR HAVING THREE OR MORE PIPE CONNECTIONS SHALL HAVE A MINIMUM INSIDE DIAMETER OF 5 FEET.

- 2. REINFORCED PRECAST CONCRETE FLAT COVER SLABS WITH 24" DIA. ECCENTRIC MASONRY OPENING SHALL BE USED FOR ALL MANHOLES.
- 3. ALL BENCHES, INVERTS AND INTERIOR WALLS OF THE MANHOLE BASE TO 12" ABOVE THE HIGHEST PIPE SHALL HAVE TWO APPLICATIONS OF EPOXY COATING (SIKAGARD 62, DURALKOTE 500 OR OTHER APPROVED EQUAL). THE REMAINING INTERIOR WALLS AND ENTIRE EXTERIOR SURFACE SHALL BE COATED WITH TWO APPLICATIONS OF APPROVED BITUMASTIC COAL TAR SEALER (ASTM D-450, TYPE B).
- MANHOLE STEPS SHALL BE STEEL REINFORCED POLYPROPYLENE, CAST IN PLACE BY MANUFACTURER.
- 5. MANHOLE FRAME AND COVER SHALL BE EAST JORDAN CO. #1045 OR OTHER DISTRICT APPROVED EQUAL. COVER SHALL HAVE EPIC SLOT AND BE GASKETED WITH "SANITARY SEWER" CAST IN LID WITH 2" LETTERING (MAX. SIZE).
- 6. FOR MANHOLES NOT LOCATED IN PAVEMENT, BACKFILL WITH SUITABLE NATIVE MATERIAL PER NYSDOT SPECIFICATION 203-2.01. FOR MANHOLES IN PAVEMENT, BACKFILL WITH CRUSHER RUN STONE, TYPE 2 PER NYSDOT SPECIFICATION

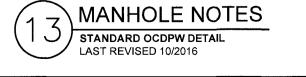

APPROVED BY: APPROVED BY: APPROVED BY: PLANNING BOARD CHAIRPERSON TOWN ENGINEER TOWN HIGHWAY & WATER SUPERINTENDENT

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**ENGINEERING** 

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ROCHESTER, NY 14614

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ITHACA LOCATION

840 HANSHAW RD, STE 6

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6 0 7 - 2 4 1 - 2 9 1 7 www.marathoneng.com

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20 of 21 SHEET No: 1022-19 JOB No: DRAWING No:

### B. WATERMAINS

#### 1. POLYVINYL CHLORIDE (PVC)

SHALL CONFORM TO AWWA C-900, MINIMUM CLASS 200 (DR14) WITH ELASTOMERIC GASKET JOINTS. INTEGRAL BELL AND RUBBER RINGS LOCKED IN PLACE, MINIMUM DEPTH 5'-0" WITH A MINIMUM OF SIX (6) INCHES OF FULL SAND ENCASEMENT. PVC PIPE INSTALLATION SHALL INCLUDE EITHER:

- a) SIX (6) INCH WIDE METALLIC TAPE PLACED OVER THE CENTER OF THE PIPE ON TOP OF THE 24-INCH SAFETY COVER AS MANUFACTURED BY LINE GUARD III, INC;
- b) CONTINUOUS #10 GAUGE COPPER WIRE ATTACHED TO THE PIPE AT 5-FOOT INTERVALS WITH PLASTIC TIES WITH A MINIMUM OF 150 LBS TENSILE STRENGTH. WIRE SHALL BE ATTACHED TO ALL CAST FITTINGS, HYDRANTS AND VALVE BOXES TO MAKE A CONTINUOUS TRACEABLE SYSTEM.

## 2. HIGH-DENSITY POLYETHYLENE (HDPE) PIPE

UPON REVIEW AND DISCUSSION WITH THE TOWN, MAY BE CONSIDERED FOR POSSIBLE USE IN SPECIAL CIRCUMSTANCES, I.E. ROAD & STREAM CROSSINGS. SHALL BE SDR-11 DESIGN SHALL BE FORWARDED TO THE TOWN WATER SUPERINTENDENT FOR REVIEW AND APPROVAL.

DUCTILE IRON SHALL MEET AWWA C-153-11 SPECIFICATIONS, MINIMUM CLASS 350, WITH MECHANICAL OR PUSH-ON JOINT, EXCEPT FOR HYDRANT BRANCHES WHICH SHALL BE MECHANICAL JOINTS. FITTINGS SHALL BE CEMENT LINED IN ACCORDANCE WITH AWWA C-104-13. BOLTS AND NUTS SHALL BE FLUOROPOLYMER COATED "BLUE BOLTS". (ASS TYLER UNION FITTING) ALL JOINTS SHALL CONFORM TO THE REQUIREMENTS OF AWWA C-111.

PVC SHALL MEET SPECIFICATIONS OF AWWA C-905 MADE FROM PVC COMPOUND 12454-B (ASTM D1784) N. PRESSURE REDUCING VALVES (PRV) AND VAULTS WITH GASKET JOINTS MEETING ASTM D3139.

#### D. HYDRANTS

## SHALL BE MANUFACTURED IN ACCORDANCE WITH AWWA C-502.

1000-1499

500-999

HYDRANTS SHALL BE MUELLER MANUFACTURED FOR 5 FOOT BURY WITH BREAKAWAY FLANGE CONSTRUCTION AND 6-INCH MECHANICAL JOINT INLET. SHOE AND INLET SHALL BE EPOXY COATED.

THEY SHALL OPEN LEFT, WITH A ONE AND ONE-HALF INCH (1-1/2") PENTAGON-OPERATING NUT.

ALL HYDRANTS SHALL BE PAINTED RED WITH BONNETS PAINTED AS PER THE AWWA HYDRANT COLOR

#### CODE AS LISTED BELOW:

**BONNET COLOR** FLOW RANGE (GPM)

> 1500

**ORANGE** 

ALL VALVE BOX COVERS SHALL BE PAINTED BLUE.

HYDRANTS SHALL BE THREE-WAY WITH TWO (2) 2-1/2 INCH HOSE NOZZLES AND ONE (1) 4-1/2 INCH PUMPER CONNECTION (QUICK DISCONNECT), ALL WITH NATIONAL STANDARD THREADS. MAIN VALVE OPENINGS SHALL BE 5-1/4 INCH WITH THE TOTAL UNIT CONSISTING OF THE TEE, GUARD VALVE, HYDRANT AND ADAPTORS. (SEE APPENDIX W).

- 1. THE MAIN VALVE SEAT RING SHALL BE BRONZE AND SCREW INTO THE BRONZE DRAIN RING.
- 2. STAINLESS STEEL FASTENERS SHALL BE USED FOR ALL CONNECTIONS ON HYDRANTS AND VALVES AND FLUOROPOLYMER COATED "BLUE BOLTS" FOR FITTINGS.

# E. FLUSHING HYDRANT - BLOWOFF

SHALL BE 2 INCH SELF-DRAINING, NON-FREEZING WITH 5 FOOT BURY, WITH ALL BRONZE PARTS DESIGNED TO CONNECT TO A 2 INCH MAIN LINE OUTLET AS MANUFACTURED BY GIL INDUSTRIES, INC., MODEL SLIM

# F. GATE VALVE AND BOX

# 1. ALL VALVES 12" OR LESS SHALL BE GATE VALVES.

2. GATE VALVES SHALL CONFORM TO AWWA C-509 OR LATEST REVISION, RESILIENT-SEATED WEDGE TYPE EPOXY COATED GATE VALVES WITH A NON-RISING STEM; "O" RING PACKING, AND OPEN LEFT. THEY SHALL BE OF THE 350 PSI TEST CLASS WITH A MINIMUM WORKING PRESSURE OF 250 PSI. VALVES SHALL BE MANUFACTURED BY, MUELLER CO., MODEL 2360, WITH MJ ENDS, A 2" SQUARE OPERATING NUT. STAINLESS STEEL BOLTS AND NUTS SHALL BE UTILIZED.

3. THE VALVE ENDS SHALL DEPEND ON THE TYPE OF PIPE USED AND THE PARTICULAR USE INTENDED.

4. VALVE BOXES SHALL BE BIBBY-STE-CROIX MODEL NUMBER VB3000 SERIES, OR APPROVED EQUAL, TWO-PIECE SCREW-TYPE, CAST-IRON CONSTRUCTION, VALVE BOX, WITH A 5-1/4 INCH INSIDE DIAMETER AND COVERS MARKED "WATER".

5. IF THE VALVES ARE BURIED DEEP THEY MUST HAVE AN EXTENSION STEM THAT CAN BE REACHED WITH A 6 FOOT VALVE BOX KEY.

# G. TAPPING SLEEVE AND VALVE

ALL VALVES SHALL HAVE MECHANICAL JOINT ENDS AND BE FURNISHED WITH SUFFICIENT QUANTITIES OF ACCESSORIES. VALVES SHALL OPEN LEFT AND BE MANUFACTURED BY MUELLER WITH EPOXY COATING.

# H. ANCHORING FITTINGS

ANCHORING PIPE IN ACCORDANCE WITH ANSI-A21.4, OR LATEST REVISION, SHALL BE EMPLOYED TO ANCHOR ALL HYDRANTS TO GATE VALVES. THE ANCHORING PIPE SHALL BE EPOXY COATED CEMENT LINED AND PROVIDED WITH A ROTATING GLAND. THERE SHOULD BE A MINIMUM 18 INCHES BETWEEN HYDRANT AND GATE VALVE. THESE ANCHORING PIPES SHALL BE TYLER 5-198 OR PROPOSED EQUAL.

ALL VALVES GREATER THAN 16" IN DIAMETER SHALL BE BUTTERFLY TYPE. ALL BUTTERFLY VALVES SHALL

#### CONFORM TO AWWA C-504, OR LATEST REVISION. . RESTRAINERS

SHALL BE MANUFACTURED OF HIGH STRENGTH DUCTILE IRON PIPE AND INCORPORATE A FULL 360 DEGREE SUPPORT AROUND THE PIPE. THEY SHALL BE AS MANUFACTURED BY MEGALUG OR UNI-FLANGE SERIES 1500, 1300, 1350, OR 1390 DEPENDING ON THE SPECIFIC USE.

#### K. WATER SERVICE MATERIAL

1. CORPORATIONS STOP SHALL BE MUELLER H-15008 COMPRESSION TYPE.

2. CURB STOPS SHALL BE MUELLER H-15209 MARK II COMPRESSION TYPE

3. CURB BOXES SHALL BE MUELLER H-10334, 5 FEET LONG WITH STAINLESS STEEL RODS AND STAINLESS STEEL KEYS. CURB BOXES SHALL NOT BE LOCATED WITHIN DRIVEWAYS.

#### 4. COPPER SERVICES SHALL BE TYPE "K" ASTM B88

5. PLASTIC SERVICES SHALL BE COPPER TUBE SIZE (CTS) AT 200 PSI, WITH A MINIMUM 1 INCH PIPE DIAMETER (ONLY USED FROM CURB BOX TO UNIT AND A CONTINUOUS? #10 GAUGE COPPER TRACER WIRE SHALL BE INCLUDED FROM THE CURB BOX TO THE STRUCTURE). SAND BEDDING SHALL BE PROVIDED AS APPROPRIATE.

POLYETHYLENE ASTM D-2737, PE 3408 PER AWWA C-901 (MINIMUM 5'-0" DEPTH AND SAND **ENCASEMENT REQUIRED)** 

- 6. ALL SERVICES TAPPED INTO MAINS SHALL UTILIZE DOUBLE STRAP SS SADDLE (MUELLER) WITH A MUELLER CORPORATION
- 7. ANY SERVICES LARGER THAN 1" SHALL MEET THE MINIMUM SPECIFICATIONS OF THE WATER SUPERINTENDENT.

### 8. REFER TO APPENDIX W.

#### L. METER PITS FOR INDIVIDUAL SERVICES

1. INDIVIDUAL METER PITS, WHERE REQUIRED, SHALL BE MUELLER, DOUBLE LID STYLE WITH WABASH COVER W2. COVER SHALL BE EQUIPPED TO RECEIVE ATTACHMENTS FOR RADIO-READ WATER METERS.

#### 2. REFER TO APPENDIX W.

#### M.THRUST BLOCKS

SHALL BE CAST IN PLACE 3000-PSI CONCRETE TO DIMENSIONS AS SHOWN IN APPENDIX W.

1. PRV VAULTS WHERE REQUIRED BY THE TOWN OF CANANDAIGUA, SHALL BE A MINIMUM OF 6'X16'X8' HIGH, LAKELAND PRECAST CONCRETE VAULT PROVIDED WITH 48"X48" ALUMINUM HATCH WITH ALUMINUM LADDER, SUMP RECESS, OPENINGS AS REQUIRED, SEALS, BOOTS, STAINLESS STEEL TRIM, DUAL PILOTS AND DUAL STRAINERS. SENTENCE HERE ABOUT COATING OR WATERPROOFING THE CONCRETE VAULT? THE STEEL VENT PIPE IS TO BE PAINTED BLUE.

2. THE PRV VAULT SHALL ALSO BE EQUIPPED WITH A ROSS 40WR-BP PRESSURE REDUCING VALVE AND MAY REQUIRE A BACK PRESSURE SUSTAINING FEATURE AND REVERSE FLOW FEATURE DEPENDING ON THE LOCATION IN THE WATER SYSTEM.

## 3. REFER TO APPENDIX W

#### O.EQUIVALENTS

1. ANY MATERIAL AND MANUFACTURER SUBSTITUTES ARE TO BE PROVIDED IN ADVANCE TO THE TOWN WATER SUPERINTENDENT FOR REVIEW AND APPROVAL.

2. FOR ANY PROJECT IT WILL BE ASSUMED THAT THE DEVELOPER WILL FURNISH THE EXACT MATERIALS SPECIFIED ON THE PLANS AND SPECIFICATIONS UNLESS THE DEVELOPER FILES WITH THE TOWN OF CANANDAIGUA WATER SUPERINTENDENT PRIOR TO ANY USE IN THE DEVELOPMENT, THE NAMES AND COMPLETE DESCRIPTION OF EACH ARTICLE WHICH HE PROPOSES TO SUBSTITUTE FOR APPROVAL BY

3. ANY COSTS INCURRED BY THE TOWN OR ITS REPRESENTATIVES ASSOCIATED WITH THE VERIFICATION OF SUBSTITUTE EQUIPMENT AND MATERIALS WILL BE THE RESPONSIBILITY OF THE DEVELOPER.

NOTES:

FINISHED GRADE -

3. ALL RESIDENTIAL SERVICE SHALL BE 1" MIN. DIAMETER.

4. CURB BOXES SHALL NOT BE LOCATED IN DRIVEWAY AREAS.


COPPER SERVICES SHALL BE ENCASED ALL AROUND WITH SELECT EARTH, SERVICES SHALL BE TYPE K COPPER OR 200 P.S.I. CTS PLASTIC FROM THE MAIN TO THE CURB STOP.

2. PLASTIC SERVICES (CTS 200) ALLOWED FROM THE CURB STOP TO THE STRUCTURE. TRACER WIRE SHOULD BE PROVIDED AS SHOWN.

CORPORATION (MUELLER)

- WATERMAIN

- DOUBLE STRAP

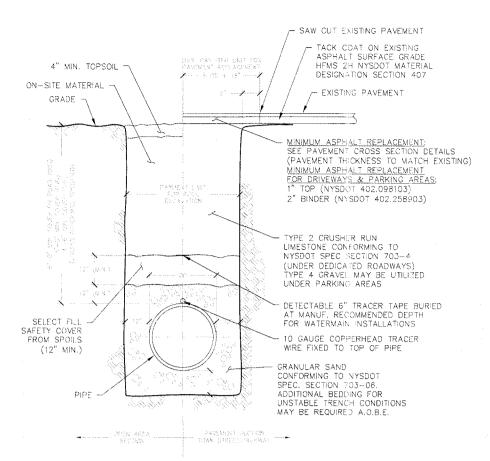

DETENTION AREA OUTFALL STRUCTURE STANDARD TOWN DETAIL (W-8) LAST REVISED 2018

(TOP PAINTED BLUE)

w/ SS ROD

CURB STOP (MUELLER)

2"x4"x16" CONC. BLOCK


COMPACTED SUBGRADE

TYPICAL WATER SERVICE

STANDARD TOWN DETAIL (W-3)

LAST REVISED 2018

7- 10 GAUGE COPPERHEAD TRACING WIRE (FOR ALL PLASTIC SERVICES)

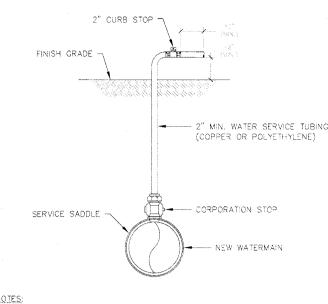

. UPON NOTIFICATION FROM THE HEALTH DEPARTMENT THAT A SATISFACTORY WATER SAMPLE HAS BEEN OBTAINED, SHUT DOWN CORPORATION STOP AND

- 2. IMMEDIATELY PRIOR TO PLACING THE WATER MAIN IN SERVICE THE CONTRACTOR SHALL REMOVE ALL CORPORATIONS ASSOCIATED WITH TEMPORARY FACILITIES ( I.E. SAMPLING TAPS, ETC.) AND REPLACE WITH THREADED BRASS PLUGS.
- 3. FOR DISINFECTION\SAMPLING TAPS THAT ARE NOT NEEDED TO BLOW-OFF, 1" DISINFECTION\SAMPLING TAPS ARE ACCEPTABLE.
- 4. 1000 LF MAXIMUM DISTANCE BETWEEN SAMPLE TAPS UNLESS OTHERWISE SPECIFIED BY ENGINEER.

TEMPORARY DISINFECTION / SAMPLING / BLOW-OFF

STANDARD TOWN DETAIL (W-7) LAST REVISED 2018

AWWA HYDRAN

COLOR CODE

ORANGE 500-999

FIRE HYDRANT MARKER

STAINLESS STEEL FASTENERS

UNDISTURBED SOIL -

8"x8"x16" CONC. BLOCK

(MIN. 18" LAY LENGTH BETWEEN

HYDRANT AND GATE VALVE)

2. HYDRANTS SHALL BE PAINTED RED.

6" ANCHOR FITTING

10 CU. FT. No. 2 — CRUSHED GRAVEL STONE FOR WEEP DRAINAGE (ONLY IF ABOVE

W/ SPRING AND FLAT BRACKET (5' STEEL RED-WHITE REFLICETIVE

MARKER (TYPE A) W/ PLATED SPRING)

(PAINTED PER AWWA

(PAINT BLUE)

SCREW TYPE

VALVE BOX (MUELLER)

EARTH -BACKFILL/

\_\_\_\_\_\_

BOLT VALVE TO TE


6" GATE VALVE (MUELLER)

1. IF GROUND WATER IS ENCOUNTERED, THE WEEP HOLES WUST BE PLUGGED AND THE HYDRANT MARKED.

LAST REVISED 2018


HYDRANT UNIT


STANDARD TOWN DETAIL (W-6)

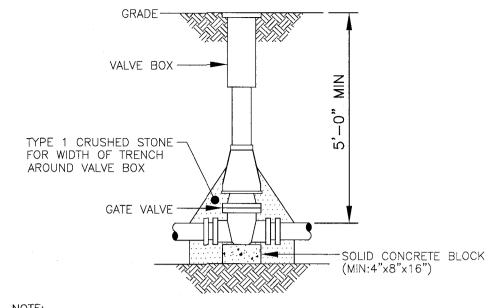


1. VALVE BOX SHALL BE CENTERED ON VALVE AND SET ON COMPACTED BACKFILL.


- 2. VALVE SHALL NOT SUPPORT VALVE BOX. 3. ALL BODY AND BONNET BOLTS SHALL BE STAINLESS STEEL.
- 4. ALL VALVES SHALL BE OPEN LEFT EXCEPT VALVES 12" AND SMALLER
- INSTALLED IN THE TOWN OF WEBSTER (WHICH SHALL BE OPEN RIGHT).

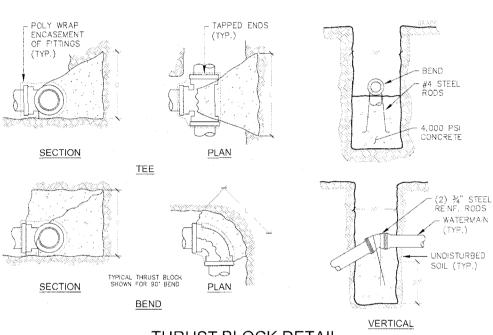

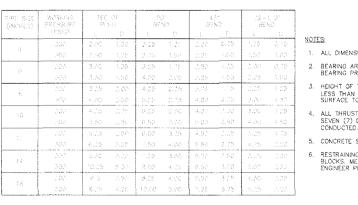

WATERMAIN THRUST BLOCK SCHEDULE STANDARD TOWN DETAIL (W-5) LAST REVISED 2018

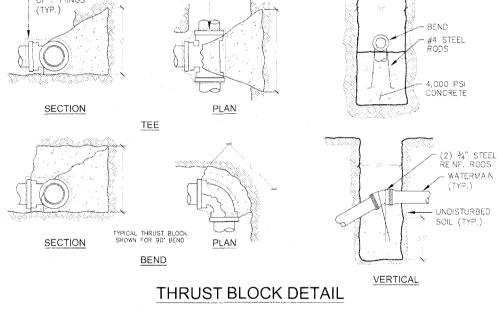

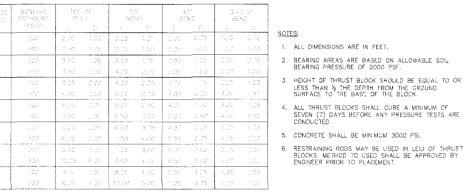

APPROVED BY: APPROVED BY: APPROVED BY: TOWN HIGHWAY & WATER SUPERINTENDENT PLANNING BOARD CHAIRPERSON TOWN ENGINEER

**ENGINEERING** ROCHESTER LOCATION

> 39 CASCADE DRIVE ROCHESTER, NY 14614 5 8 5 - 4 5 8 - 7 7 7 0 ITHACA LOCATION 840 HANSHAW RD, STE 6 ITHACA, NY 14850 6 0 7 - 2 4 1 - 2 9 1 7

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0 ST **M** 

1022-19 AS SHOWN DESIGNED: RJT 5/21/21

REVISIONS DATE BY REVISION 12/12/19 CP ISSUED PREMYLAR

JOB NO:

SCALE:

DRAWN:

DATE:

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BRINGLEY

DRAWING TITLE: CONSTRUCTION DETAILS

ROBER<sup>T</sup>

21 of 21 SHEET No:

1022-19 JOB No: