

NO. DESCRIPTION DATE BY

PRC COMMENTS 09/15/21 GFT

TOWN ENGINEER COMMENTS 10/19/21 GFT

TOWN ENGINEER COMMENTS FOR

**REVISIONS** 

NOT APPROVED FOR CONSTRUCTION

It is a violation of New York State Education Law Article 145 Section 7209 for any person, unless he or she is acting under the direction of a licensed professional engineer or land surveyor, to alter an item in any way. If an item bearing the seal of an engineer or land surveyor is altered, the altering engineer or land surveyor shall affix to the item his or her seal and the notation "altered by" followed by his or her signature and the date of such alteration, and a specific description of the alteration.

## THORNTON =


30 Assembly Drive, Suite 106 Mendon, New York 14506 Tel. 585-624-4810 Consultant Engineers



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PROJECT NAME:

# Boat Display Expansion

FLX Marine 2121 State Route 332 Town of Canandaigua Ontario County, NY

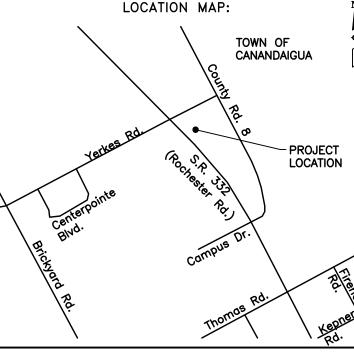DRAWING TITLE:

## Site Plan

FILE NAME: SITEPLAN.DWG	DESIGNED BY:  GFT		
DRAWN BY:	CHECKED BY:		
HKT	GFT		
APPROVED BY:	DATE:		
GFT	SEPTEMBER 2021		
SCALE:	PROJECT NO.:		
1" = 30'	21-850		
SHEET NO.:	DRAWING NO.:		
_1_ of _3_	S-1		

#### LANDSCAPING NOTES


- All plants shall meet or exceed the requirements set forth in the latest edition of the American Standard for Nursery Stock by the American Association of Nurserymen, ANSI Z60.1.
- Upon completion and acceptance of the landscaping by the Town of Canandaigua, a two (2) year maintenance guarantee is required.
- 3. All planting beds to receive 3" of shredded hardwood bark mulch and weed barrier.
- 4. No trees are to be planted within 20' of overhead wires or within 5' of underground
- 5. Stake and wrap tree trunks upon planting.
- 6. Planting backfill mixture to consist of 4 parts of topsoil and 1 part peat moss. Provide 10 lbs. of 5—10—5 fertilizer per 1 cubic yard of planting backfill.
- Apply lawn seed mix at a rate of 5 lbs. per 1,000 s.f. of lawn area using the following proportions by weight: <u>Lawn Areas</u>


8 by Weight
in Mixture
45 Kentucky Bluegrass
40 Red Fescue (commercial)
15 Common Ryegrass

Rate of lawn fertilizer to be 25 lbs. per 1,000 s.f.

- 8. All seeded areas are to receive 4" of topsoil, seed, straw mulch cover, fertilizer, and water until a thick turf cover is obtained.
- 9. All planting bed areas shall be constructed with 12" of planting backfill mixture.
- 10. Topsoil must be stripped and stockpiled before construction and replaced on all landscaped and lawn areas to a minimum depth of 4" before resale or removal from site.
- 11. No Phosphorous shall be used at planting time unless soil testing has been completed and tested by a Horticultural Testing Lab and the soil tests specifically indicate a phosphorous deficiency that is harmful, or will prevent new lawns and plantings from establishing properly.
- 12. If soil tests indicate a phosphorous deficiency that will impact plant and lawn establishment, phosphorous shall be applied at the minimum recommended level prescribed in the soil test following all NYS DEC regulations.


PLANTING SCHEDULE						
JANTITY	KEY	BOTANICAL NAME	COMMON NAME	SIZE	ROOT	NOTES
20	ВМ	Buxus microphylla	Littleleaf Boxwood	24" Height	Container	6' O.C.
6	RL	Syringa x "Royalty"	Royalty Lilac	24" Height	Container	

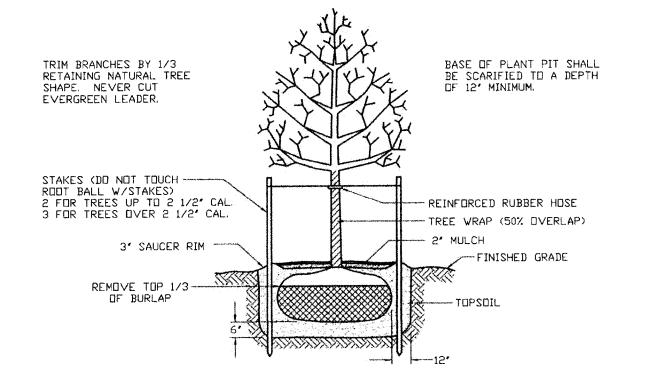

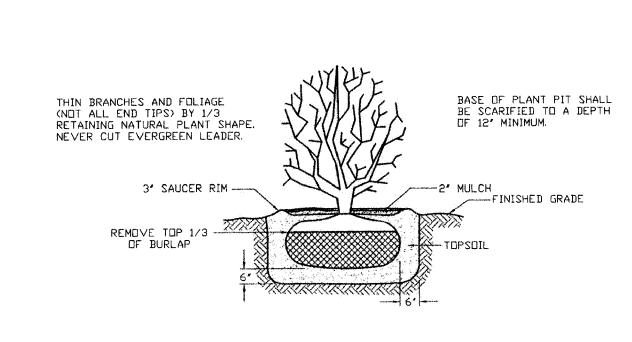

TYPICAL TREE PLANTING
NOT TO SCALE

TYPICAL SHRUB PLANTING
NOT TO SCALE

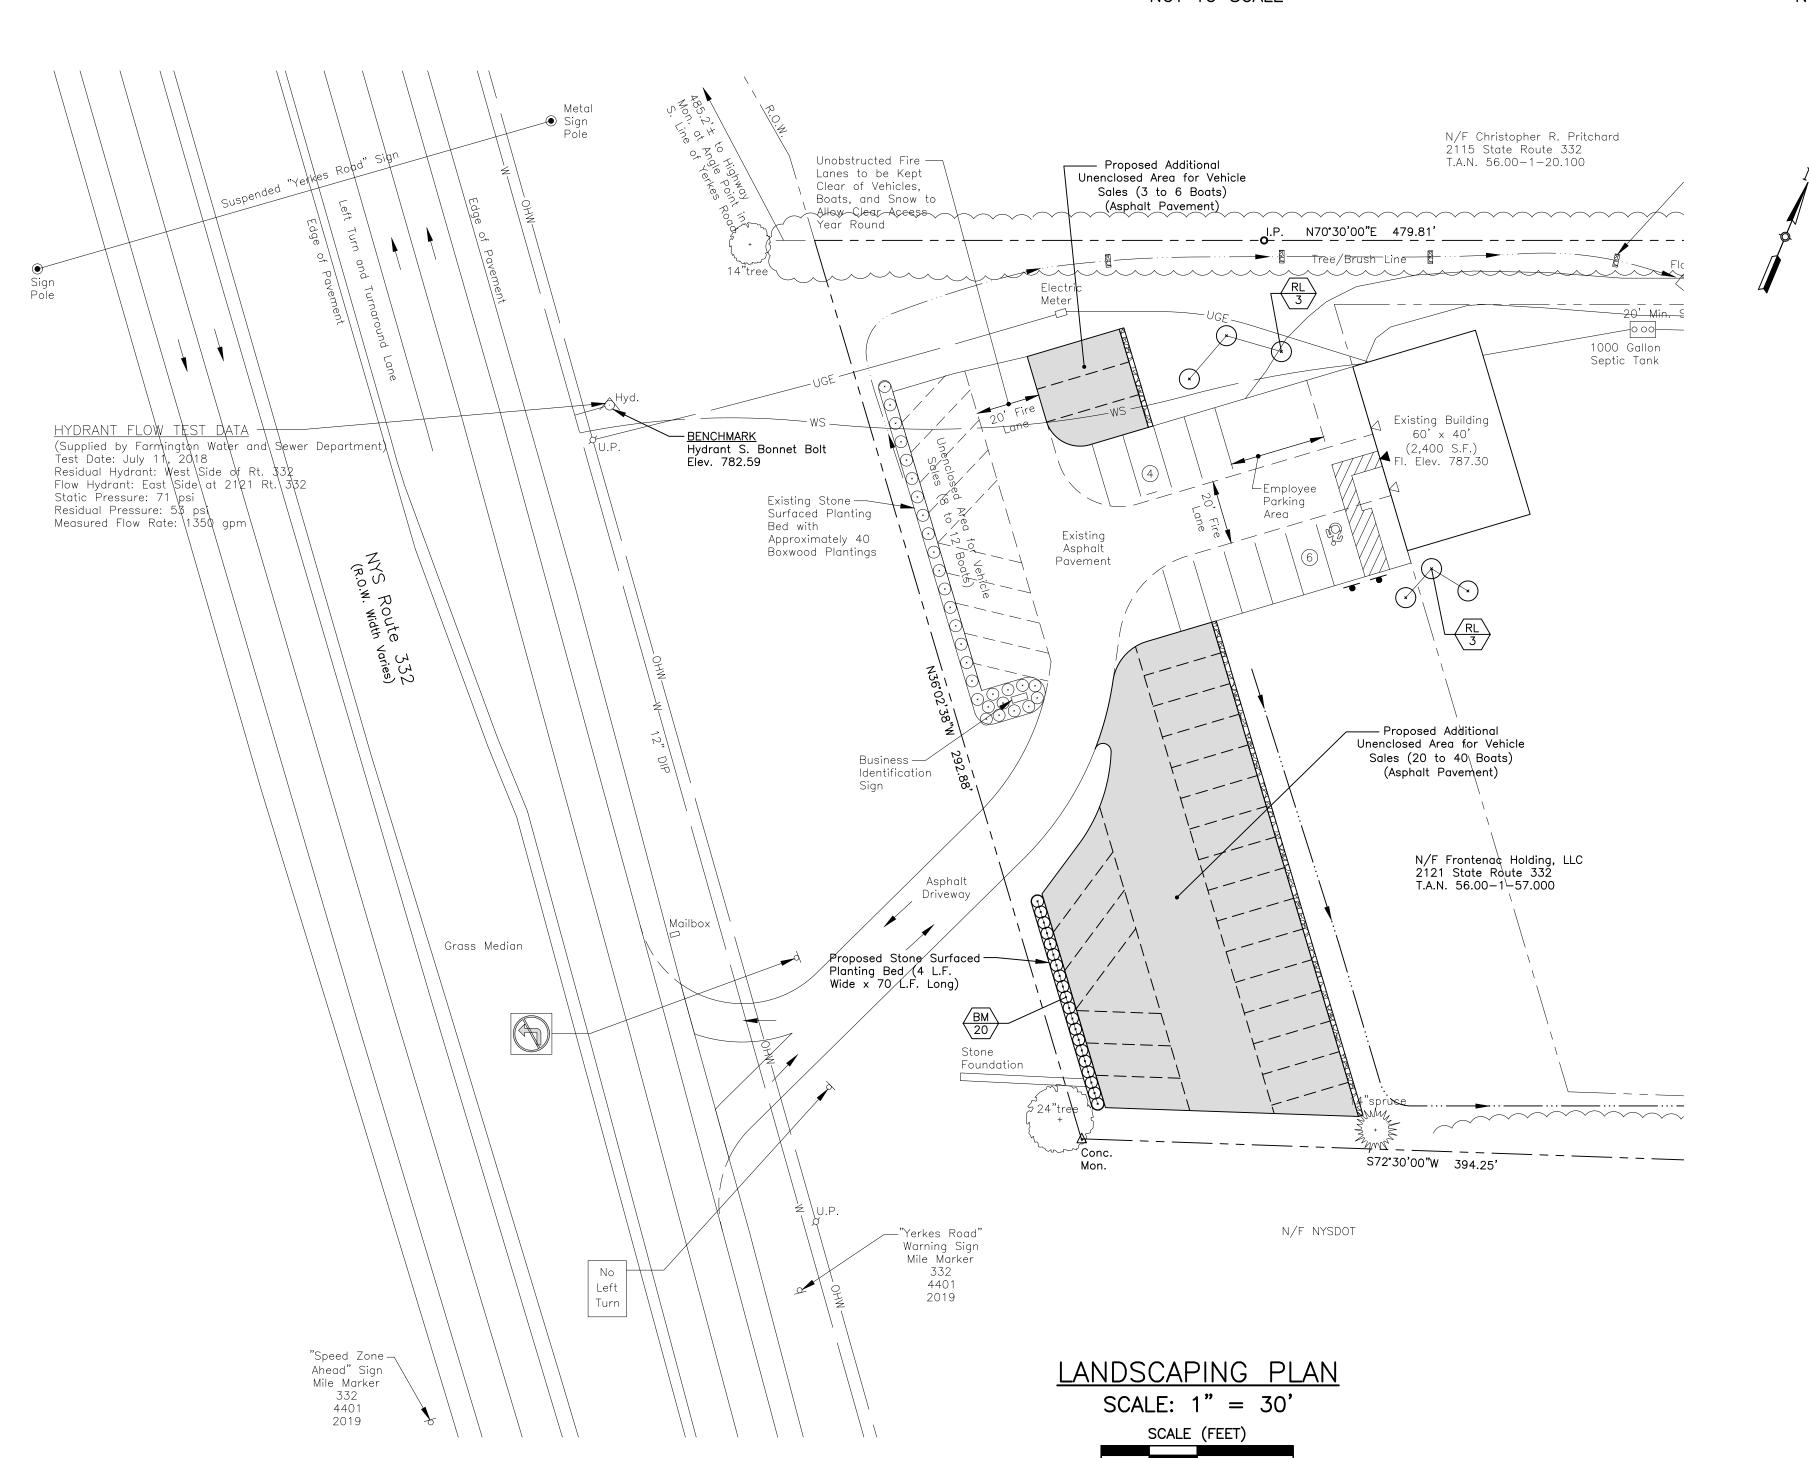

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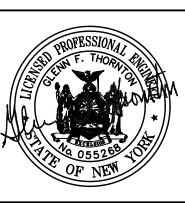
CONSTRUCTION

REVISIONS

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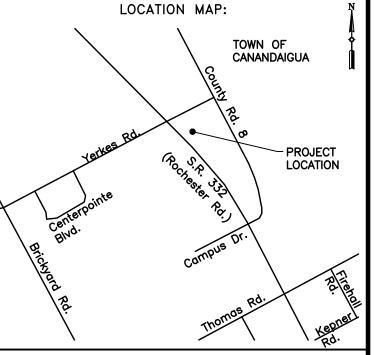
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PROJECT NAME:

## Boat Display Expansion

FLX Marine 2121 State Route 332 Town of Canandaigua Ontario County, NY

DRAWING TITLE:

## Landscaping Plan

FILE NAME: LANDSCAPEPLAN.DWG	DESIGNED BY:  GFT		
DRAWN BY: HKT	CHECKED BY: GFT		
APPROVED BY:  GFT	DATE: SEPTEMBER 2021		
scale: AS NOTED	PROJECT NO.: 21-850		
SHEET NO.:	DRAWING NO.:		
_2_ or _3_	S-2		


### <u>APPROVALS</u>

Town Engineer

Planning Board Chairperson Date

Date


\_\_\_\_\_\_Canandaigua—Farmington Water Superintendent Date

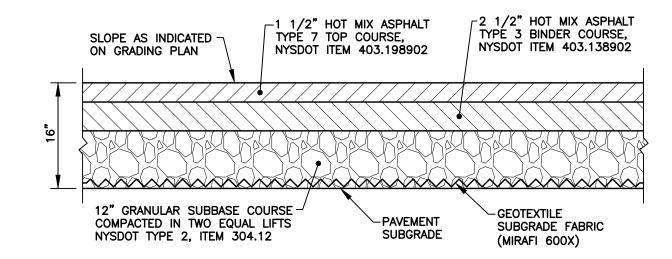


#### <u>NOTES</u>

- 1. PAVEMENT SUBGRADE AREAS SHALL BE COMPACTED TO A DEPTH OF SIX INCHES AND TO A DENSITY OF NOT LESS THAN 95% OF THE MAXIMUM DENSITY AS DETERMINED BY ASTM D-1557.
- 2. EXISTING TOPSOIL (6" MINIMUM THICKNESS) SHALL BE REMOVED FROM ALL PROPOSED PAVEMENT AREAS. AREAS BELOW THE PAVEMENT SUBGRADE SHALL BE FILLED WITH COMPACTED GRANULAR SUBBASE COURSE.

ASPHALT PAVEMENT NOT TO SCALE

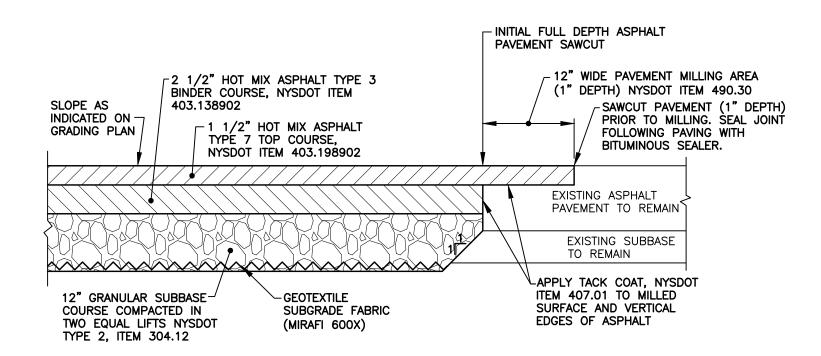

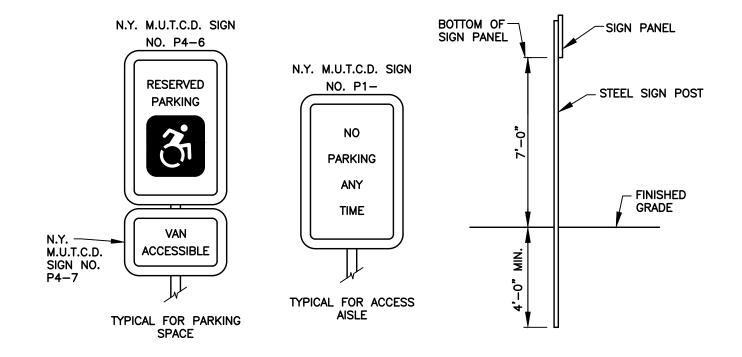

PAVEMENT TRANSITION NOT TO SCALE

EXISTING

MOUNTABLE BERM

(OPTIONAL)

**PROFILE** 

CONSTRUCTION SPECIFICATIONS 1. STONE SIZE - USE 2" STONE, OR RECLAIMED OR RECYCLED CONCRETE EQUIVALENT.

2. LENGTH - NOT LESS THAN 50' (EXCEPT ON A SINGLE RESIDENCE LOT WHERE

4. WIDTH - 12' MINIMUM, BUT NOT LESS THAN THE FULL WIDTH AT POINTS WHERE INGRESS OR EGRESS OCCURS. 24' IF SINGLE ENTRANCE TO SITE.

CONSTRUCTION ENTRANCES SHALL BE PIPED ACROSS THE ENTRANCE. IF PIPING IS

7. MAINTENANCE — THE ENTRANCE SHALL BE MAINTAINED IN A CONDITION WHICH WILL PREVENT TRACKING OR FLOWING OF SEDIMENT ONTO PUBLIC RIGHTS—OF—WAY, ALL SEDIMENT SPILLED, DROPPED, WASHED OR TRACTED ONTO PUBLIC RIGHTS—OF—WAY MUST BE REMOVED IMMEDIATELY.

9. PERIODIC INSPECTION AND NEEDED MAINTENANCE SHALL BE PROVIDED AFTER EACH

8. WHEN WASHING IS REQUIRED, IT SHALL BE DONE ON AN AREA STABILIZED WITH

STONE AND WHICH DRAINS INTO AN APPROVED SEDIMENT TRAPPING DEVICE.

5. FILTER CLOTH - WILL BE PLACED OVER THE ENTIRE AREA PRIOR TO PLACING

6. SURFACE WATER - ALL SURFACE WATER FLOWING OR DIVERTED TOWARD


IMPRACTICAL, A MOUNTABLE BERM WITH 5:1 SLOPES WILL BE PERMITTED.

A 30' MINIMUM LENGTH WOULD APPLY).

3. THICKNESS - NOT LESS THAN 6".

PAVEMENT 7

**EXISTING**  HANDICAP PARKING SIGNS NOT TO SCALE

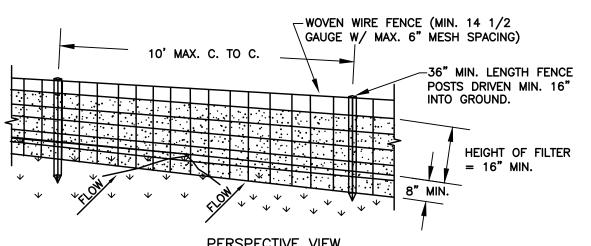

#### 36" MIN. FENCE POST-WOVEN WIRE FENCE (MIN. 14 1/2 GAUGE W/ MAX. 6" MESH SPACING) WITH FILTER CLOTH COMPACTED SOIL EMBED FILTER CLOTH -A MIN. OF 6" IN GROUND.


#### **CONSTRUCTION SPECIFICATIONS**

- 2. FILTER CLOTH TO BE TO BE FASTENED SECURELY TO WOVEN WIRE FENCE WITH TIES SPACED EVERY 24" AT TOP AND MID SECTION.

- 5. MAINTENANCE SHALL BE PERFORMED AS NEEDED AND MATERIAL REMOVED WHEN "BULGES" DEVELOP IN THE SILT FENCE.

PEA GRAVEL PAVEMENT GEOTEXTILE -FILTER FABRIC (MIRAFI 180N) 1' MIN.

PEA GRAVEL DIAPHRAGM

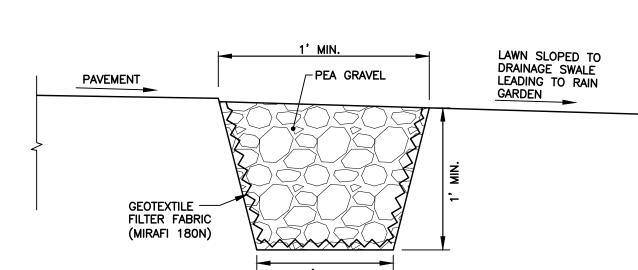

NOT TO SCALE

#### STORM RUNOFF — FROM PAVEMENTS — 2" SHREDDED AND LAWN AREAS HARDWOOD MULCH /-1.05' PONDING DEPTH -2'-6" SOIL MEDIA (NOTE 1) <del>| | SUBSO</del>IL | | 1'-0" WASHED STONE **NOTES**

1. SOIL MEDIA SHALL CONSIST OF BLENDED 50% TO 70% SAND AND 50% TO 30%


WIDTH AND LENGTH AS NOTED ON PLAN

-DOWNSTREAM OVERFLOW TO LAWN

FABRIC (MIRAFI 180N)

2. LANDSCAPE STONES, AND PLANTS THAT ARE TOLERANT TO BOTH WET AND DRY CONDITIONS, SHOULD BE PROVIDED. SUGGESTED PLANTS INCLUDE RED OSIER DOGWOOD, ARROWWOOD, WINTERBERRY, WITCH HAZEL, BROOK-SIDE ADER, SWEET PEPPERBUSH, SWITCH GRASS, NEW ENGLAND ASTER, WOOLGRASS, CUTLEAF CONEFLOWER, AND FOX SEDGE. PLANTS MUST BE IN ACCORDANCE WITH THE NYSDEC RECOMMENDED SPECIES LIST.

> RAIN GARDEN NOT TO SCALE

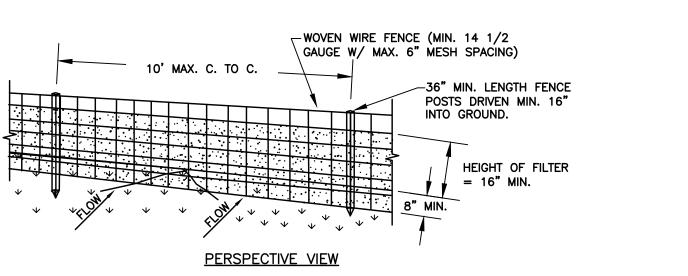

# UNDISTURBED GROUND SECTION VIEW

- 1. WOVEN WIRE FENCE TO BE FASTENED SECURELY TO FENCE POSTS WITH WIRE TIES OR STAPLES. POSTS SHALL BE STEEL EITHER "T" OR "U" TYPE OR HARDWOOD.
- FENCE SHALL BE WOVEN WIRE, 12 1/2 GAUGE, 6" MAXIMUM MESH OPENING
- 3. WHEN TWO SECTIONS OF FILTER CLOTH ADJOIN EACH OTHER THEY SHALL BE OVER-LAPPED BY 6" AND FOLDED. FILTER CLOTH SHALL BE EITHER FILTER X, MIRAFI 100X, STABILINKA T140N, OR APPROVED EQUIVALENT.
- 4. PREFABRICATED UNITS SHALL BE GEOFAB, ENVIROFENCE, OR APPROVED EQUIVALENT.

## NOT TO SCALE

EXISTING FILTER\_

**EXISTING** GROUND 7

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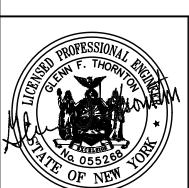
REVISIONS

DESCRIPTION

PRC COMMENTS

TOWN ENGINEER COMMENTS

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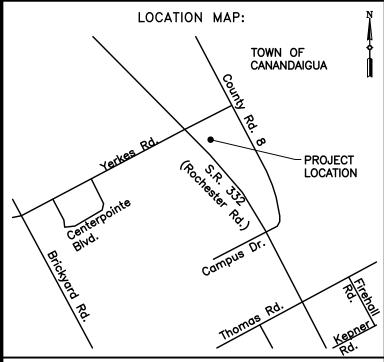


Consultant Engineers

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© Thornton Engineering LLP, 2021 LOCATION MAP:



PROJECT NAME:

## **Boat Display** Expansion

FLX Marine 2121 State Route 332 Town of Canandaigua Ontario County, NY

DRAWING TITLE:

## Miscellaneous Details

FILE NAME:	DESIGNED BY:		
DETAILS.DWG	GFT		
DRAWN BY:	CHECKED BY:		
HKT	GFT		
APPROVED BY:	DATE:		
GFT	SEPTEMBER 2021		
SCALE:	PROJECT NO.:		
NOT TO SCALE	21-850		
SHEET NO.:	DRAWING NO.:		
$\underline{3}$ of $\underline{3}$	D-1		

SILT FENCE NOT TO SCALE

STABILIZED CONSTRUCTION ENTRANCE