

REVISIONS

NO. DESCRIPTION DATE BY

PRC COMMENTS 09/15/21 GFT

TOWN ENGINEER COMMENTS 10/19/21 GFT


PLANNING BOARD COMMENTS 01/27/22 GFT

NOT APPROVED FOR CONSTRUCTION

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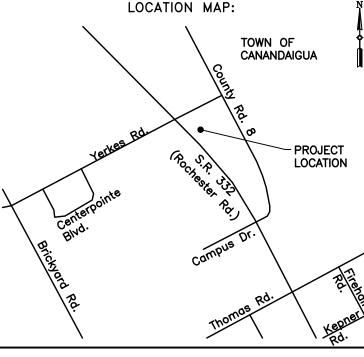
30 Assembly Drive, Suite 106 Mendon, New York 14506 Tel. 585-624-4810 Consultant Engineers



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PROJECT NAME:

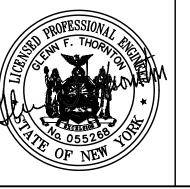Boat Display Expansion

FLX Marine 2121 State Route 332 Town of Canandaigua Ontario County, NY

DRAWING TITLE:

Site Plan

FILE NAME: SITEPLAN.DWG	DESIGNED BY: GFT		
DRAWN BY:	CHECKED BY:		
HKT	GFT		
APPROVED BY:	DATE:		
GFT	SEPTEMBER 2021		
SCALE:	PROJECT NO.:		
1" = 30'	21-850		
SHEET NO.:	DRAWING NO.:		
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LANDSCAPING NOTES

- All plants shall meet or exceed the requirements set forth in the latest edition of the American Standard for Nursery Stock by the American Association of Nurserymen, ANSI Z60.1.
- 2. Upon completion and acceptance of the landscaping by the Town of Canandaigua, a two (2) year maintenance guarantee is required.
- 3. All planting beds to receive 3" of shredded hardwood bark mulch and weed barrier.
- 4. No trees are to be planted within 20' of overhead wires or within 5' of underground
- 5. Stake and wrap tree trunks upon planting.
- 6. Planting backfill mixture to consist of 4 parts of topsoil and 1 part peat moss. Provide 10 lbs. of 5—10—5 fertilizer per 1 cubic yard of planting backfill.
- Apply lawn seed mix at a rate of 5 lbs. per 1,000 s.f. of lawn area using the following proportions by weight: <u>Lawn Areas</u>

% by Weightin MixtureSpecies or Variety45Kentucky Bluegrass40Red Fescue (commercial)15Common Ryegrass

Rate of lawn fertilizer to be 25 lbs. per 1,000 s.f.

- 8. All seeded areas are to receive 4" of topsoil, seed, straw mulch cover, fertilizer, and water until a thick turf cover is obtained.
- 9. All planting bed areas shall be constructed with 12" of planting backfill mixture.
- 10. Topsoil must be stripped and stockpiled before construction and replaced on all landscaped and lawn areas to a minimum depth of 4" before resale or removal from site.
- 11. No Phosphorous shall be used at planting time unless soil testing has been completed and tested by a Horticultural Testing Lab and the soil tests specifically indicate a phosphorous deficiency that is harmful, or will prevent new lawns and plantings from establishing properly.
- 12. If soil tests indicate a phosphorous deficiency that will impact plant and lawn establishment, phosphorous shall be applied at the minimum recommended level prescribed in the soil test following all NYS DEC regulations.


Remove 12 Green Velvet Boxwoods As Shown and Replant in

Landscape Bed B (Typ.)

LANDSCAPE BED B


SCALE: 1" = 20'

PLANTING SCHEDULE						
QUANTITY	KEY	BOTANICAL NAME	COMMON NAME	SIZE	ROOT	NOTES
49	BG	Buxus x "Green Velvet"	Green Velvet Boxwood	18" Diameter	Container	4' O.C.
6	RL	Syringa x "Royalty"	Royalty Lilac	24" Height	Container	4' O.C.
9	WW	Weigela florida "Alexandra"	Wine and Roses Weigela	# 2	Container	4' O.C.
9	SW	Spirea x burmalda "Anthony Waterer"	Anthony Waterer Spirea	# 3	Container	4' O.C.

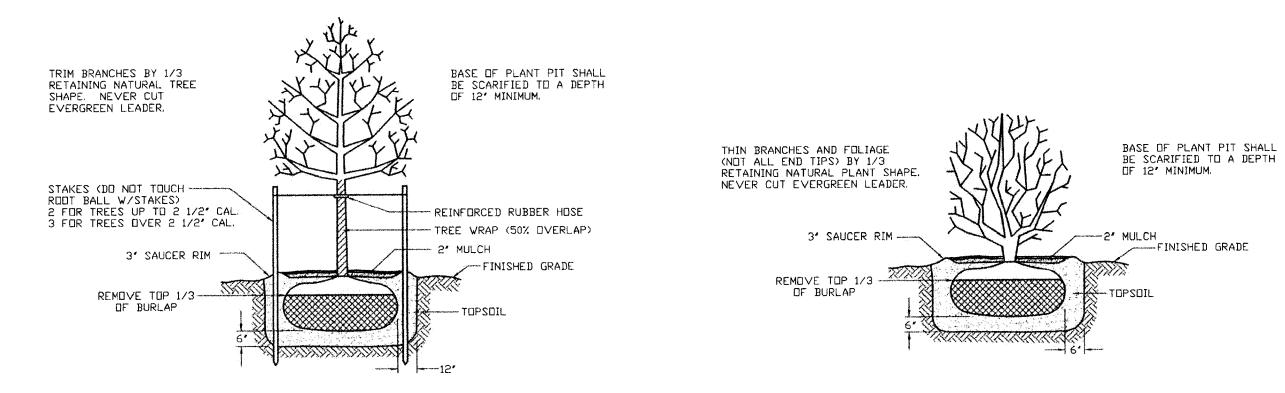

TYPICAL TREE PLANTING NOT TO SCALE

TYPICAL SHRUB PLANTING NOT TO SCALE

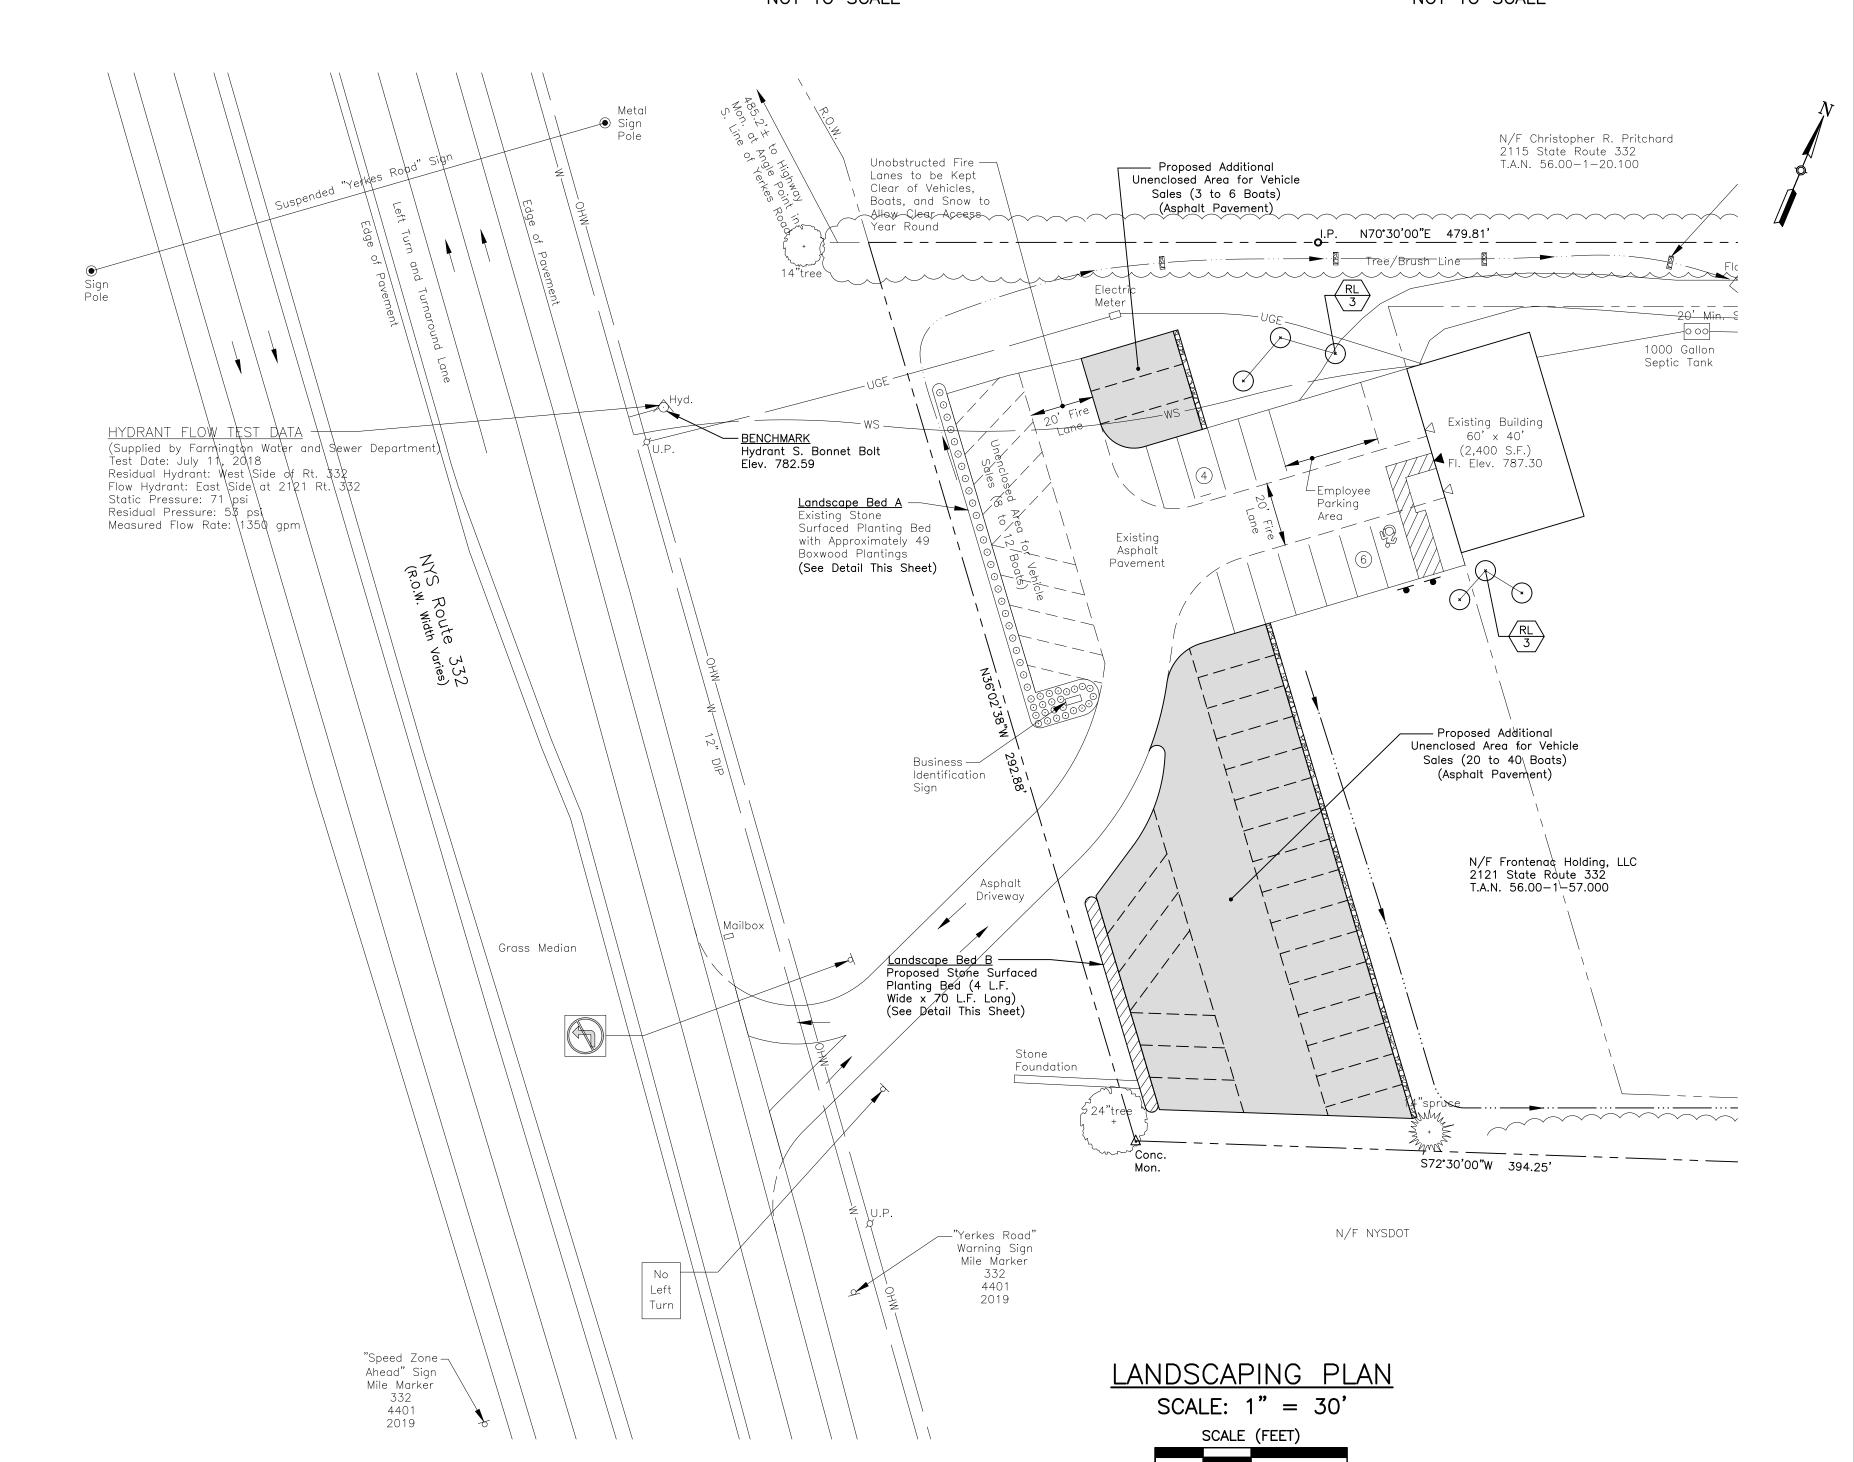

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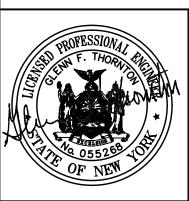
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LOCATION MAP:

TOWN OF CANANDAIGUA

Contain Project Location

Rocket Pr

PROJECT NAME:

Boat Display Expansion

FLX Marine 2121 State Route 332 Town of Canandaigua Ontario County, NY

DRAWING TITLE:

Landscaping Plan

NDSCAPEPLAN.DWG	GFT
DRAWN BY: HKT	CHECKED BY: GFT
APPROVED BY:	DATE: SEPTEMBER 2021
scale: AS NOTED	PROJECT NO.: 21-850
SHEET NO.:	DRAWING NO.:
	S-2

DESIGNED BY:

<u>APPROVALS</u>


Planning Board Chairperson Date

LANDSCAPE BED A

SCALE: 1" = 20'

Town Engineer Date

Canandaigua—Farmington Water Superintendent Date

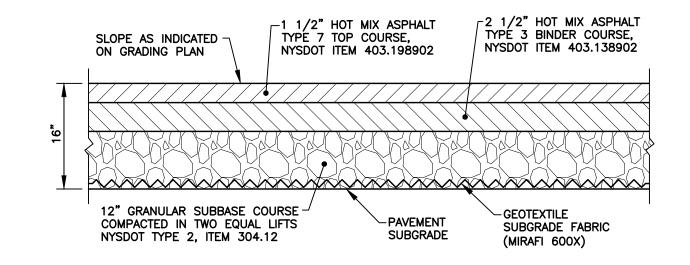


<u>NOTES</u>


- 1. PAVEMENT SUBGRADE AREAS SHALL BE COMPACTED TO A DEPTH OF SIX INCHES AND TO A DENSITY OF NOT LESS THAN 95% OF THE MAXIMUM DENSITY AS DETERMINED BY ASTM D-1557.
- 2. EXISTING TOPSOIL (6" MINIMUM THICKNESS) SHALL BE REMOVED FROM ALL PROPOSED PAVEMENT AREAS. AREAS BELOW THE PAVEMENT SUBGRADE SHALL BE FILLED WITH COMPACTED GRANULAR SUBBASE COURSE.

ASPHALT PAVEMENT

NOT TO SCALE

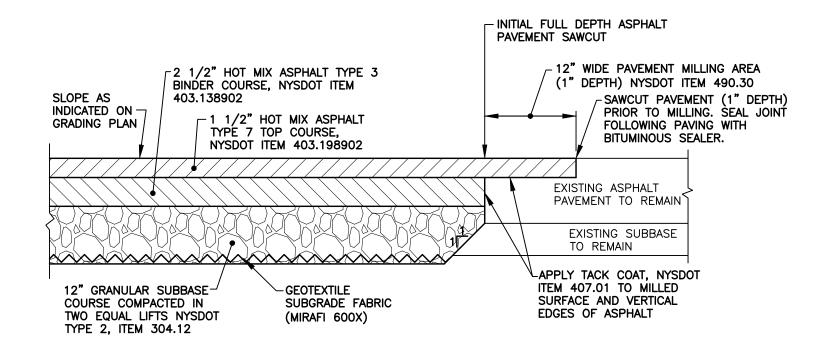


PAVEMENT TRANSITION NOT TO SCALE

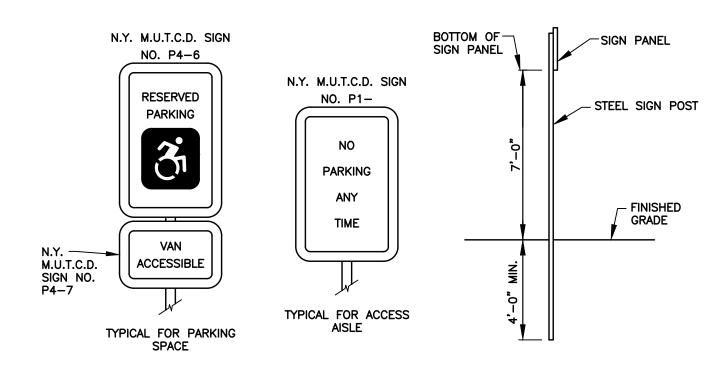


HANDICAP PARKING SIGNS


NOT TO SCALE

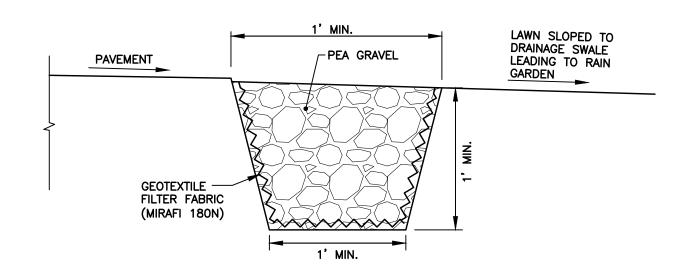


PEA GRAVEL DIAPHRAGM NOT TO SCALE

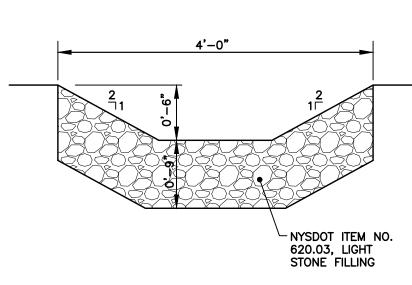

RIPRAP PILOT CHANNEL NOT TO SCALE

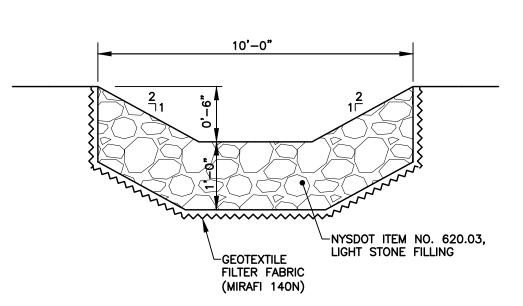



STONE RIPRAP SPILLWAY NOT TO SCALE

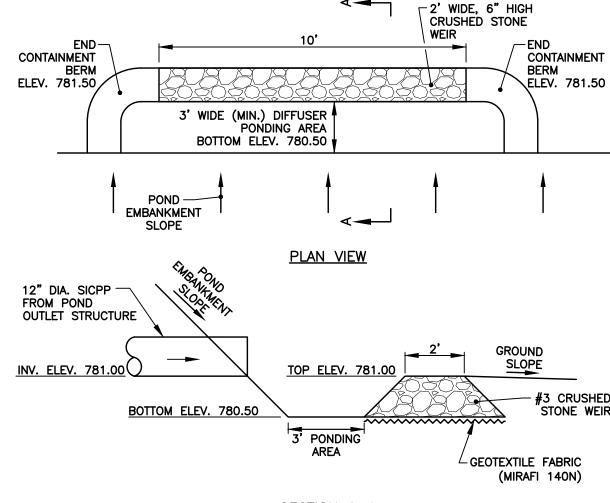

SECTION A-A

FLOW DIFFUSER NOT TO SCALE

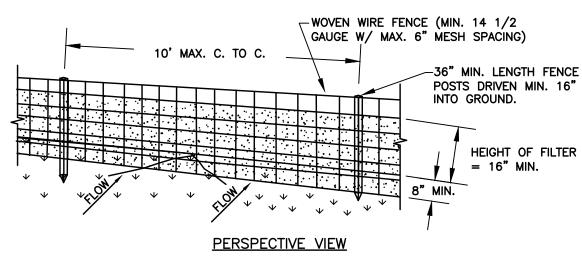

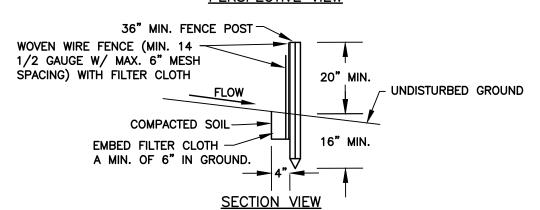

CONSTRUCTION SPECIFICATIONS


- 1. WOVEN WIRE FENCE TO BE FASTENED SECURELY TO FENCE POSTS WITH WIRE TIES OR STAPLES. POSTS SHALL BE STEEL EITHER "T" OR "U" TYPE OR HARDWOOD.
- 2. FILTER CLOTH TO BE TO BE FASTENED SECURELY TO WOVEN WIRE FENCE WITH TIES SPACED EVERY 24" AT TOP AND MID SECTION. FENCE SHALL BE WOVEN WIRE, 12 1/2 GAUGE, 6" MAXIMUM MESH OPENING.
- 3. WHEN TWO SECTIONS OF FILTER CLOTH ADJOIN EACH OTHER THEY SHALL BE OVER-LAPPED BY 6" AND FOLDED. FILTER CLOTH SHALL BE EITHER FILTER X, MIRAFI 100X, STABILINKA T140N, OR APPROVED EQUIVALENT.
- 4. PREFABRICATED UNITS SHALL BE GEOFAB, ENVIROFENCE, OR APPROVED EQUIVALENT.
- 5. MAINTENANCE SHALL BE PERFORMED AS NEEDED AND MATERIAL REMOVED WHEN "BULGES" DEVELOP IN THE SILT FENCE.


SILT FENCE

NOT TO SCALE

7. MAINTENANCE - THE ENTRANCE SHALL BE MAINTAINED IN A CONDITION WHICH WILL PREVENT TRACKING OR FLOWING OF SEDIMENT ONTO PUBLIC RIGHTS-OF-WAY, ALL SEDIMENT SPILLED, DROPPED, WASHED OR TRACTED ONTO PUBLIC RIGHTS-OF-WAY MUST BE REMOVED IMMEDIATELY. 8. WHEN WASHING IS REQUIRED, IT SHALL BE DONE ON AN AREA STABILIZED WITH STONE AND WHICH DRAINS INTO AN APPROVED SEDIMENT TRAPPING DEVICE. 9. PERIODIC INSPECTION AND NEEDED MAINTENANCE SHALL BE PROVIDED AFTER EACH

STABILIZED CONSTRUCTION ENTRANCE NOT TO SCALE

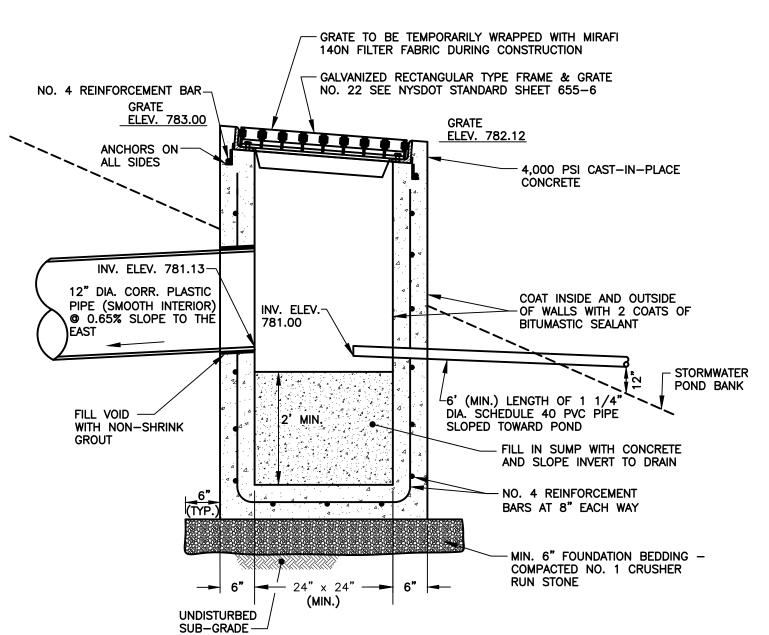

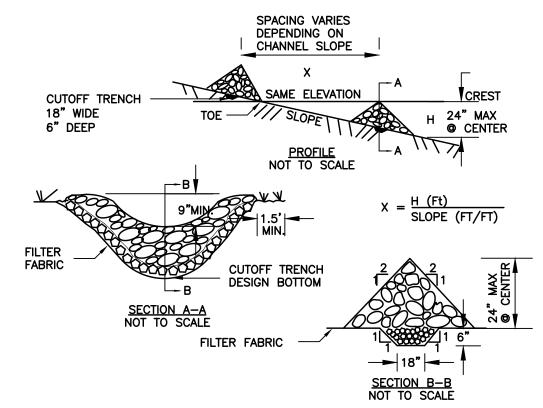

CONSTRUCTION SPECIFICATIONS

- 1. STONE WILL BE PLACED ON A FILTER FABRIC FOUNDATION TO THE LINES, GRADES AND LOCATIONS SHOWN IN THE PLAN.
- 2. SET SPACING OF CHECK DAMS TO ASSUME THAT THE ELEVATIONS OF THE CREST OF THE DOWNSTREAM DAM IS AT THE SAME ELEVATION OF THE TOE OF THE
- 3. EXTEND THE STONE A MINIMUM OF 1.5 FEET BEYOND THE DITCH BANKS TO PREVENT CUTTING AROUND THE DAM.
- 4. PROTECT THE CHANNEL DOWNSTREAM OF THE LOWEST CHECK DAM FROM SCOUR AND EROSION WITH STONE OR LINER AS APPROPRIATE.
- 5. ENSURE THAT CHANNEL APPURTENANCES SUCH AS CULVERT ENTRANCES BELOW CHECK DAMS ARE NOT SUBJECT TO DAMAGE OR BLOCKAGE FROM DISPLACED STONE. MAXIMUM DRAINAGE AREA 2 ACRES.

ROCK CHECK DAM NOT TO SCALE


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<u>3</u>	PLANNING BOARD COMMENTS	01/27/22	GFT	
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M	OT APPROVED			
	CONSTRUCTION	NC		
	CONSTR			7

REVISIONS

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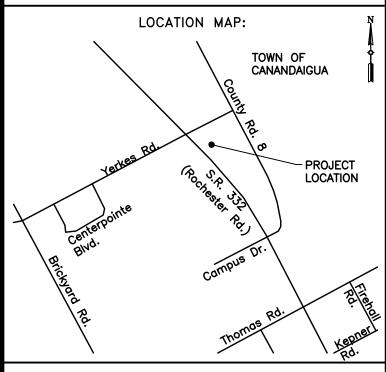
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Boat Display Expansion

FLX Marine 2121 State Route 332 Town of Canandaigua Ontario County, NY

DRAWING TITLE:

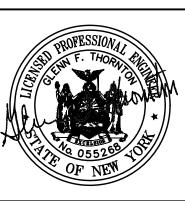Miscellaneous Details

FILE NAME:	DESIGNED BY:		
DETAILS.DWG	GFT		
DRAWN BY:	CHECKED BY:		
HKT	GFT		
APPROVED BY:	DATE:		
GFT	SEPTEMBER 2021		
SCALE:	PROJECT NO.:		
NOT TO SCALE	21-850		
SHEET NO.:	DRAWING NO.:		
$\underline{3}$ of $\underline{3}$	D-1		

EXISTING

GROUND

OUTLET CONTROL STRUCTURE NOT TO SCALE

CONSTRUCTION SPECIFICATIONS 1. STONE SIZE - USE 2" STONE, OR RECLAIMED OR RECYCLED CONCRETE EQUIVALENT. 2. LENGTH — NOT LESS THAN 50' (EXCEPT ON A SINGLE RESIDENCE LOT WHERE A 30' MINIMUM LENGTH WOULD APPLY).

EXISTING PAVEMENT :

PAVEMENT

MOUNTABLE BERM

(OPTIONAL)

3. THICKNESS - NOT LESS THAN 6". 4. WIDTH - 12' MINIMUM, BUT NOT LESS THAN THE FULL WIDTH AT POINTS WHERE INGRESS OR EGRESS OCCURS. 24' IF SINGLE ENTRANCE TO SITE. 5. FILTER CLOTH - WILL BE PLACED OVER THE ENTIRE AREA PRIOR TO PLACING

PROFILE

PLAN VIEW

6. SURFACE WATER — ALL SURFACE WATER FLOWING OR DIVERTED TOWARD CONSTRUCTION ENTRANCES SHALL BE PIPED ACROSS THE ENTRANCE. IF PIPING IS IMPRACTICAL, A MOUNTABLE BERM WITH 5:1 SLOPES WILL BE PERMITTED.